

DRAWN BY: CTW
CHECKED BY: CTW
APPROVED BY: CTW
ISSUE DATE
Const. Document
Submittal 4/25/17

Bldg. No. 1
First Floor,
Second Floor
& Roof Plans

A
1.0

GENERAL INFORMATION


- BUILDING NO.1: AREA (2 'A' UNITS and 3 'B' UNITS): 7,856 GROSS SQUARE FOOTAGE 6,704 NET SQUARE FOOTAGE
- UNIT 'A' AREA:
FIRST FLOOR: 982 G.S.F. 844 NET S.F.
TOTAL: 982 G.S.F. 844 NET S.F.
- UNIT 'B' AREA:
FIRST FLOOR: 982 G.S.F. 848 NET S.F.
SECOND FLOOR: 982 G.S.F. 824 NET S.F.
TOTAL: 1,964 G.S.F. 1,672 NET S.F.

ARCHITECTURAL LEGEND

ASSUMED NORTH
N

1 | FIRST FLOOR PLAN


SCALE: 1/8"=1'-0"

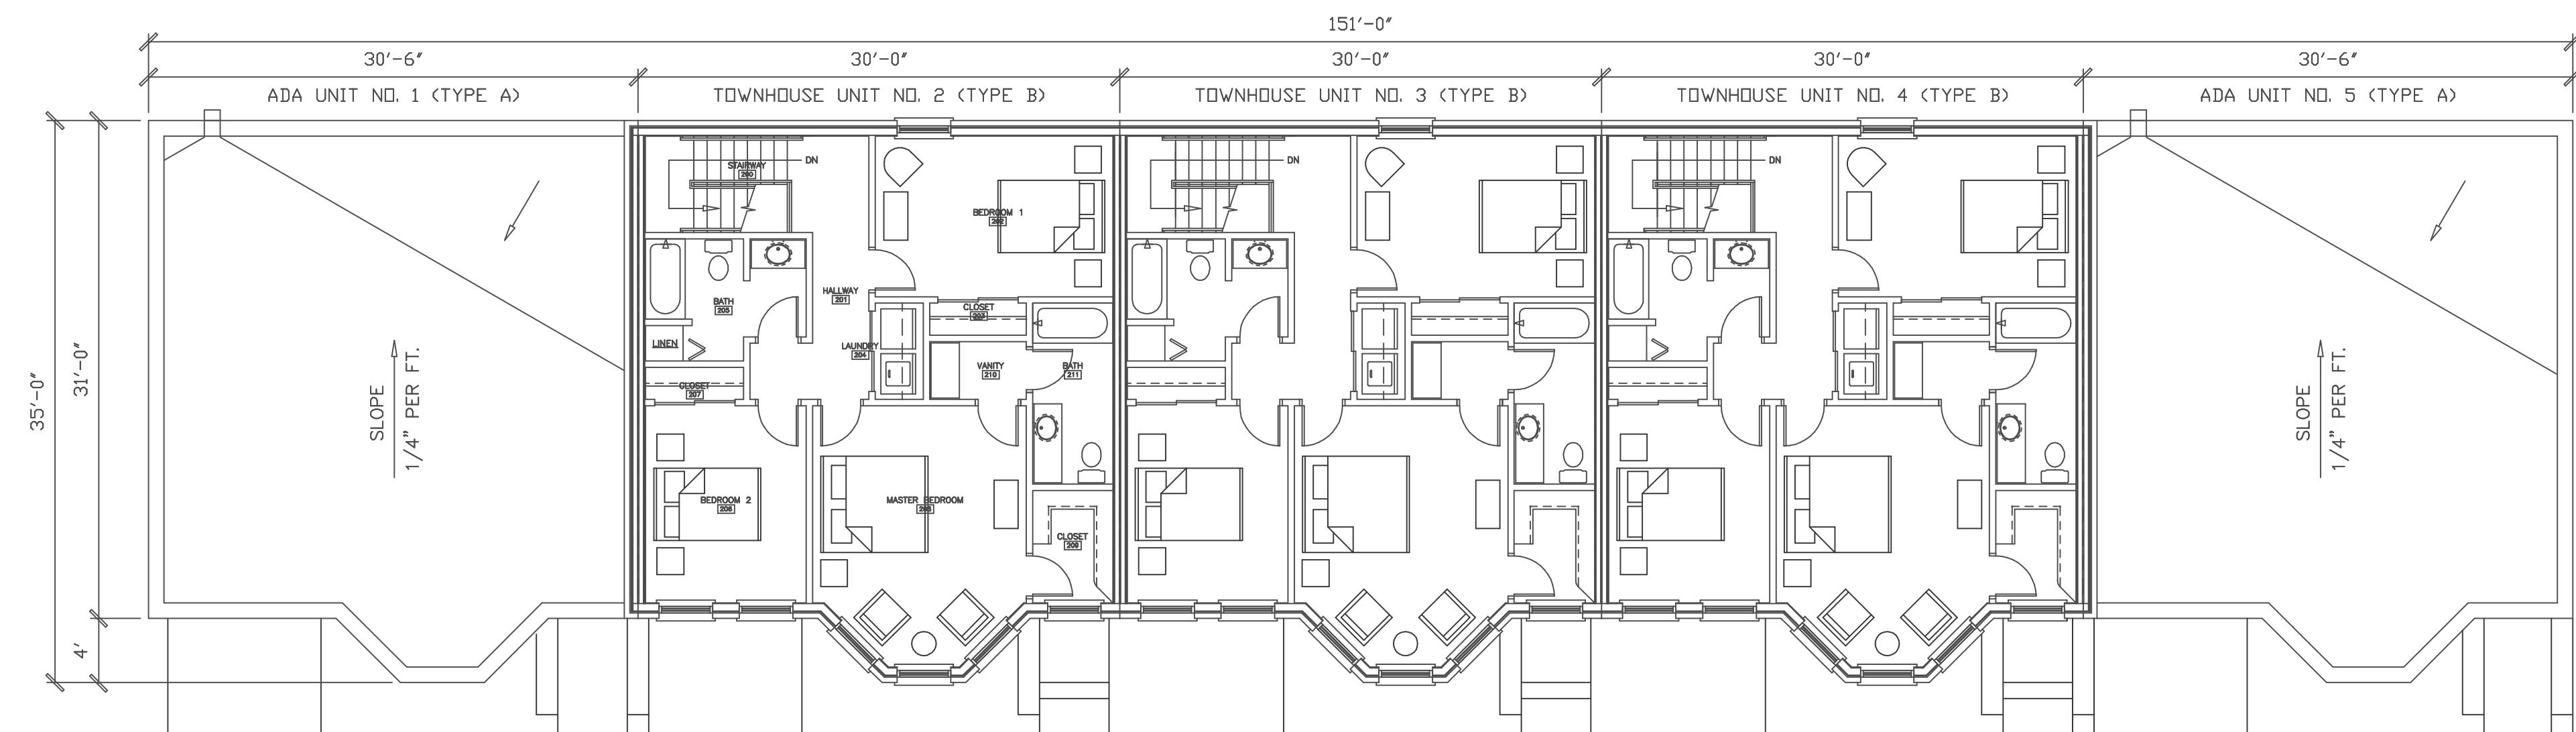

ASSUMED NORTH
N

2 | SECOND FLOOR PLAN

SCALE: 1/8"=1'-0"

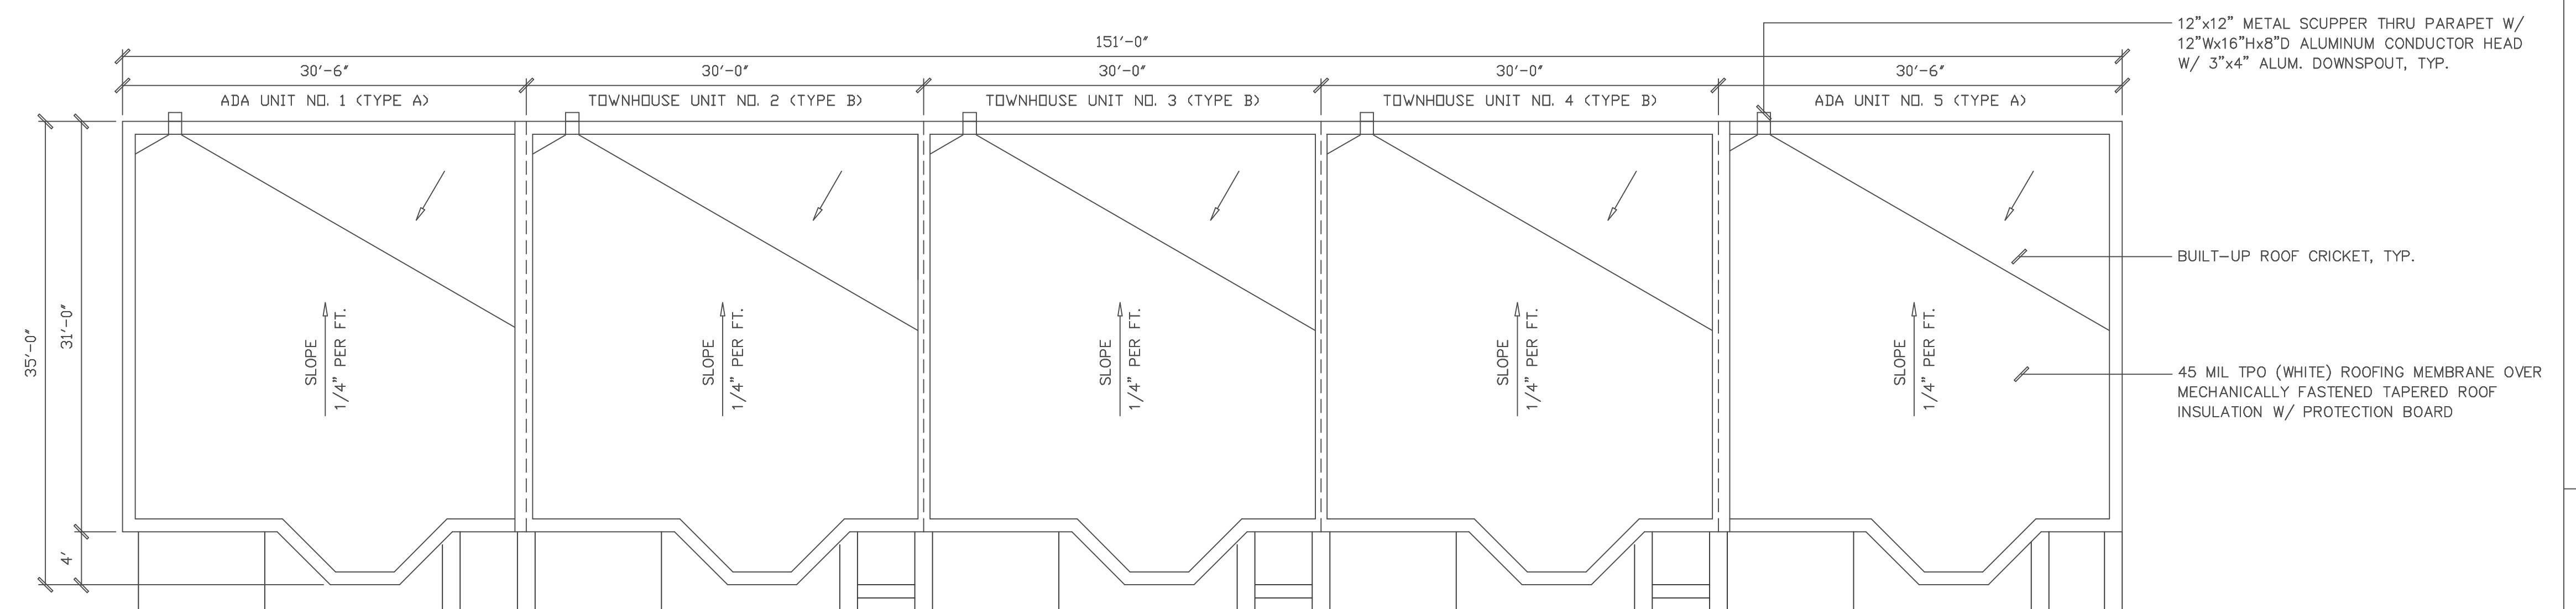


ASSUMED NORTH
N

3 | ROOF PLAN

SCALE: 1/8"=1'-0"

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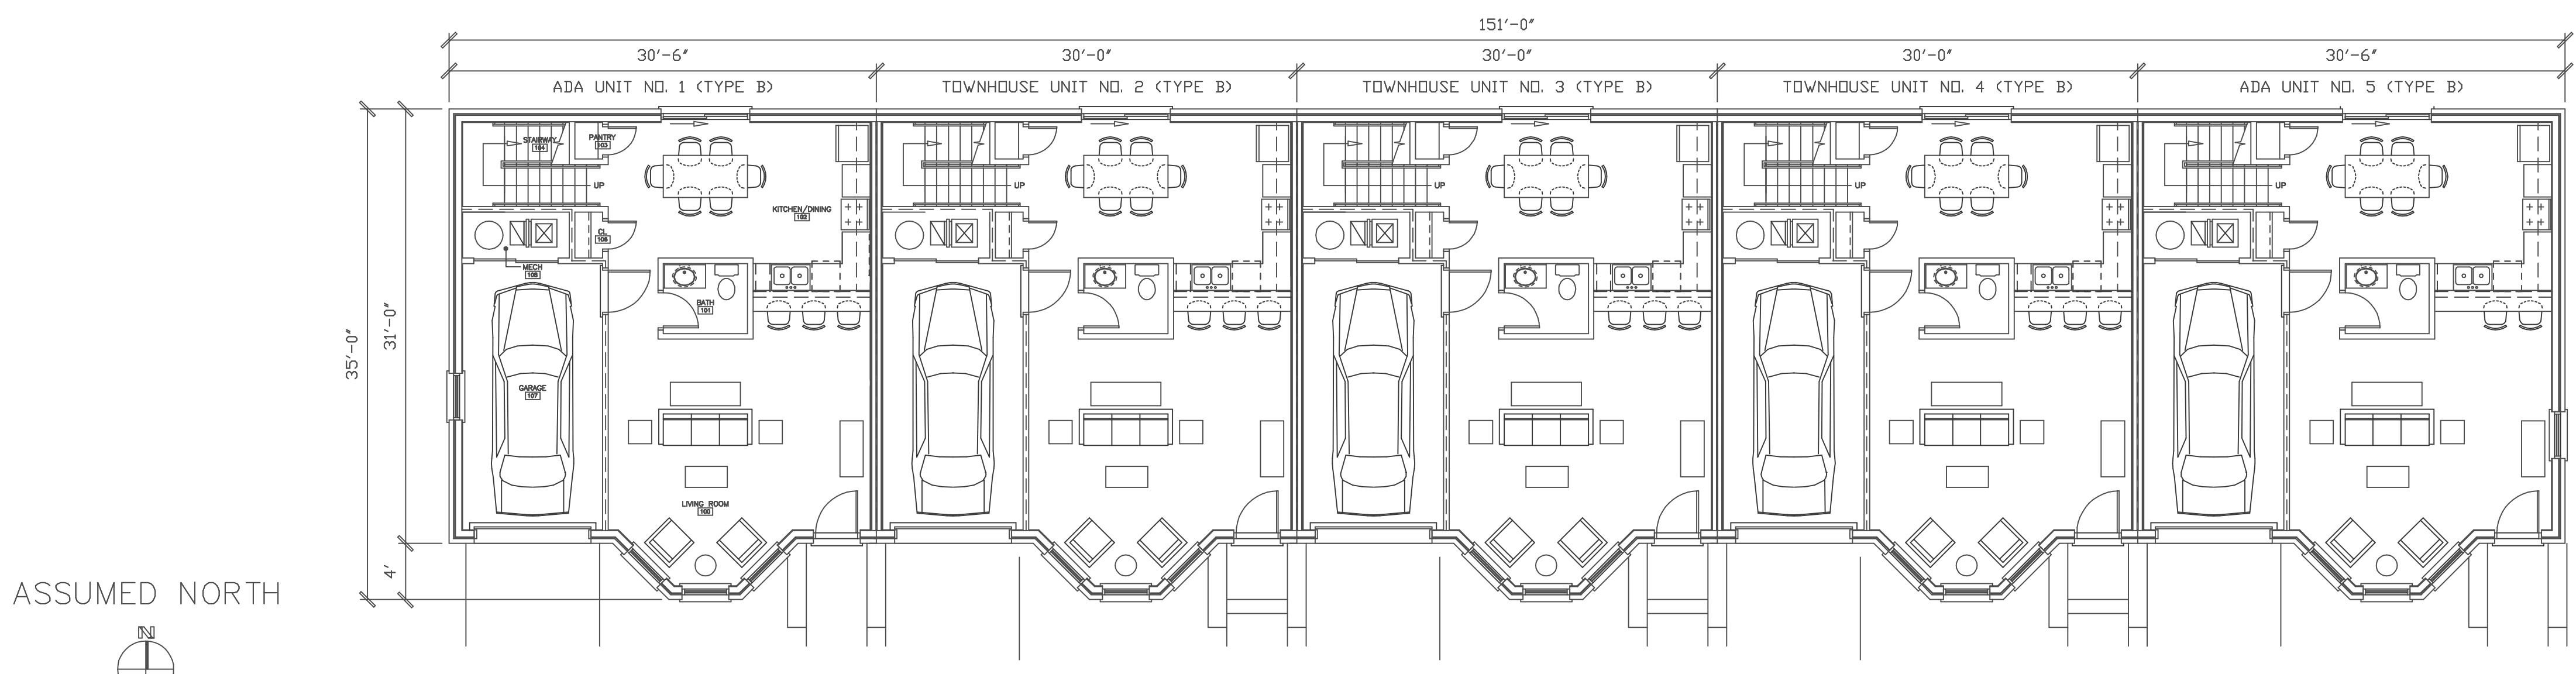
Bldg. No. 2-7
First Floor,
Second Floor
& Roof Plans

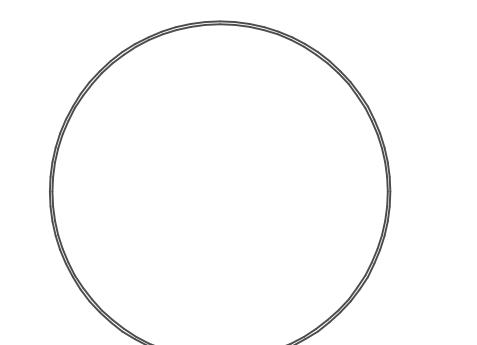A
—
2.0

GENERAL INFORMATION

- BUILDING NO. 2-7: AREA (5 'B' UNITS): 9,820 GROSS SQUARE FOOTAGE 8,360 NET SQUARE FOOTAGE
- UNIT 'B' AREA:
FIRST FLOOR: 982 G.S.F. 848 NET S.F.
SECOND FLOOR: 982 G.S.F. 824 NET S.F.
TOTAL: 1,964 G.S.F. 1,672 NET S.F.

ARCHITECTURAL LEGEND



1 FIRST FLOOR PLAN

SCALE: 1/8"=1'-0"

ASSUMED NORTH

2 SECOND FLOOR PLAN

SCALE: 1/8"=1'-0"

ASSUMED NORTH

3 ROOF PLAN


SCALE: 1/8"=1'-0"

12"x12" METAL SCUPPER THRU PARAPET W/
12"x16" Hx8"D ALUMINUM CONDUCTOR HEAD
W/ 3"x4" ALUM. DOWNSPOUT, TYP.

BUILT-UP ROOF CRICKET, TYP.

45 MIL TPO (WHITE) ROOFING MEMBRANE OVER
MECHANICALLY FASTENED TAPERED ROOF
INSULATION W/ PROTECTION BOARD

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OF UNAUTHORIZED REUSE OR MODIFICATION OF
THESE PLANS BY A THIRD PARTY, THE THIRD
PARTY SHALL HOLD CRAIG T. WATSON, AIA
HARMLESS AND BEAR ALL COSTS INCLUDING LEGAL
FEES ASSOCIATED WITH CRAIG T. WATSON, AIA,
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SCHEMATIC DESIGN
SUBMITTAL 2/6/17

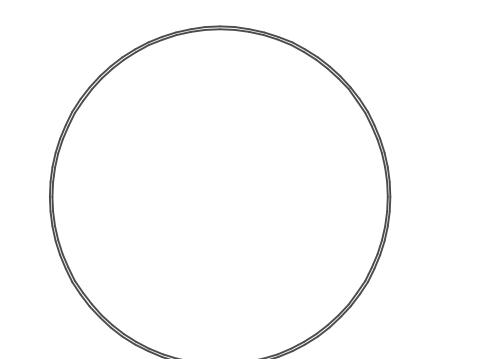
Bldg. No. 1
Exterior
Building
Elevations

A

3.0


MATERIAL LEGEND

- 1 4' HIGH PRE-MOLDED FIBERGLASS ENTABLATURE WITH METAL PARAPET CAP
- 2 4" BRICK VENEER, MATCH EXISTING MASONRY ON WESTERN BAPTIST COLLEGE BUILDING (FORMERLY THE GILLIS ORPHAN HOUSE)
- 3 CAST CONCRETE PANEL/BRICK VENEER CONTROL JOINT WITH BACKER ROD AND SEALANT, COLOR SELECTED BY ARCHITECT
- 4 12"x12" METAL SCUPPER THRU PARAPET W/ 12"x16"x10"D ALUMINUM CONDUCTOR HEAD, COLOR SELECTED BY ARCHITECT
- 5 4"x6" ALUM. DOWNSPOUT W/ HANGERS TOP AND BOTTOM, PLUS ONE AT MID-SPAN, COLOR SELECTED BY ARCHITECT
- 6 4" THICK CAST CONCRETE SILL PANEL WITH SAND TEXTURED FINISH, COLOR SELECTED BY ARCHITECT
- 7 1"x1" RECESSED ACCENT IN CONCRETE SILL PANEL AND CAST CONCRETE WING WALL
- 8 4"Dx5 5/16"H CAST STONE SILL WITH MINIMUM 4" BEARING EACH SIDE OF OPENING
- 9 4"Dx8"H CAST STONE LINTEL WITH MINIMUM 6" BEARING EACH SIDE OF OPENING
- 10 4"Dx5 5/16"H CAST STONE HORIZONTAL BAND
- 11 CAST BRONZE ADDRESS SIGNAGE RECESSED IN BRICK VENEER FACING
- 12 CAST-IN-PLACE CONCRETE FOUNDATION WALL AND FOOTINGS, REFERENCE STRUCTURAL DRAWINGS
- 13 CONCRETE STEPS AND WALKWAYS WITH HEAVY-DUTY BROOM FINISH, REFERENCE CIVIL DRAWINGS
- 14 CAST-IN-PLACE CONCRETE WING WALL, INTEGRAL COLOR FINISH TO BE SELECTED BY ARCHITECT
- 15 SINGLE HUNG VINYL CLAD WOOD WINDOW WITH INSUL. LOW 'E' GLASS
- 16 METAL CLAD WOOD ENTRY DOOR WITH FULL LITE, CLEAR TEMPERED INSULATED GLASS, COLOR SELECTED BY ARCHITECT
- 17 STEEL INSULATED OVERHEAD GARAGE DOOR WITH DOOR OPENER AND KEYPAD
- 18 DOWNSPOUTS ROUTED TO UNDERGROUND STORM DRAINAGE SYSTEM
- 19 16'Lx10'D CONCRETE PATIO W/ HEAVY BROOM FINISH
- 20 METAL CLAD WOOD SLIDING PATIO DOOR W/ SLIDING SCREEN DOOR, FULL LITE, CLEAR TEMPERED INSULATED GLASS

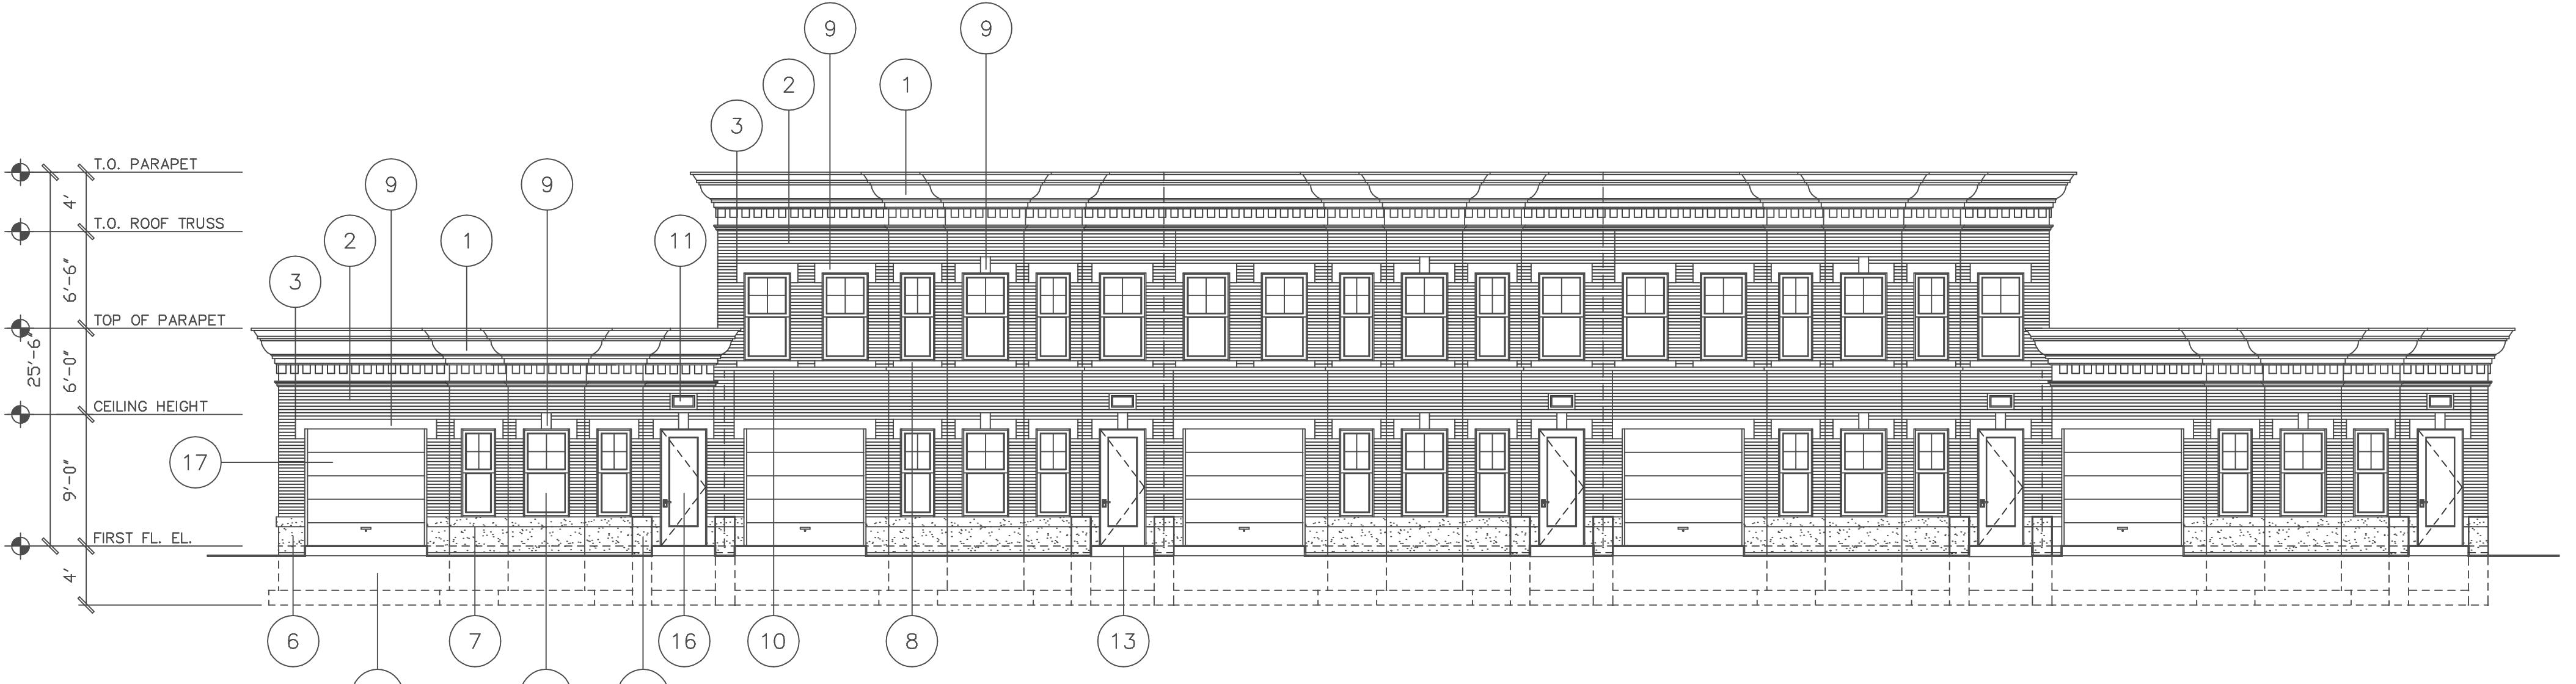


1 FRONT ELEVATION

SCALE: 1/8"=1'-0"

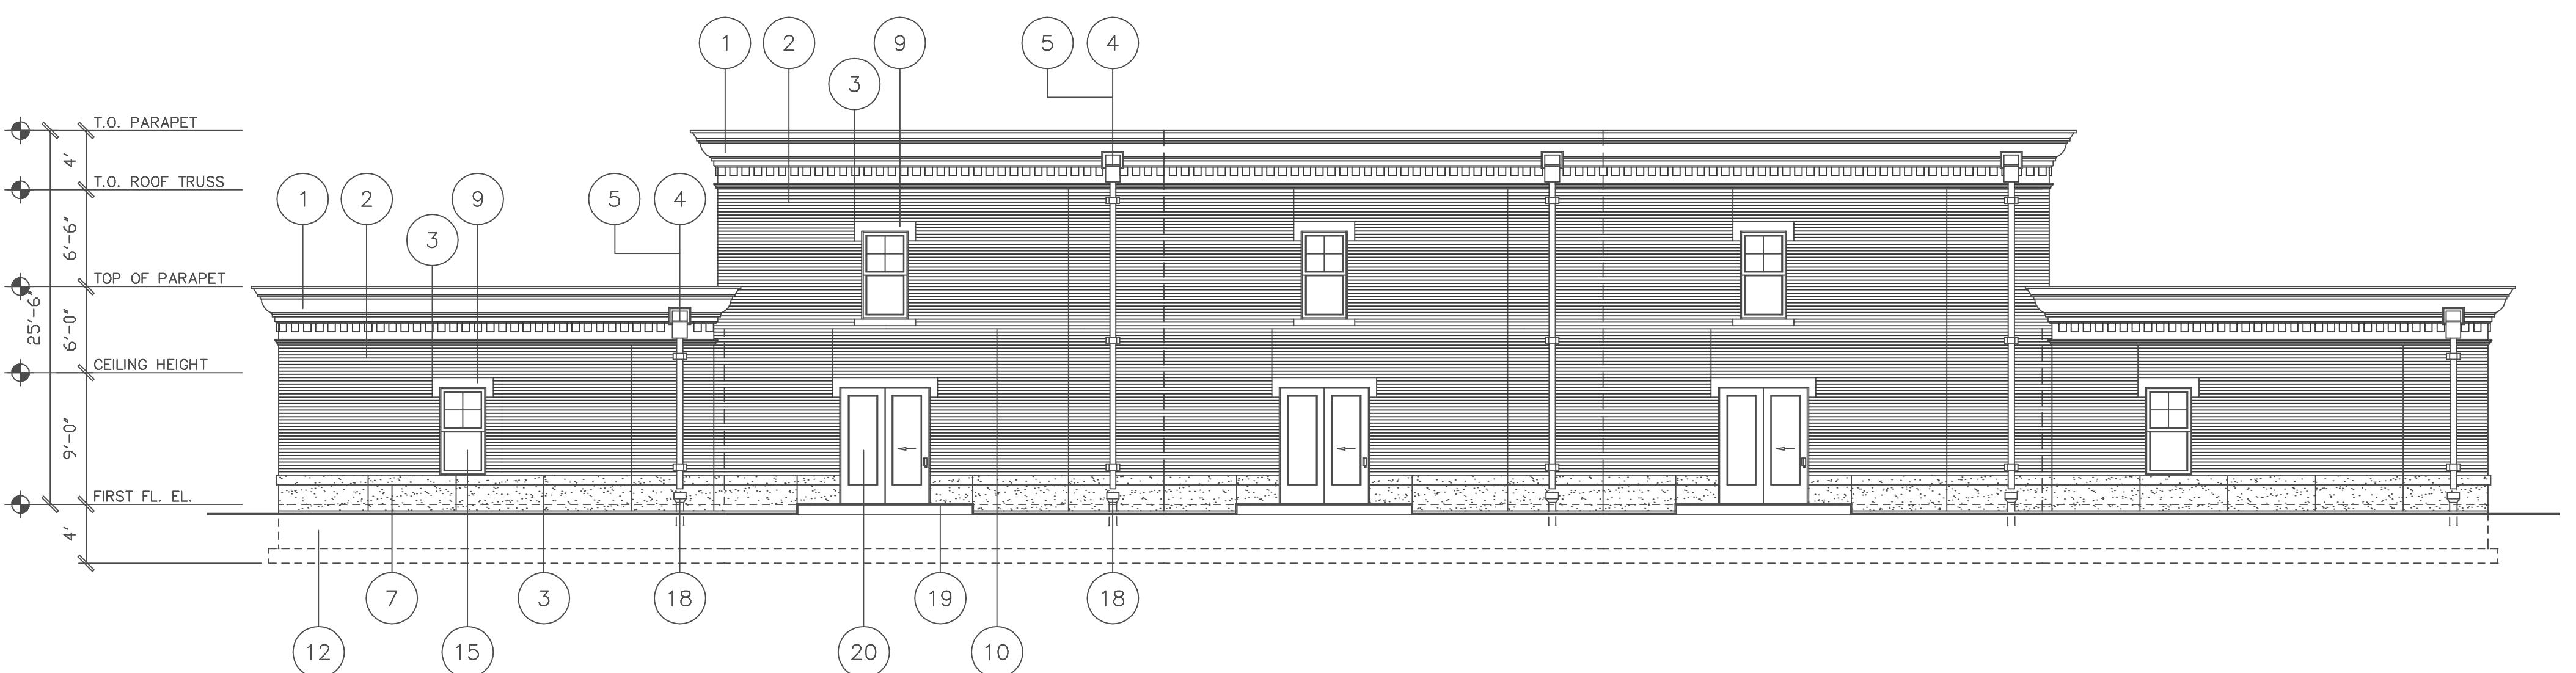


2 REAR ELEVATION

SCALE: 1/8"=1'-0"

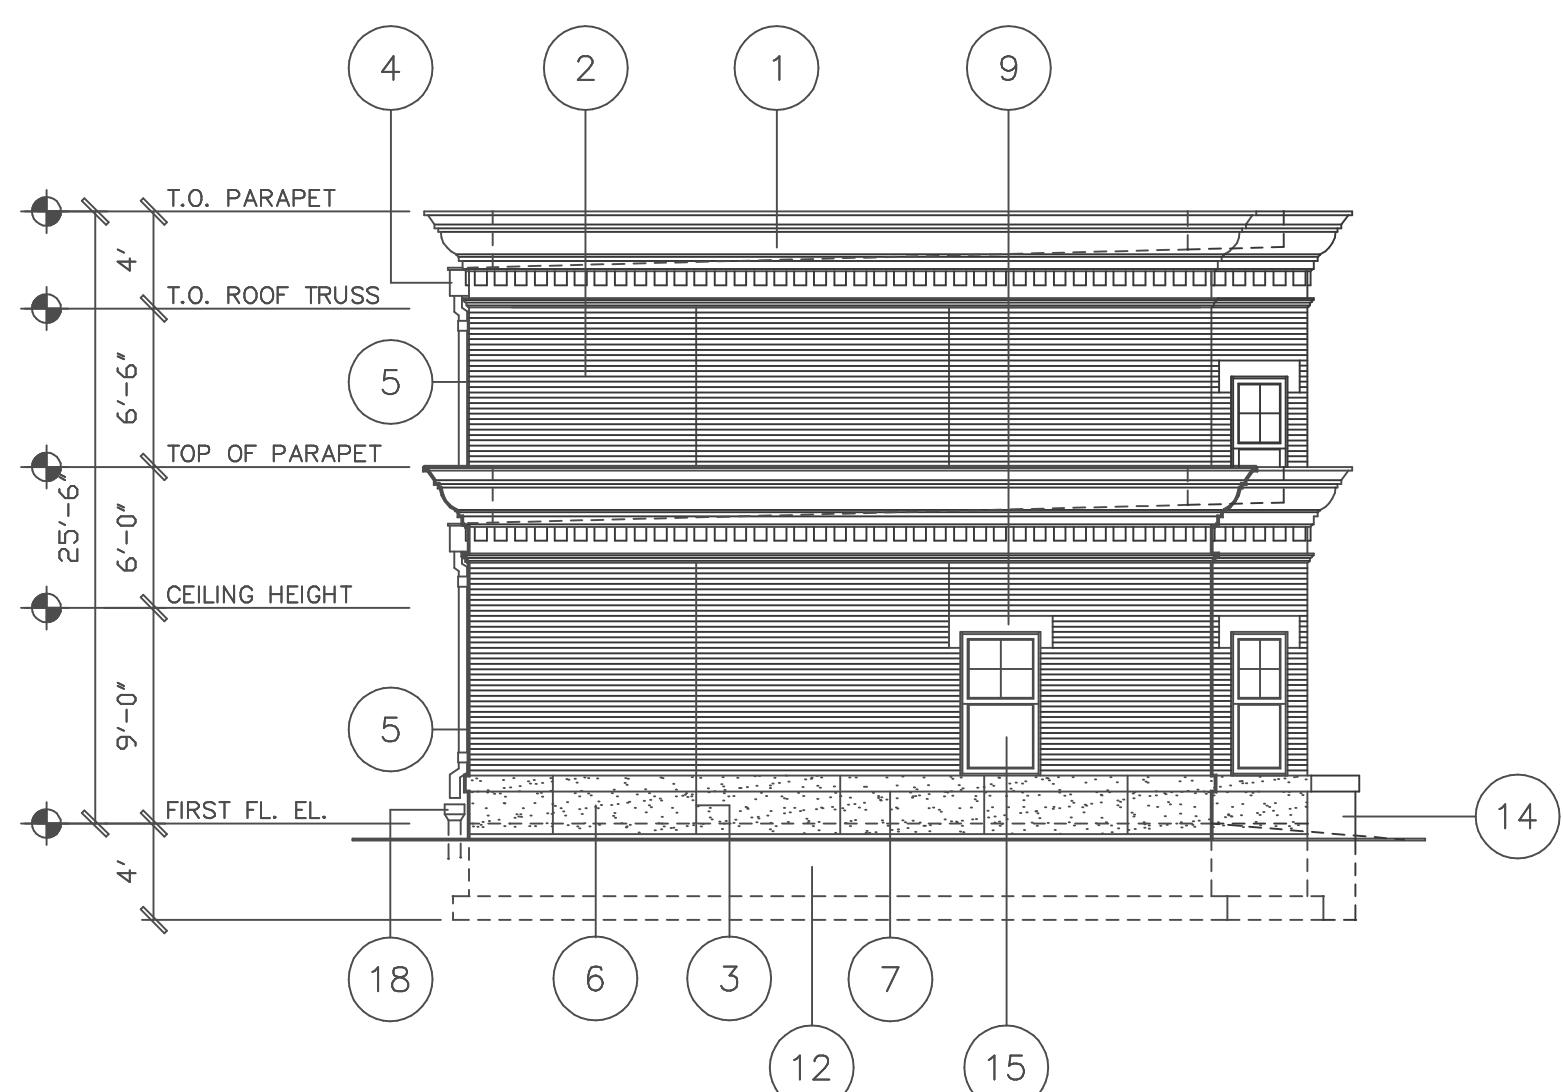

3 LEFT ELEVATION

SCALE: 1/8"=1'-0"

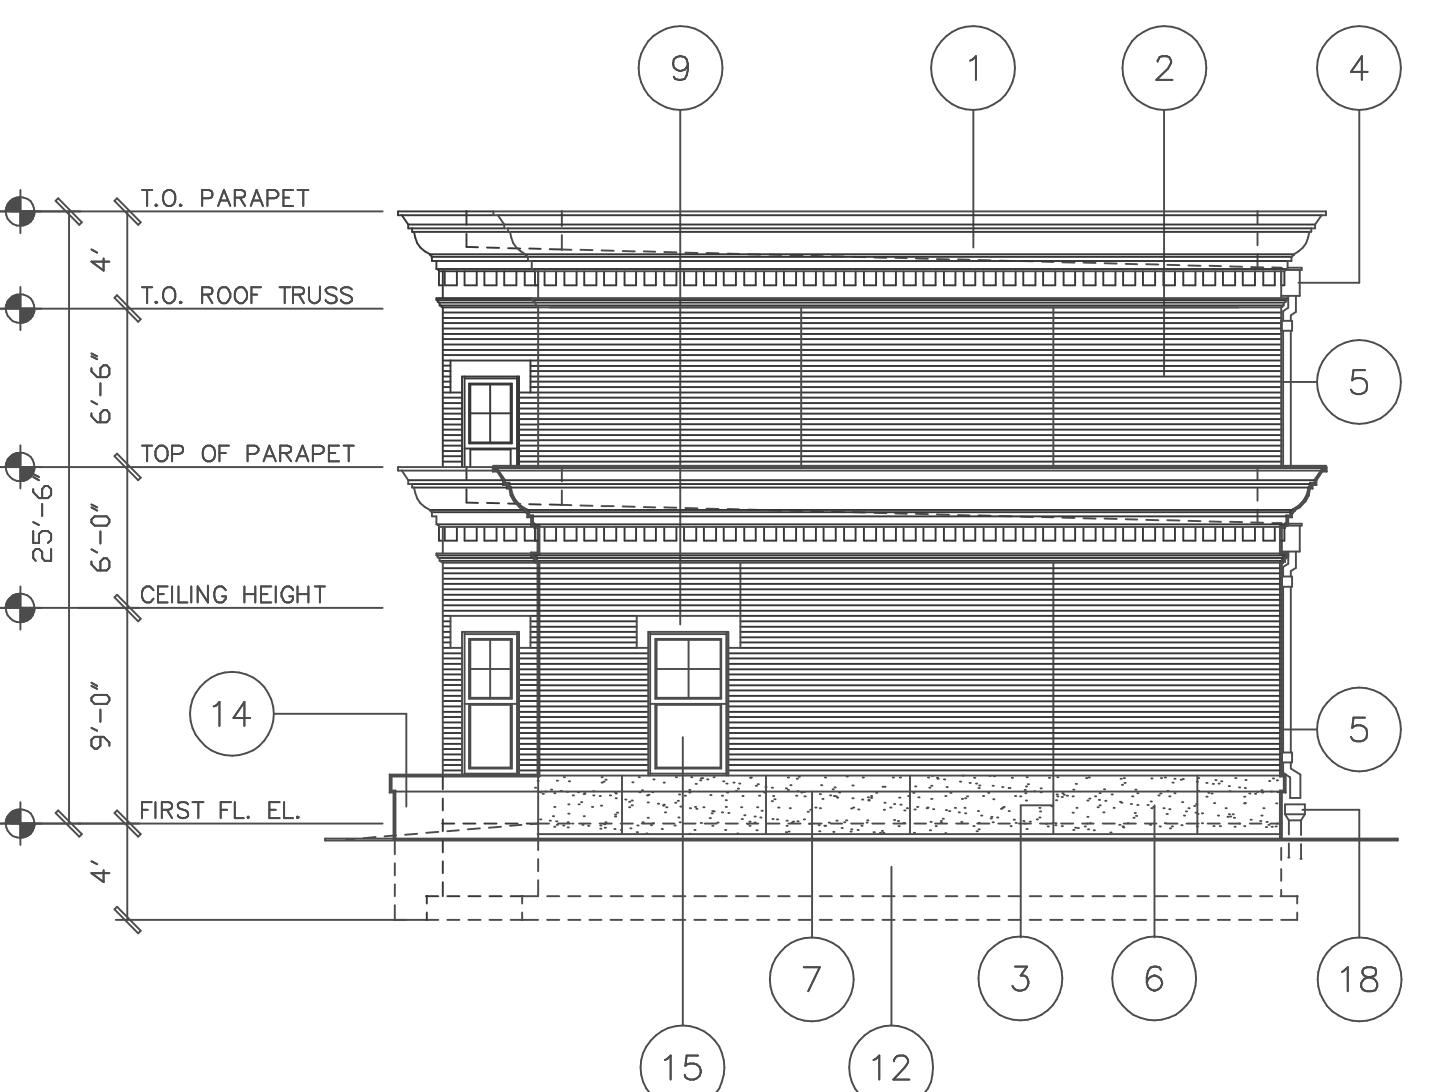

4 RIGHT ELEVATION


SCALE: 1/8"=1'-0"

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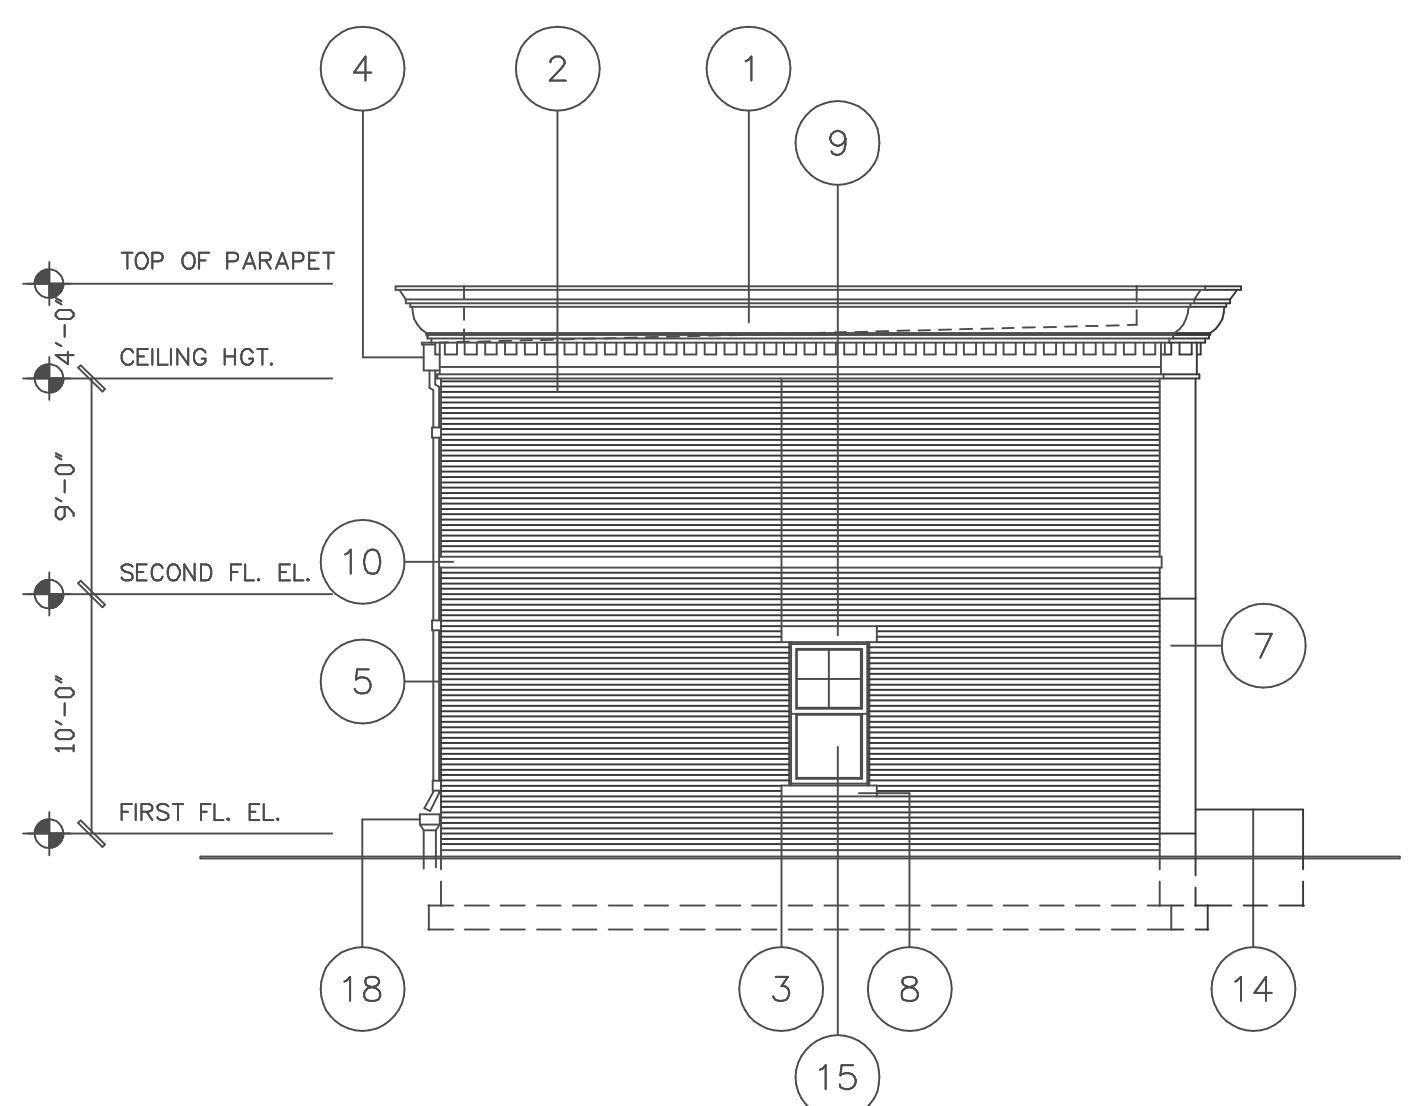
1 FRONT ELEVATION

SCALE: 1/8"=1'-0"




2 REAR ELEVATION

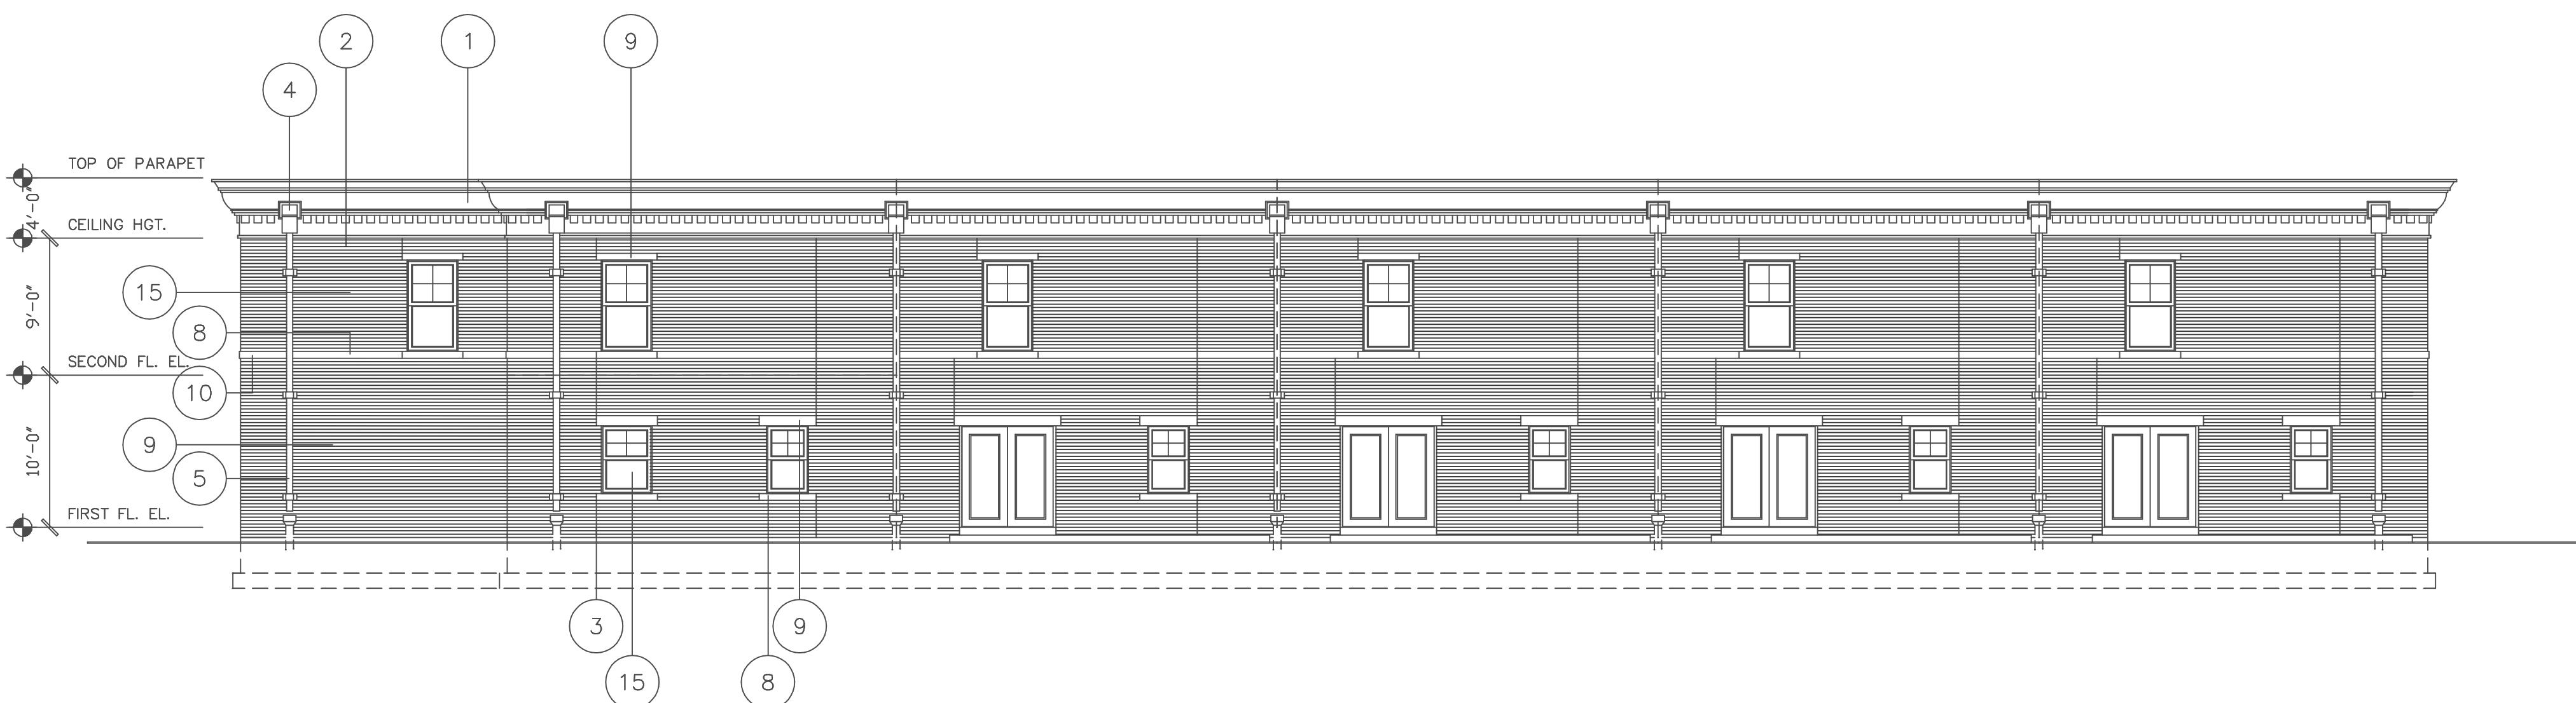SCALE: 1/8"=1'-0"



3 LEFT ELEVATION

SCALE: 1/8"=1'-0"

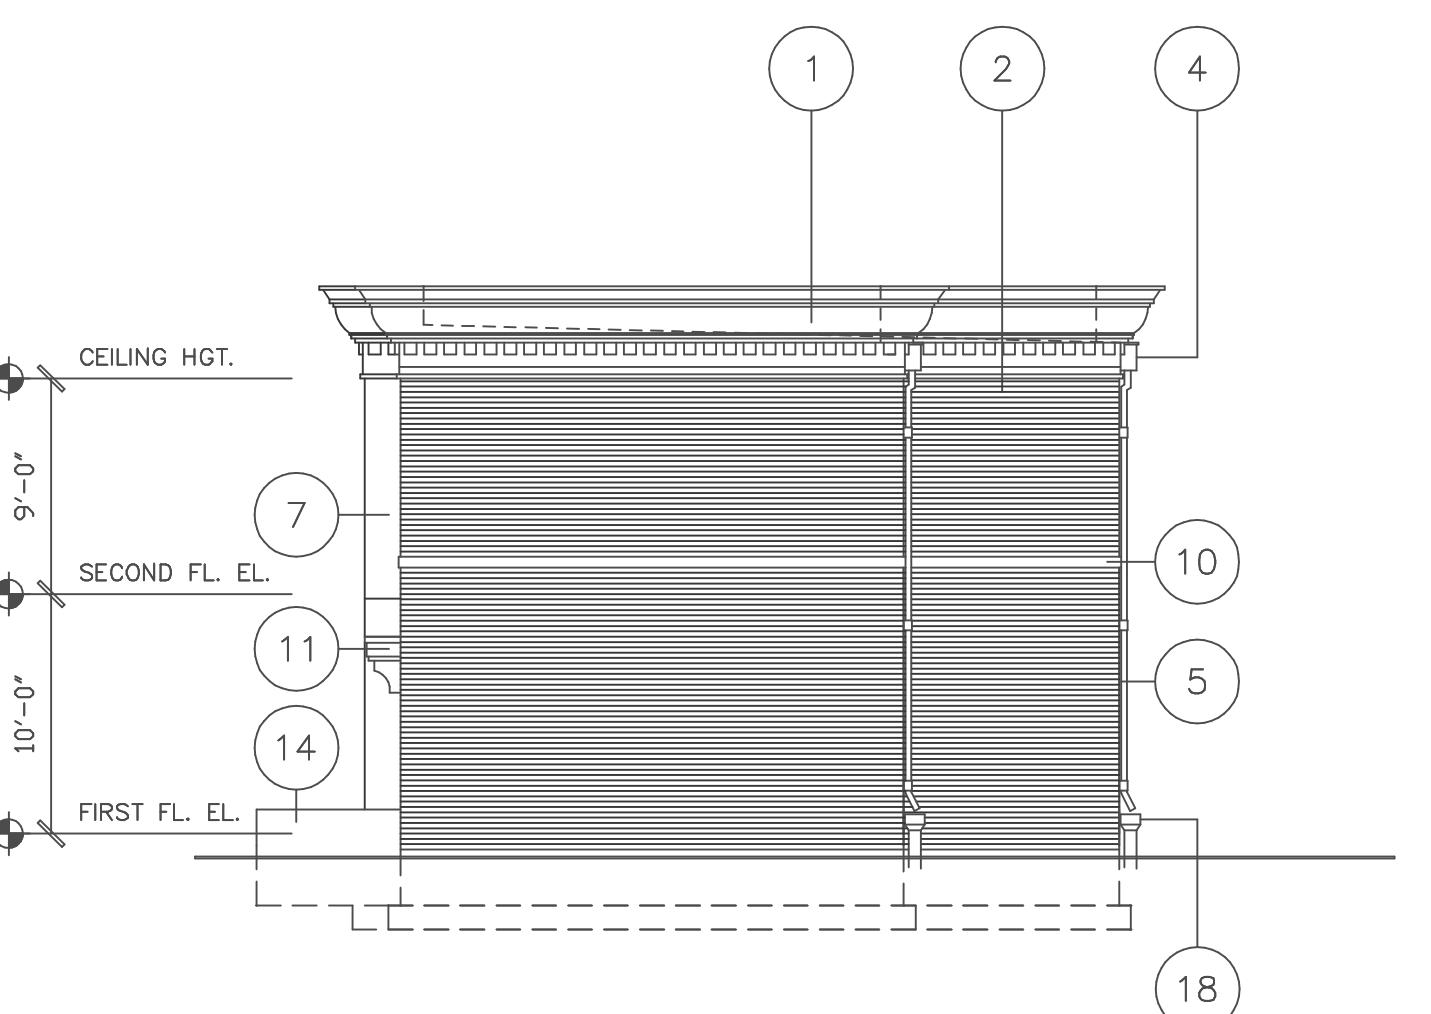

4 RIGHT ELEVATION

SCALE: 1/8"=1'-0"

MATERIAL LEGEND

- 1 4' HIGH PRE-MOLDED FIBERGLASS ENTABLATURE WITH METAL PARAPET CAP
- 2 4" BRICK VENEER, MATCH EXISTING MASONRY ON WESTERN BAPTIST COLLEGE BUILDING (FORMERLY THE GILLIS ORPHAN HOUSE)
- 3 BRICK VENEER CONTROL JOINT WITH BACKER ROD AND SEALANT, COLOR SELECTED BY ARCHITECT
- 4 12"x12" METAL SCUPPER THRU PARAPET W/ 12"x16"x8"D ALUMINUM CONDUCTOR HEAD, COLOR SELECTED BY ARCHITECT
- 5 3"x4" ALUM. DOWNSPOUT W/ HANGERS TOP AND BOTTOM, PLUS ONE AT MID-SPAN, COLOR SELECTED BY ARCHITECT
- 6 METAL CONTROL JOINT IN ACRYLIC STUCCO FINISH
- 7 1" THK. ACRYLIC STUCCO FINISH OVER METAL LATH OVER STUCCO WRAP OVER BUILDING WRAP W/ WALL FLASHING AND WEEP SCREED. INTEGRAL COLOR SELECTED BY ARCHITECT
- 8 4"Dx5 5/16"H CAST STONE SILL WITH MINIMUM 4" BEARING EACH SIDE OF OPENING
- 9 4"Dx8"H CAST STONE LINTEL WITH MINIMUM 4" BEARING EACH SIDE OF OPENING
- 10 4"Dx5 5/16"H CAST STONE HORIZONTAL BAND
- 11 WOOD FRAMED CANOPY W/ DECORATIVE WOOD BRACKET SUPPORT
- 12 CAST BRONZE ADDRESS SIGNAGE RECESSED IN BRICK VENEER FACING
- 13 CONCRETE STAIRS/WALK W/ HEAVY BROOM FINISH
- 14 CAST-IN-PLACE CONCRETE WING WALL ALONG STAIRS/RAMP
- 15 SINGLE HUNG VINYL CLAD WOOD WINDOW WITH INSUL. LOW 'E' GLASS
- 16 METAL CLAD WOOD ENTRY DOOR WITH FULL LITE, CLEAR TEMPERED INSULATED GLASS W/ TRANSOM WINDOW
- 17 STEEL INSULATED OVERHEAD GARAGE DOOR WITH DOOR OPENER AND KEYPAD
- 18 DOWNSPOUTS ROUTED TO UNDERGROUND STORM DRAINAGE SYSTEM
- 19 21'Lx10'D CONCRETE PATIO W/ HEAVY BROOM FINISH
- 20 TREATED WOOD WINDOW TRIM, PAINTED; 2"x5" CROSSHEAD W/ TOP TRIM AND FLASHING AT HEAD, 2"x4" CASING AT JAMBS AND 2"x5" APRON AT SILL, COLOR TO BE SELECTED BY ARCHITECT
- 21 METAL CLAD WOOD SLIDING PATIO DOOR W/ SLIDING SCREEN DOOR, FULL LITE, CLEAR TEMPERED INSULATED GLASS

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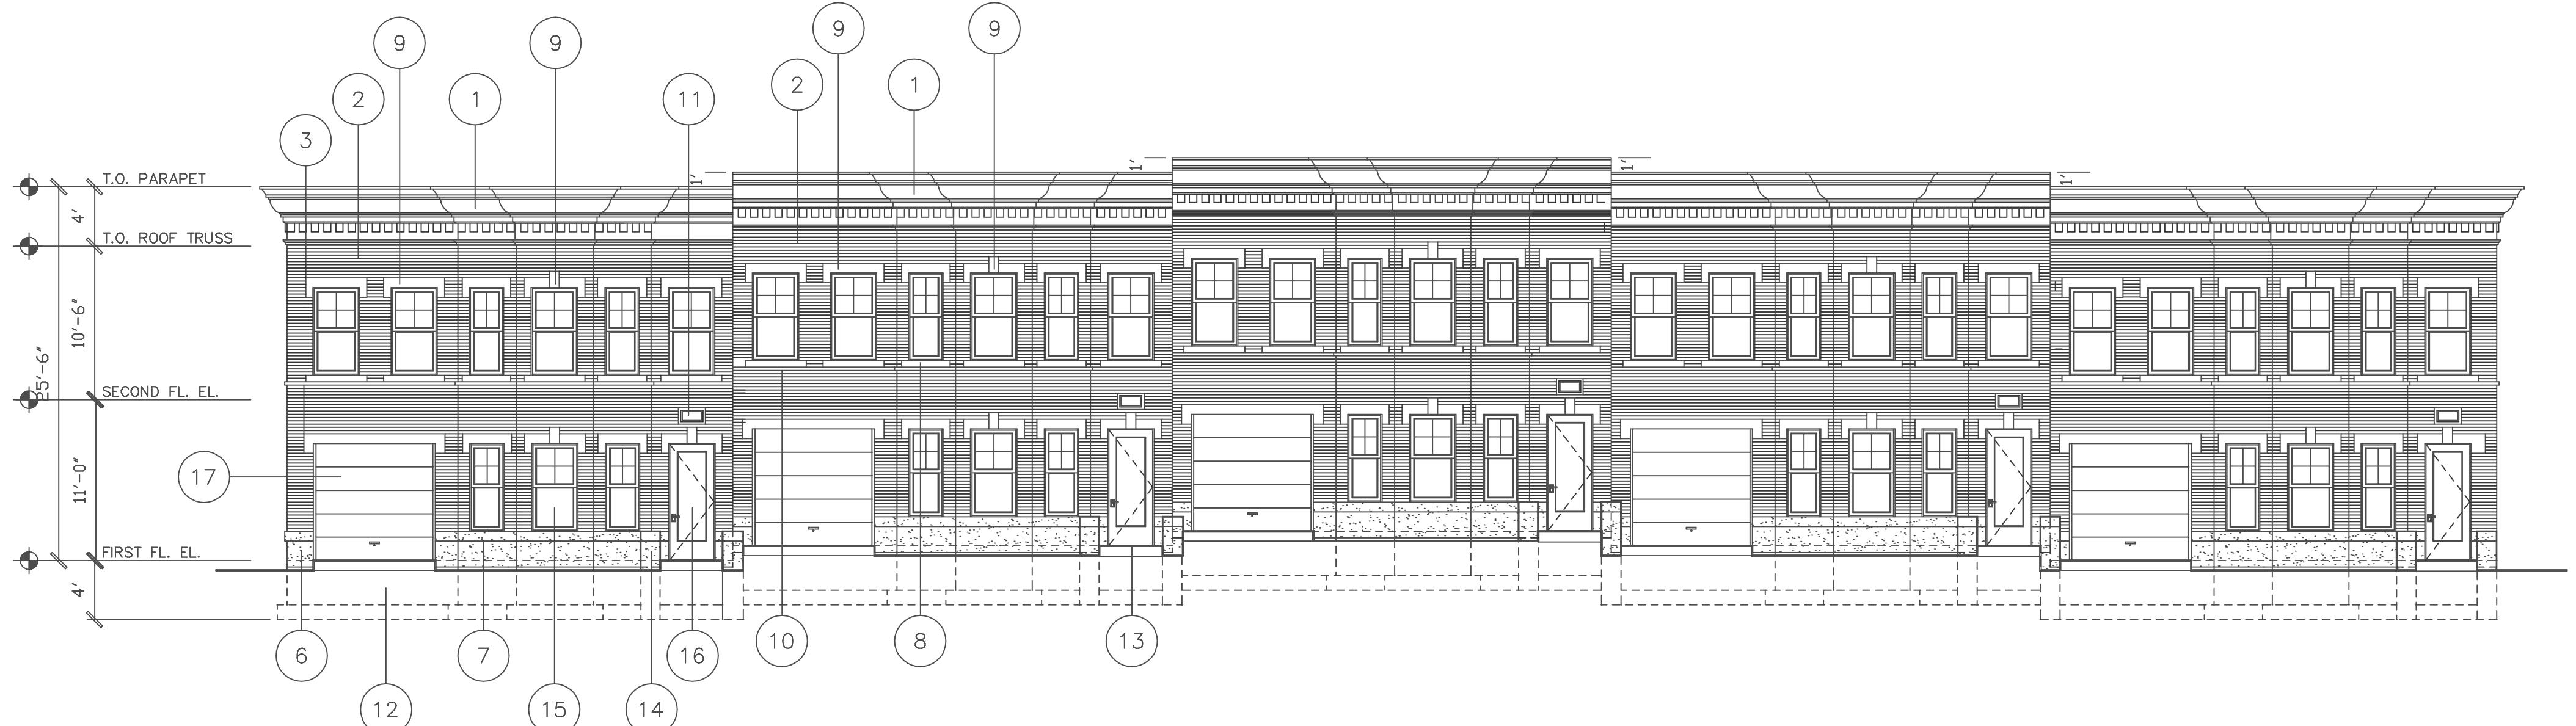
SCHEMATIC DESIGN

SUBMITTAL 2/6/17

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Type 'B':
Building
Exterior
Elevations


A
3.1



1 FRONT ELEVATION

MATERIAL LEGEND	
1	4' HIGH PRE-MOLDED FIBERGLASS ENTABLATURE WITH METAL PARAPET CAP
2	4" BRICK VENEER, MATCH EXISTING MASONRY ON WESTERN BAPTIST COLLEGE BUILDING (FORMERLY THE GILLIS ORPHAN HOUSE)
3	CAST CONCRETE PANEL/BRICK VENEER CONTROL JOINT WITH BACKER ROD AND SEALANT, COLOR SELECTED BY ARCHITECT
4	12"x12" METAL SCUPPER THRU PARAPET W/ 12"x16"x10'D ALUMINUM CONDUCTOR HEAD, COLOR SELECTED BY ARCHITECT
5	4"x6" ALUM. DOWNSPOUT W/ HANGERS TOP AND BOTTOM, PLUS ONE AT MID-SPAN, COLOR SELECTED BY ARCHITECT
6	4" THICK CAST CONCRETE SILL PANEL WITH SAND TEXTURED FINISH, COLOR SELECTED BY ARCHITECT
7	1"x1" RECESSED ACCENT IN CONCRETE SILL PANEL AND CAST CONCRETE WING WALL
8	4"x5 5/16"H CAST STONE SILL WITH MINIMUM 4" BEARING EACH SIDE OF OPENING
9	4"x8" CAST STONE LINTEL WITH MINIMUM 6" BEARING EACH SIDE OF OPENING
10	4"x5 5/16"H CAST STONE HORIZONTAL BAND
11	CAST BRONZE ADDRESS SIGNAGE RECESSED IN BRICK VENEER FACING
12	CAST-IN-PLACE CONCRETE FOUNDATION WALL AND FOOTINGS, REFERENCE STRUCTURAL DRAWINGS
13	CONCRETE STEPS AND WALKWAYS WITH HEAVY-DUTY BROOM FINISH, REFERENCE CIVIL DRAWINGS
14	CAST-IN-PLACE CONCRETE WING WALL, INTEGRAL COLOR FINISH TO BE SELECTED BY ARCHITECT
15	SINGLE HUNG VINYL CLAD WOOD WINDOW WITH INSUL. LOW 'E' GLASS
16	METAL CLAD WOOD ENTRY DOOR WITH FULL LITE, CLEAR TEMPERED INSULATED GLASS, COLOR SELECTED BY ARCHITECT
17	STEEL INSULATED OVERHEAD GARAGE DOOR WITH DOOR OPENER AND KEYPAD
18	DOWNSPOUTS ROUTED TO UNDERGROUND STORM DRAINAGE SYSTEM
19	16'Lx10'D CONCRETE PATIO W/ HEAVY BROOM FINISH
20	METAL CLAD WOOD SLIDING PATIO DOOR W/ SLIDING SCREEN DOOR, FULL LITE, CLEAR TEMPERED INSULATED GLASS
21	CAST-IN-PLACE CONCRETE RETAINING WALL, REFERENCE CIVIL DRAWINGS


SCALE: 1/8"=1'-0"

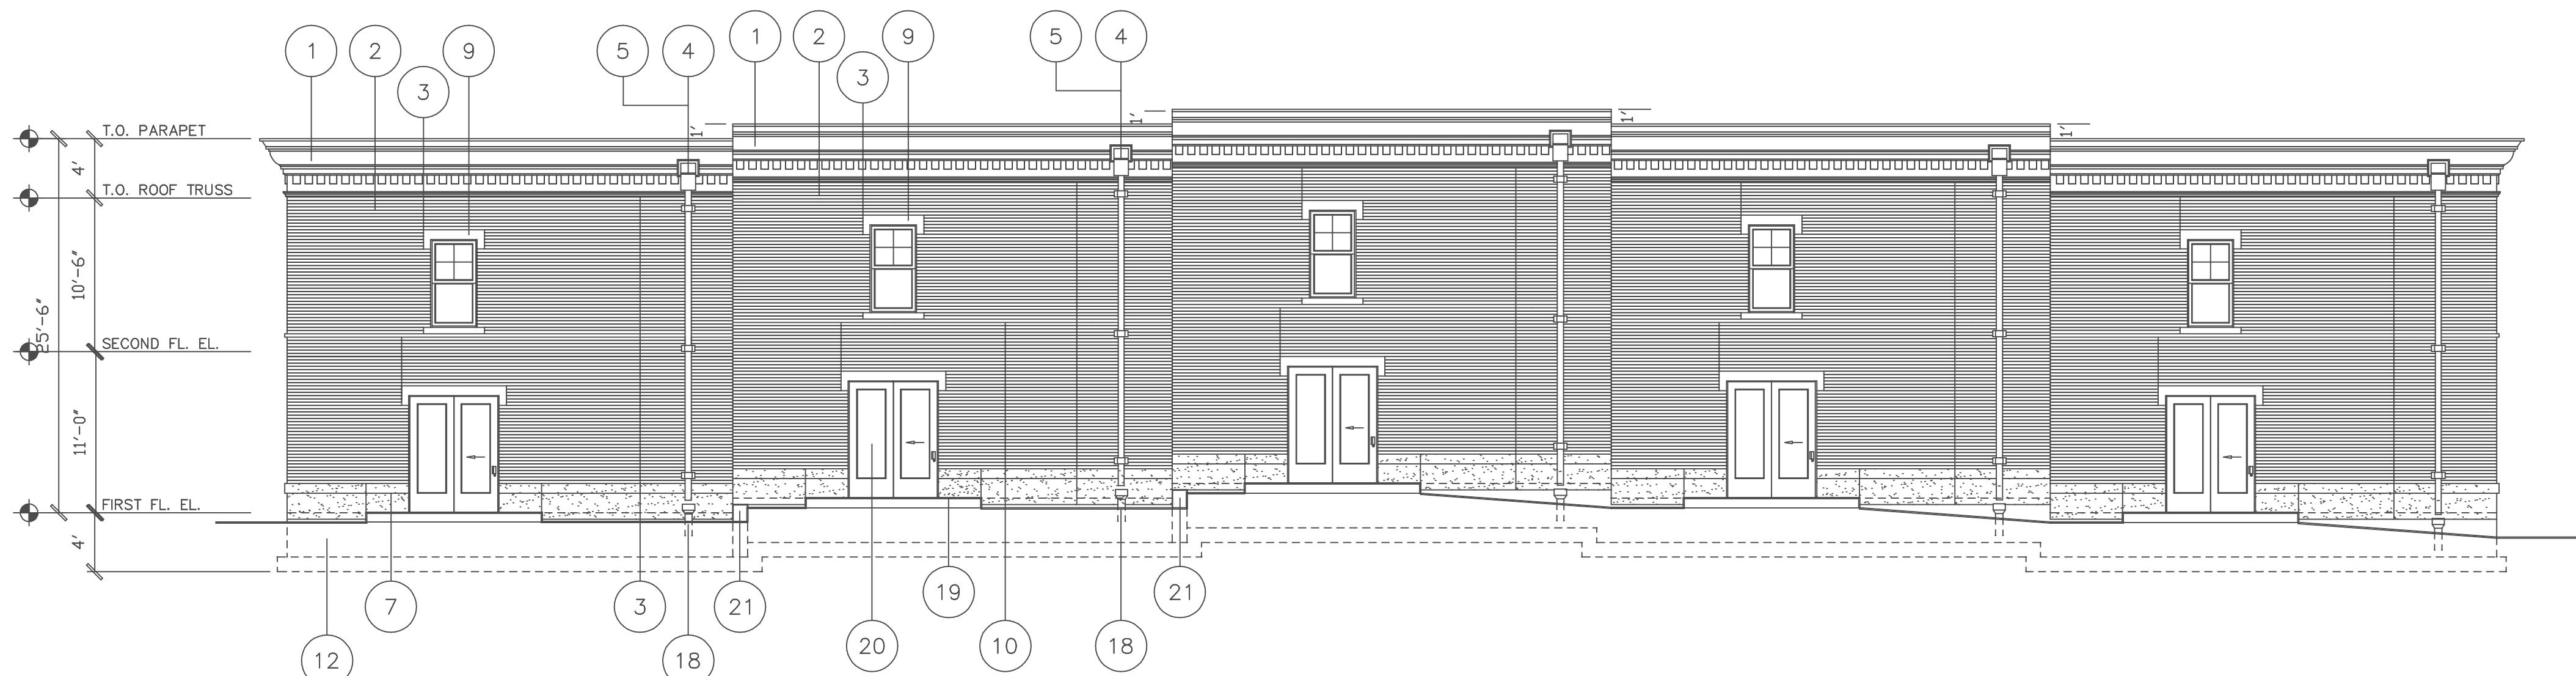

2 REAR ELEVATION


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SUBMITTAL	2/6/17

SCALE: 1/8"=1'-0"

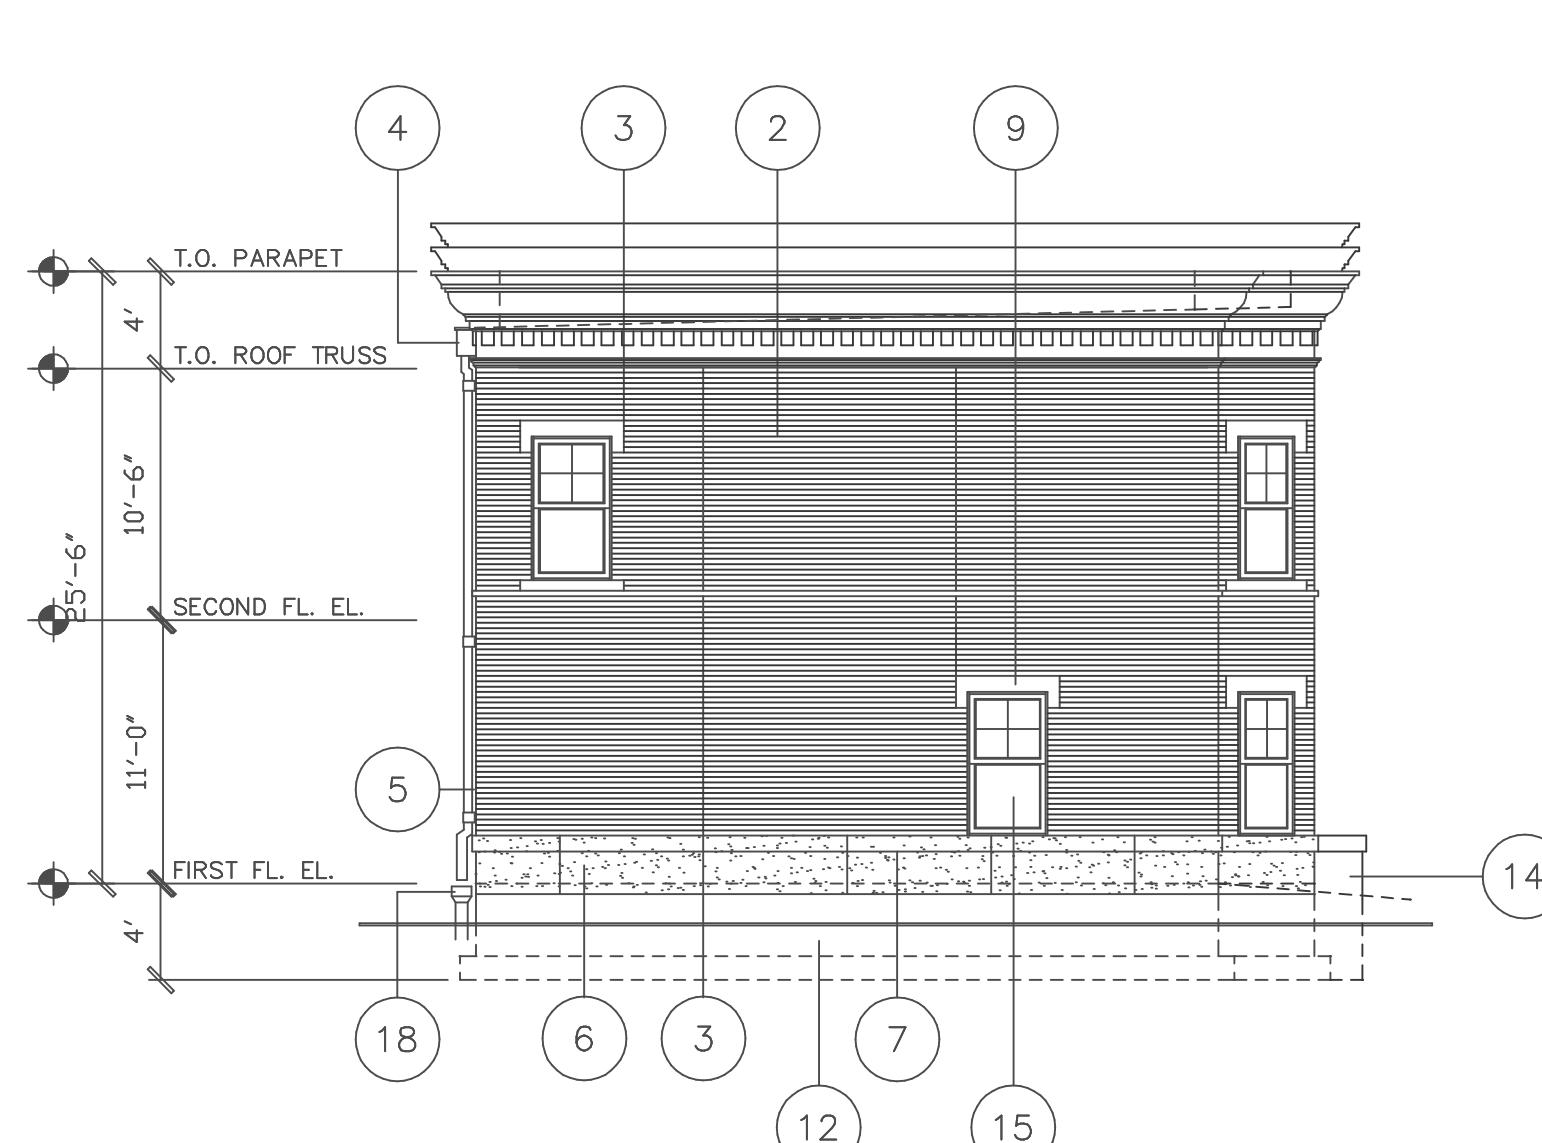

3 LEFT ELEVATION

SCALE: 1/8"=1'-0"

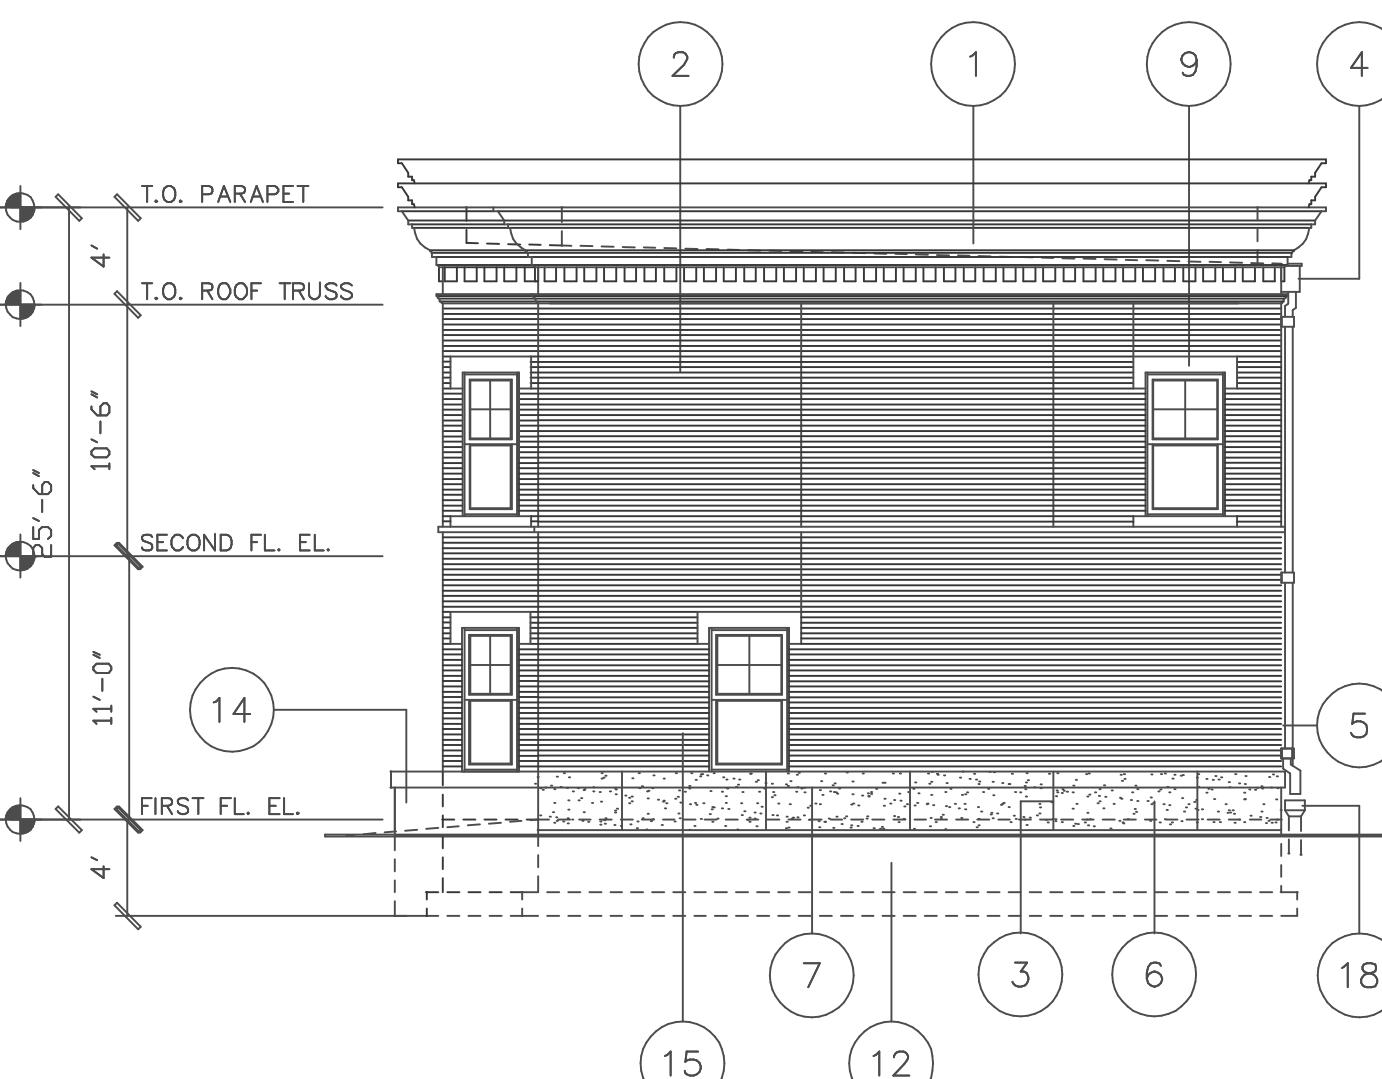

4 RIGHT ELEVATION

SCALE: 1/8"=1'-0"

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A
3.2

Bldg. No. 3-7
Exterior
Building
Elevations

GILLIS / WESTERN BAPTIST BIBLE COLLEGE

DESIGN DEVELOPMENT

2119 TRACY AVENUE, KANSAS CITY, MO 64108
AUGUST 25, 2017

OWNER: DISTRICT ROW, LLC 1601 E. 18TH STREET, SUITE 120 KANSAS CITY, MO 64108 T: 816.474.0900
CONTACT: KAREN CURLS

ARCHITECT OF RECORD: STRATA ARCHITECTURE INC. 1701 OAK STREET, SUITE 100 KANSAS CITY, MO 64108 T: 816.474.0900
CONTACT: ANGIE GAEBLER, AIA - PROJECT ARCHITECT


CIVIL ENGINEER: DUBOIS CONSULTANTS 5737 SWOPE PARKWAY KANSAS CITY, MO 64130 T: 816.333.7700
CONTACT:

STRUCTURAL ENGINEER: DUBOIS CONSULTANTS 5737 SWOPE PARKWAY KANSAS CITY, MO 64130 T: 816.333.7700
CONTACT: ADEIL W. TAUHEED

MEP: CUSTOM ENGINEERING, INC. 12760 EAST HIGHWAY 40 INDEPENDENT, MO 64055 T: 816.350.1473
CONTACT: ANDREW DAILEY



WESTERN BAPTIST BIBLE COLLEGE BUILDING REHABILITATION 2119 TRACY AVE. KANSAS CITY, MO 64108

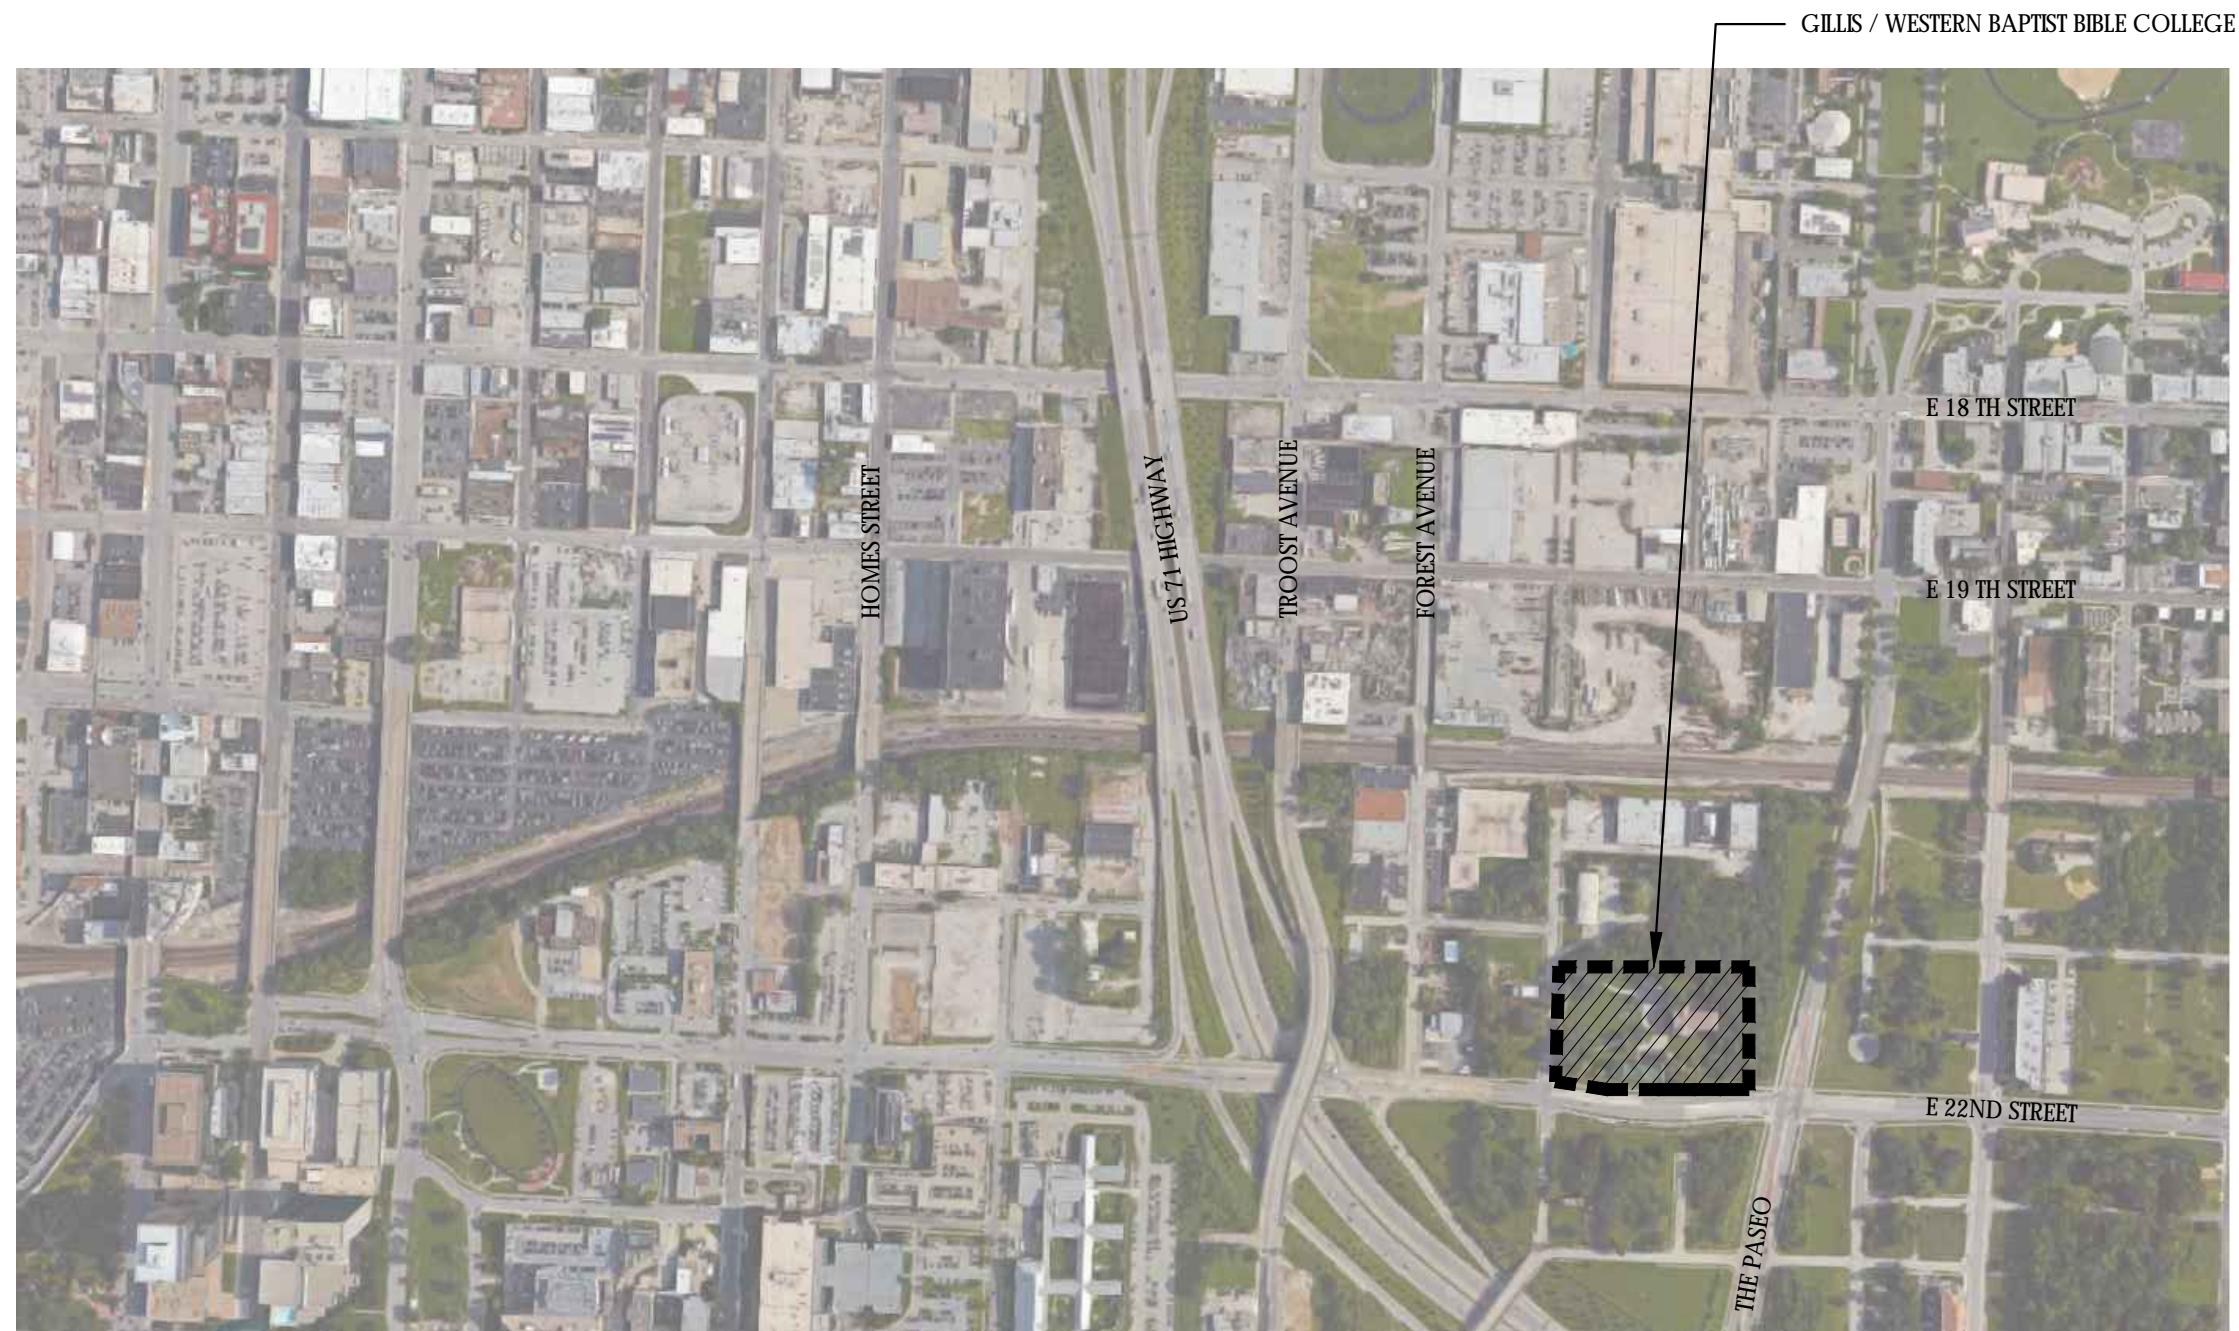

SITE VICINITY MAP



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G000 COVER

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C101 SITE DETAILS

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A003 WINDOW SCHEDULE
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AD101 DEMOLITION FIRST FLOOR PLAN
AD102 DEMOLITION SECOND FLOOR PLAN
AD103 DEMOLITION THIRD FLOOR PLAN
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A221 WEST ELEVATION ENLARGED ELEVATIONS
A222 WEST ELEVATION ENLARGED ELEVATIONS
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A501 ENLARGED PLANS - STAIRS
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A601 INTERIOR ELEVATIONS
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S002 LEGENDS & ABBREVIATIONS
S003 STANDARD CONCRETE DETAILS
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DX101 DEMOLITION FIRST FLOOR PLAN
DX102 DEMOLITION SECOND FLOOR PLAN
DX103 DEMOLITION THIRD FLOOR PLAN
S100 GROUND FLOOR PLAN
S101 FIRST FLOOR PLAN
S102 SECOND FLOOR PLAN
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E001 ELECTRICAL SITE PLAN
E100 POWER GROUND FLOOR PLAN
E101 POWER GROUND FLOOR PLAN
E102 POWER SECOND FLOOR PLAN
E103 POWER THIRD FLOOR PLAN
E104 POWER ROOF FLOOR PLAN
E105 POWER ATTIC FLOOR PLAN
E200 LIGHTING GROUND FLOOR PLAN
E201 LIGHTING FIRST FLOOR PLAN
E202 LIGHTING SECOND FLOOR PLAN
E203 LIGHTING THIRD FLOOR PLAN
E204 LIGHTING ATTIC
E300 ELECTRICAL ONE-LINE
E400 ELECTRICAL DETAILS
E401 LIGHT FIXTURE SCHEDULE

FIRE ALARM PLAN:

FA100 FIRE ALARM GROUND PLAN
FA101 FIRE ALARM FIRST FLOOR PLAN
FA102 FIRE ALARM SECOND FLOOR PLAN
FA103 FIRE ALARM ATTIC FLOOR PLAN
FS100 FIRE SPRINKLER GROUND FLOOR PLAN
FS101 FIRE SPRINKLER FIRST FLOOR PLAN
FS102 FIRE SPRINKLER SECOND FLOOR PLAN
FS103 FIRE SPRINKLER THIRD FLOOR PLAN
FS104 FIRE SPRINKLER ATTIC FLOOR PLAN
FS105 FIRE SPRINKLER SYSTEM RISER

MECHANICAL DRAWINGS:
M000 MECHANICAL LEGEND
M100 MECHANICAL BASEMENT FLOOR PLAN
M101 MECHANICAL FIRST FLOOR PLAN
M102 MECHANICAL SECOND FLOOR PLAN
M103 MECHANICAL THIRD FLOOR PLAN
M104 MECHANICAL ROOF FLOOR PLAN


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P000 PLUMBING LEGEND
P001 PLUMBING SCHEDULES
P100 PLUMBING GROUND FLOOR PLAN
P101 PLUMBING FIRST FLOOR PLAN
P102 PLUMBING SECOND FLOOR PLAN
P103 PLUMBING THIRD FLOOR PLAN
P104 PLUMBING ROOF FLOOR PLAN
P201 PLUMBING DETAILS

All drawings and written information appearing herein shall not be duplicated, disclosed or otherwise used without the written consent of the architect.

DATE: AUGUST 25, 2017
REVISION & DATE:

DESIGN DEVELOPMENT
COVER
SHEET NUMBER:

G000

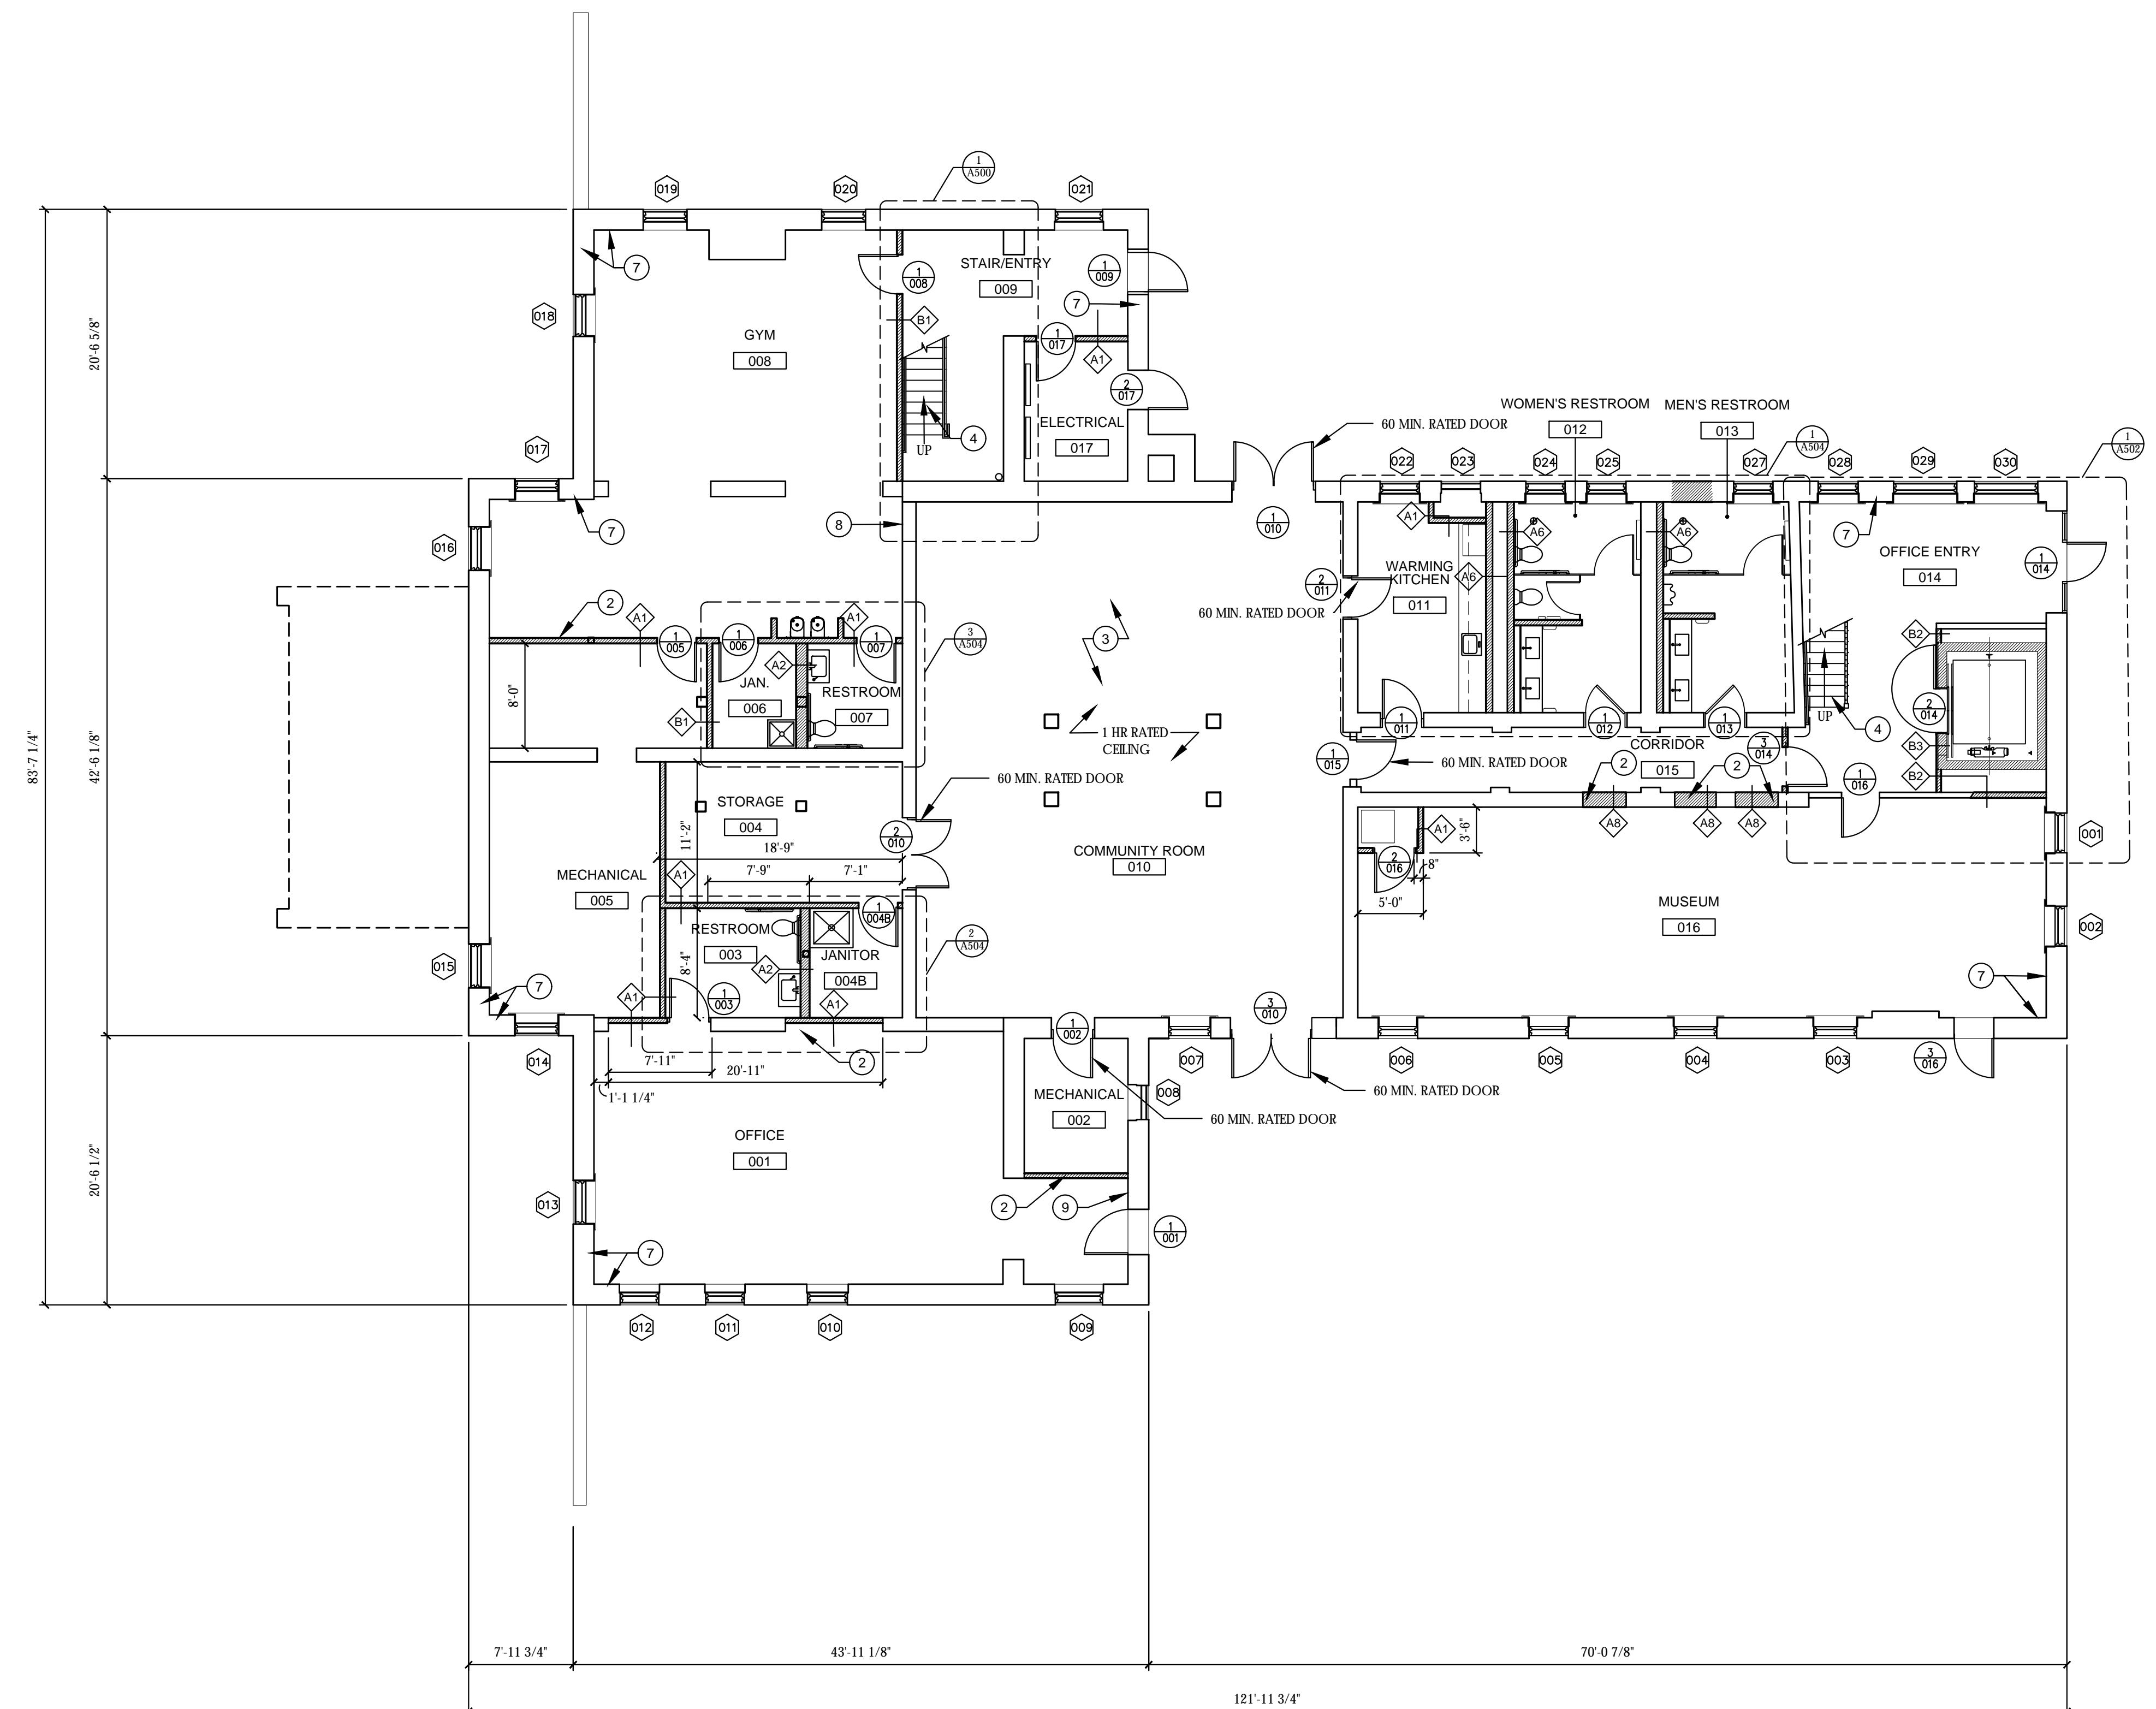

GENERAL FLOOR PLAN NOTES:

- A. THE WORK IN THESE DOCUMENTS IS BEING DONE TO AN EXISTING STRUCTURE. THE CONTRACTOR WILL BE SOLELY RESPONSIBLE FOR FIELD VERIFICATION OF ALL EXISTING CONDITIONS PRIOR TO COMMENCEMENT OF WORK. ARCHITECT SHALL BE NOTIFIED IMMEDIATELY OF ANY DISCREPANCIES DETERMINAL TO THE PROPER EXECUTION OF NEW CONSTRUCTION.
- B. ALL DIMENSIONS ARE TO FACE OF FINISH MATERIAL OR CENTERLINE OF STRUCTURAL COMPONENTS, UNLESS NOTED OTHERWISE.
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KEYED NOTES - FLOOR PLANS:


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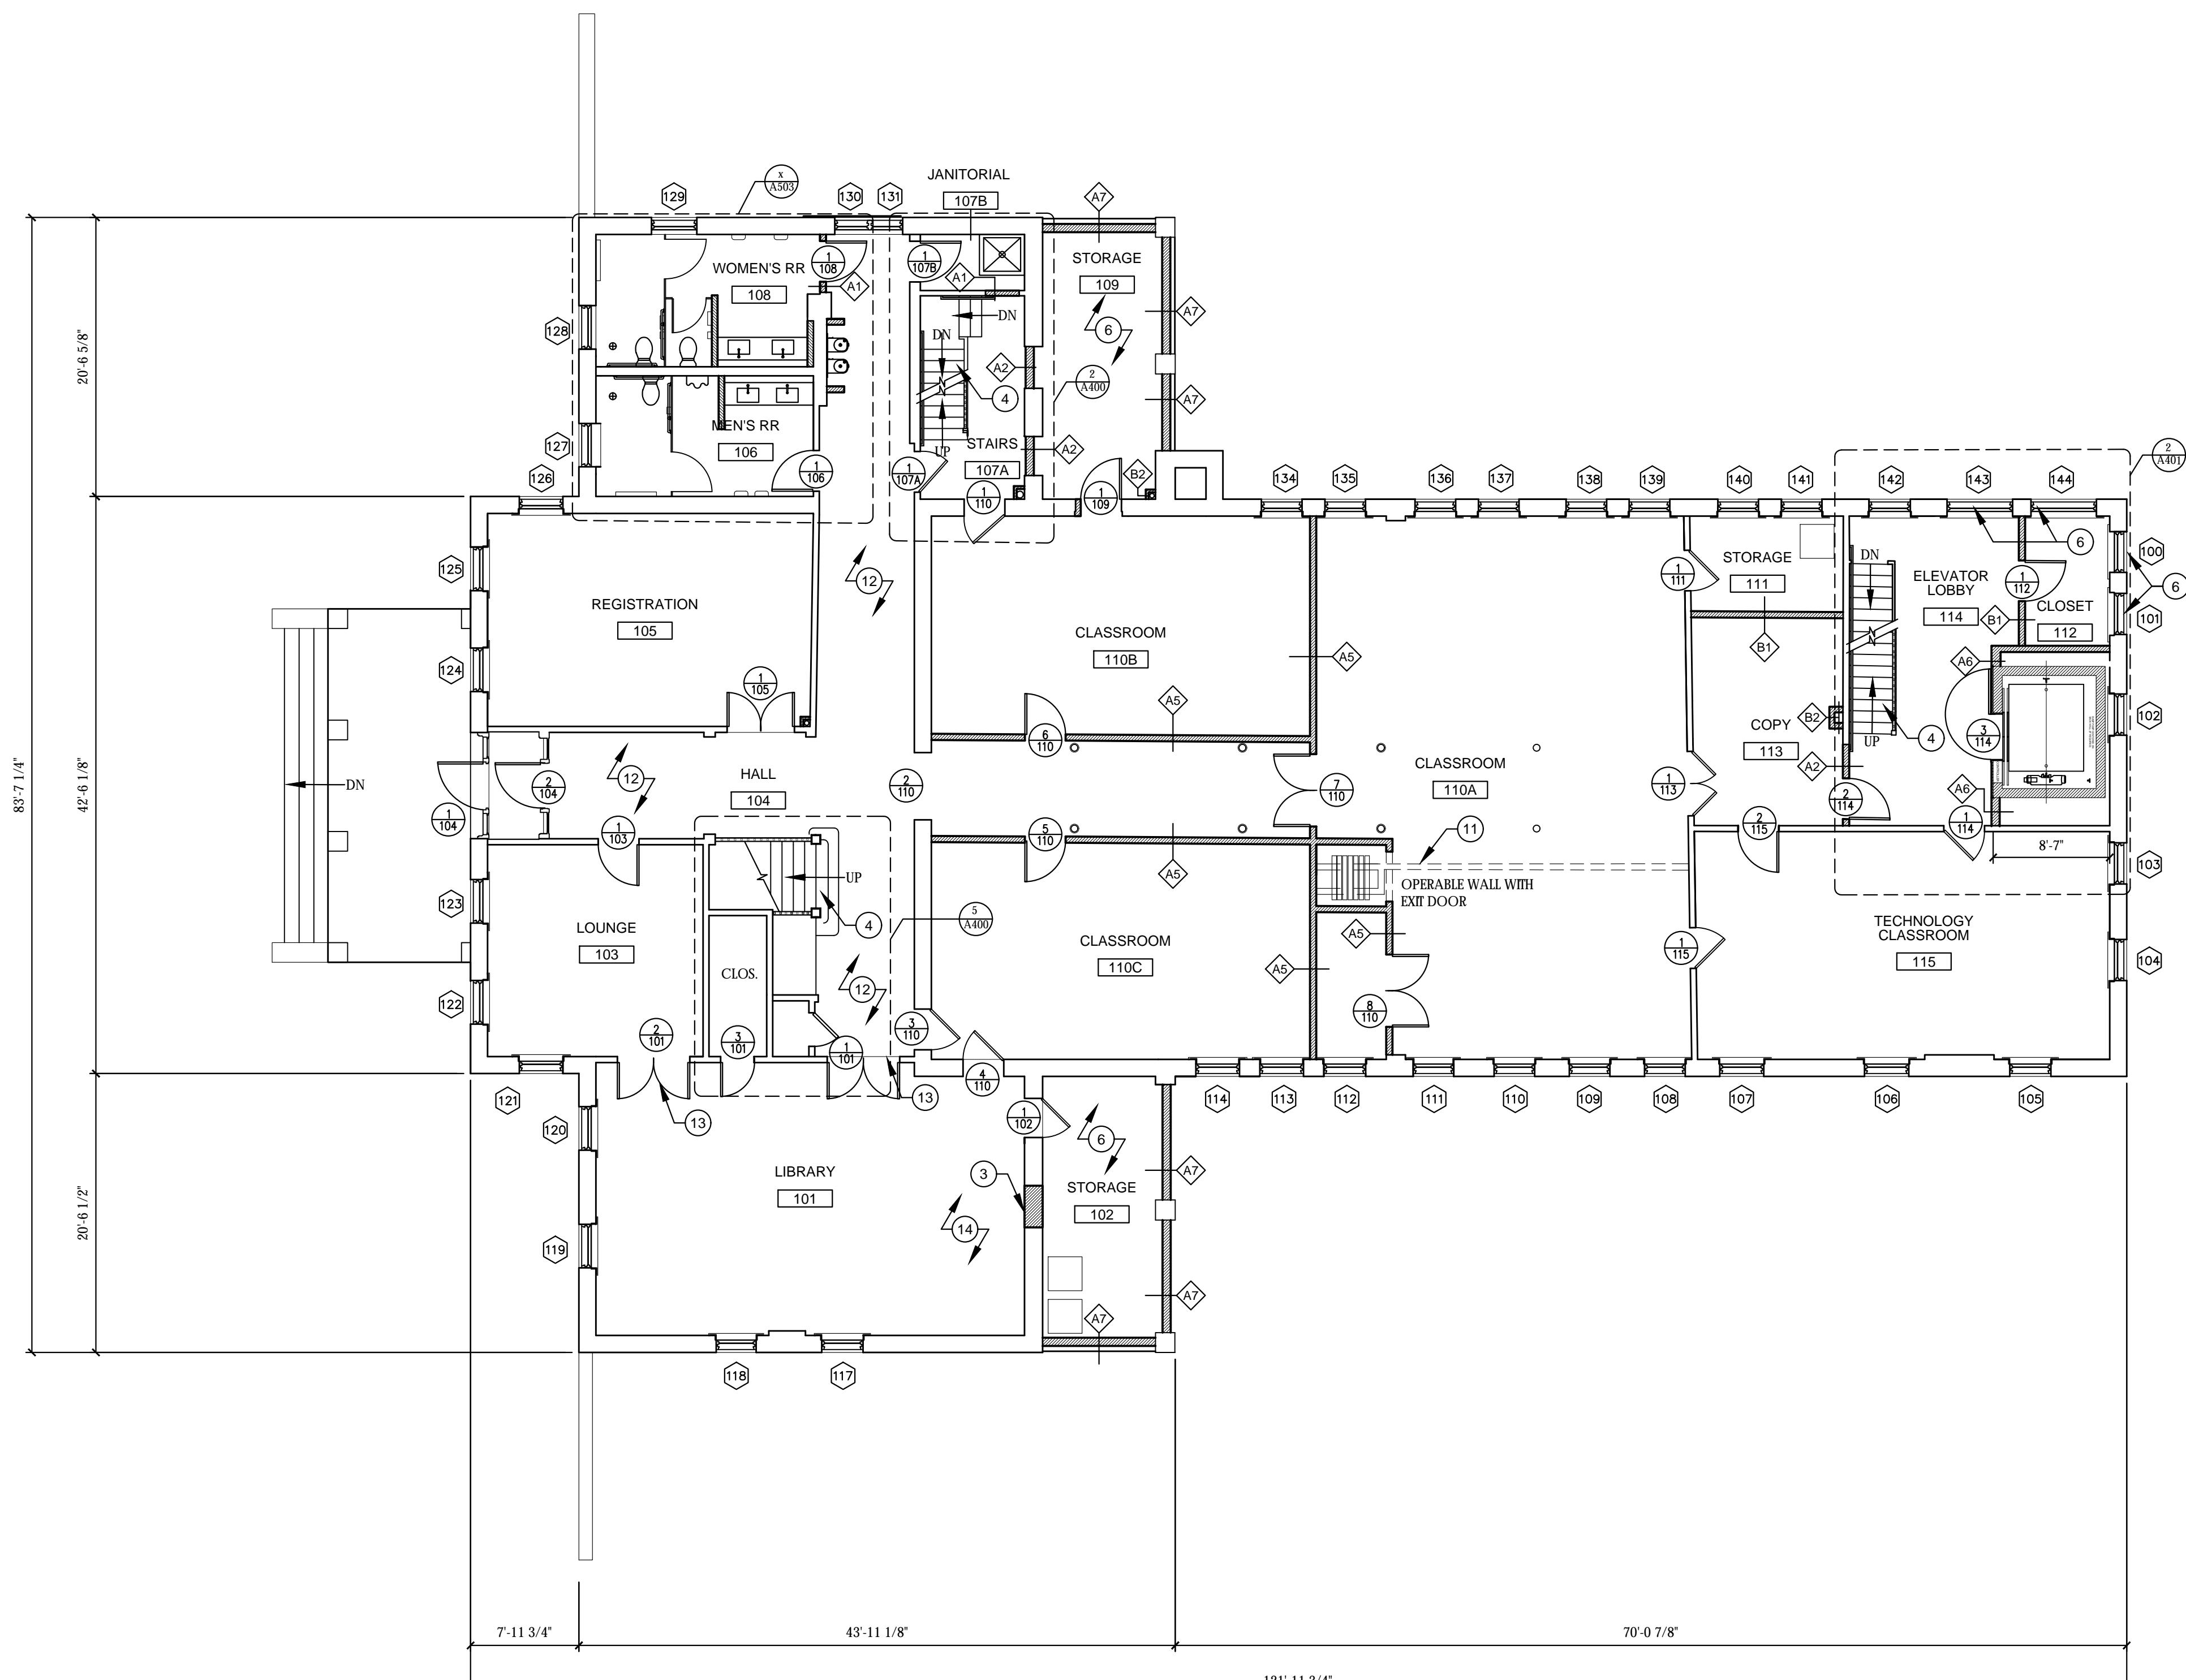
DATE: AUGUST 25, 2017
REVISION & DATE:

DESIGN DEVELOPMENT
GROUND FLOOR PLAN
SHEET NUMBER:

A100



WESTERN BAPTIST BIBLE COLLEGE
BUILDING REHABILITATION
2119 TRACY AVE.
KANSAS CITY, MO 64108

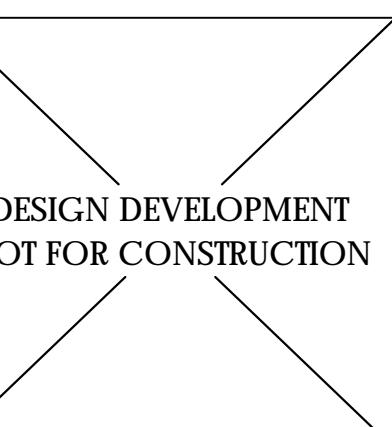

DATE: AUGUST 25, 2017
REVISION & DATE:

DESIGN DEVELOPMENT
FIRST FLOOR PLAN
SHEET NUMBER:

A101

WESTERN BAPTIST BIBLE COLLEGE
BUILDING REHABILITATION
2119 TRACY AVE.
KANSAS CITY, MO 64108

Missouri State Certificate of Authority #2009024884
— 1701 Oak Street, Kansas City, Missouri 64108 — 816.474.0900 — www.stratarch.com

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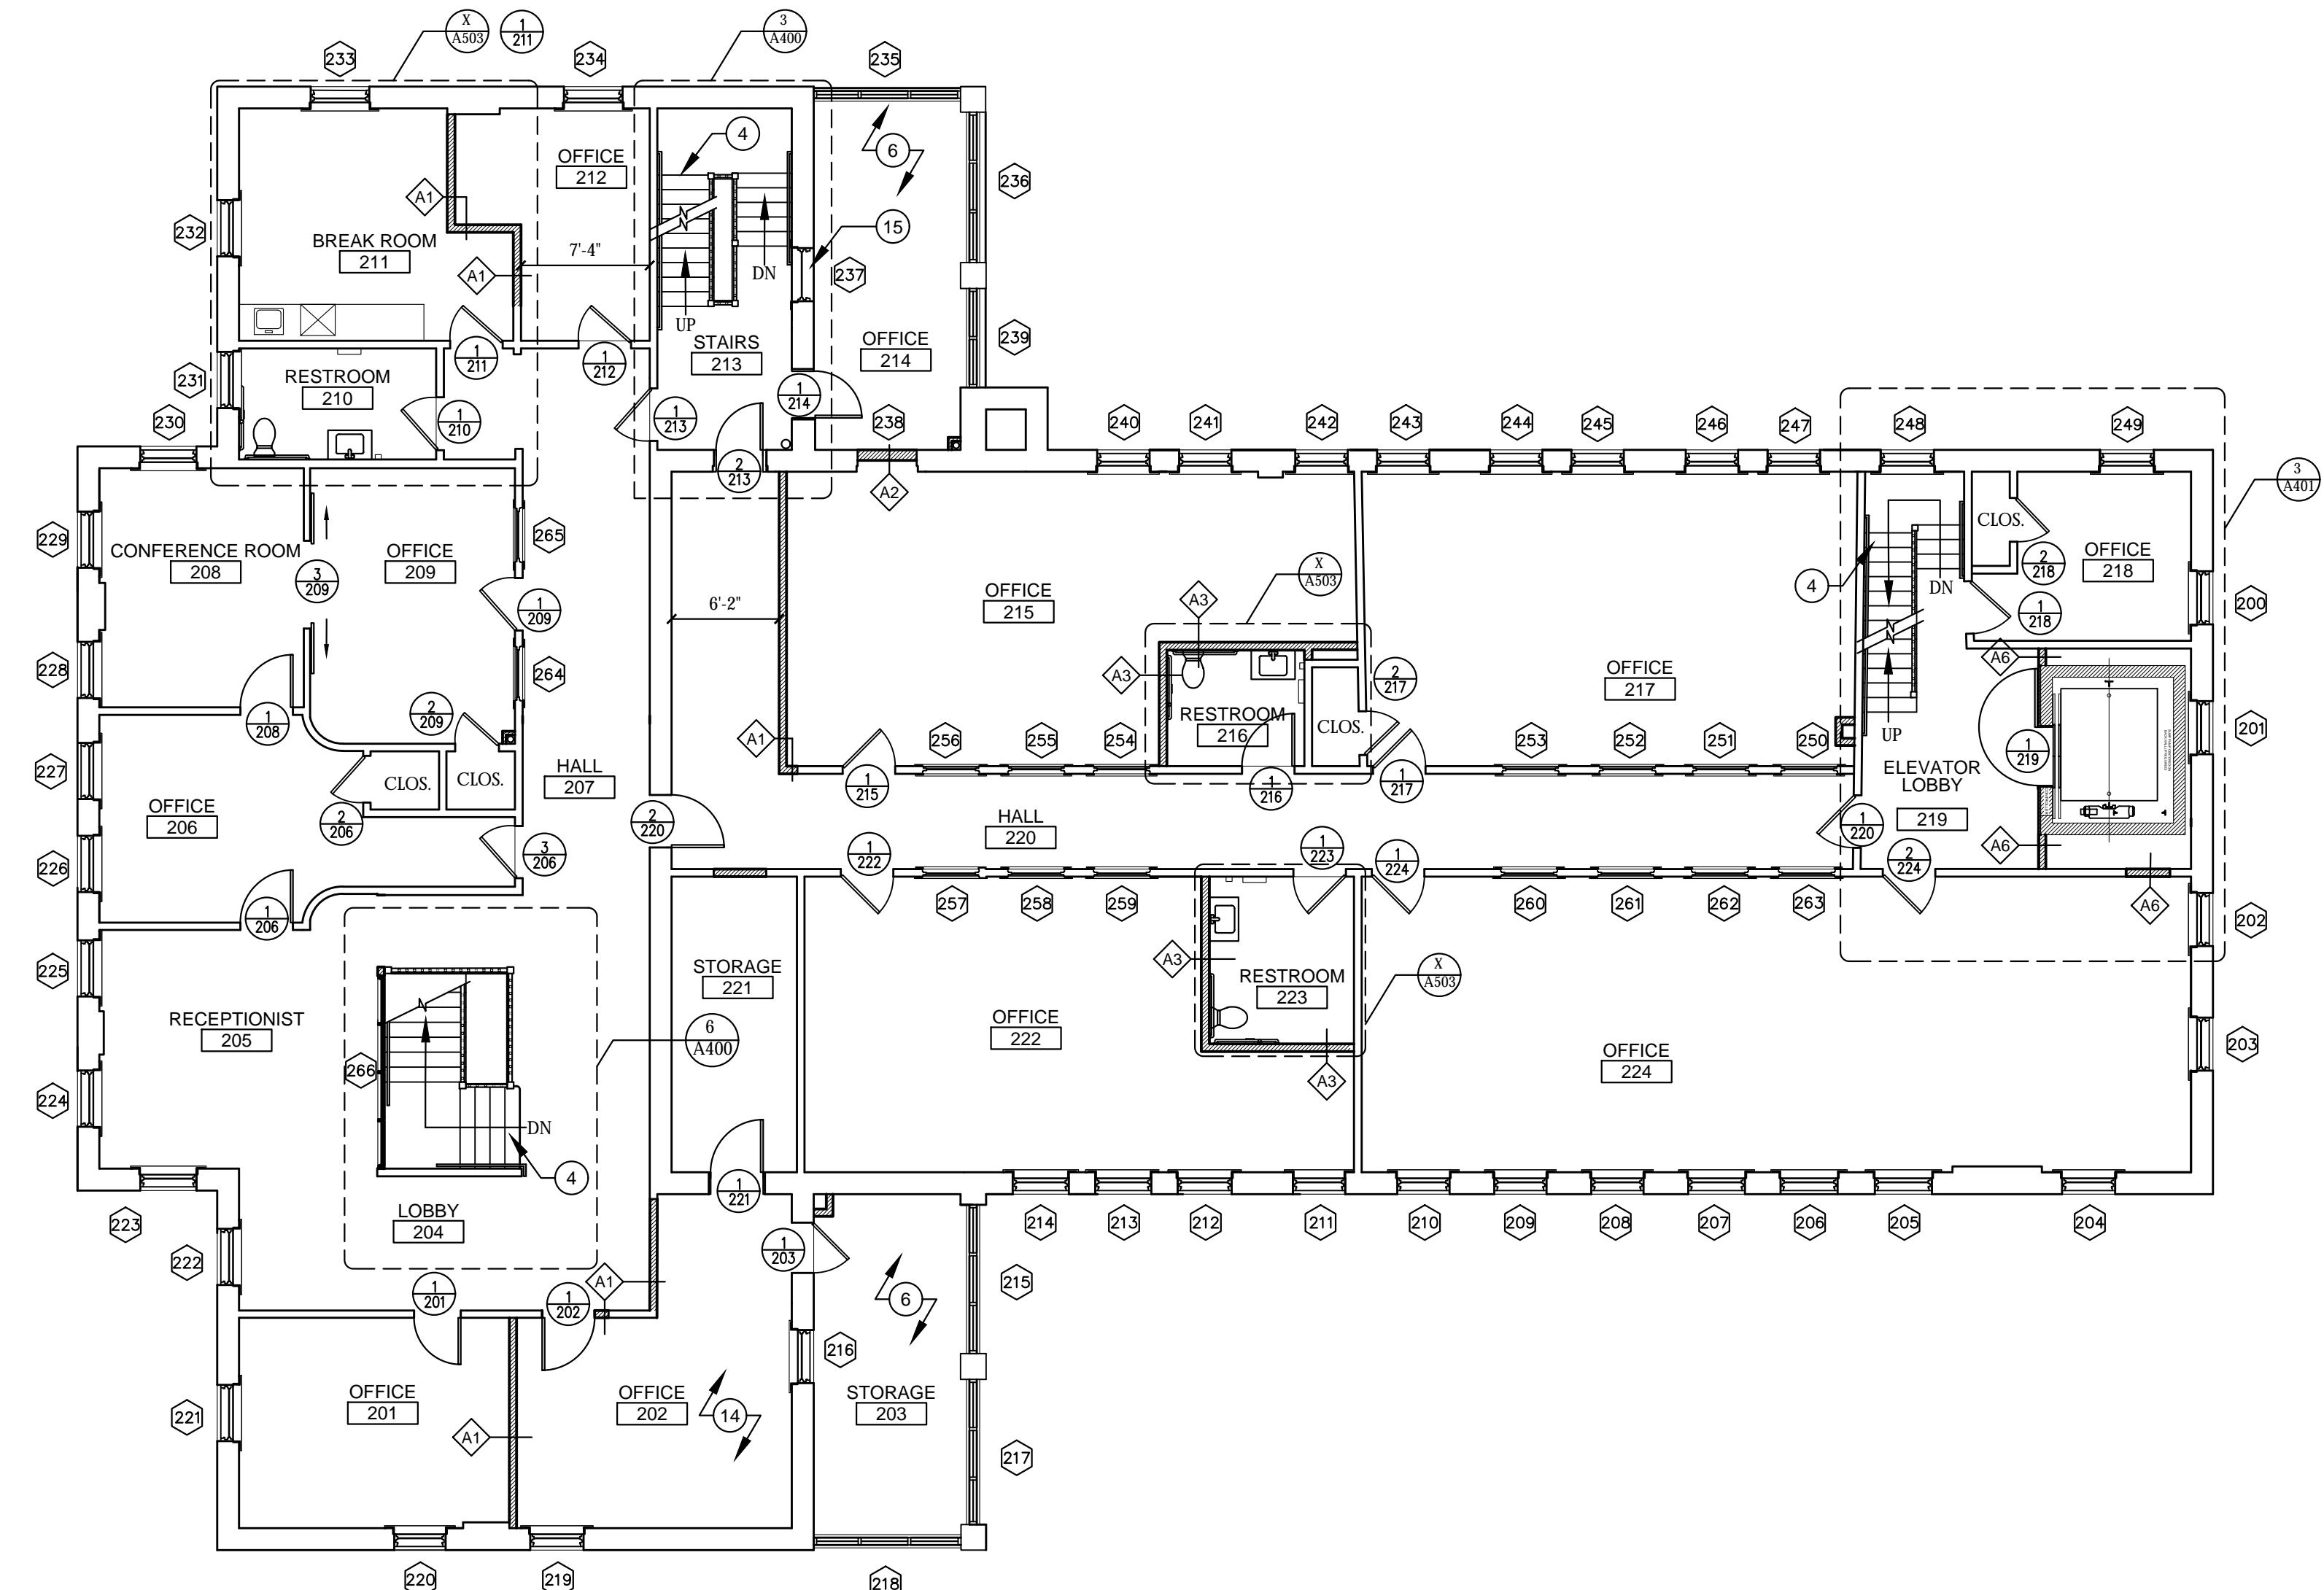
DESIGN DEVELOPMENT
NOT FOR CONSTRUCTION

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DATE: AUGUST 25, 2017
REVISION & DATE:

DESIGN DEVELOPMENT
SECOND FLOOR PLAN
SHEET NUMBER:

A102




1 SECOND FLOOR PLAN

Scale: 1/8" = 1'-0"



8 0 8 16
SCALE OF FEET

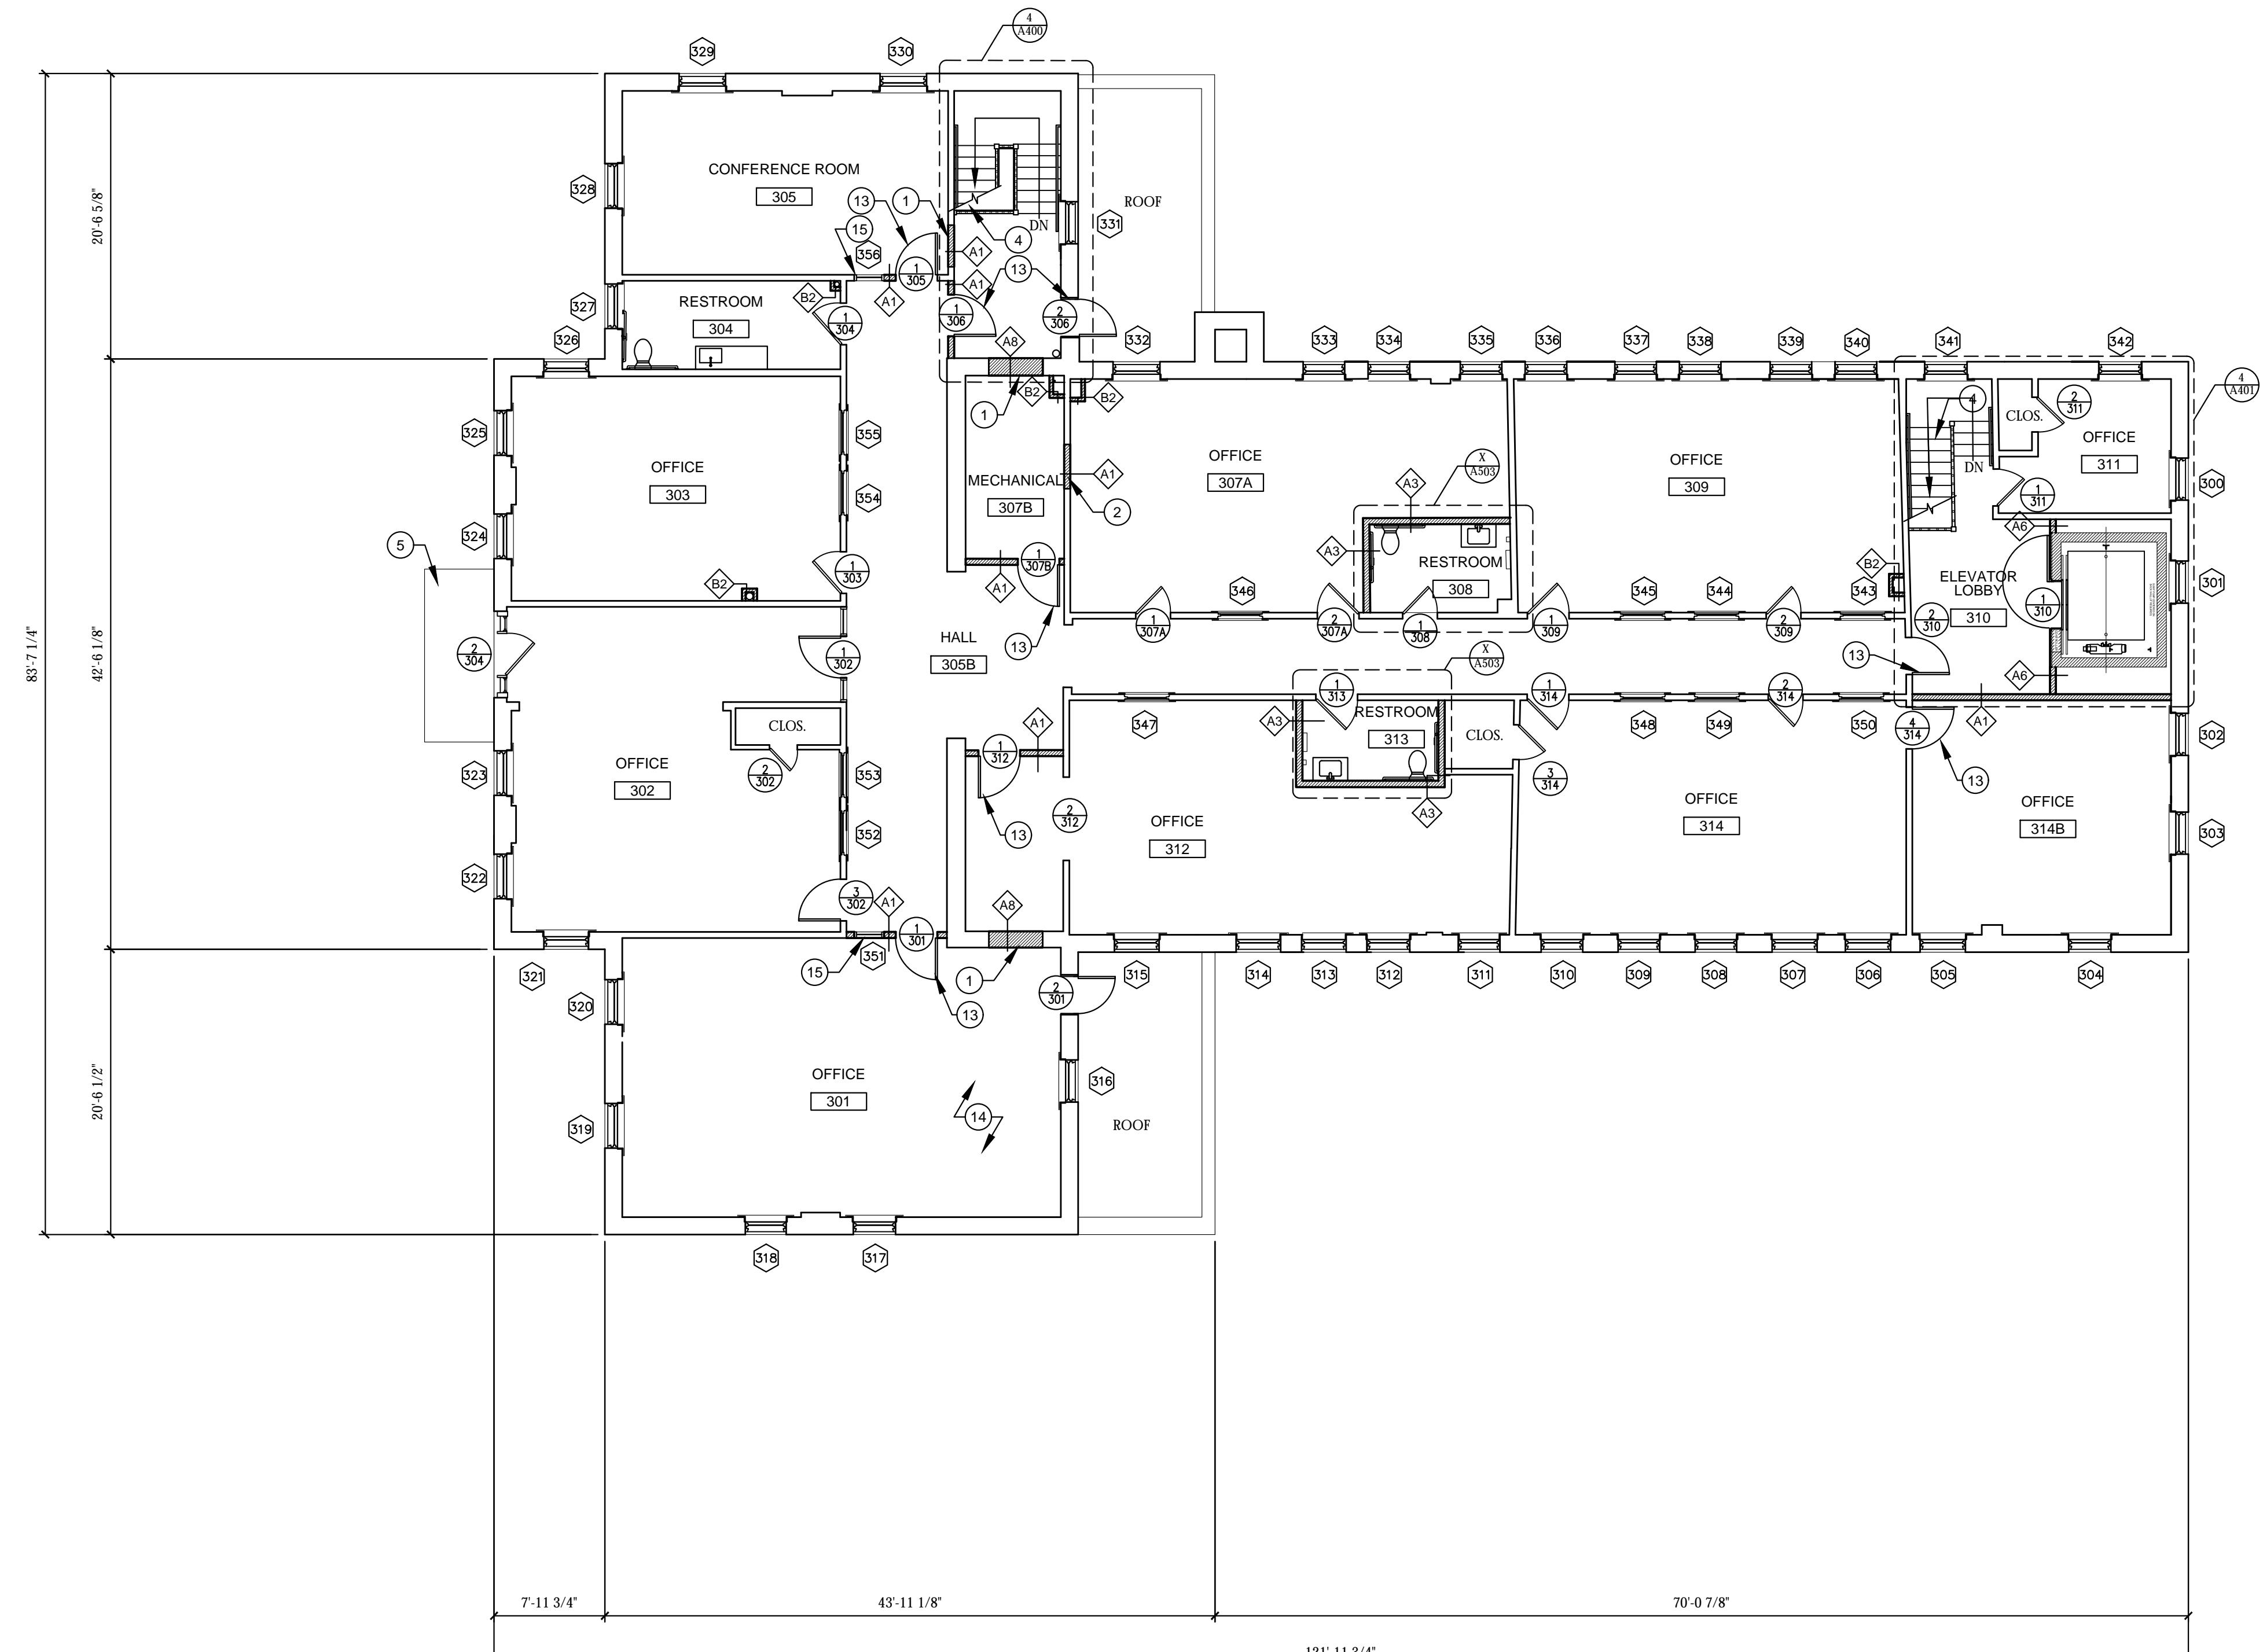

1 THIRD FLOOR PLAN



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DATE: AUGUST 25, 2017
REVISION & DATE:

DESIGN DEVELOPMENT
THIRD FLOOR PLAN
SHEET NUMBER:

A103



WESTERN BAPTIST BIBLE COLLEGE
BUILDING REHABILITATION
2119 TRACY AVE.
KANSAS CITY, MO 64108

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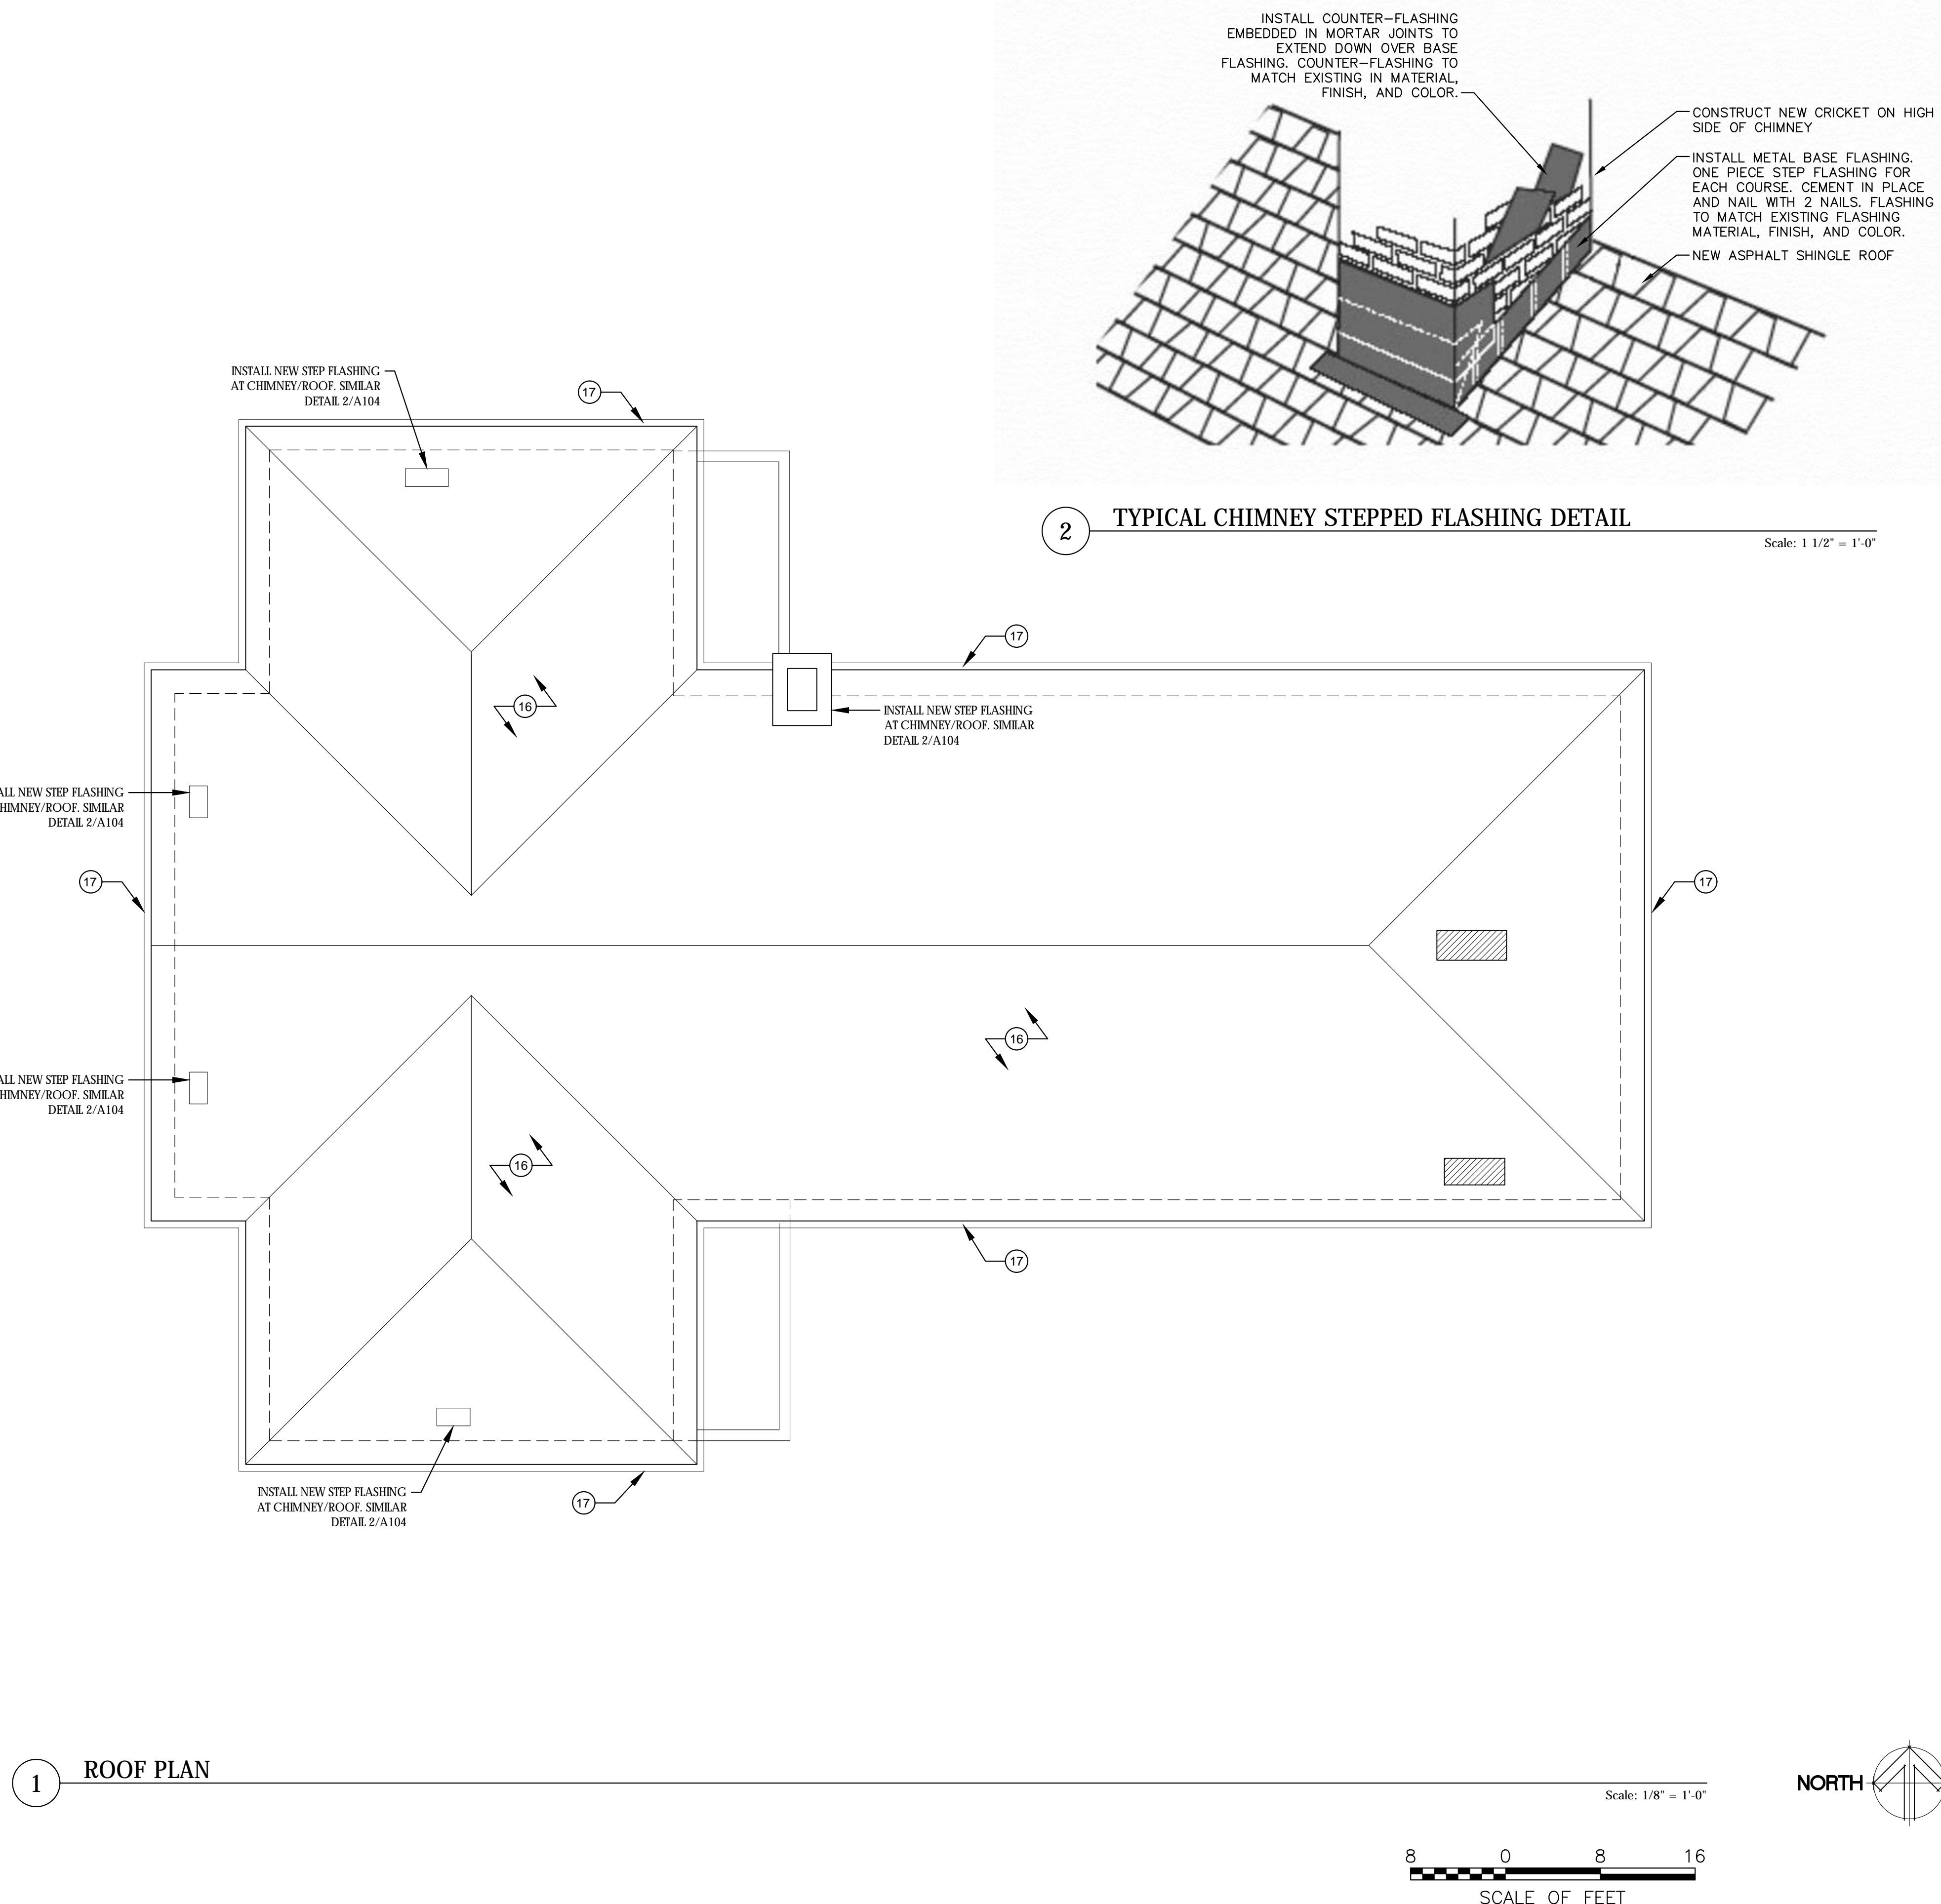
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10. NEW GYPSUM AND WOOD WALL INFILL. EXTERIOR WALL TO BE FRAMED TO REFERENCE HISTORIC PORCH. REFERENCE WALL TYPES AND DETAILS.
11. NEW OPERABLE WALL THAT INCLUDES AN EXIT DOOR WHEN WALL IS FULLY OPEN.
12. THROUGHOUT FIRST FLOOR WEST CORRIDOR INSTALL VENEER PLASTER COATING OVER EXISTING FLOOR FOR SMOOTH FINISH.
13. INSTALL DOOR AND TRIM THAT REPLICATES THE HISTORIC DOOR AND TRIM. REPLICATION SHALL MATCH HISTORIC IN SIZE, PROFILES, AND MATERIAL.
14. FLOOR OPENING FROM THE REMOVAL OF EXISTING STAIR IS TO BE INFILLED. REFERENCE STRUCTURAL DRAWINGS. FINISH FLOOR TO BE WOOD FLOORING THAT MATCHES HISTORIC FLOOR IN SPECIES, WIDTH, AND FINISH. NEW WOOD FLOORING TO BE INSTALLED IN A SEAMLESS MANOR WITH EXISTING HISTORIC WOOD FLOOR.
15. INSTALL WINDOW TRIM THAT REPLICATES THE HISTORIC WINDOW TRIM. REPLICATION SHALL MATCH HISTORIC IN SIZE, PROFILES, AND MATERIAL.
16. INSTALL NEW ARCHITECTURAL 50 YEAR ASPHALT SHINGLES. REMOVE EXISTING DETERIORATED SHEATHING AND REPLACE WITH EXTERIOR RATED OSB SHEATHING TO MATCH THE EXISTING SHEATHING THICKNESS. REPLACE FULL SECTIONS BETWEEN RAFTERS TO ENSURE STRUCTURAL UNIFORMITY. INSTALL SELF-ADHERING WATER AND ICE BARRIER FROM EDGE OF ROOF TO WITHIN 36-INCHES OF INTERIOR FACE OF EXTERIOR WALL. ASSUMING 40% REQUIRED SHEATHING REPLACEMENT.
17. INSTALL 7-K-STYLE GUTTERS AND DOWNSPOUTS. PROVIDE ALL REQUIRED GUTTER HANGERS, END CAPS, DOWNSPOUT. PROVIDE ALL REQUIRED GUTTER HANGERS, END CAPS, DOWNSPOUT ELBOWS AND ANY OTHER REQUIRED ACCESSORIES FOR COMPLETE INSTALLATION. SLOPE GUTTERS TO DRAIN PROPERLY.

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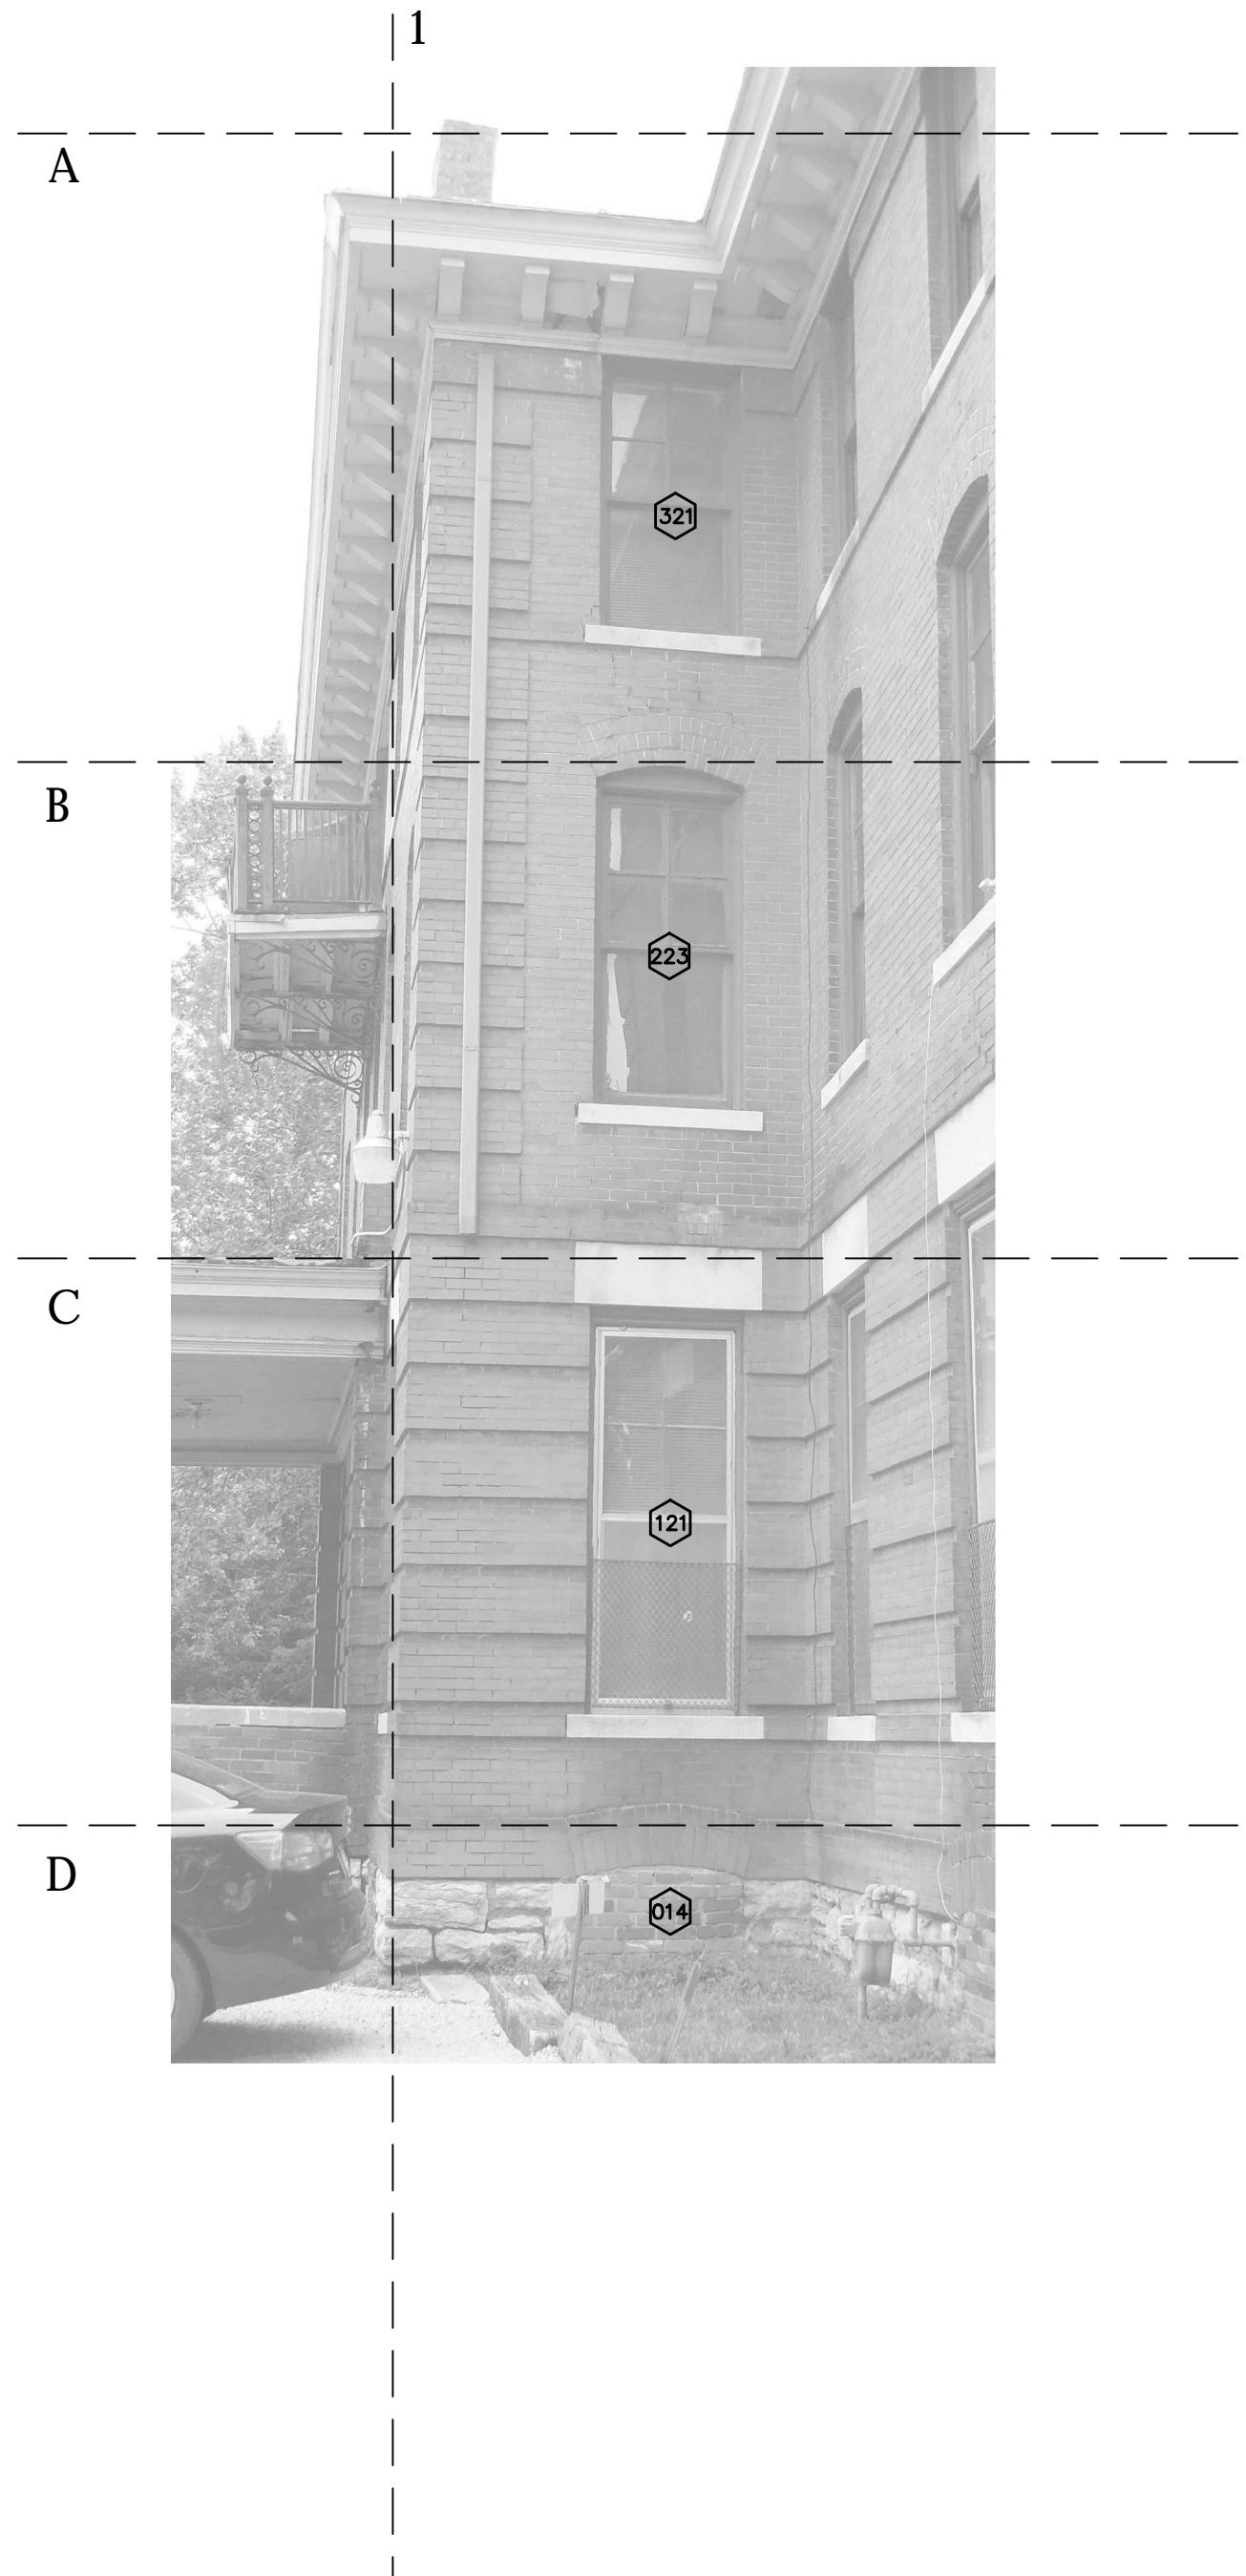
DATE: AUGUST 25, 2017
REVISION & DATE:

DESIGN DEVELOPMENT
ROOF PLAN
SHEET NUMBER:


A104



WESTERN BAPTIST BIBLE COLLEGE
BUILDING REHABILITATION
2119 TRACY AVE.
KANSAS CITY, MO 64108



1 SOUTH ELEVATION

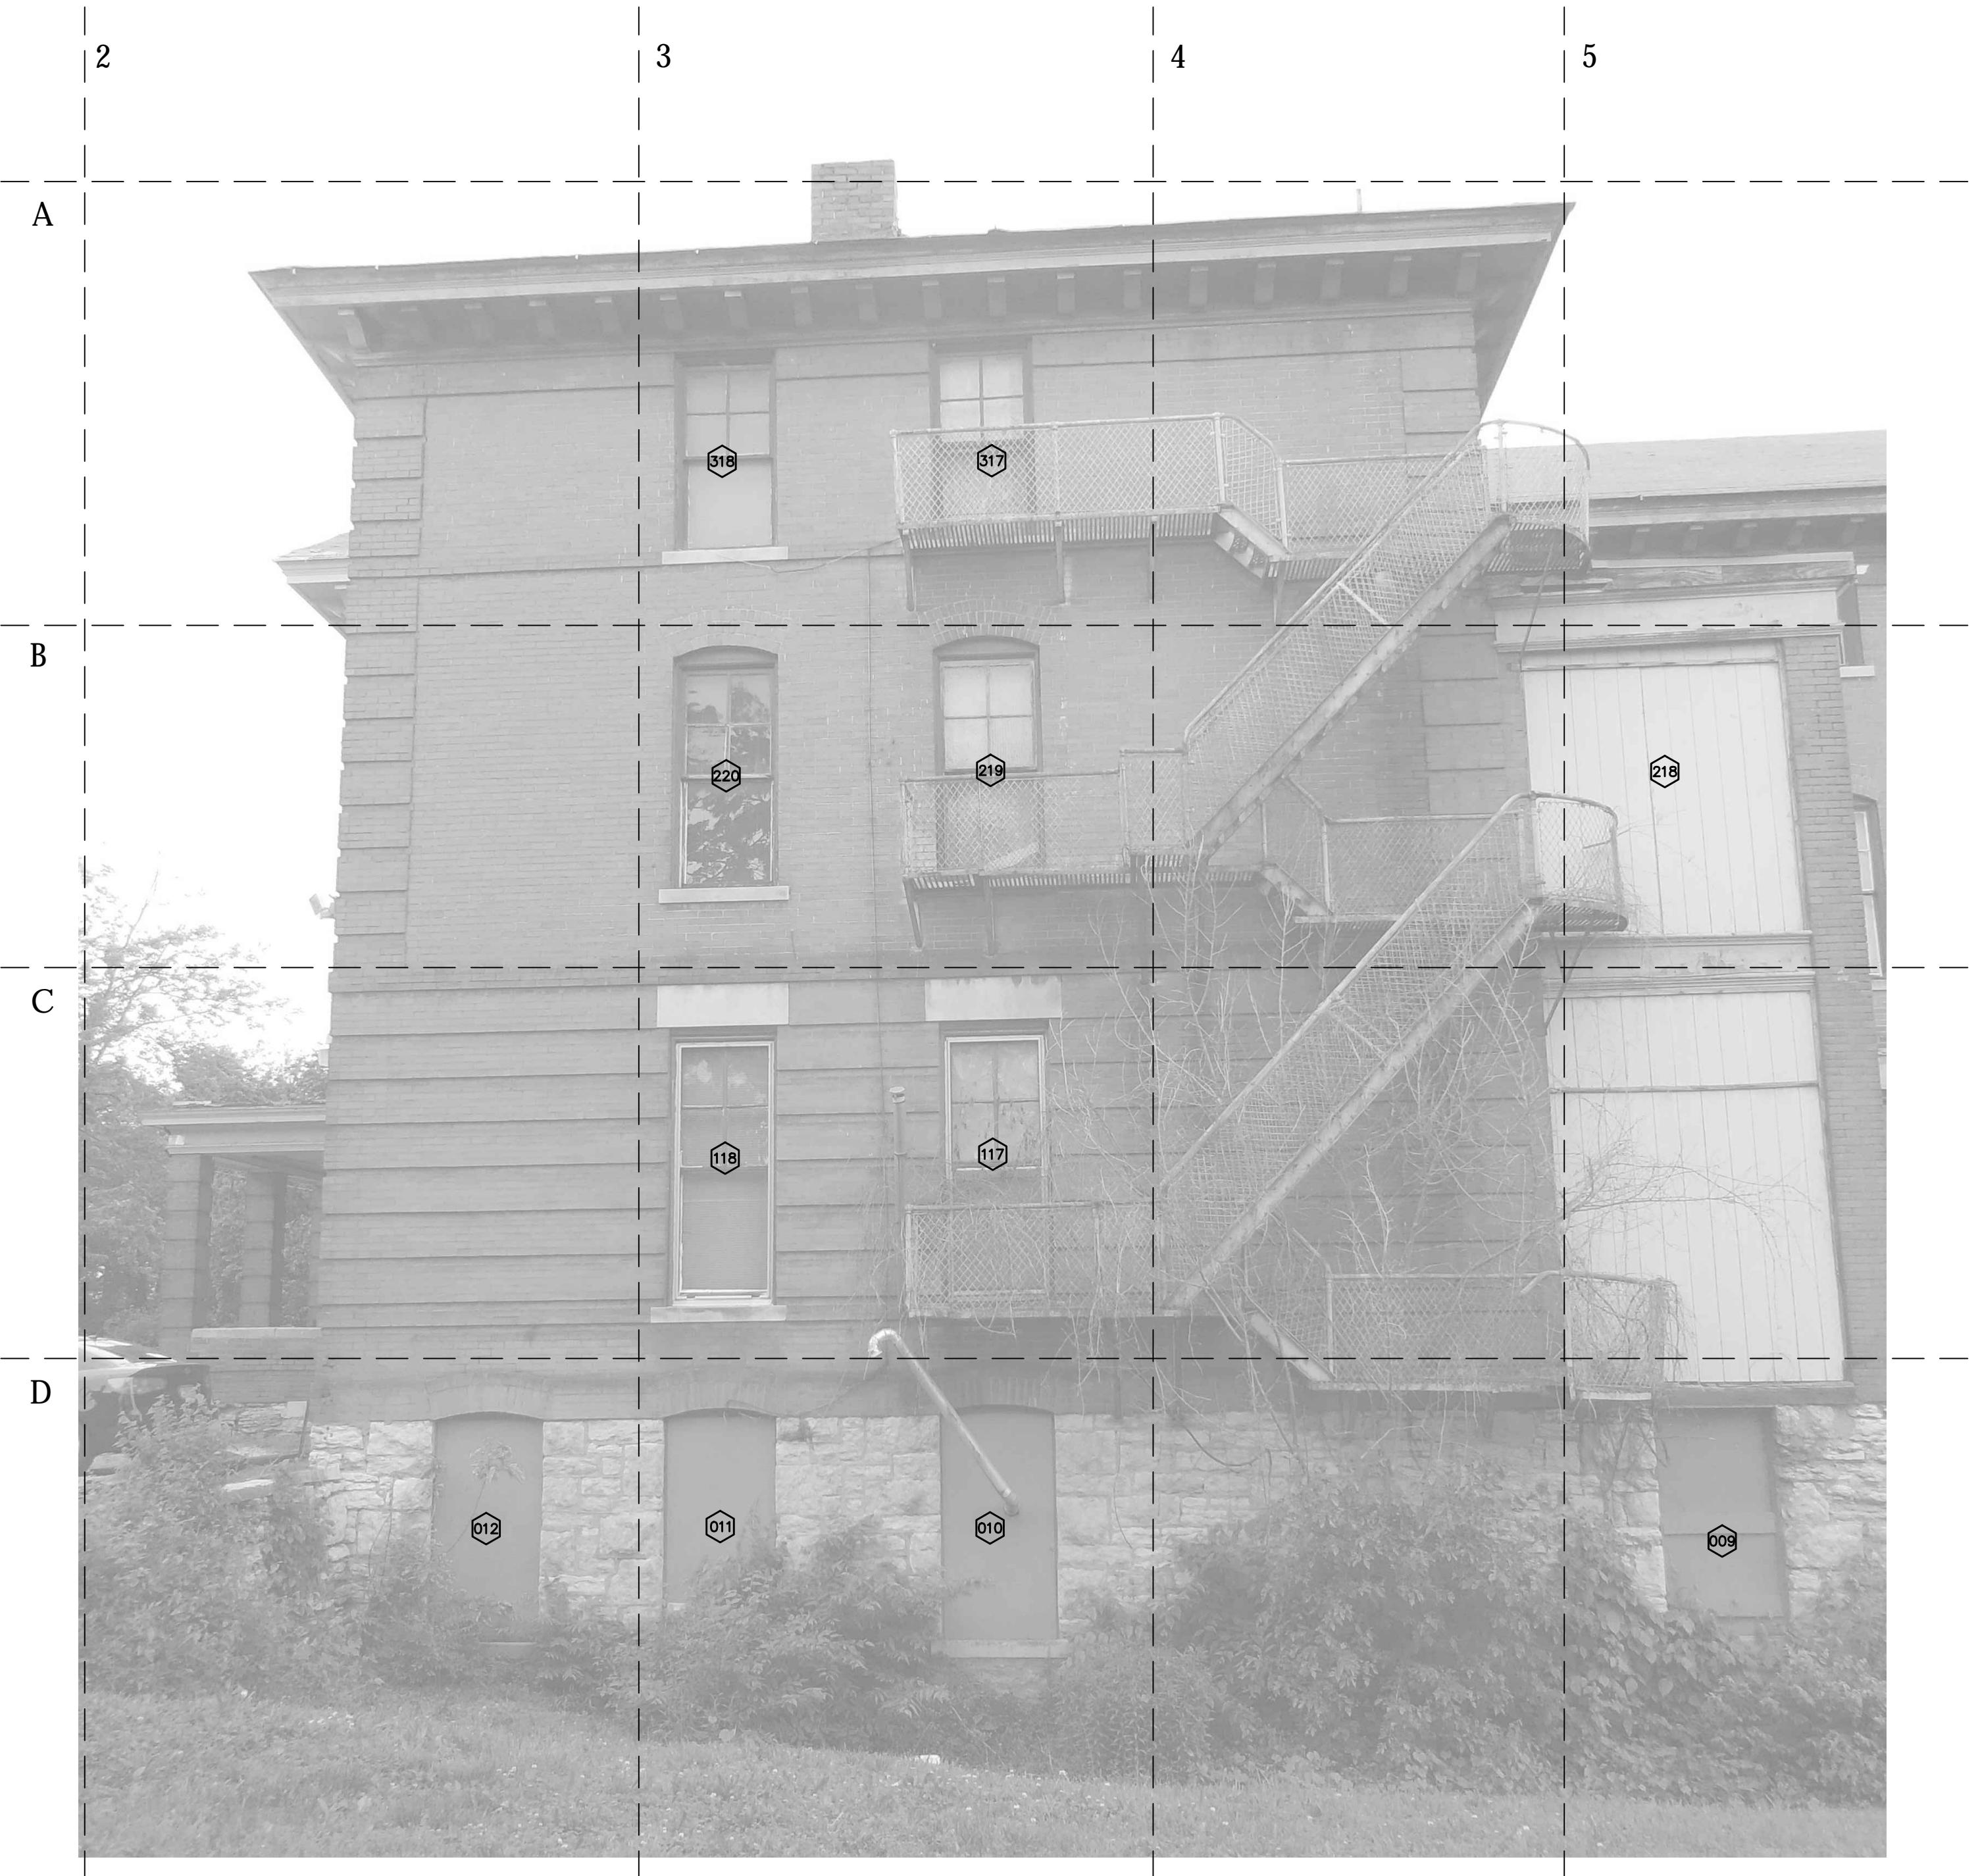

Scale: NA

GENERAL EXTERIOR NOTES:

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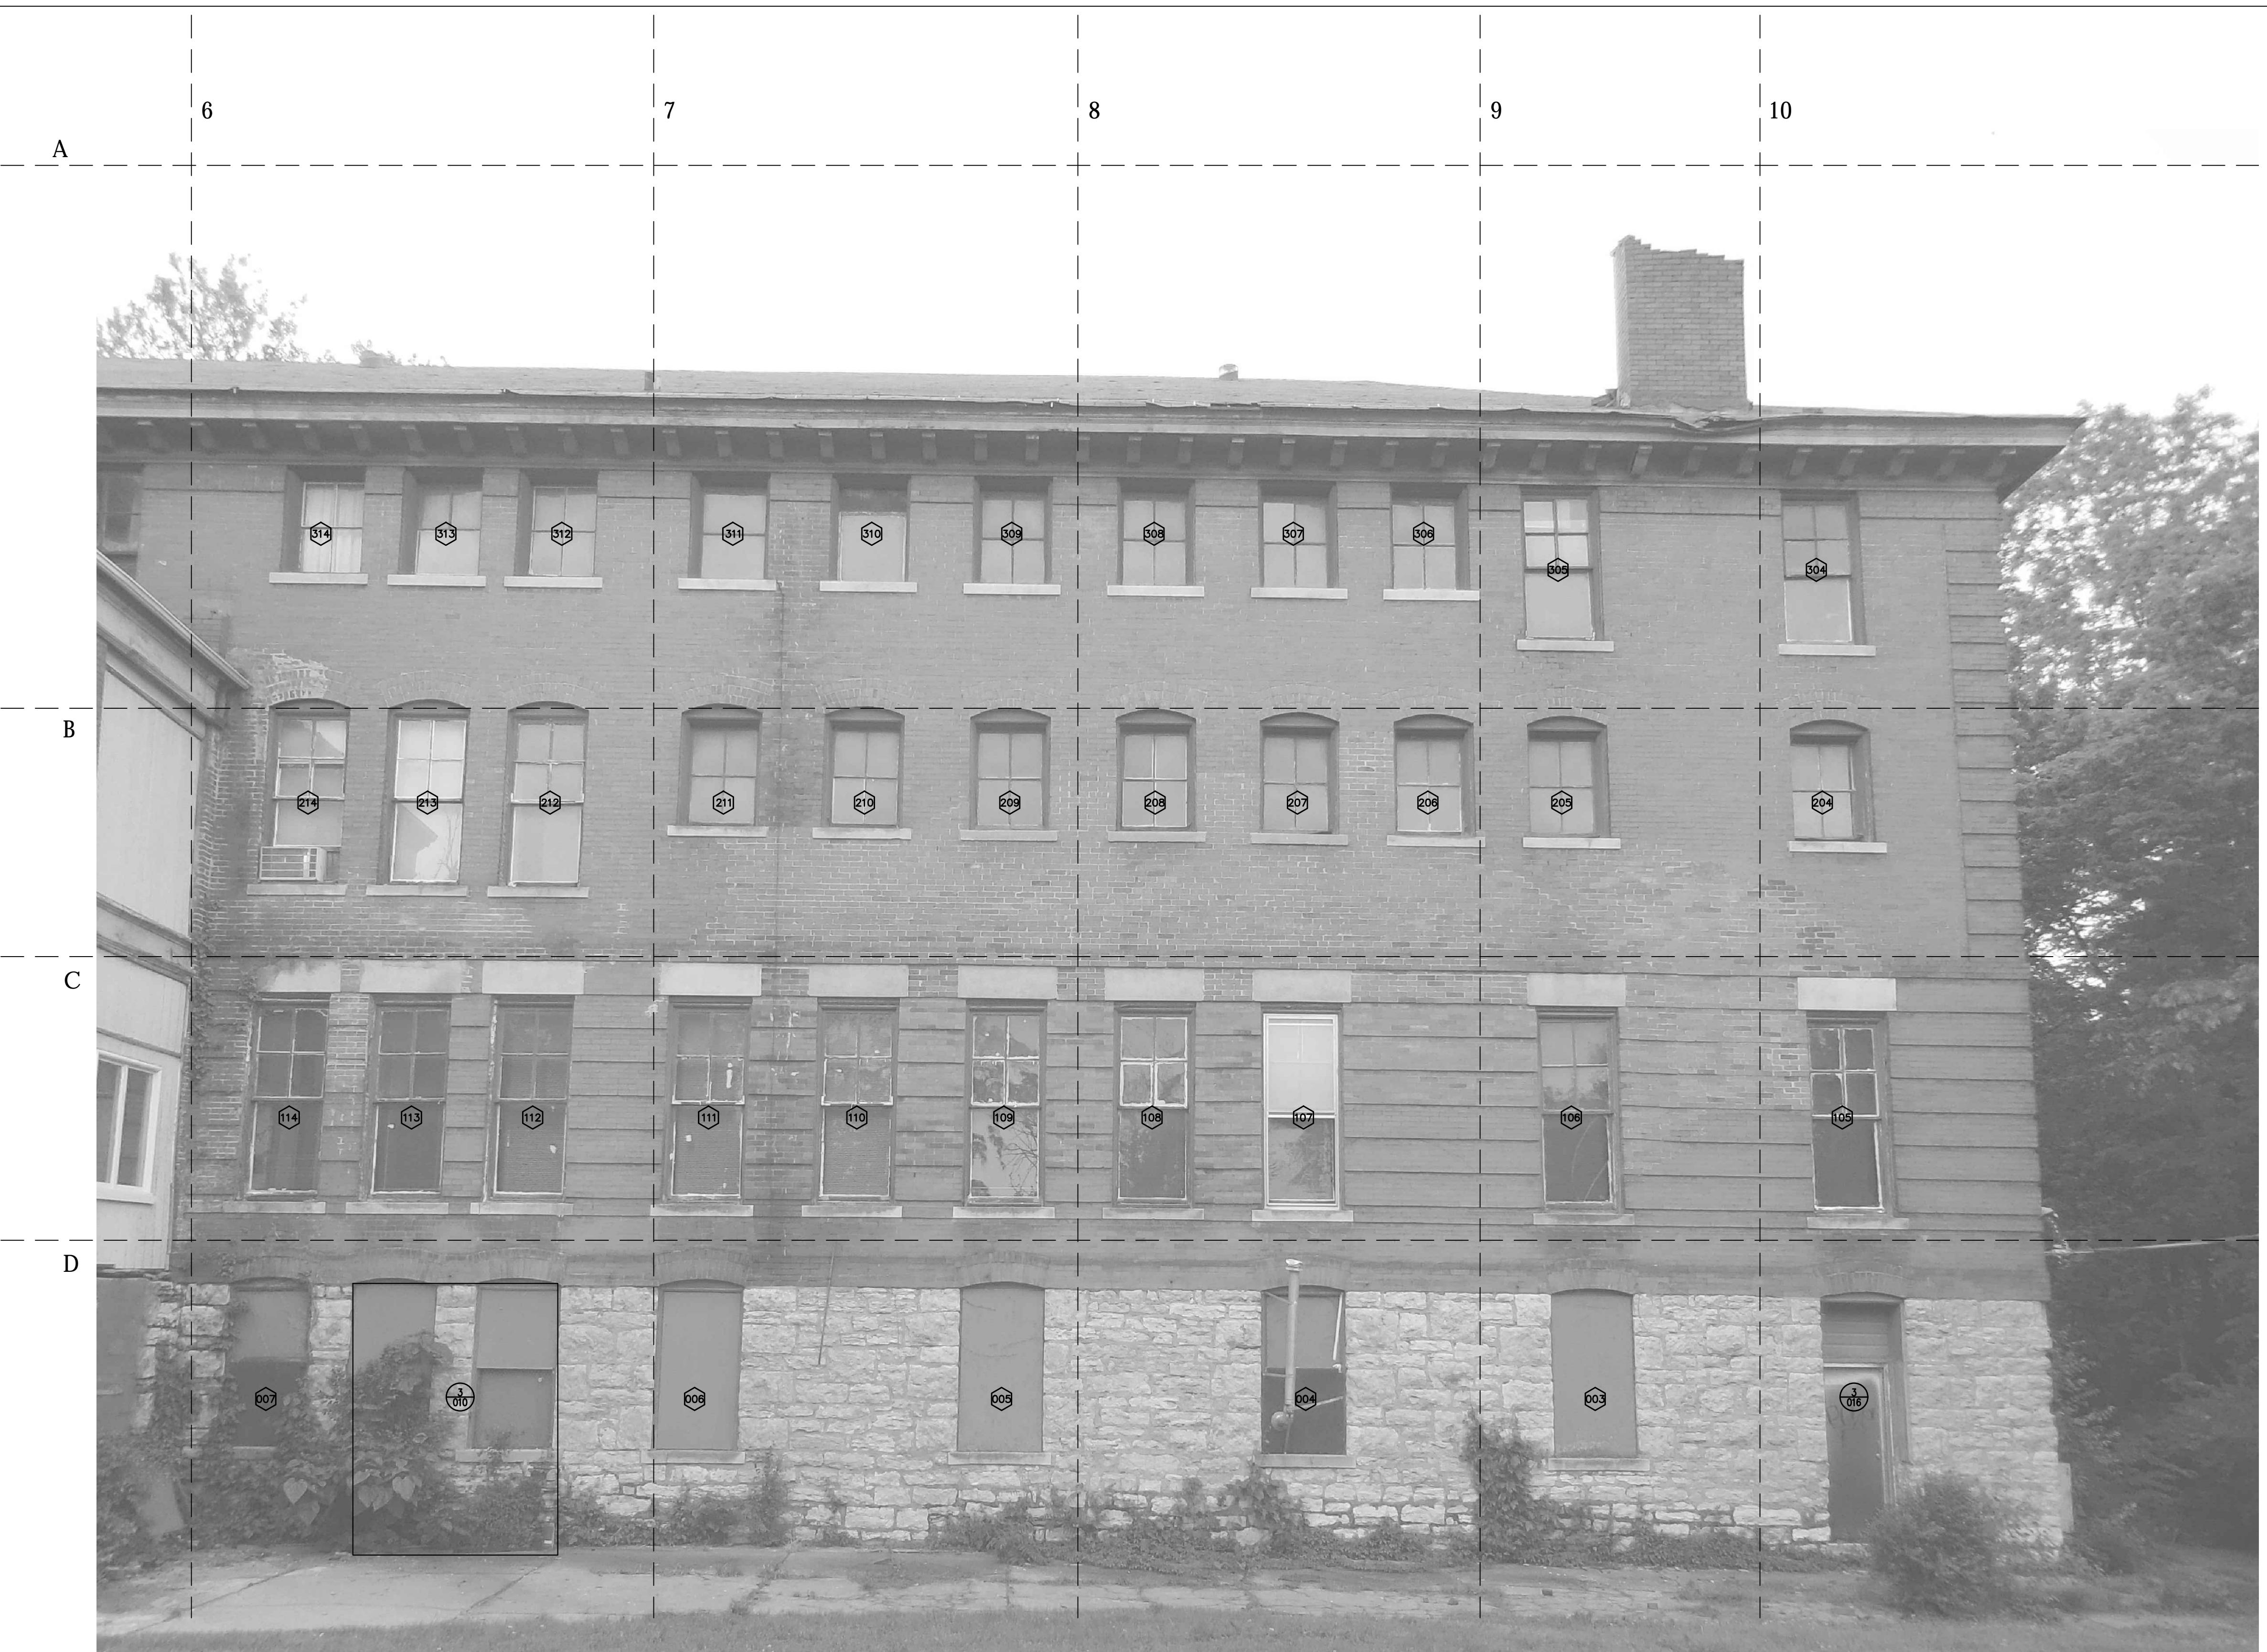
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REVISION & DATE:

DESIGN DEVELOPMENT
SOUTH ELEVATION
SHEET NUMBER:

A200



1 SOUTH ELEVATION

Scale: NA

GENERAL EXTERIOR NOTES:

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SOUTH ELEVATION
SHEET NUMBER:

A201

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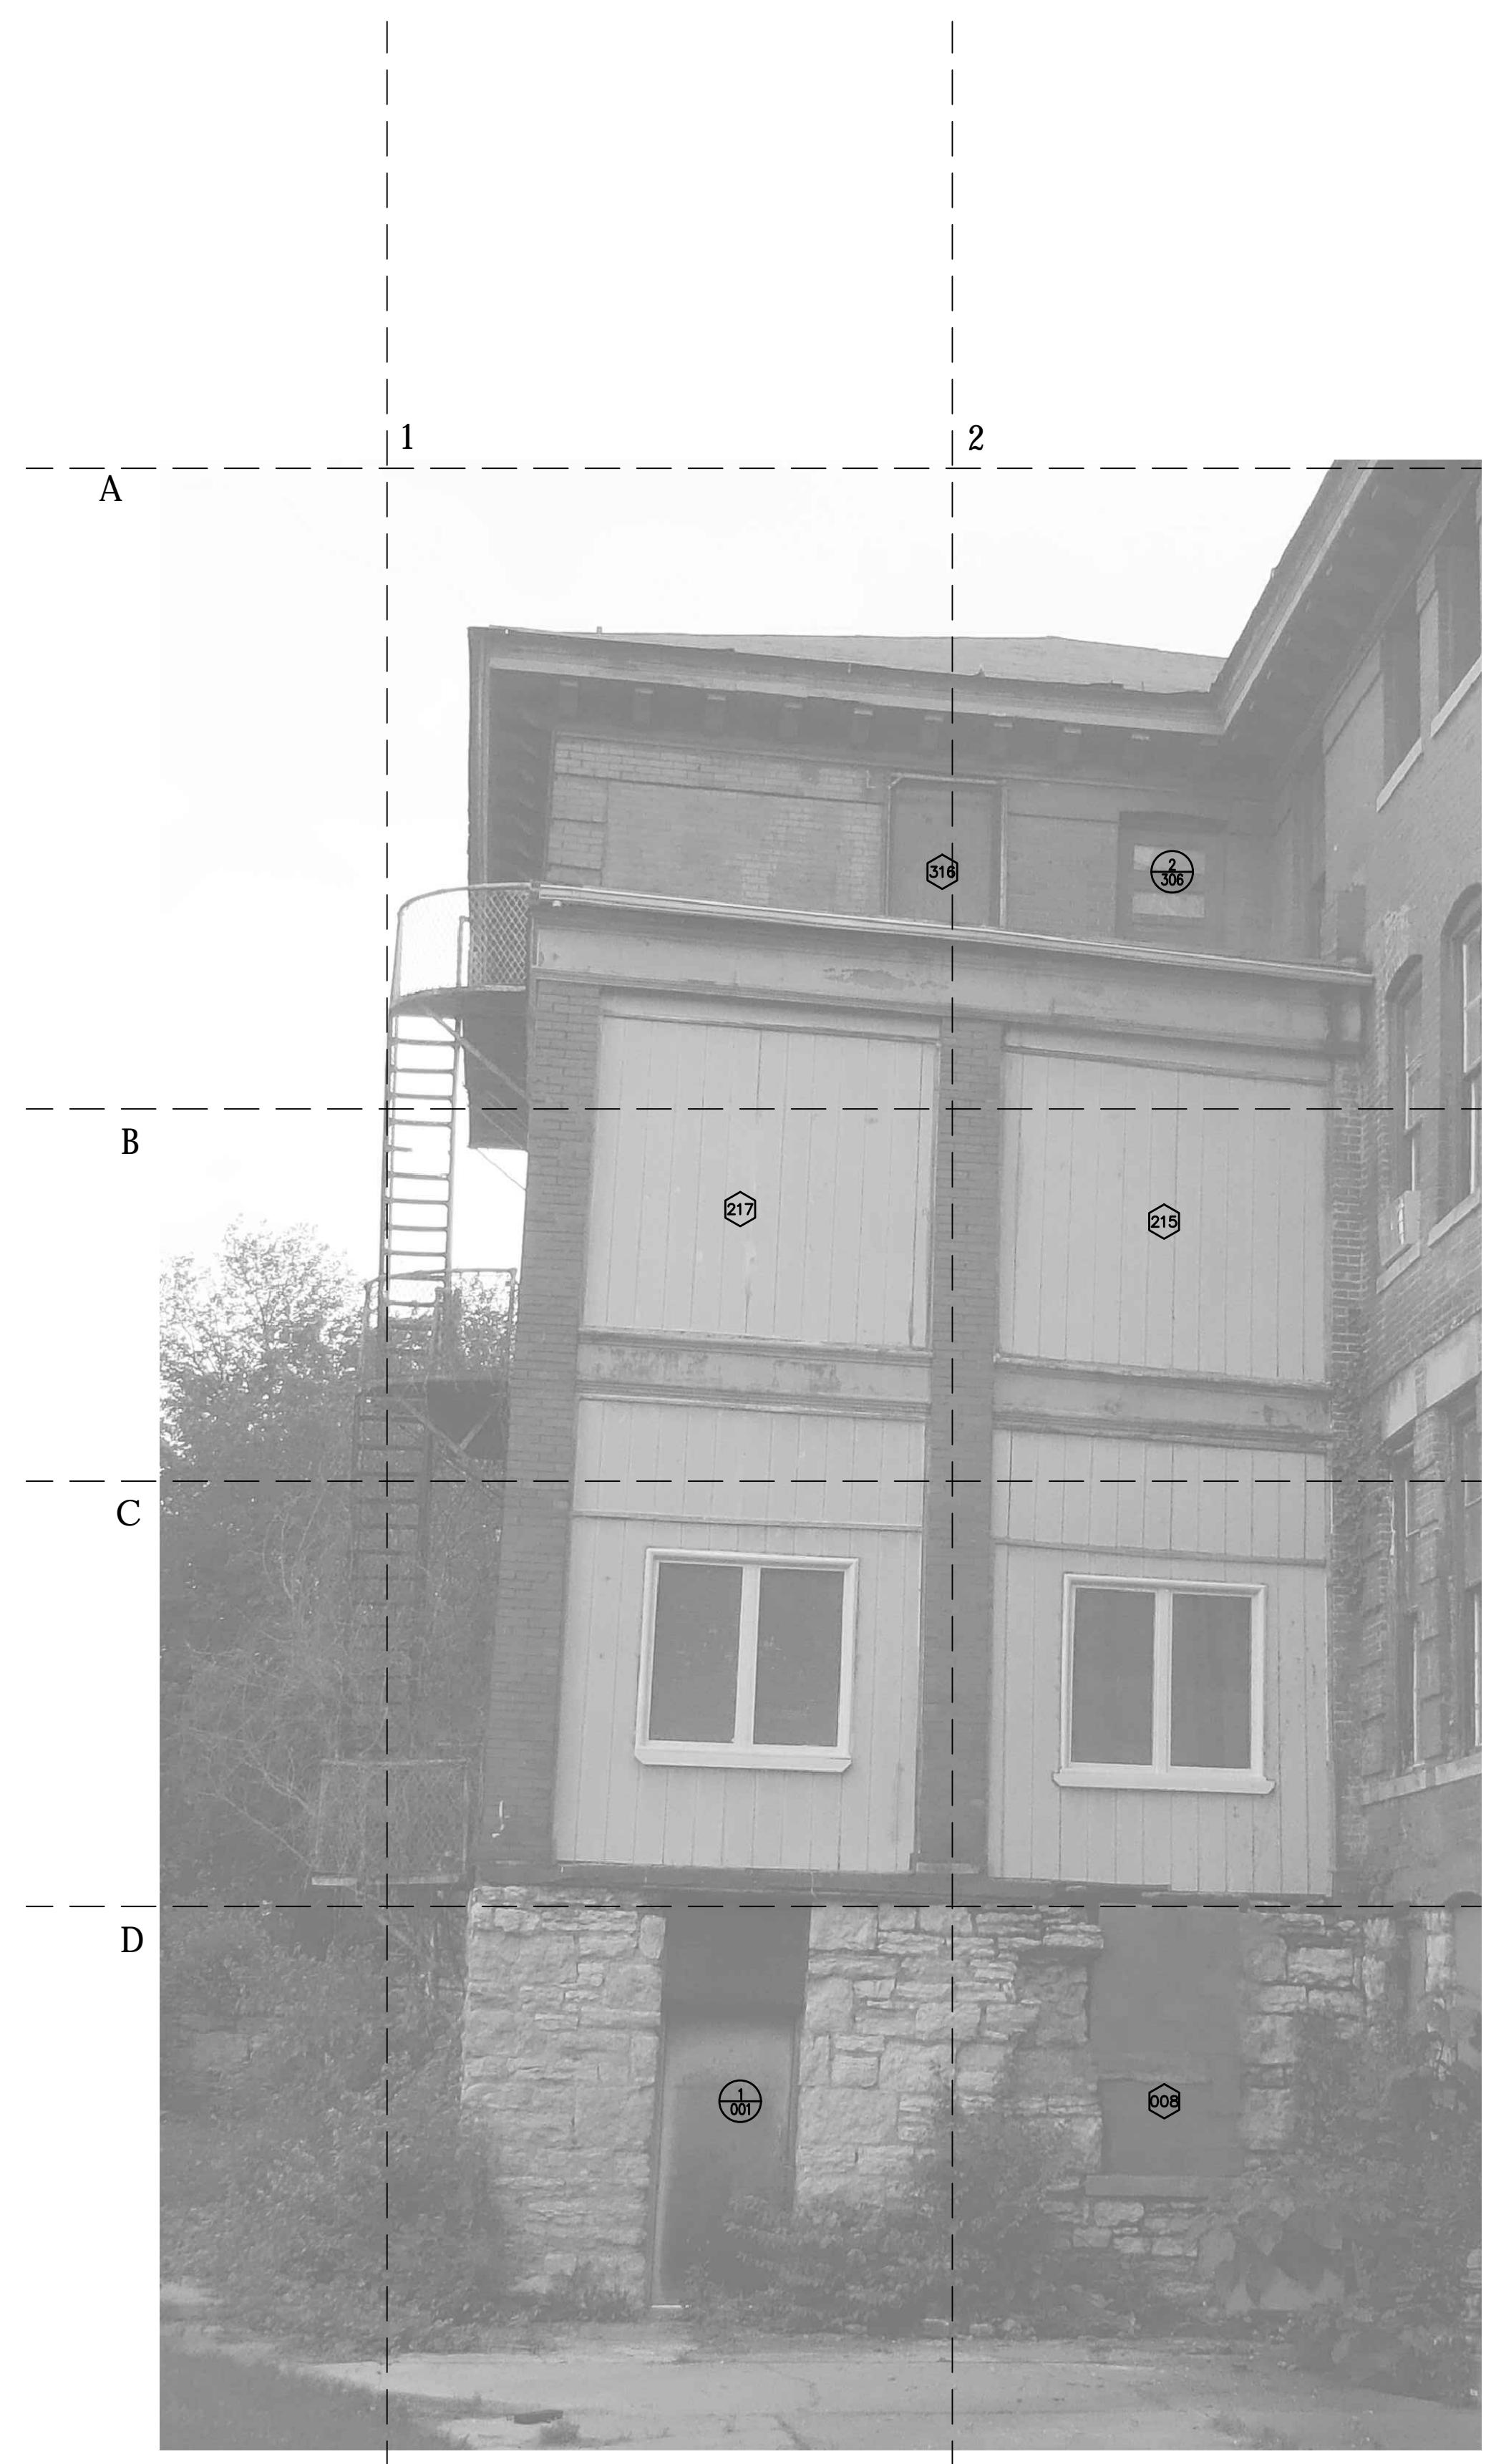
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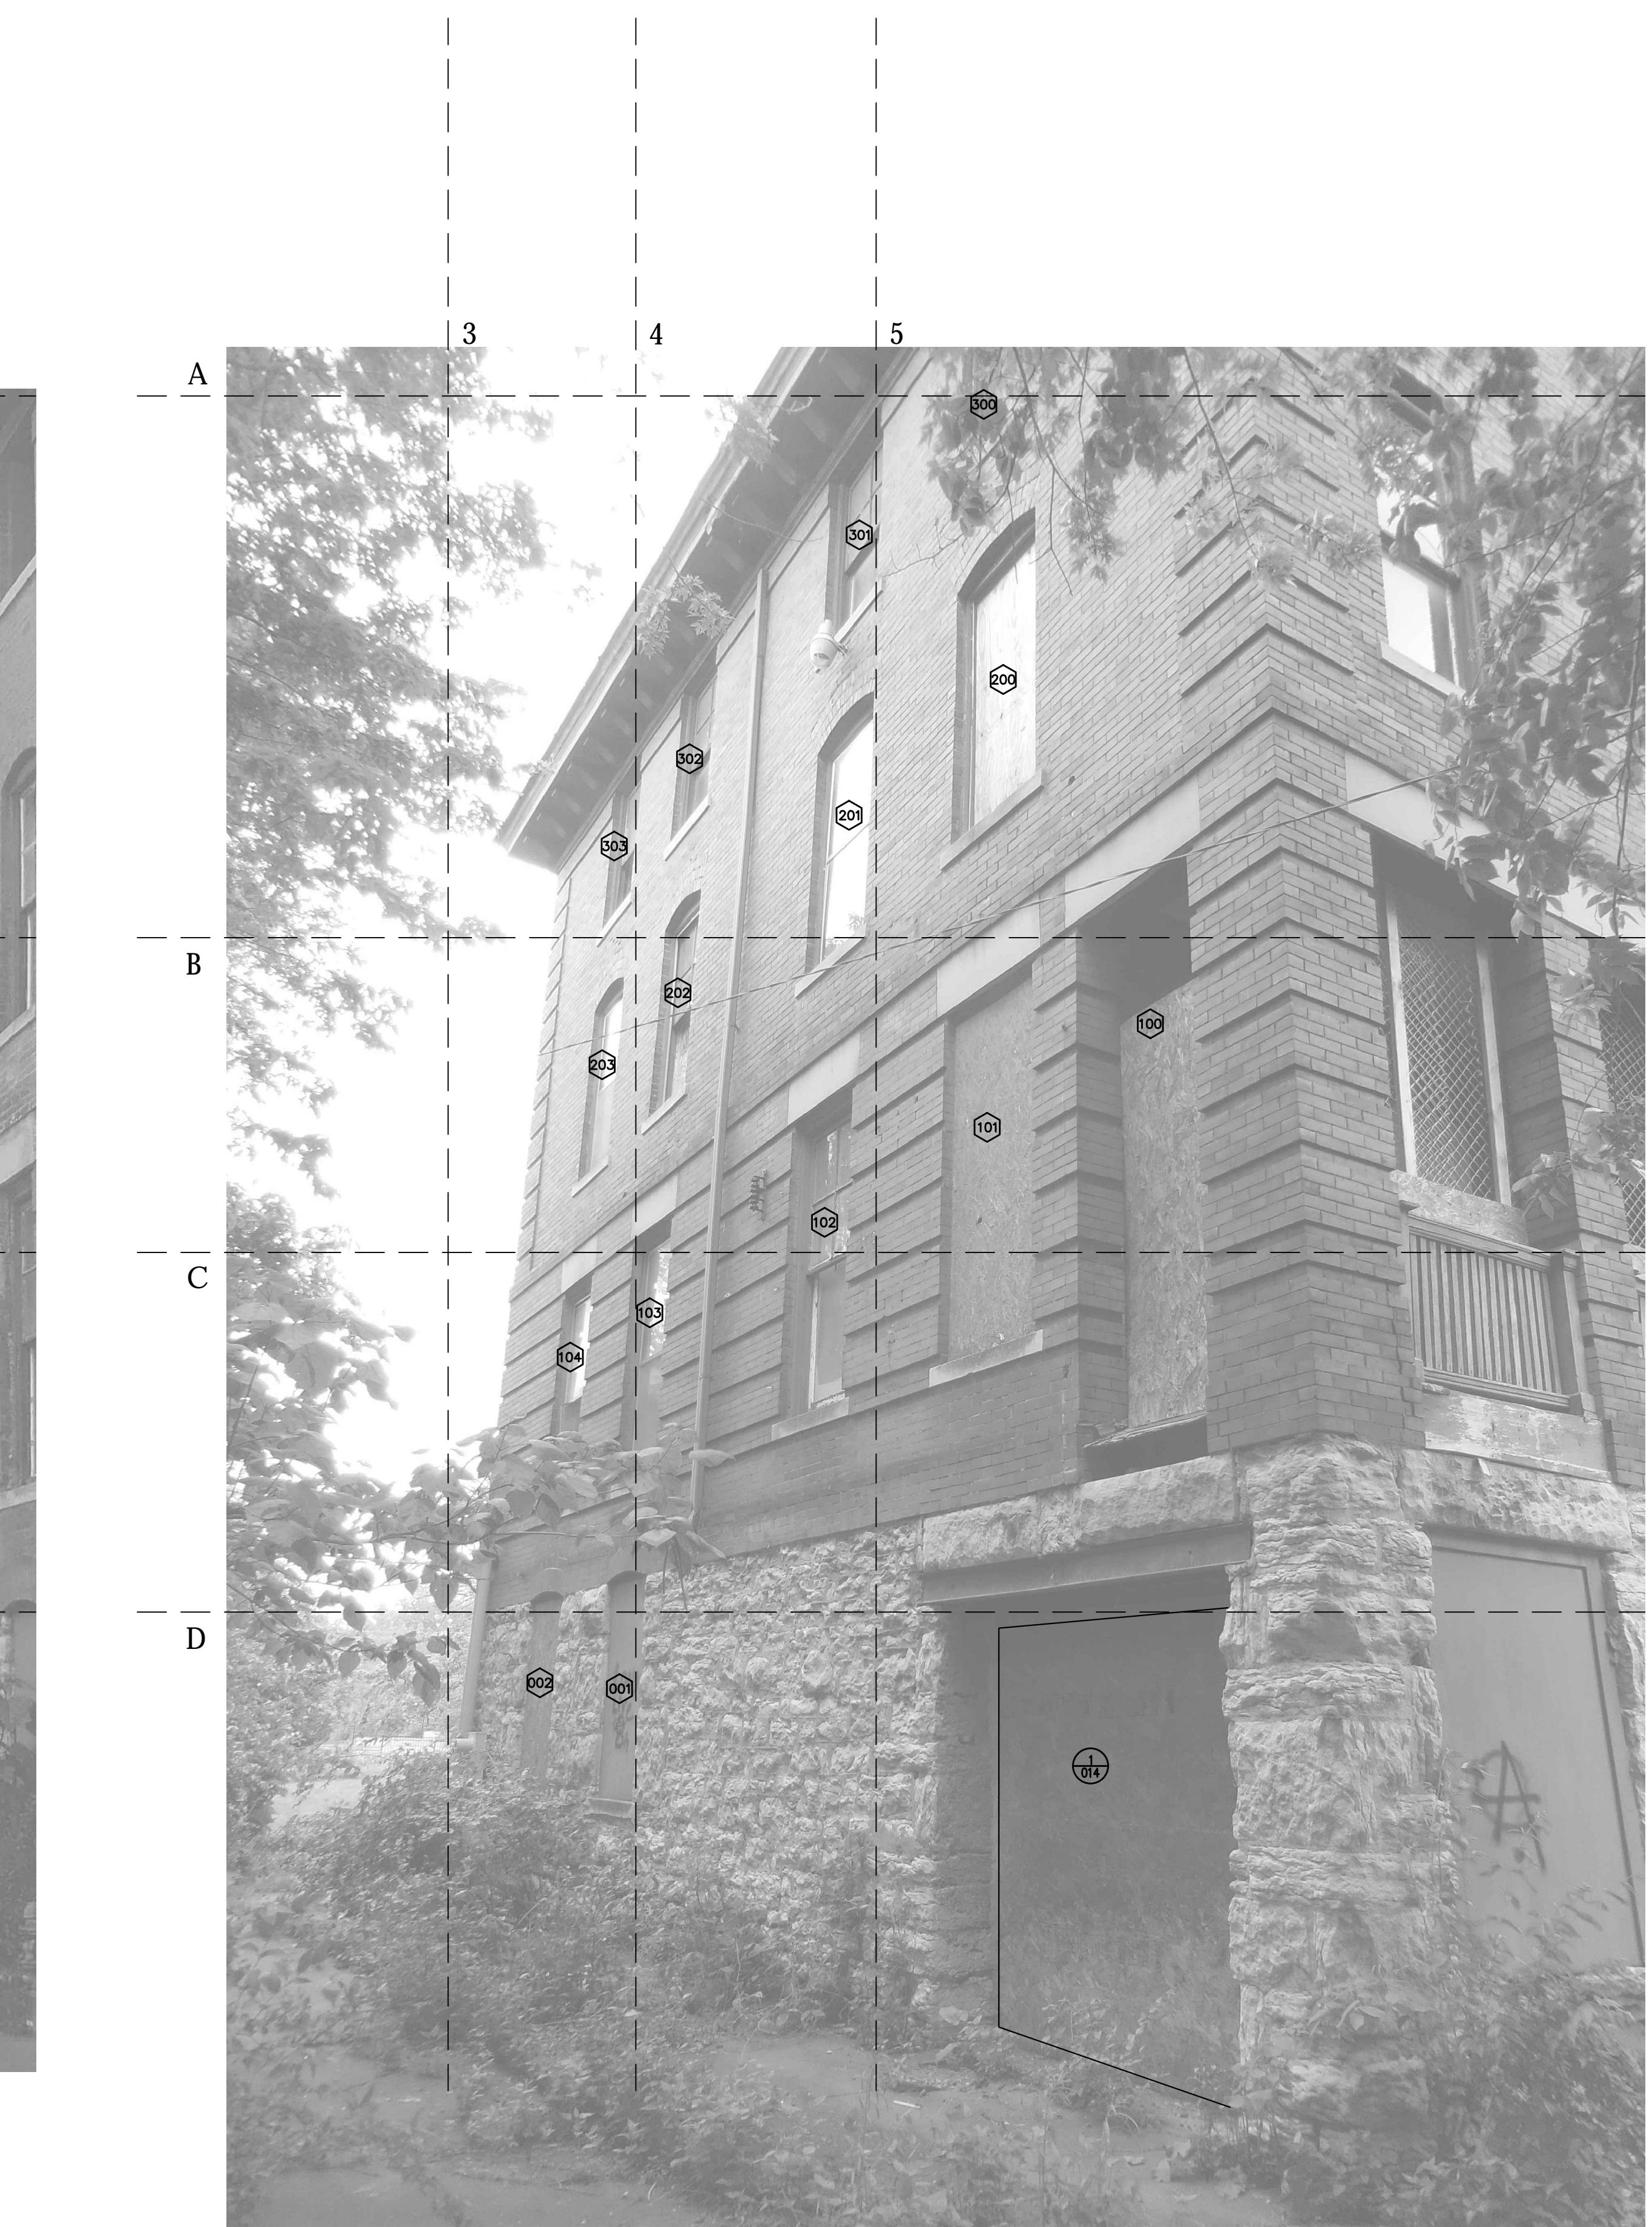
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REVISION & DATE:

DESIGN DEVELOPMENT
EAST ELEVATION
SHEET NUMBER:

A202



1 EAST ELEVATION



1 EAST ELEVATION

Scale: NA

GENERAL EXTERIOR NOTES:

- REFERENCE SHEETS A212 - A215 FOR EAST ELEVATION ENLARGED DETAILS AND SCOPE OF WORK.
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1 NORTH ELEVATION - EAST SECTION

Scale: NA

GENERAL EXTERIOR NOTES:

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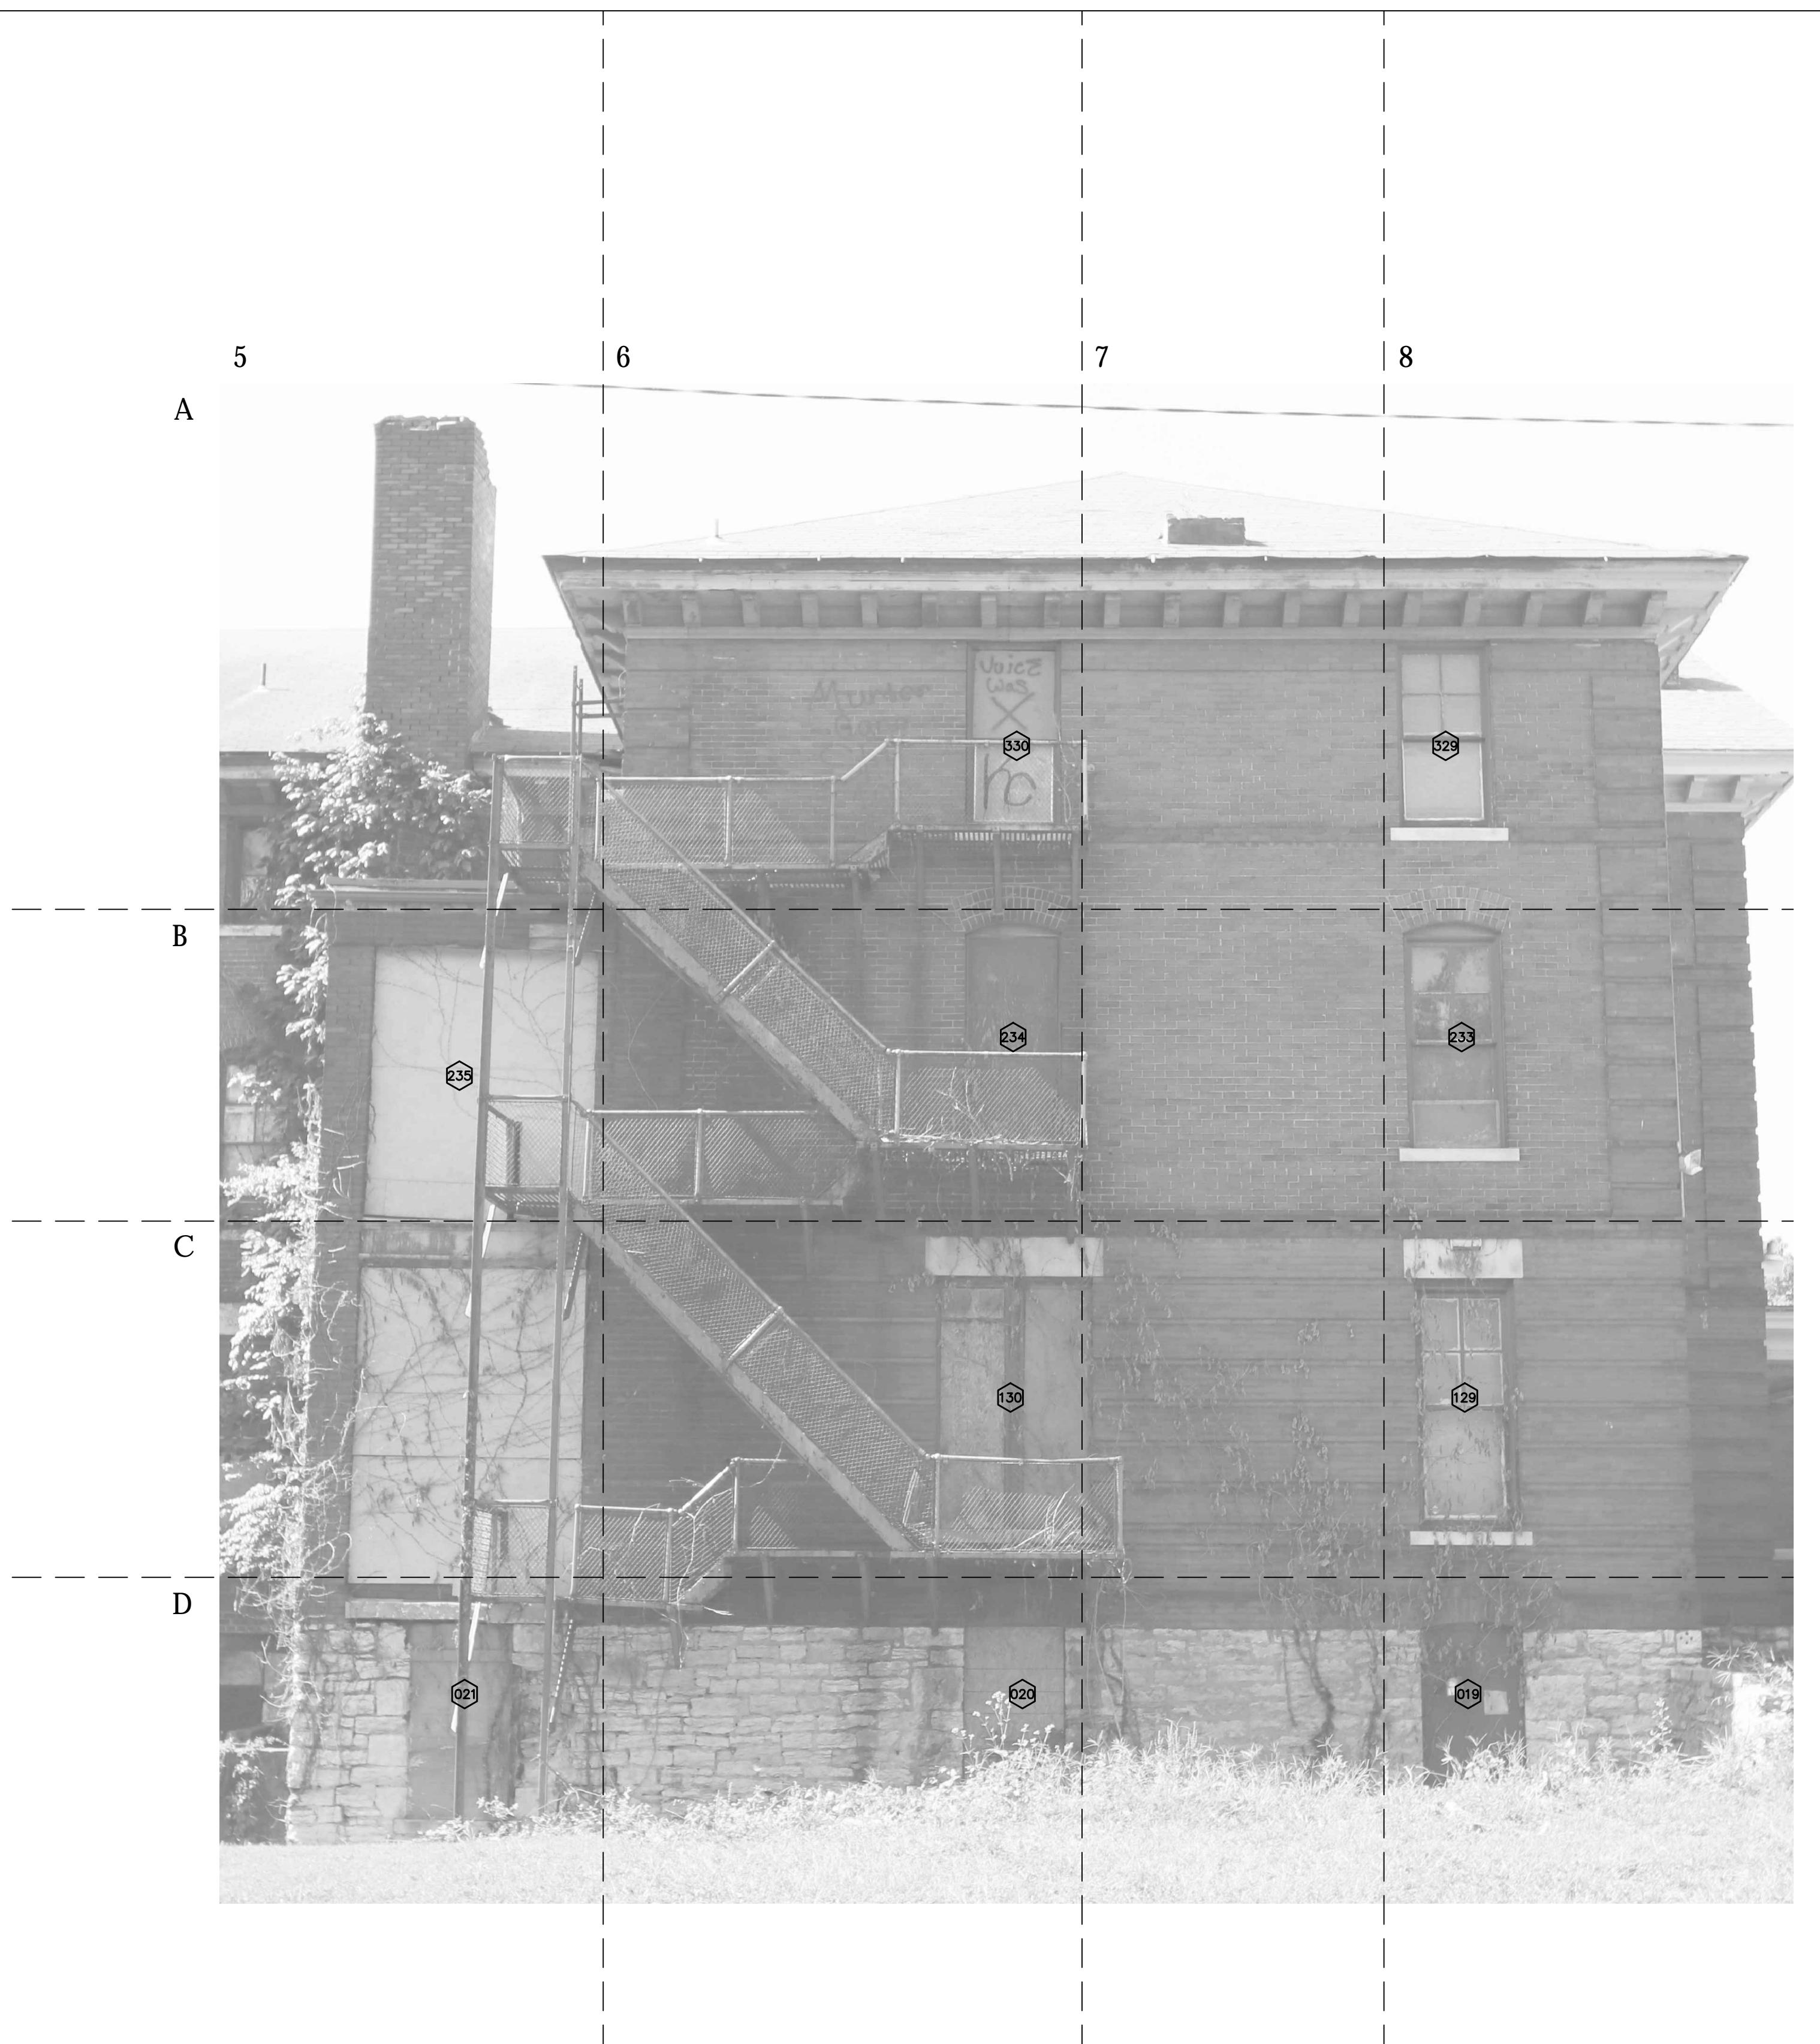
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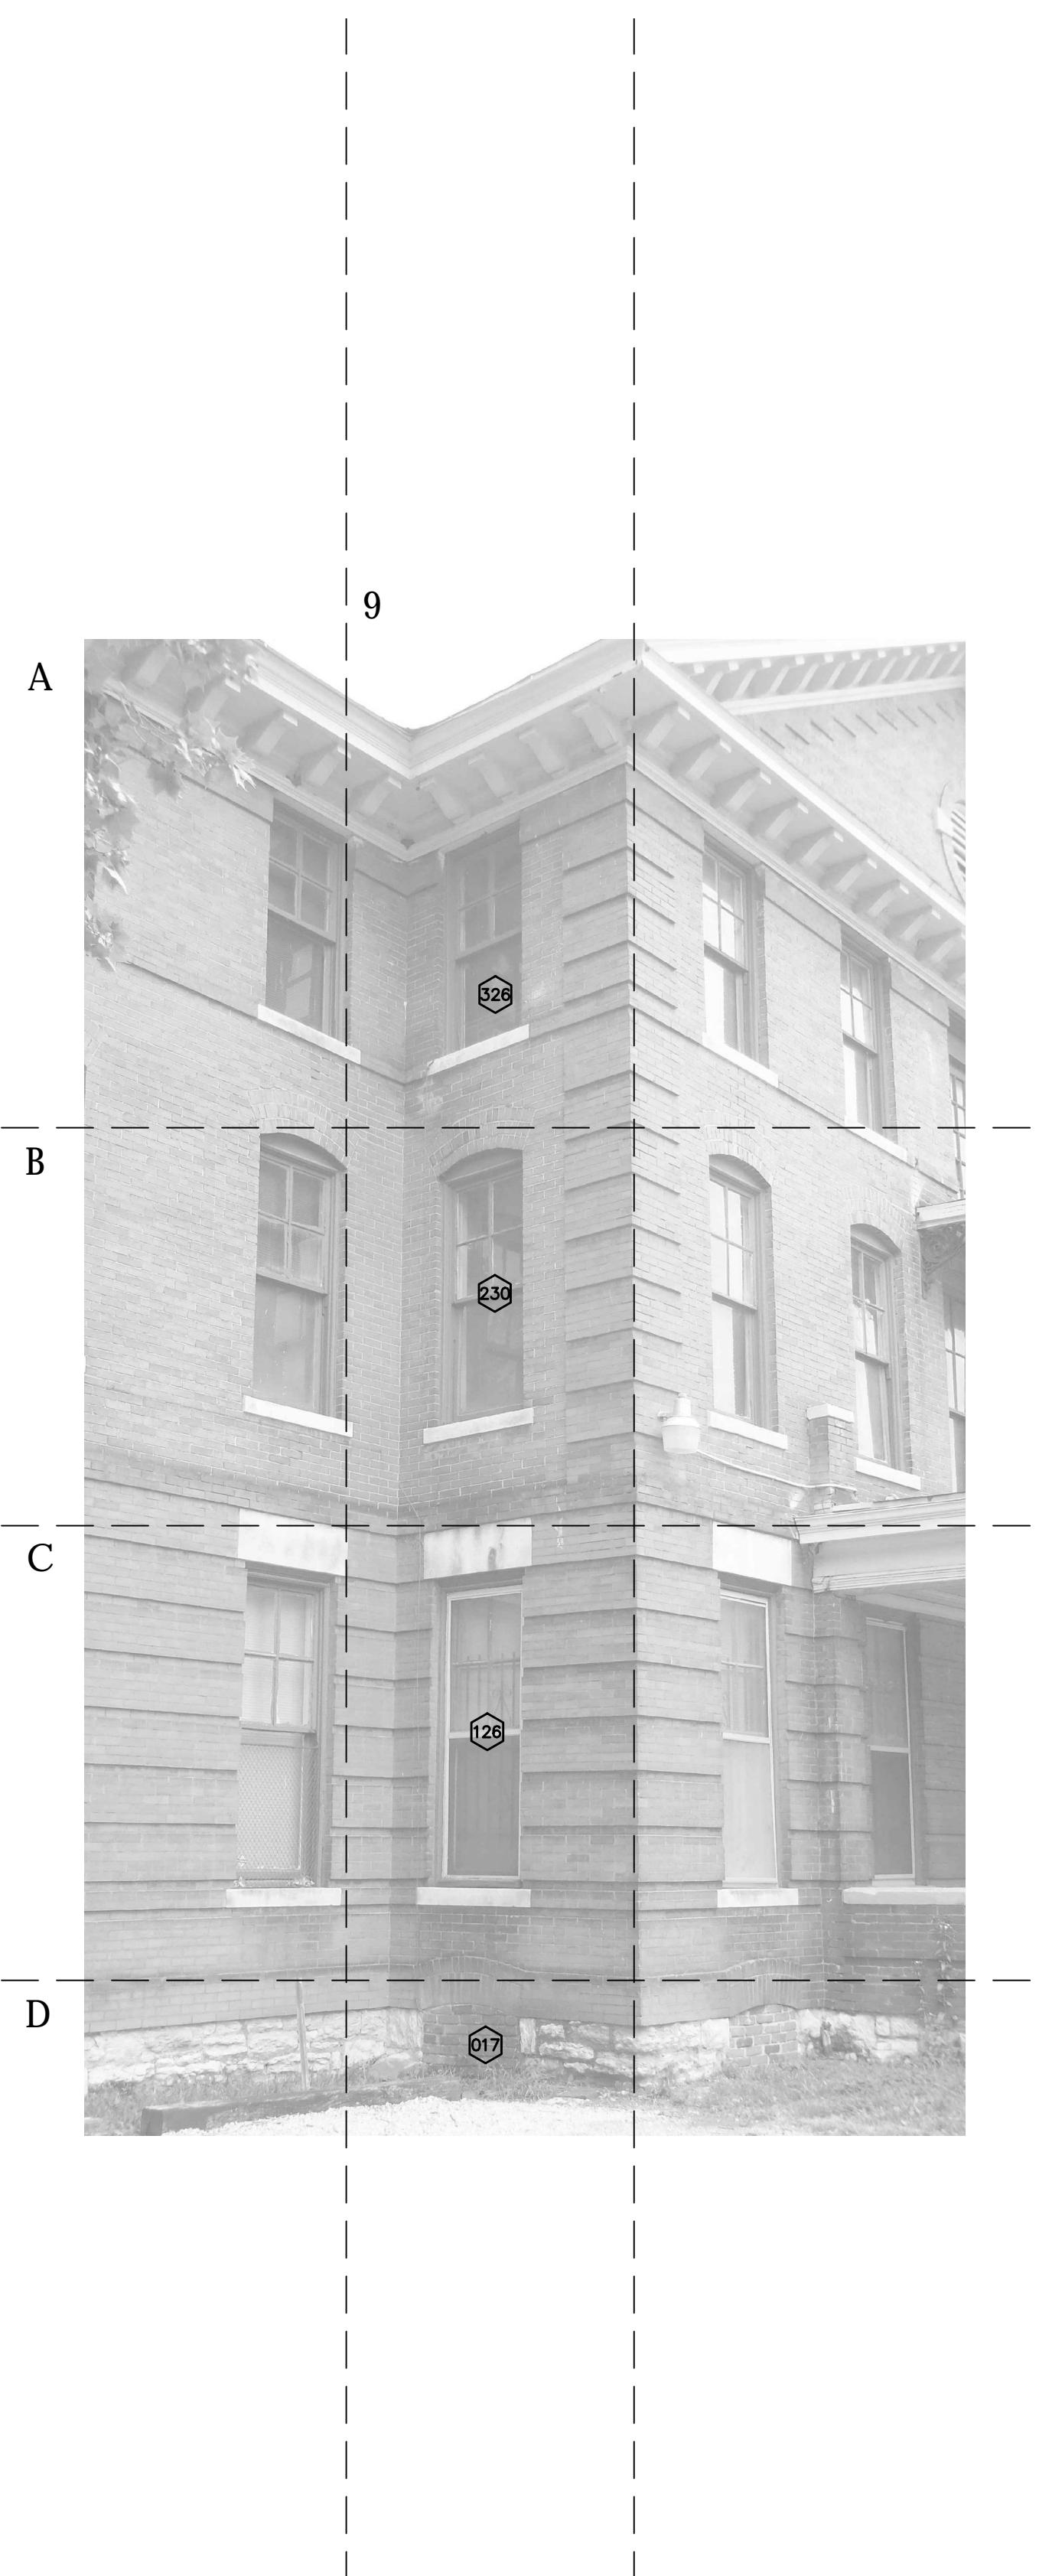
DATE: AUGUST 25, 2017
REVISION & DATE:

DESIGN DEVELOPMENT
EAST ELEVATION
SHEET NUMBER:

A204



1 NORTH ELEVATION



GENERAL EXTERIOR NOTES:

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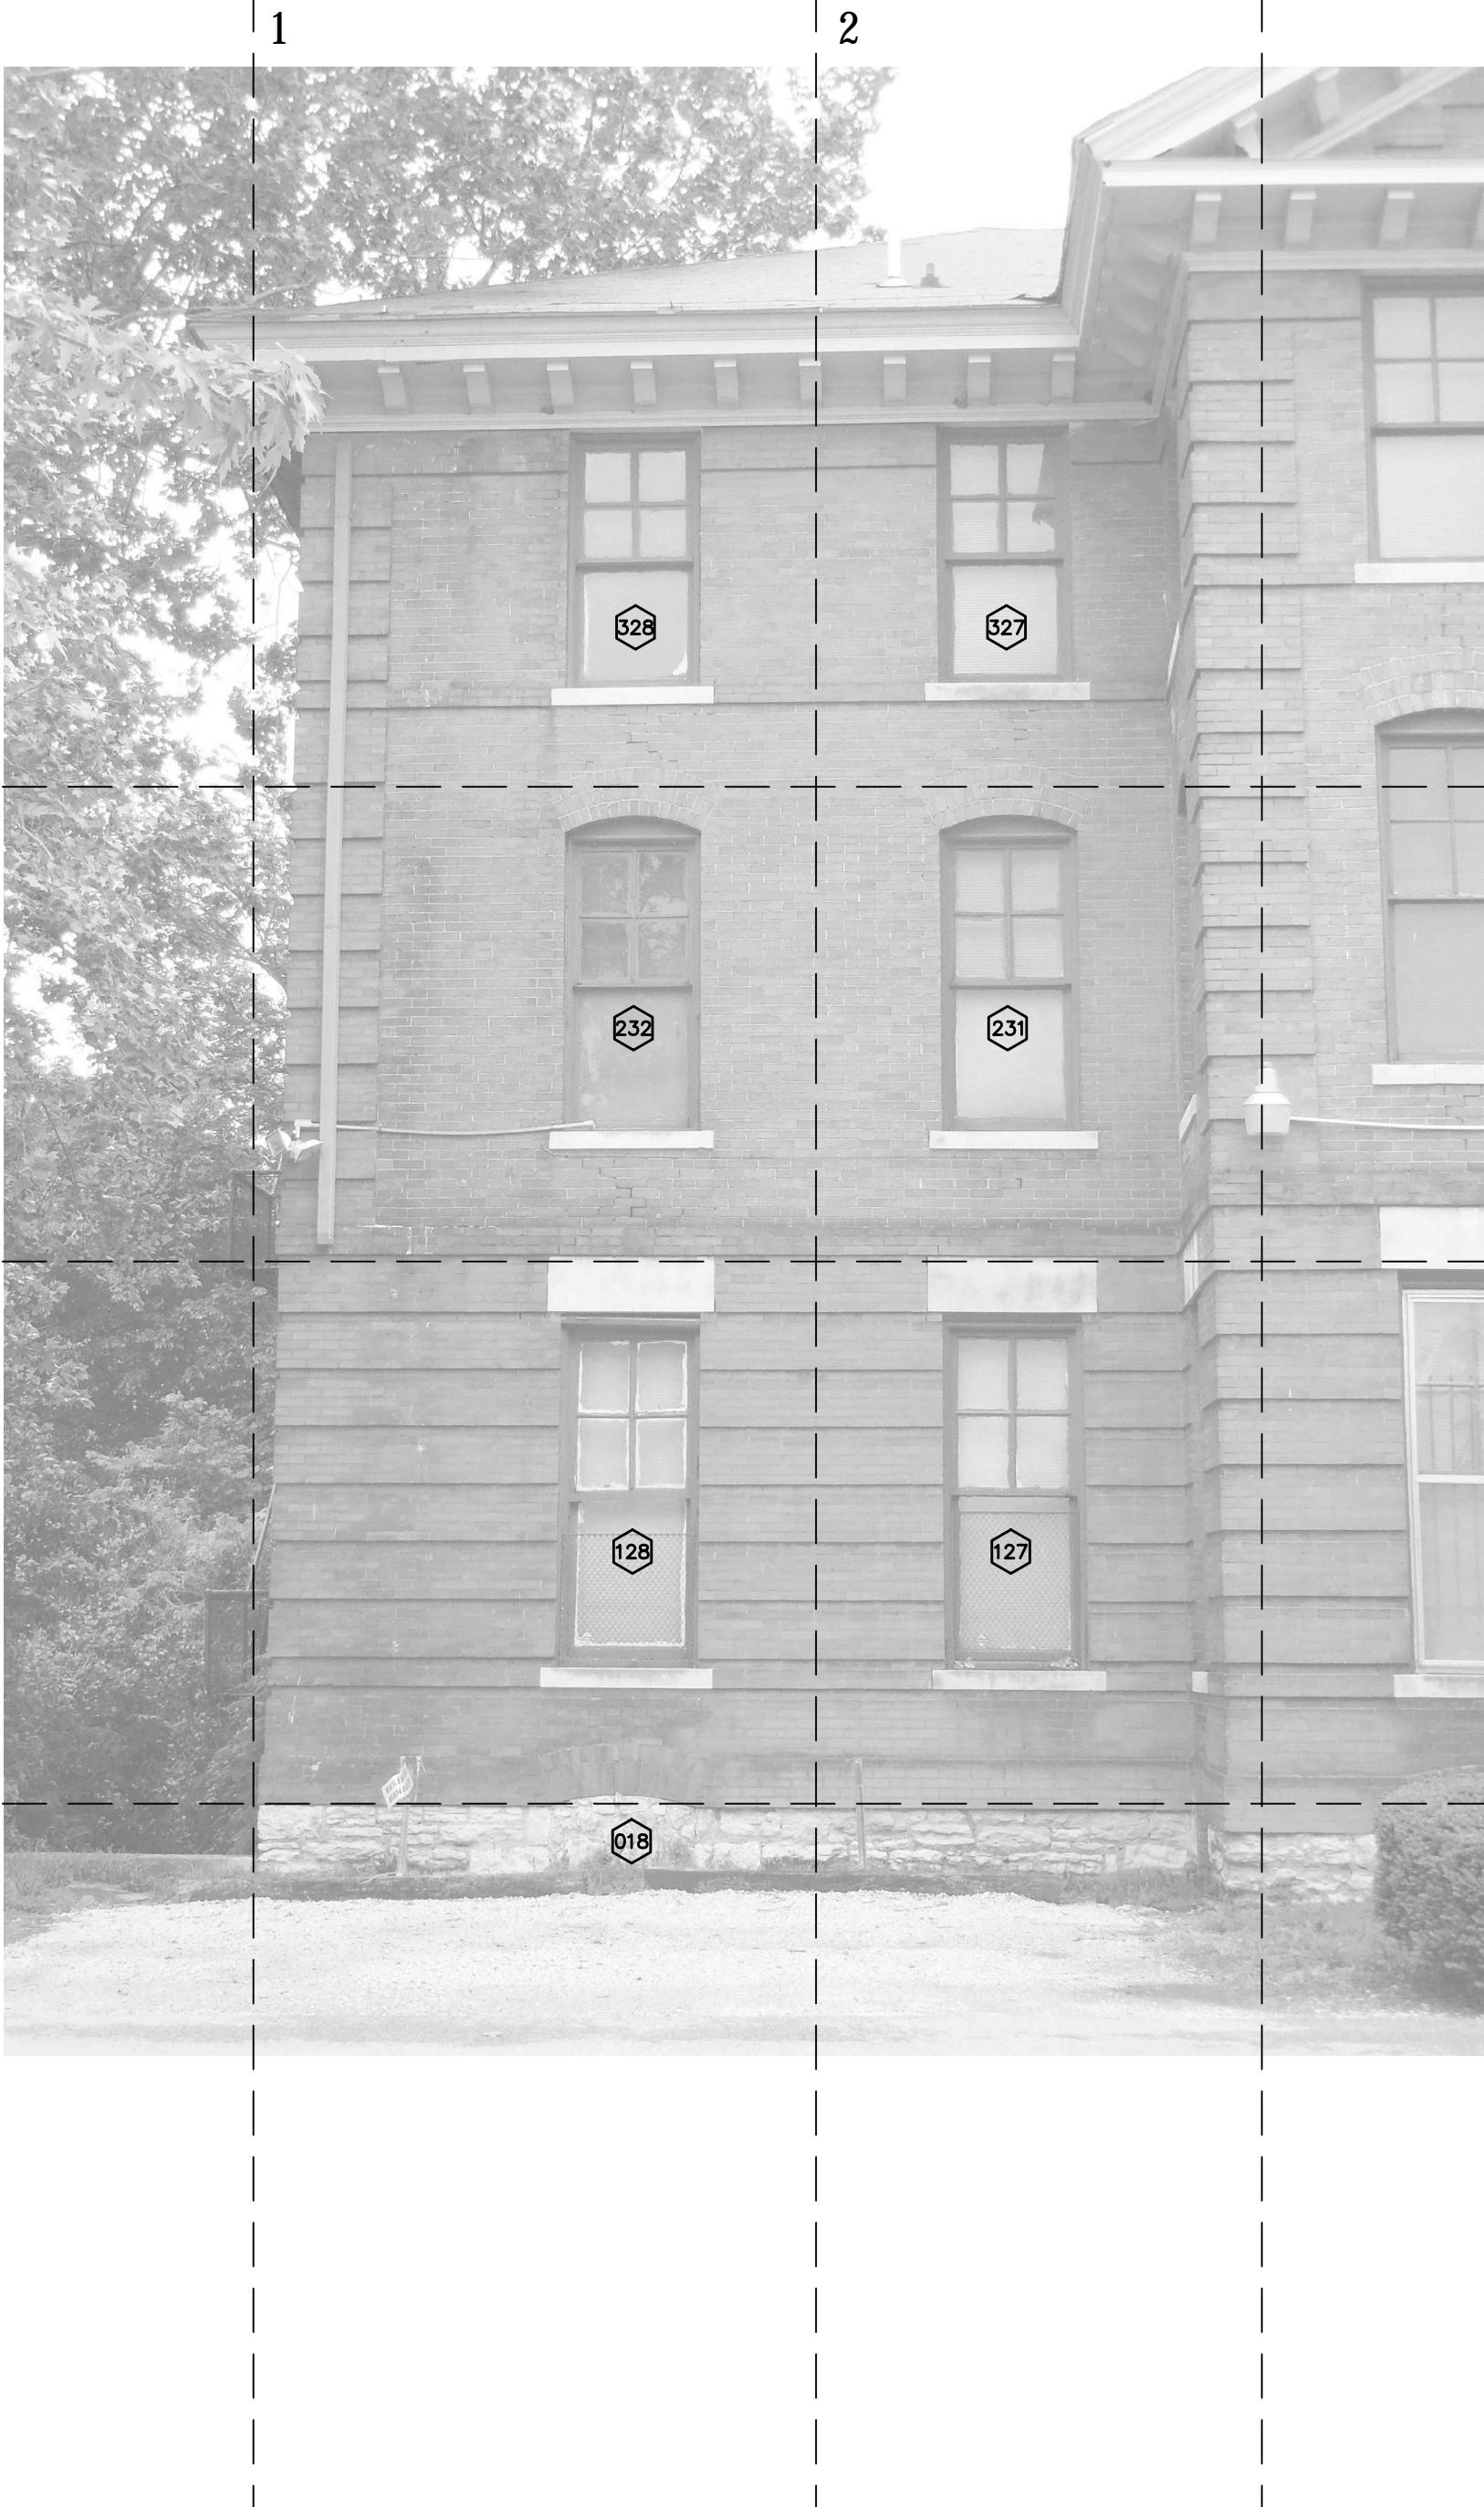
A205

1

Scale: 1/4" = 1'-0"

8 0 8 16
SCALE OF FEET

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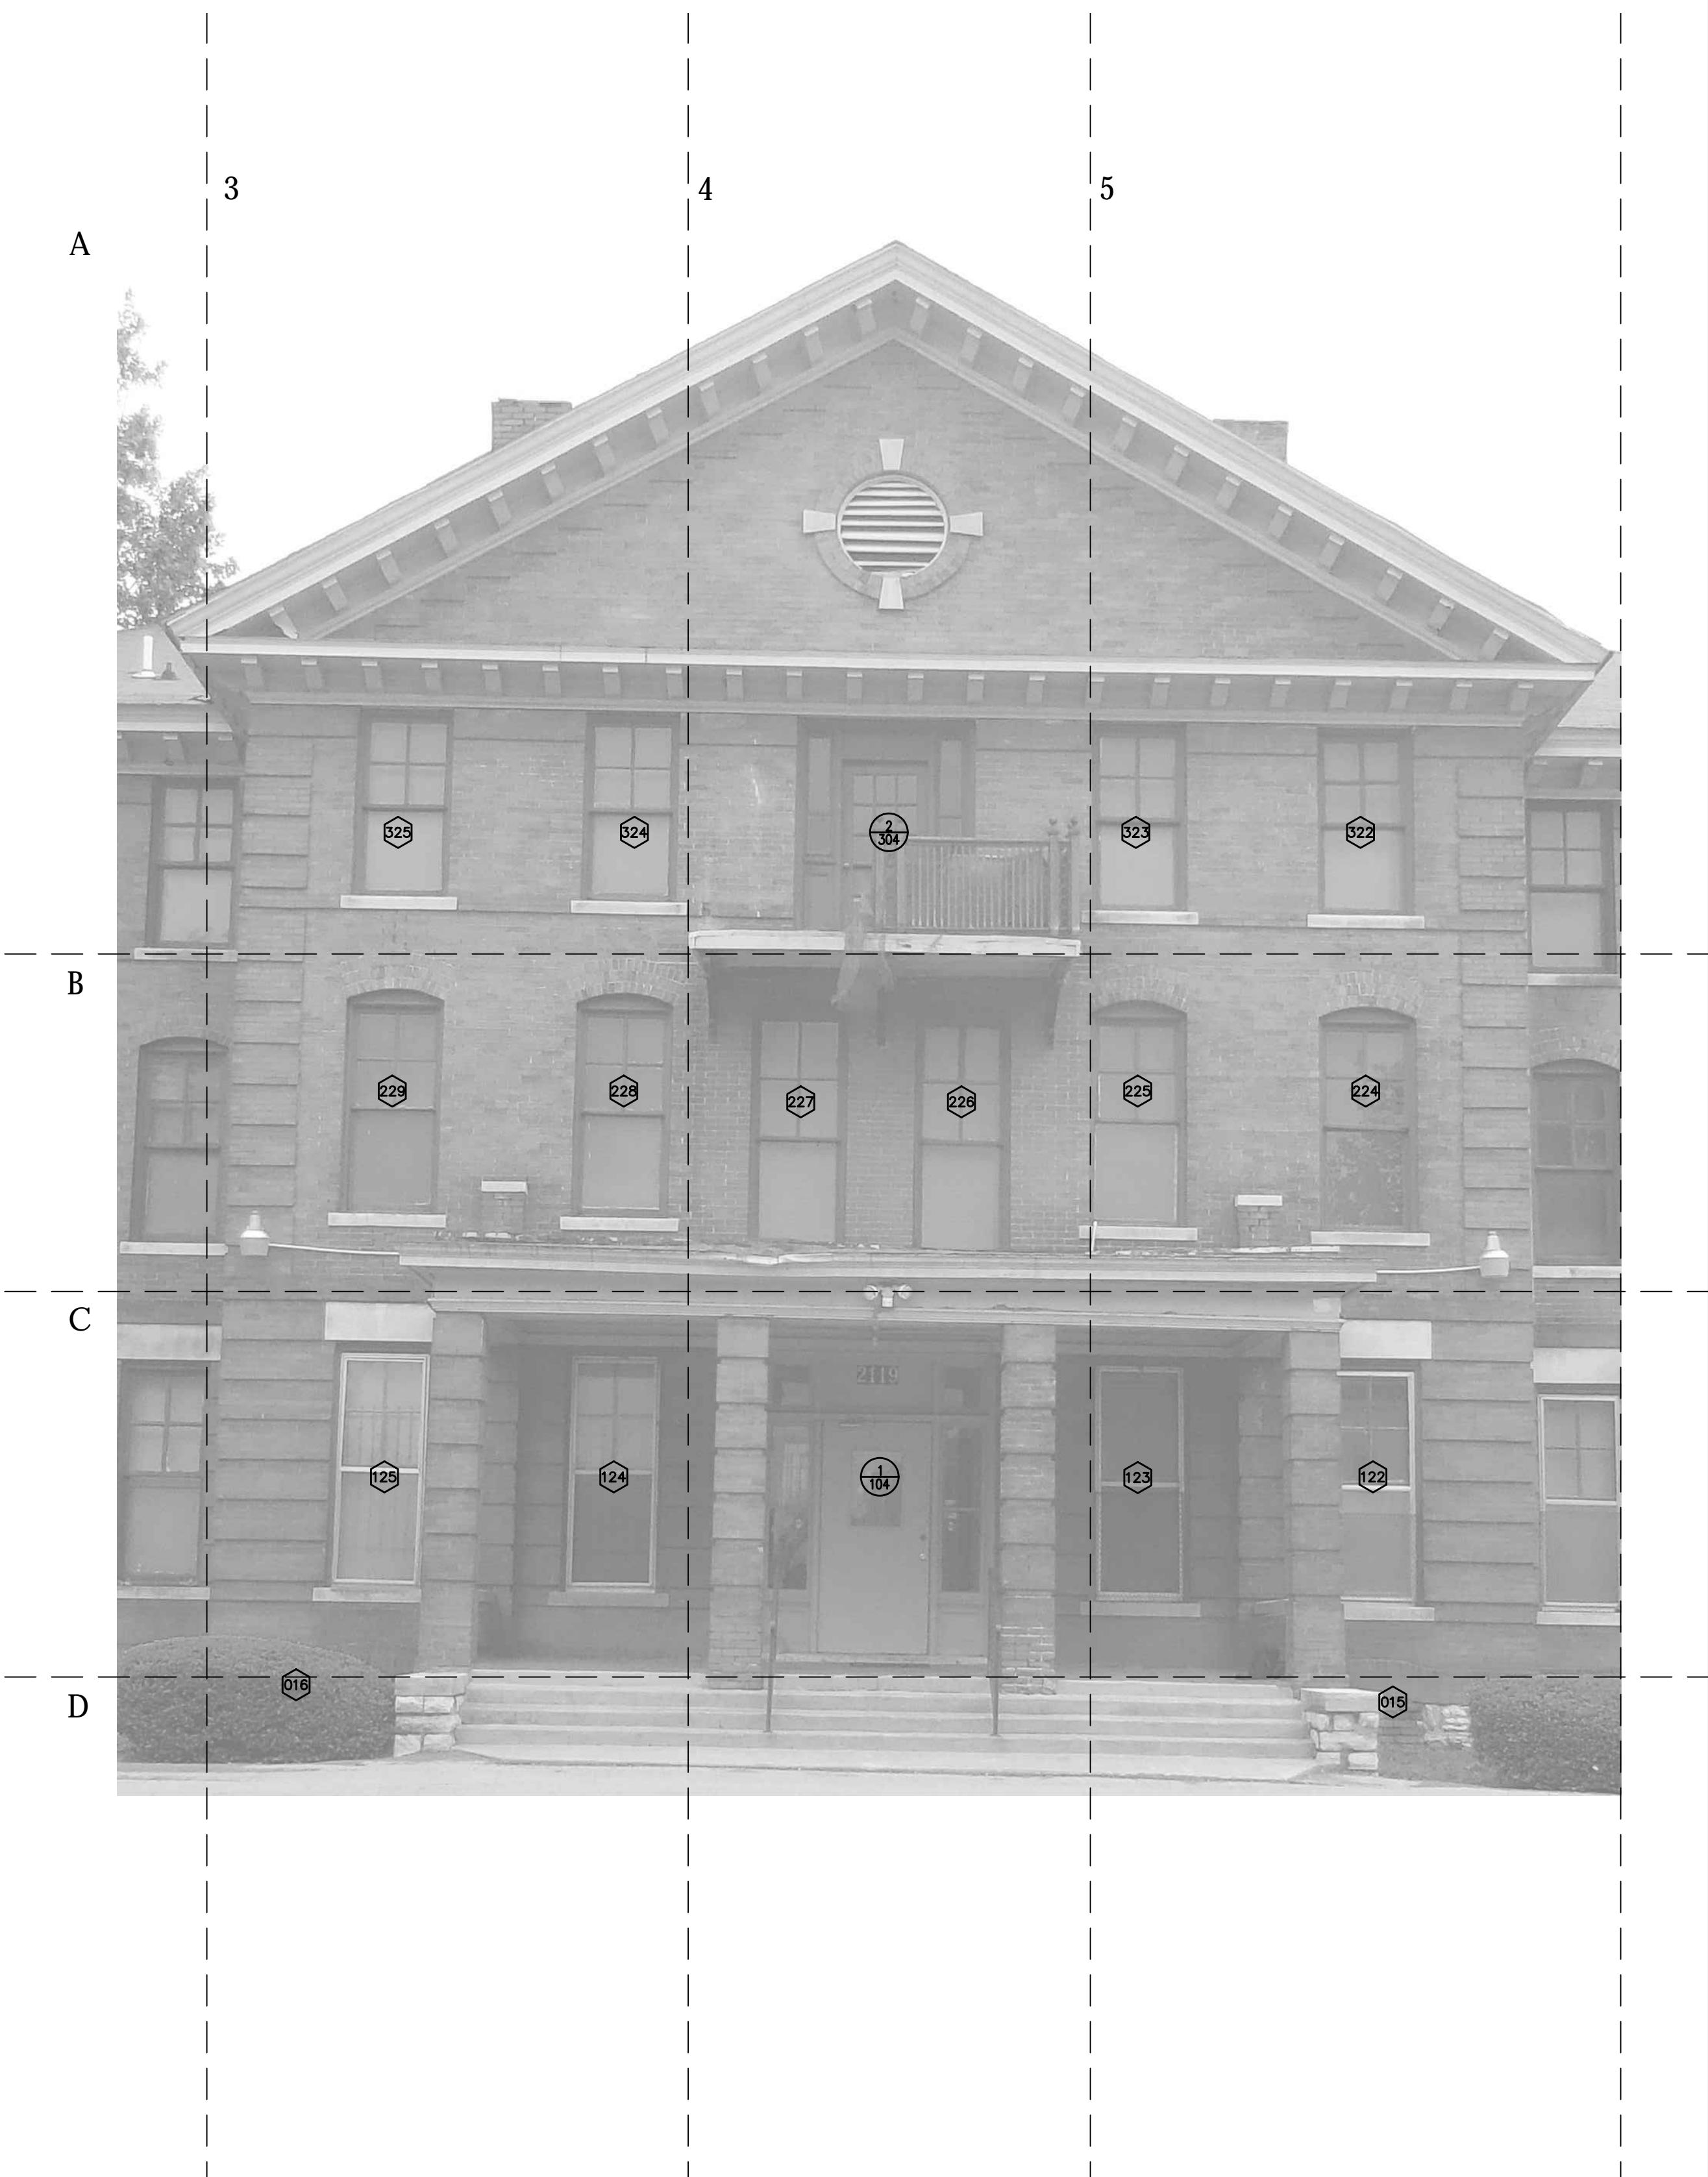
A

B

C

D

1 WEST ELEVATION



A

B

C

D

8 0 8 16
Scale: 1/4" = 1'-0"
SCALE OF FEET

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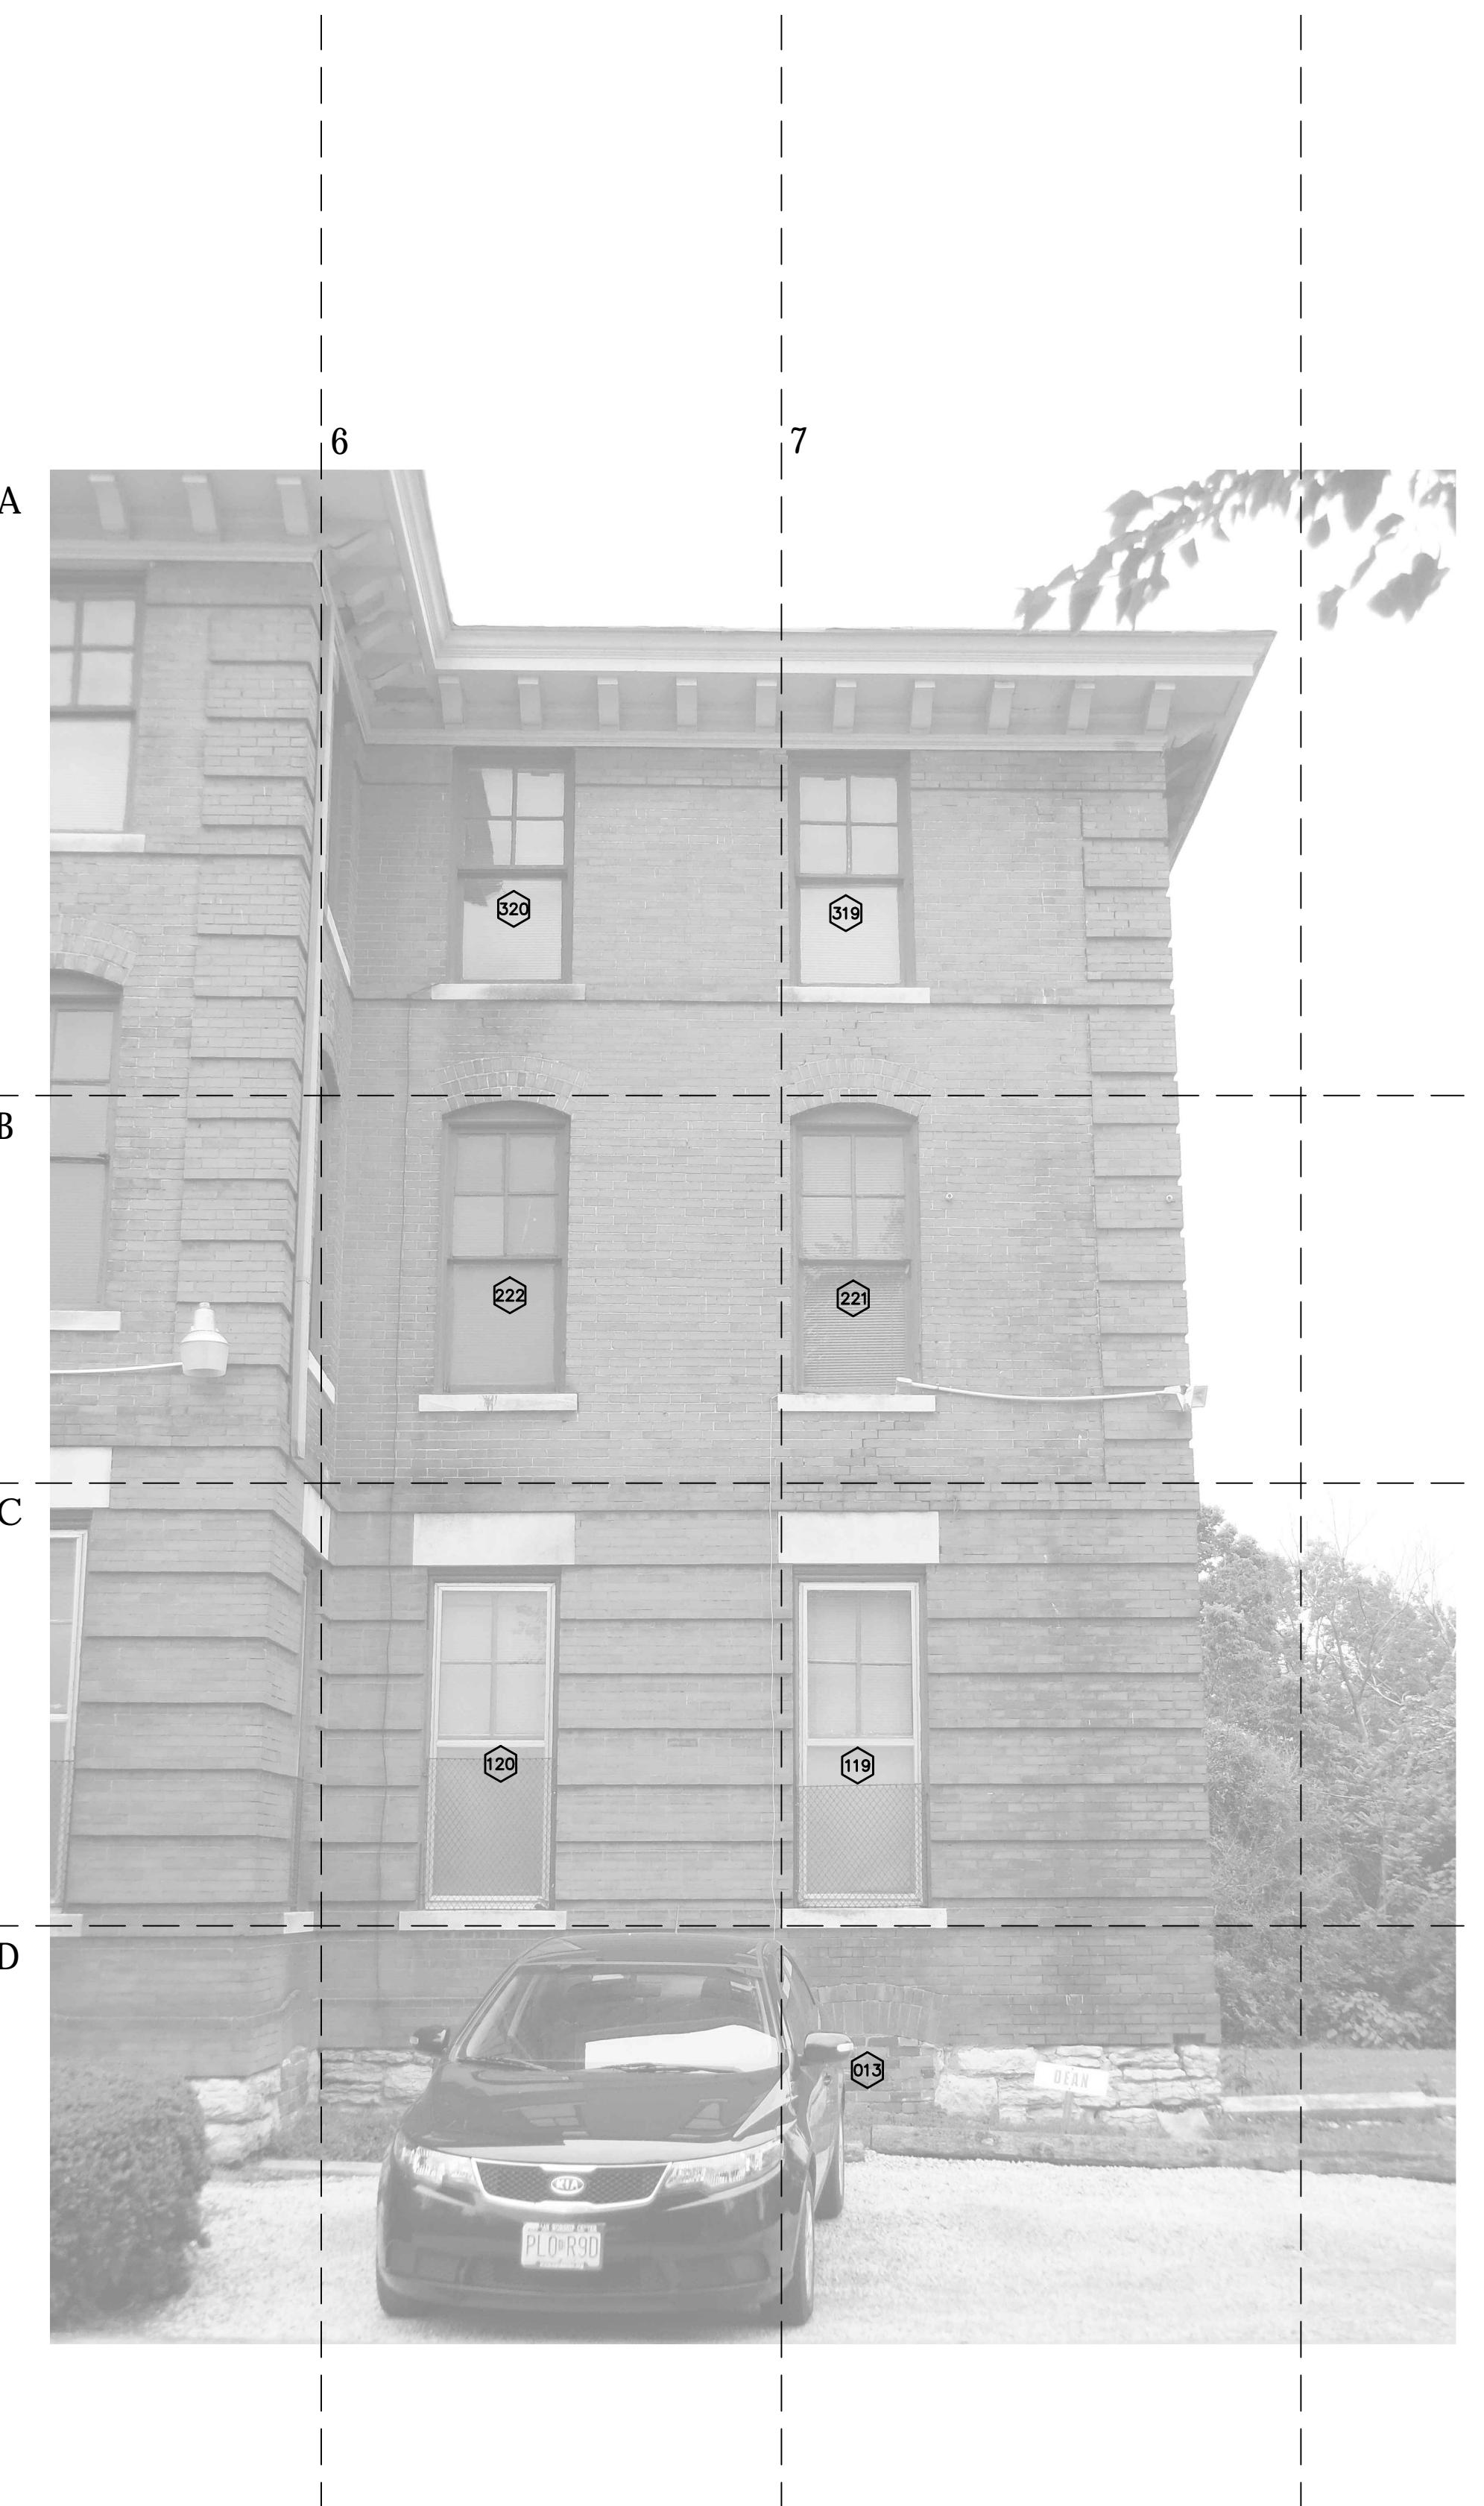
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NORTH ELEVATION
SHEET NUMBER:

A206



1 WEST ELEVATION - SOUTH SECTION

Scale: 1/4" = 1'-0"

8 0 8 16
SCALE OF FEET

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A207