

CITY PLAN COMMISSION STAFF REPORT

City of Kansas City, Missouri City Panning & Development Department www.kcmo.gov/cpc

October 19, 2021

Proiect Name I-49 Industrial Center North

Docket #10 Request

CD-CPC-2021-00109 - Development Plan.

Applicants

Chris Hafner

Davidson Architecture & Engineering.

Owners

Platform Ventures

Location Generally located at

NEC of Botts Rd and

M-150 Hwy.

Area About 256 acres

Zonina M2-2 & M3-5

Council District 6th

County Jackson

School District Grandview 130

Surrounding Land Uses

North: City of Grandview, Industrial and

residential (existing).

South: zoned M1-5, Industrial uses.

zoned M1-5/ M2-2, Apartments and

Industrial uses.

West: zoned UR, NNSA Federal Complex.

Major Street Plan

The City's Major Street Plan classifies Botts Road as Thoroughfare with 4 Through lanes. Missouri Route 150 is classified as a freeway.

Land Use Plan

The Martin City Area Plan recommends Industrial land use for the subject property. The request conforms to this recommendation.

APPROVAL PROCESS

City Plan Commission

City Council

NEIGHBORHOOD AND CIVIC ORGANIZATIONS NOTIFIED

The subject property does not lie within any registered neighborhood or civic organization therefore none were notified. Notice of the public hearing was sent to surrounding properties within 300 feet.

REQUIRED PUBLIC ENGAGEMENT

Public engagement as required by 88-505-12 applies to this request. The applicant held a virtual public meeting on July 22, 2021, a summary of which is attached. The meeting included abutting residents within Grandview city limits.

EXISTING CONDITIONS

The project site comprises of 13 parcels generally located at the northeast corner of MO Route 150 and Botts Road. The project is mostly undeveloped except for the existing Ideka Asphalt Plant located at the southeast corner of the site. The plan proposes to relocate the plan south of MO Route 150 (Docket No. 3). Botts Road at this location is elevated over 150 Hwy with on and off ramps. Access to the site is proposed via Botts Road and Colorado Avenue. The site is bisected by existing regulated streams.

Surrounding land uses includes existing industrial and residential uses with the City of Grandview to the north. To the east is the Cloverleaf apartments and industrial uses. The NNSA Federal Complex is on the west of Botts Road. To the south is the second plat of the CenterPoint Intermodal development. The parcel further south is I-49 Industrial Center approved in July 2021.

SUMMARY OF REQUEST

The applicant is seeking approval of a Development Plan (preliminary plat) to allow for 2.5 million square foot of office, commercial and warehouse development on 12 lots and two (2) tracts.

PROFESSIONAL STAFF RECOMMENDATION

Docket #10 Approval with conditions.

CONTROLLING CASE – There is no controlling case on this project site.

RELATED RELEVANT CASES

Case No. 14309-P - On July 3, 2012, the City Plan Commission approved a major site plan in District M3-5 (manufacturing 3-5) to allow for an asphalt plant on about 16.5 acres generally located at the northwest quadrant of Missouri Highway 150 and Colorado Avenue.



PLAN REVIEW

The applicant is seeking approval of a Development Plan for the "I 49 Industrial Center North" a logistics and warehousing facility on about 245 acres generally located at northeast corner of Botts Road and M 150 Hwy. The development plan proposed 12 industrial warehouse manufacturing and distribution buildings totaling approximately 2.5 million square feet with a total of 1,857 parking spaces and 747 trailer parking spaces. The buildings are proposed to be constructed of tilt up concrete panels accented with 3-tone paints. The rendering shows relief features and on the span of the building with entry treatments with canopies. The plan proposes additional semi-truck parking along the frontage of M-150 Hwy right-of-way along the southern edge of the site. The shown sidewalks complete the pedestrian sidewalk network for this area of the campus and provide proper internal pedestrian connections. Access to the development is proposed off M-150 Highway and Botts Road.

Use-Specific (88-300) and Development Standards (88-400)

Standards	Applicability	Meets	More Information
Boulevard and Parkway Standards (88-323)	NO		
Parkland Dedication (88-408)	NO		
Parking and Loading Standards (88-420)	YES		SEE ANALYSIS
Landscape and Screening Standards (88-425)	YES		SEE ANALYSIS
Outdoor Lighting Standards (88-430)	YES		SEE ANALYSIS
Sign Standards (88-445)	YES		SEE ANALYSIS
Pedestrian Standards (88-450)	YES		SEE ANALYSIS

Requested Deviations

The plan does not stipulate or request any deviations.

PLAN ANALYSIS

Staff expressed concern about the location of the proposed semi-truck parking and visibility from the public right of way. The applicant has provided perspectives showing the limited visibility due to the topography of the site. They have also proposed additional screening from the public right of way.

The developer has submitted a stream buffer waiver request application to the Land Development Division for review. This is an administrative review by staff with a recommendation to the City Council. Staff recommends that the ordinance request for this development plan proceed to City Council concurrently with the Stream Buffer Waiver request as the Council's action will have significant impact of the plan.

Parking and Loading Standards (88-420)

Section 88-420-06 Parking Ratios stipulates that for "Manufacturing, Production and Industrial Service" and "Warehousing, Wholesaling, Freight Movement" uses provide 1 parking space per 4 employees. Staff recommends adding long term and short term bicycle parking to the data table. The applicant's request conforms to the applicable requirements of this section subject to the correction.

Pedestrian Standards (88-450)

Staff recommends that the plan be revised so that the eastern sidewalk along Botts Rd should be extended northward to a point and connect to the west sidewalk to cross Hwy 150. Subject to the recommended conditions/plan corrections, the applicant's request conforms to the applicable provisions of this section.

Landscape and Screening Standards (88-425)

The applicant will install new street trees and interior landscaping throughout the site. Subject to the recommended conditions/plan corrections, the applicant's request conforms to the applicable provisions of this section.

Outdoor Lighting Standards (88-430)

A lighting plan is required with any new Development Plan application. A lighting plan has been provided which shows conformance to the sign regulations of the city's zoning and development code. Subject to the recommended conditions/plan corrections, the applicant's request conforms to the applicable provisions of this section.

Sign Standards (88-445)

The applicant is proposing to install several new signs throughout the site. A sign plan is required with any Development Plan application that proposes signage that exceeds the zoning and development code base regulations. Three new oversized monument signs are proposed on the southwest corner of the site near the intersection of M-150 Highway and Botts Road and also near the western and southeastern entrances. These will provide greater visibility to motorists and the sign near the intersection is needed to due to the grade change in this area. Development district monument signs are also shown along Botts Road and will list the tenants within the site. Additional individual building monument signs are also near the front of each individual building.

In order to be approved, the plan must comply with all of the following criteria:

88-516-05-A. The plan must comply with all standards of this zoning and development code and all other applicable city ordinances and policies.

Staff Analysis: The proposed development meets the requirements of the zoning and development code and follows the recommended land use of the Martin City Area Plan.

- **88-516-05-B.** The proposed use must be allowed in the district in which it is located.
- Staff Analysis: The warehouse, industrial, manufacturing, and warehousing uses are permitted within the M1-5 zoning district.
- **88-516-05-C.** Vehicular ingress and egress to and from the site, and circulation within the site, must provide for safe, efficient and convenient movement of traffic not only within the site but on adjacent roadways. Staff Analysis: The proposed plan meets the requirements for vehicular access and circulation.
- **88-516-05-D.** The plan must provide for safe, efficient, and convenient non-motorized travel opportunities, being pedestrian and bicycle movement, on the subject site.
- Staff Analysis: The applicant has revised the proposed site plans for consideration and review by the City Plan Commission that met the city's requirements for public sidewalk and internal pedestrian (non-motorized) travel.
- **88-516-05-E.** The plan must provide for adequate utilities based on City standards for the particular development proposed.
- Staff Analysis: There are adequate utilities to serve the proposed development.
- **88-516-05-F.** The location, orientation, and architectural features, including design and material, of buildings and other structures on the site must be designed to be compatible with adjacent properties. Staff Analysis: The applicant has revised the proposed building elevations to add additional architectural details and color improvements.
- **88-516-05-G.** Landscaping, berms, fences and/or walls must be provided to buffer the site from undesirable views, noises, lighting or other off-site negative influences and to buffer adjacent properties from negative influences that may be created by the plan.
- Staff Analysis: The proposed uses are very similar to those of the surrounding property. Therefore, no berms, fences, or other buffers are required. However, the applicant has provided a landscaping plan that focuses landscaping elements along the public roadway frontages rather than extensive internal landscaping elements for the warehouse and distribution buildings.
- **88-516-05-H.** The design of streets, drives, and parking areas within the project should result in a minimum of area devoted to asphalt or other impervious surfaces consistent with the needs of the project and city code requirements.

Staff Analysis: The proposed site plan provides an efficient layout for the proposed uses and does not create unnecessary impervious surfaces.

88-516-05-I. The plan must identify trees to be removed and trees to be preserved during the development of the subject property with the goal of saving trees that are not required to be removed for the development of the property.

Staff Analysis: The site currently has very few, if any, mature trees that would be removed for this development.

PROFESSIONAL STAFF RECOMMENDATION

Staff recommends Approval Subject to the Corrections and Conditions as reflected in the attached Plan Correction Report and Plan Conditions Report.

Respectfully Submitted,

Olofu Agbaji Planner

Plan Conditions, Corrections, & Recommendations Report



Recommended to City Plan Commission Recommended by Development Review Committee

Report Date: October 13, 2021

Case Number: CD-CPC-2021-00109

Project: I-49 Industrial Center North

Plan Corrections

Correction(s) by Development Management of the City Planning and Development Department. Contact Olofu Agbaji at 816-513-8815 / Olofu.Agbaji@kcmo.org with questions.

1. Overall parking along MO Route 150 shall be properly screened with a significant berm. Extend screening and berming along the west side of Colorado Avenue north of MO Route 150 to ensure that the truck parking is properly screened. Revise Plans and Resubmit (10/13/2021)

Correction(s) by Land Development Division of the City Planning and Development Department. Contact Stacey Lowe at 816-513-2552 / stacey.lowe@kcmo.org with questions.

- 2. Preliminary stream buffer plan was not submitted in accordance with the requirements of Section 88-415. Ensure that the plan includes the information regarding the floodplain limits for the property and all of the regulated streams present on the property. (7/27/2021)
- 3. Preliminary plat drawing needs to be revised to remove any proposed easements shown inside the City's right of way for the proposed east-west roadway. Any existing easements will need to be subordinated prior to recording of the plat. Revise Plat and Resubmit (10/07/2021)

Correction(s) by Water Services - Stormwater of the Water Services Department. Contact Amy Bunnell at / amy.bunnell@kcmo.org with questions.

4. Not approved without stream buffer exception. (7/28/2021)

Correction(s) by Water Services - Water of the Water Services Department. Contact Jerald Windsor at 816-513-2904 / Jerald.Windsor@kcmo.org with questions.

- 5. Show and label the public and private water mains and fire hydrants. Label the sizes of the water mains. Show and label public street ROW and water main easements. Submit plans at 1"=100' maximum scale.
 - 10-7-21 -- Please label & show size of the public & Private water mains, Fire hydrants, domestic water service lines and fire service lines. Please show location of Fire Hydrants (both public & private) existing & proposed located every 300' feet or less. Please label/ name all street by name or proposed name, please label private drives. The drawings show fire lines(wtrf) in public R.O.W. and water mains (wtrm) in private R.O.W) & no domestic lines(wtrd) are shown entering any building. Some fire lines(wtrf) are not shown entering the buildings. Please update plan sheets to show proper water services to all buildings. Please email jerald.windsor@kcmo.org to get any further clarifications. (7/28/2021)

Condition(s) by City Planning and Development Department. Contact Olofu Agbaji at 816-513-8815 / Olofu Agbaji@kcmo.org with questions.

- 6. The developer shall secure approval of a project plan from the City Plan Commission for each building or phase prior to issuance building permit. (10/13/2021)
- 7. The developer shall submit an affidavit, completed by a landscape architect licensed in the State of Missouri, verifying that all landscaping required of the approved plan has been installed in accordance with the plan and is healthy prior to Certificate of Occupancy. (10/13/2021)
- 8. The developer shall submit an affidavit, completed by a landscape architect licensed in the State of Missouri, verifying that street trees have been installed in accordance with the approved street tree planting plan and are healthy prior to Certificate of Occupancy. (10/13/2021)
- 9. That the developer submit a design guideline for the proposed development per staff approval prior to ordinance request.

 The design guidelines shall incorporate the Martin City Area Plan design guidelines wherever the opportunity presents itself.

 The guidelines shall call out all preferred and prohibited building materials. (10/13/2021)
- 10. Prior to issuance of a final certificate of occupancy, all landscaping as shown on the approved landscape plan, including trees, plant material and structural elements, must be in place and healthy, as certified by a sealed letter submitted by a registered landscape architect licensed in the State of Missouri. (10/13/2021)

Condition(s) by City Planning and Development Department. Contact Stacey Lowe at 816-513-2552 / stacey.lowe@kcmo.org with questions.

- 11. The developer must [grant on City approved forms, a STREAM BUFFER Easement to the City] or [show and label the final stream buffer zones on the subdivision plat within a private open space tract], as required by Chapter 88 and Land Development Division, prior to issuance of any stream buffer permits. (7/27/2021)
- 12. The developer shall submit verification of vertical and horizontal sight distance for the drive connection to public right-of-way to the Land Development Division and make improvements to ensure local jurisdiction and/or minimum AASHTO adequate sight distance standards are met, prior to issuance of any certificate of occupancy. (7/27/2021)
- 13. The developer shall cause the area to be platted and processed in accordance with Chapter 88, Code of Ordinances of the City of Kansas City, Missouri, as amended, commonly known as the Development Regulations. (7/27/2021)
- 14. The developer must secure permits to extend public sanitary and storm water conveyance systems to serve all proposed lots within the development and determine adequacy of receiving systems as required by the Land Development Division, prior to recording the plat or issuance of a building permit whichever occurs first. (7/27/2021)
- 15. The developer must integrate into the existing street light system any relocated existing street lights within the street right-of-way impacted by the new drive or approach entrances as required by the Land Development Division, and the relocated lights must comply with all adopted lighting standards. (7/27/2021)
- 16. The developer must obtain the executed and recorded city approved grading, temporary construction, drainage/sewer, or any other necessary easements from the abutting property owner(s) that may be required prior to submitting any public improvements crossing properties not controlled by the developer and include said document(s) within the public improvement applications submitted for permitting (7/27/2021)
- 17. The developer must submit covenants, conditions and restrictions to the Land Development Division for review by the Law Department for approval and enter into covenant agreements for the maintenance of any private open space tracts with stream buffer zones or stormwater detention area tracts, prior to recording the plat. (7/27/2021)
- 18. The developer must grant a [BMP and/or Surface Drainage Easement] to the City as required by the Land Development Division, prior to recording the plat or issuance of any building permits. (7/27/2021)
- 19. The developer must subordinate to the City all private interest in the area of any right-of-way dedication, in accordance with Chapter 88 and as required by the Land Development Division, prior to issuance of any construction permits within said right-of-way, and that the owner/developer shall be responsible for all costs associated with subordination activities now and in the future. (7/27/2021)
- 20. The developer must provide an erosion hazard analysis for areas where any improvements or public right-of-way dedications are proposed within stream buffer zones or adjacent to the outside of stream meanders as required by Water Services. (7/27/2021)

Condition(s) by City Planning and Development Department. Contact Stacey Lowe at 816-513-2552 / stacey.lowe@kcmo.org with auestions.

- 21. The developer must pay impact fees as required by Chapter 39 of the City's Code of ordinances as required by the Land Development Division. (7/27/2021)
- 22. The developer must show the limits of the 100-year floodplain on the final plat and show the Minimum Low Opening Elevation (MLOE) of any structure on each lot that abuts a 100-year flood prone area (including detention basins and engineered surface drainage conveyances) on any plat and plan, as required by the Land Development Division. (7/27/2021)
- 23. The developer must enter into a covenant agreement for the maintenance of any stormwater detention area tracts as required by the Land Development Division, prior to recording the plat. (7/27/2021)
- 24. The developer shall submit a Preliminary Stream Buffer plan prior to approval of the [Special Use /Development/Rezoning] plan in accordance with the Section 88-415 requirements. (7/27/2021)
- 25. The owner/developer must submit plans for grading, siltation, and erosion control to Land Development Division for review and acceptance, and secure a Site Disturbance permit for any proposed disturbance area equal to one acre or more prior to beginning any construction activities. (7/27/2021)
- 26. The developer shall submit a final stream buffer plan to the Land Development Division for approval prior to issuance of any building permits and obtain permits for the Stream Buffer prior to removal of any mature riparian species within the buffer zones due to construction activities on the site, in accordance with the Section 88-415 requirements. (7/27/2021)
- 27. After the City Plan Commission enters its disposition for the development plan, the developer shall not enter into any agreement that would encumber or otherwise have any impact on the proposed right-of-way dedications for the planned project without the prior written consent of the Land Development Division. (7/27/2021)
- 28. The developer must design and construct all interior public streets to City Standards, as required by Chapter 88 and the Land Development Division, including curb and gutter, storm sewers, street lights, and sidewalks. (7/27/2021)
- 29. The developer must submit a Macro storm drainage study with the first Plat or Phase, from a Missouri-licensed civil engineer to the Land Development Division showing compliance with current adopted standards in effect at the time of submission, including Water Quality BMP's, to the Land Development Division for review and acceptance for the entire development area, and submit Micro storm drainage study with each subsequent Plat or Phase showing compliance with the approved Macro and adopted standards. The developer shall secure permits to construct any improvements as necessary to mitigate impacts from rate, volume, and quality of runoff from each proposed phase, prior to recording the plat or prior to issuance of a Building Permit, whichever occurs first as required by the Land Development Division. (7/27/2021)
- 30. The developer must obtain a floodplain certificate from Development Services prior to beginning any construction activities with the floodplain. (7/27/2021)

Condition(s) by Fire Department. Contact Michael Schroeder at 816-513-4611 / michael.schroeder@kcmo.org with questions.

- 31. The expectation is the project will meet the fire flow requirements as set forth in Appendix B of the International Fire Code 2018. (IFC-2018 § 507.1) (7/22/2021)
- 32. Fire hydrant distribution shall follow IFC-2018 Table C102.1 (7/22/2021)
- 33. Fire hydrants shall be installed and operable prior to the arrival of any combustible building materials onto the site. (IFC-2018 § 501.4 and 3312.1; NFPA 241-2013 § 8.7.2) (7/22/2021)
- 34. Buildings equipped with a fire standpipe system shall have an operable fire hydrant within 100 feet of the Fire Department Connection (FDC). (IFC2018 § 507.5.1.1) (7/22/2021)
- 35. Fire Department access roads shall be provided prior to construction/demolition projects begin. (IFC-2018 § 501.4 and 3310.1; NFPA 241-2013 § 7.5.5) (7/22/2021)
- 36. Required fire department access roads are designed to support a fire apparatus with a gross axle weight of 85,000 pounds. (IFC-2018: § 503.2.3) (7/22/2021)
- 37. Aerial Fire Apparatus access roads shall be provided for any building that is 30 feet in height or greater. Aerial Fire Apparatus Roads are a minimum 26 feet wide, at least 15 feet away from the building but not more than 30 feet from the structure. (IFC-2018 § D105). (7/22/2021)

Condition(s) by Fire Department. Contact Michael Schroeder at 816-513-4611 / michael.schroeder@kcmo.org with questions.

- 38. Buildings exceeding 62,000 square feet in area shall have at least two means of fire apparatus access (IFC-2018: § D104.2) (7/22/2021)
- 39. Where two fire apparatus access roads are required, they shall be placed a distance apart equal to not less than one half of the length of the maximum overall diagonal dimension of the lot or area to be served, measured in a straight line between accesses. (IFC-2018: § D104.3) (7/22/2021)

Condition(s) by Public Works Department. Contact Jeffrey Bryan at 816-513-9865 / Jeffrey.Bryan@kcmo.org with questions.

- 40. Prior to certificate of occupancy for any building in the north phase of construction, the developer shall construct a southbound left turn lane with at least 140 feet of storage on Botts Road at the North NNSA Access Road. (10/07/2021)
- 41. Prior to certificate of occupancy for any building in the south phase of construction, the developer shall construct a southbound left turn lane with at least 140 feet of storage and 100 feet of taper on Botts Road at the South NNSA Access Road. (10/07/2021)
- 42. Prior to certificate of occupancy for any building in the south phase of construction, the developer shall construct a northbound right turn lane with at least 90 feet of storage and 100 feet of taper on Botts Road at the South NNSA Access Road. (10/07/2021)
- 43. Prior to certificate of occupancy for any building in the south phase of construction, the developer shall construct traffic signals at the intersection of Botts Road and the South NNSA Access Road. (10/07/2021)

Condition(s) by Water Services Department. Contact Heather Massey at / heather.massey@kcmo.org with questions.

- 44. The developer shall have a water flow test done to ensure there is adequate water pressure to serve the development. South of River contact –Sean Allen -816-513-0318
 North of River contact Dan Richardson 816-513-4883 (7/28/2021)
- 45. The developer shall ensure that water and fire service lines should meet current Water Services Department Rules and Regulations.

 $https://www.kcwater.us/wp-content/uploads/2019/04/2018-Rules-and-Regulations-for-Water-Service-Lines.pdf \equiv (7/28/2021)$

 $Condition (s)\ by\ Water\ Services\ Department.\ \ Contact\ Jerald\ Windsor\ at\ 816-513-2904\ /\ Jerald. Windsor\ @kcmo.org\ with\ questions.$

46. The developer must submit water main extension drawings prepared by a registered professional Engineer in Missouri to the main extension desk for review, acceptance and contracts per the KC Water Rules and Regulations for Water main extensions and Relocations.


 $(https://www.kcwater.us/wp-content/uploads/2019/04/2018-Rules- and -Regulations- for-Water-Main-Extensions.pdf) \\ (7/28/2021)$

Plan Recommendations

Recommendation(s) by Water Services Department. Contact Amy Bunnell at / amy.bunnell@kcmo.org with questions.

47. Note: Drainage studies are not reviewed or approved through this process. (10/01/2021)

copyright: code review: The following documents are the sole property of governing municipality: Kansas City, MO A0.0 cover sheet governing code: 2018 International Building Code davidson architecture & engineering, Ilc for the specific purpose of construction of said building. 2018 International Fire Code These documents are considered confidential and 2018 NFPA 101 Life Safety A1.1 Site Plan subject to davidson architecture & engineering llc's 2018 International Mechanical Code copyright protection. Neither receipt nor possession 2018 Uniform Plumbing Code 2012 IECC transfers any rights to reproduce these documents or 2018 IFGC any part thereof. Any re-use of these documents 2017 NEC without the express written permission of davidson architecture & engineering, Ilc is strictly prohibited and shall confer no liability to davidson architecture & Construction Type: A1.6 Signage Plan engineering, Ilc. Zoning: A1.7 View Sections ESFR fire sprinkler system Fire Protection: Total Site Area: 10,693,914 sq. ft., 245 ac. Total Building Area: 2,460,408 sq. ft. LANDSCAPE **Building Area Ratio:** Total Impervious Area: 5,433,131 sq. ft., 51% Total Green Space: 5,261,114 sq. ft., 49% PHOTOMETRIC project description: disclaimer: CIVIL These documents are accurate to the best of davidson new spec buildings of various sizes north of Hwy 150 architecture & engineering, Ilc's professional at the I-49 Industrial Center knowledge. In the event a discrepancy in the documents is encountered, it is the responsibility of that party to notify davidson architecture & engineering in a timely manner, for corrections and/or explanation of the documents. C1.2 Overall Utility Plan C1.2A Overall Utility Plan A C1.2B Overall Utility Plan B C1.2C Overall Utility Plan C C1.3 Preliminary Plat Overall Grading Plan C2.1A Overall Grading Plan A C2.1B Overall Grading Plan B C2.1C Overall Grading Plan C ARCHITECTURAL A3.1 Typical Elevations A3.2 Typical Elevations A3.3 Typical Elevations A3.4 Building Renderings

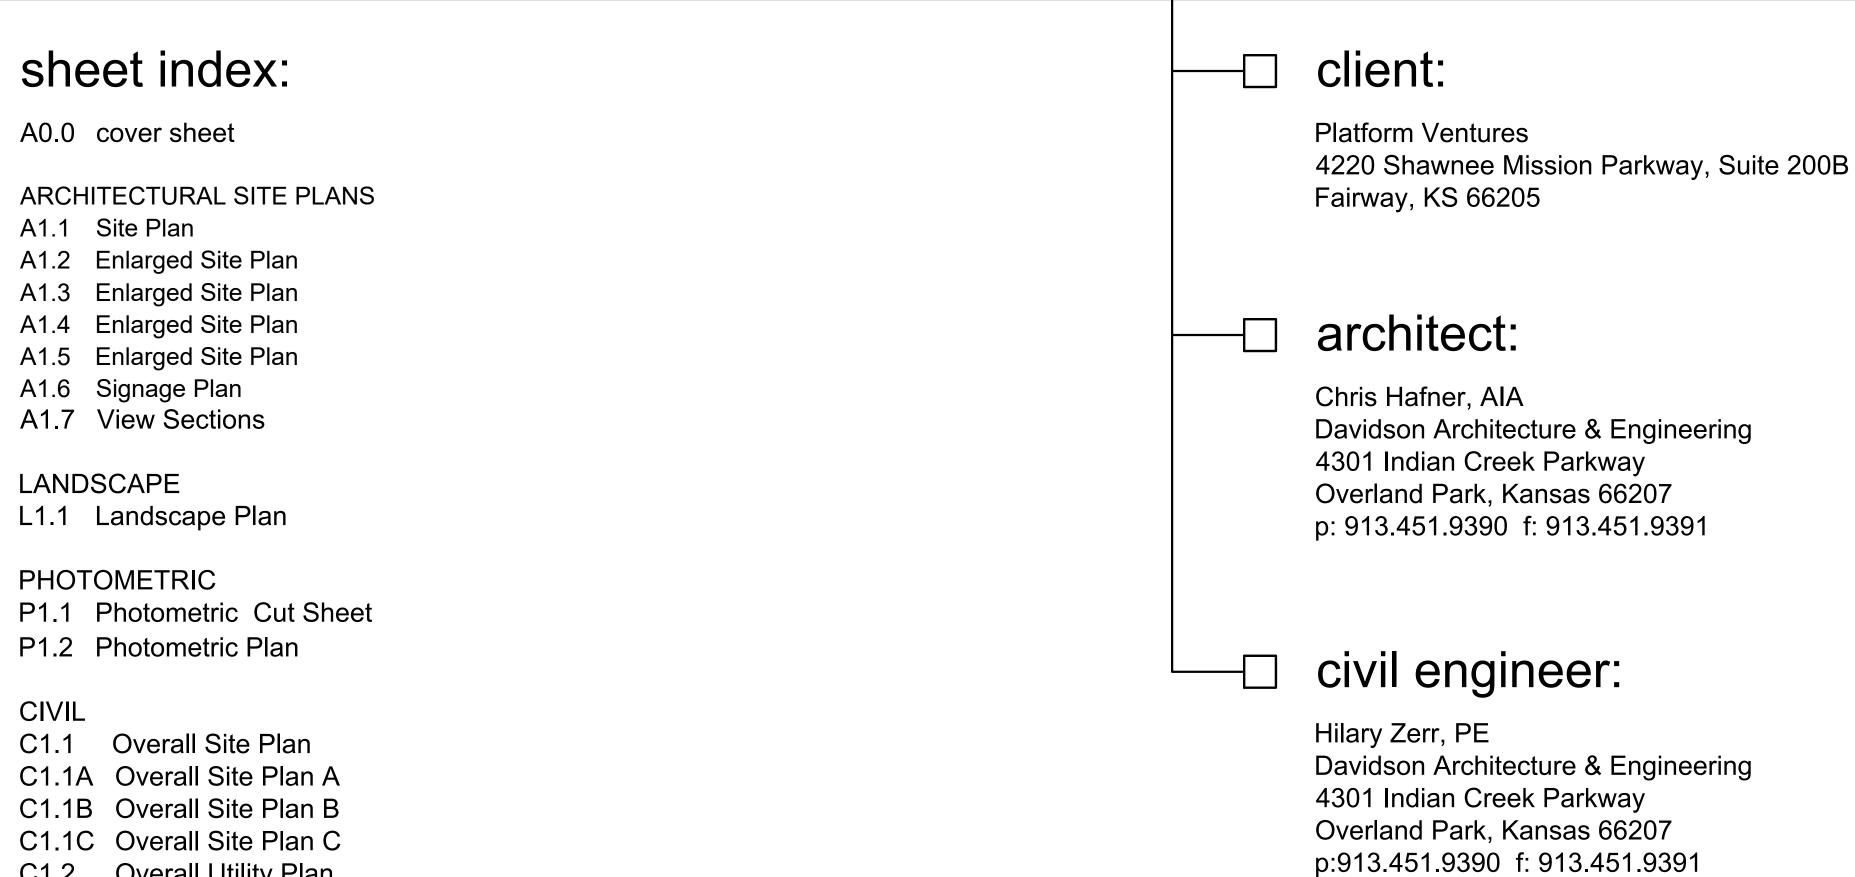


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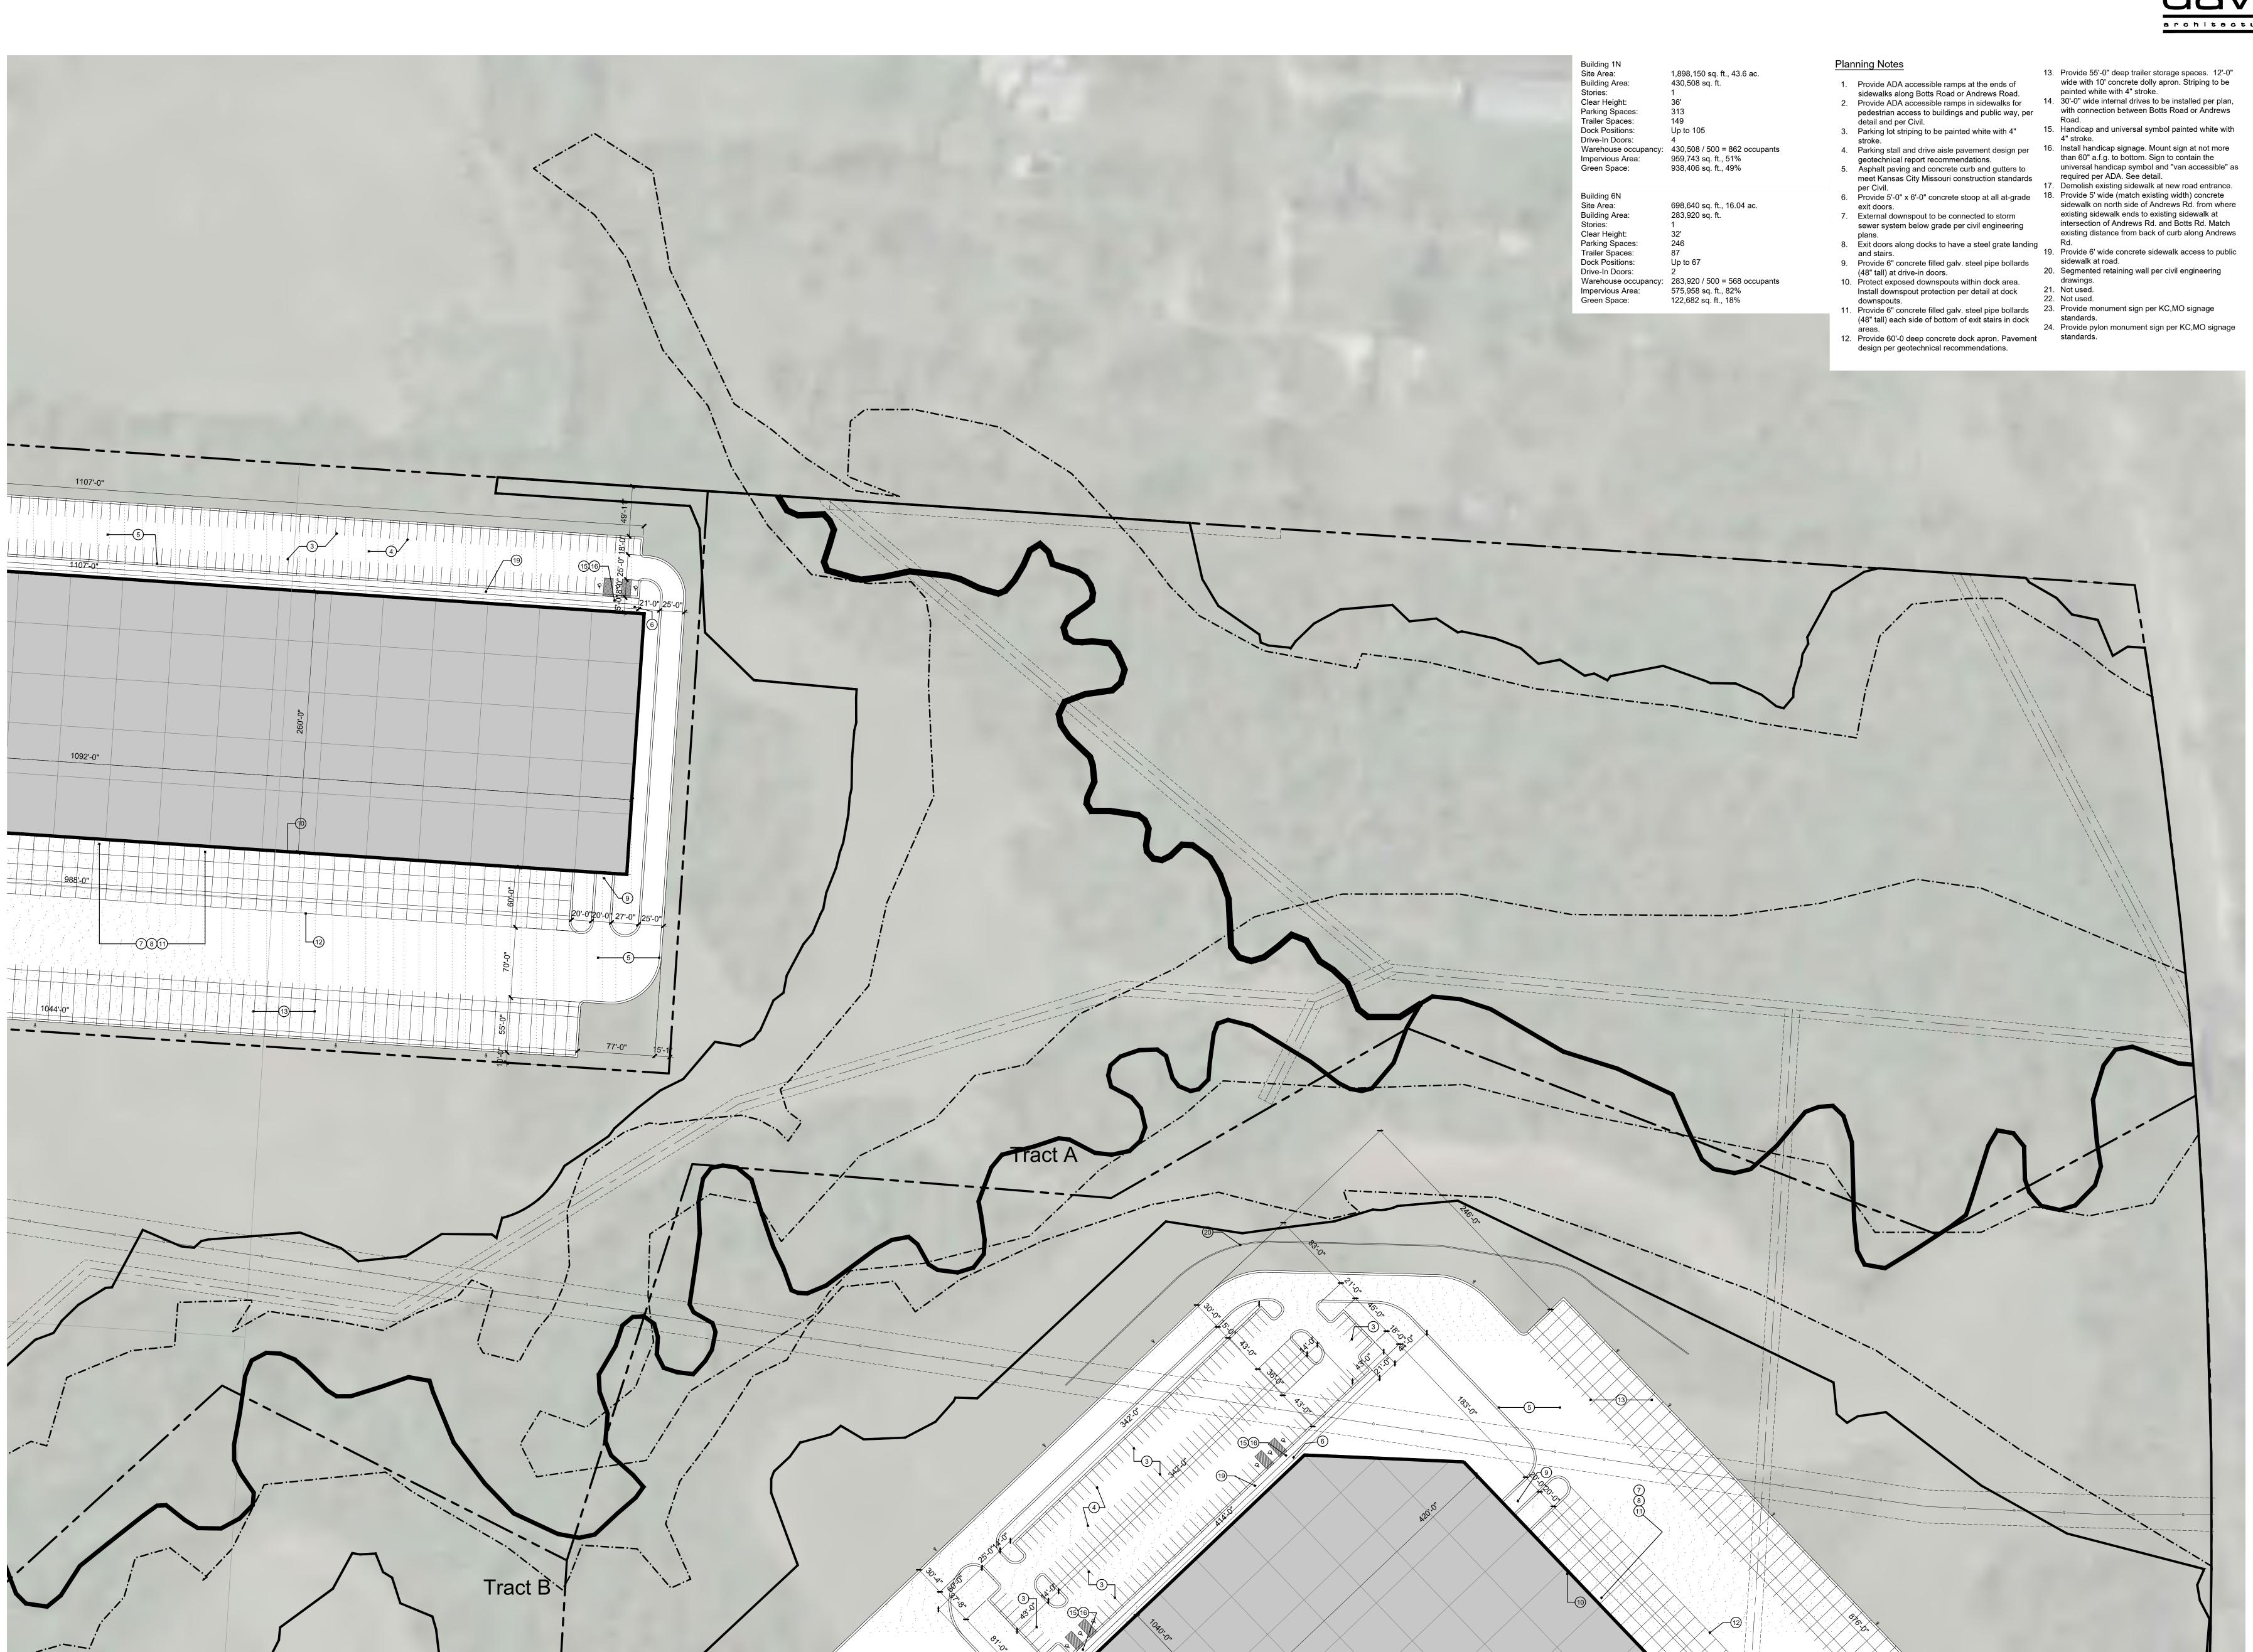





date 09.30.2021



4301 Indian Creek Parkway Overland Park, KS 66207 phone: 913,451.9390 fax: 913,451.9391 www.davidsonae.com

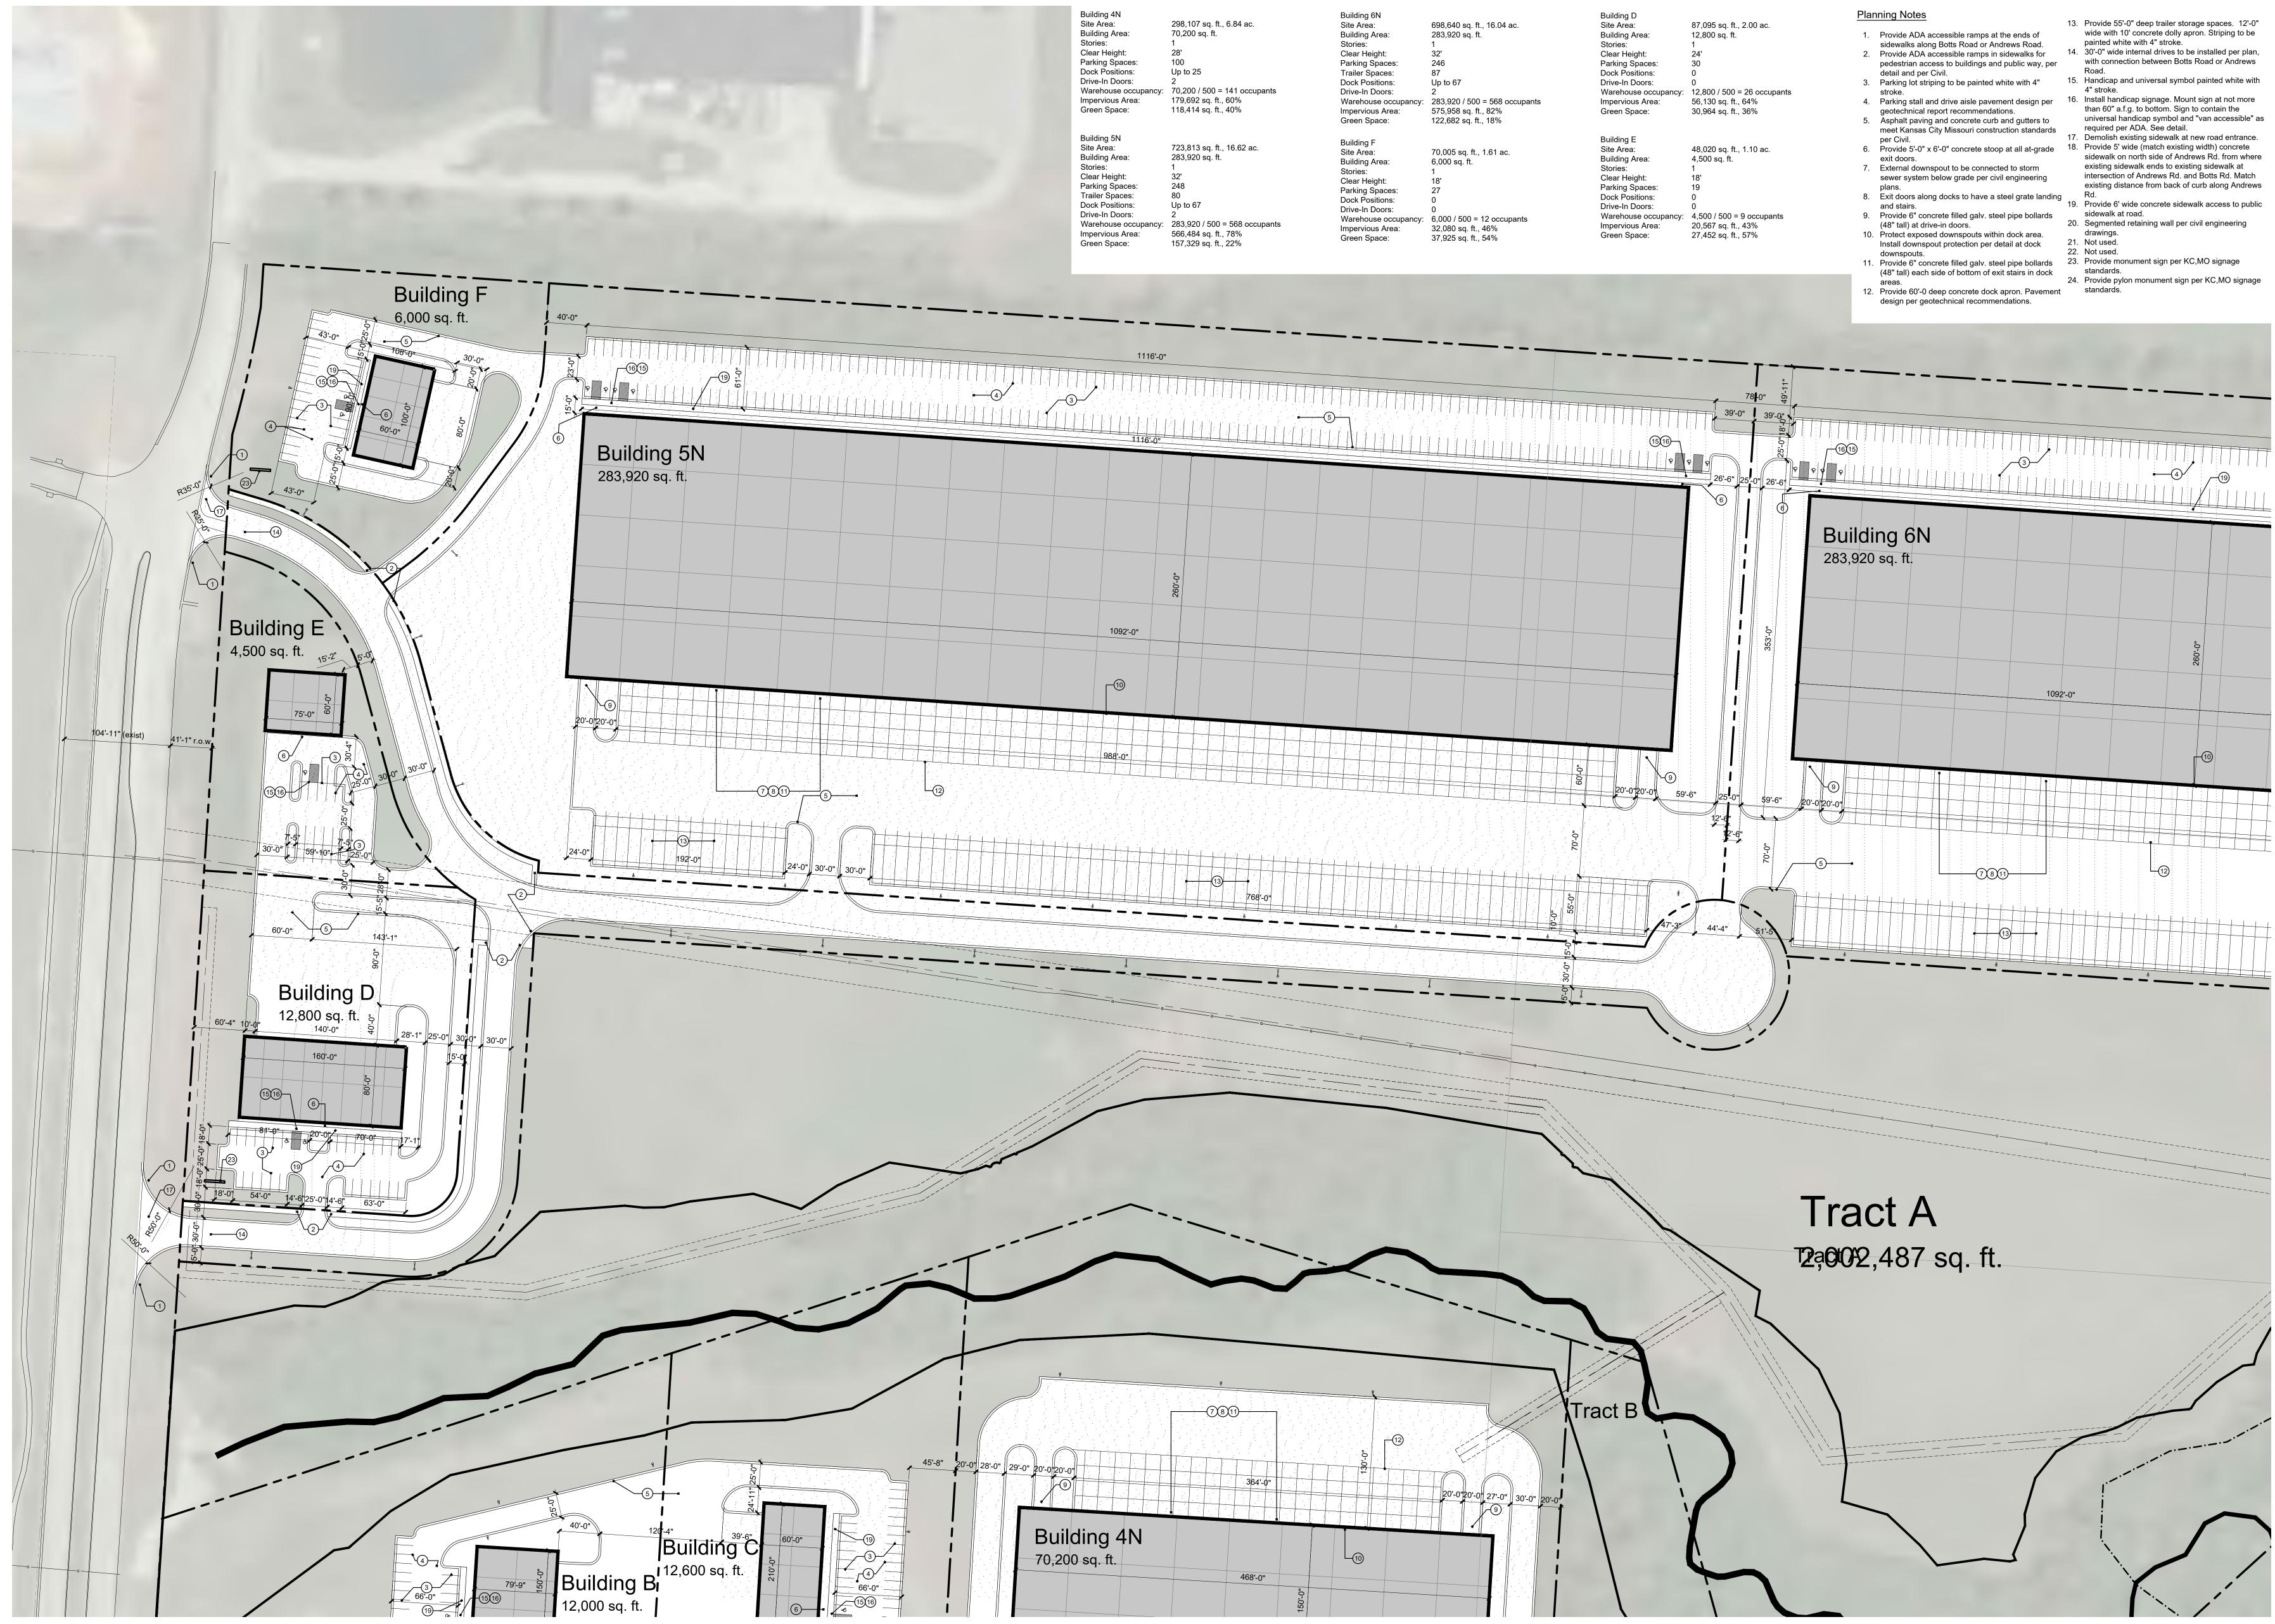

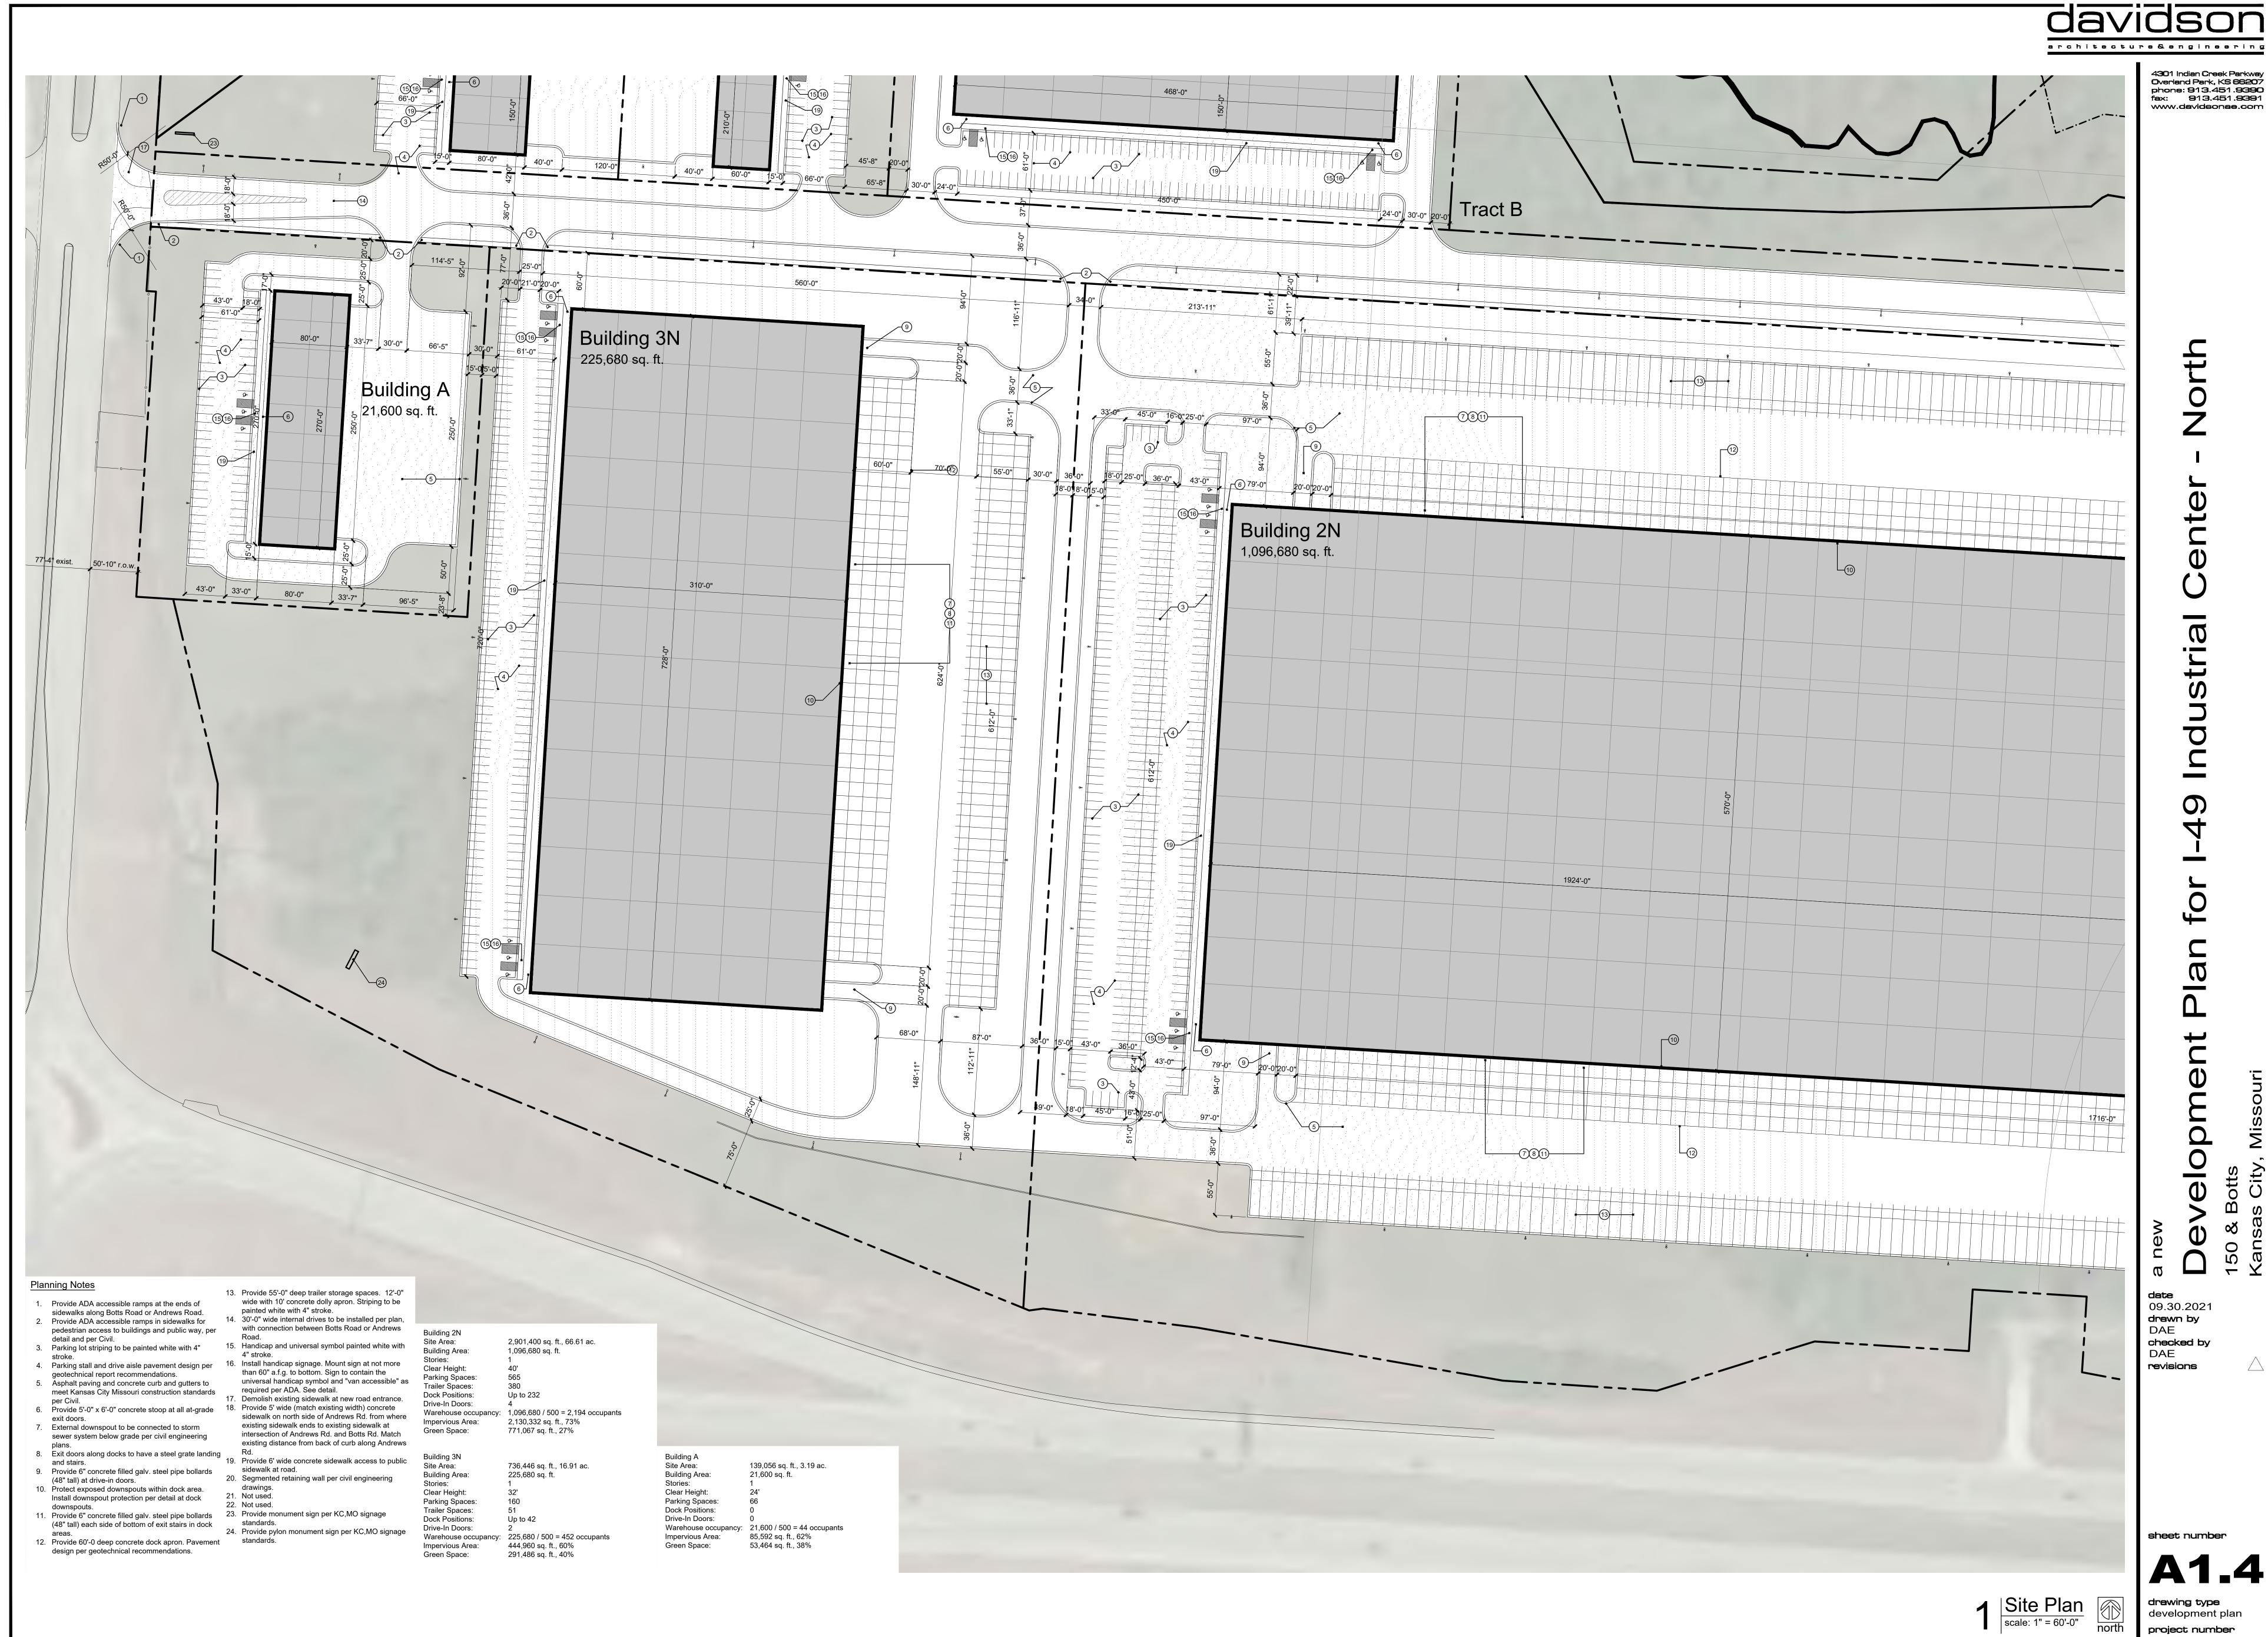

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09.30.2021 checked by

sheet number

75'-0"

1924'-0"

09.30.2021 checked by revisions

sheet number

project number

Building 1N Site Area:

Stories: Clear Height: Parking Spaces: Trailer Spaces: Dock Positions: Drive-In Doors:

Building Area:

Green Space:

Building 2N Site Area:

Building Area:

Trailer Spaces: Dock Positions:

Drive-In Doors:

Green Space:

Planning Notes

detail and per Civil.

1. Provide ADA accessible ramps at the ends of

geotechnical report recommendations.

5. Asphalt paving and concrete curb and gutters to

7. External downspout to be connected to storm sewer system below grade per civil engineering

9. Provide 6" concrete filled galv. steel pipe bollards

Protect exposed downspouts within dock area.
 Install downspout protection per detail at dock

design per geotechnical recommendations.

12. Provide 60'-0 deep concrete dock apron. Pavement standards.

(48" tall) at drive-in doors.

downspouts.

sidewalks along Botts Road or Andrews Road.

pedestrian access to buildings and public way, per

2. Provide ADA accessible ramps in sidewalks for

Impervious Area:

3. Parking lot striping to be painted white with 4"

15. Handicap and universal symbol painted white with

6. Provide 5'-0" x 6'-0" concrete stoop at all at-grade exit doors.

18. Provide 5' wide (match existing width) concrete sidewalk on north side of Andrews Rd. from where

8. Exit doors along docks to have a steel grate landing and stairs.

Rd.

19. Provide 6' wide concrete sidewalk access to public

11. Provide 6" concrete filled galv. steel pipe bollards (48" tall) each side of bottom of exit stairs in dock

sidewalk at road.

21. Not used. 22. Not used.

4. Parking stall and drive aisle pavement design per 16. Install handicap signage. Mount sign at not more

1,898,150 sq. ft., 43.6 ac.

430,508 sq. ft.

938,406 sq. ft., 49%

1,096,680 sq. ft.

2,130,332 sq. ft., 73%

painted white with 4" stroke.

771,067 sq. ft., 27%

13. Provide 55'-0" deep trailer storage spaces. 12'-0" wide with 10' concrete dolly apron. Striping to be

14. 30'-0" wide internal drives to be installed per plan,

than 60" a.f.g. to bottom. Sign to contain the

universal handicap symbol and "van accessible" as required per ADA. See detail.

17. Demolish existing sidewalk at new road entrance.

existing sidewalk ends to existing sidewalk at intersection of Andrews Rd. and Botts Rd. Match

20. Segmented retaining wall per civil engineering

24. Provide pylon monument sign per KC,MO signage

existing distance from back of curb along Andrews

with connection between Botts Road or Andrews


Up to 232

Warehouse occupancy: 1,096,680 / 500 = 2,194 occupants

2,901,400 sq. ft., 66.61 ac.

Warehouse occupancy: 430,508 / 500 = 862 occupants

Impervious Area: 959,743 sq. ft., 51%

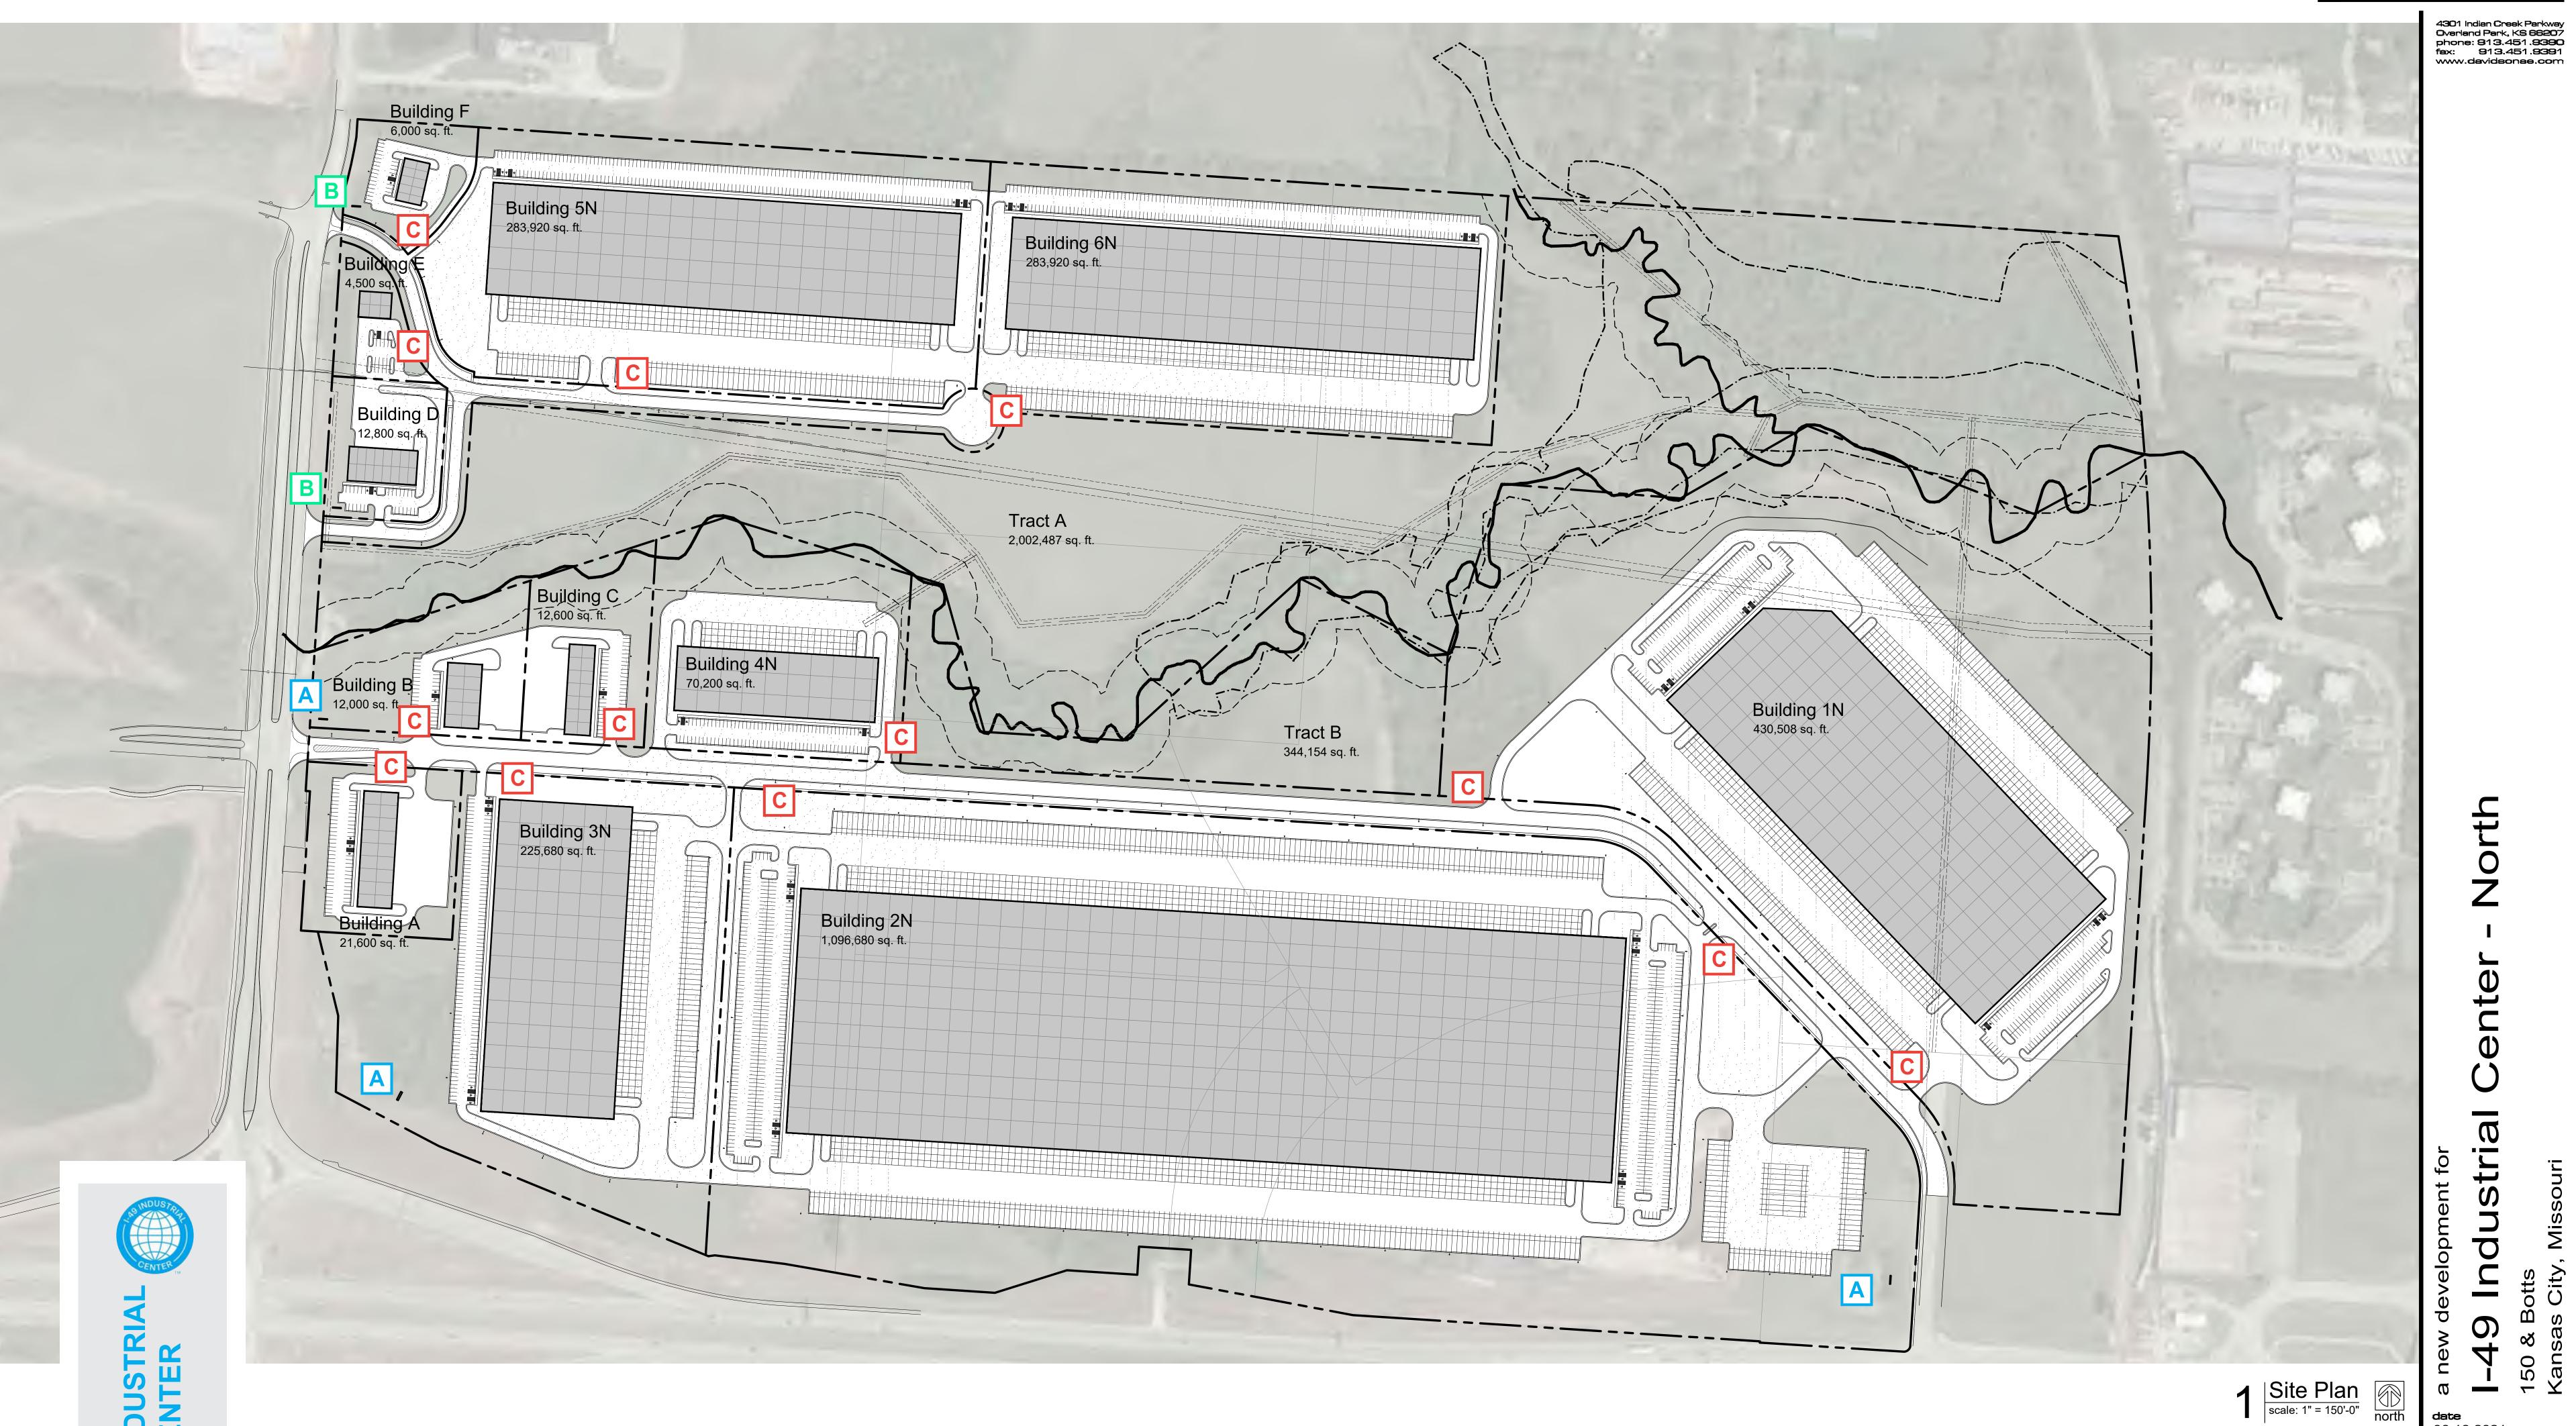

I-49 INDUSTRIAL CENTER

TENANT

Quantity:

Max Area:

Max Height:

Illumination:

Setback:

Individual buildings on parcels w/ 200' of frontage

1 per street frontage

Internal or external

50 sq. ft.

10 ft.

8 ft.

This plan is preliminary. The quantity, location, and design of signs may change

due to factors such as, but not limited to changes in site design, building occu-

pancy, and tenant needs. Signs are designed and placed throughout the devel-

ability to modify sign quantity, location, and design will allow the developer to maintain cohesive wayfinding into the future. All signs shall meet all requirements of section 88-445 Signs of the Kansas City Missouri Development Code

opment to create a consistent visual wayfinding experience for visitors. The

regardless of location or quantity.

TENANT

TENANT

TENANT

TENANT

TYPE A Sign-

Quantity:

Setback:

Max Area:

Max Height:

Illumination:

TYPE B Sign-

Quantity:

Max Area:

Setback:

Max Height:

Illumination:

Oversized Monument Sign

1 per major street frontage

Additional notes: Oversized Monument Sign may be swapped for a

Internal or external

Type C monument sign.

200 sq. ft.

20 ft.

Development District sign

75 sq. ft.

Internal or external

10 ft.


8 ft.

2 per entrance (1 per frontage without entrance)

date 06.18.2021 drawn by DAE checked by DAE revisions

sheet number


drawing type preliminary project number

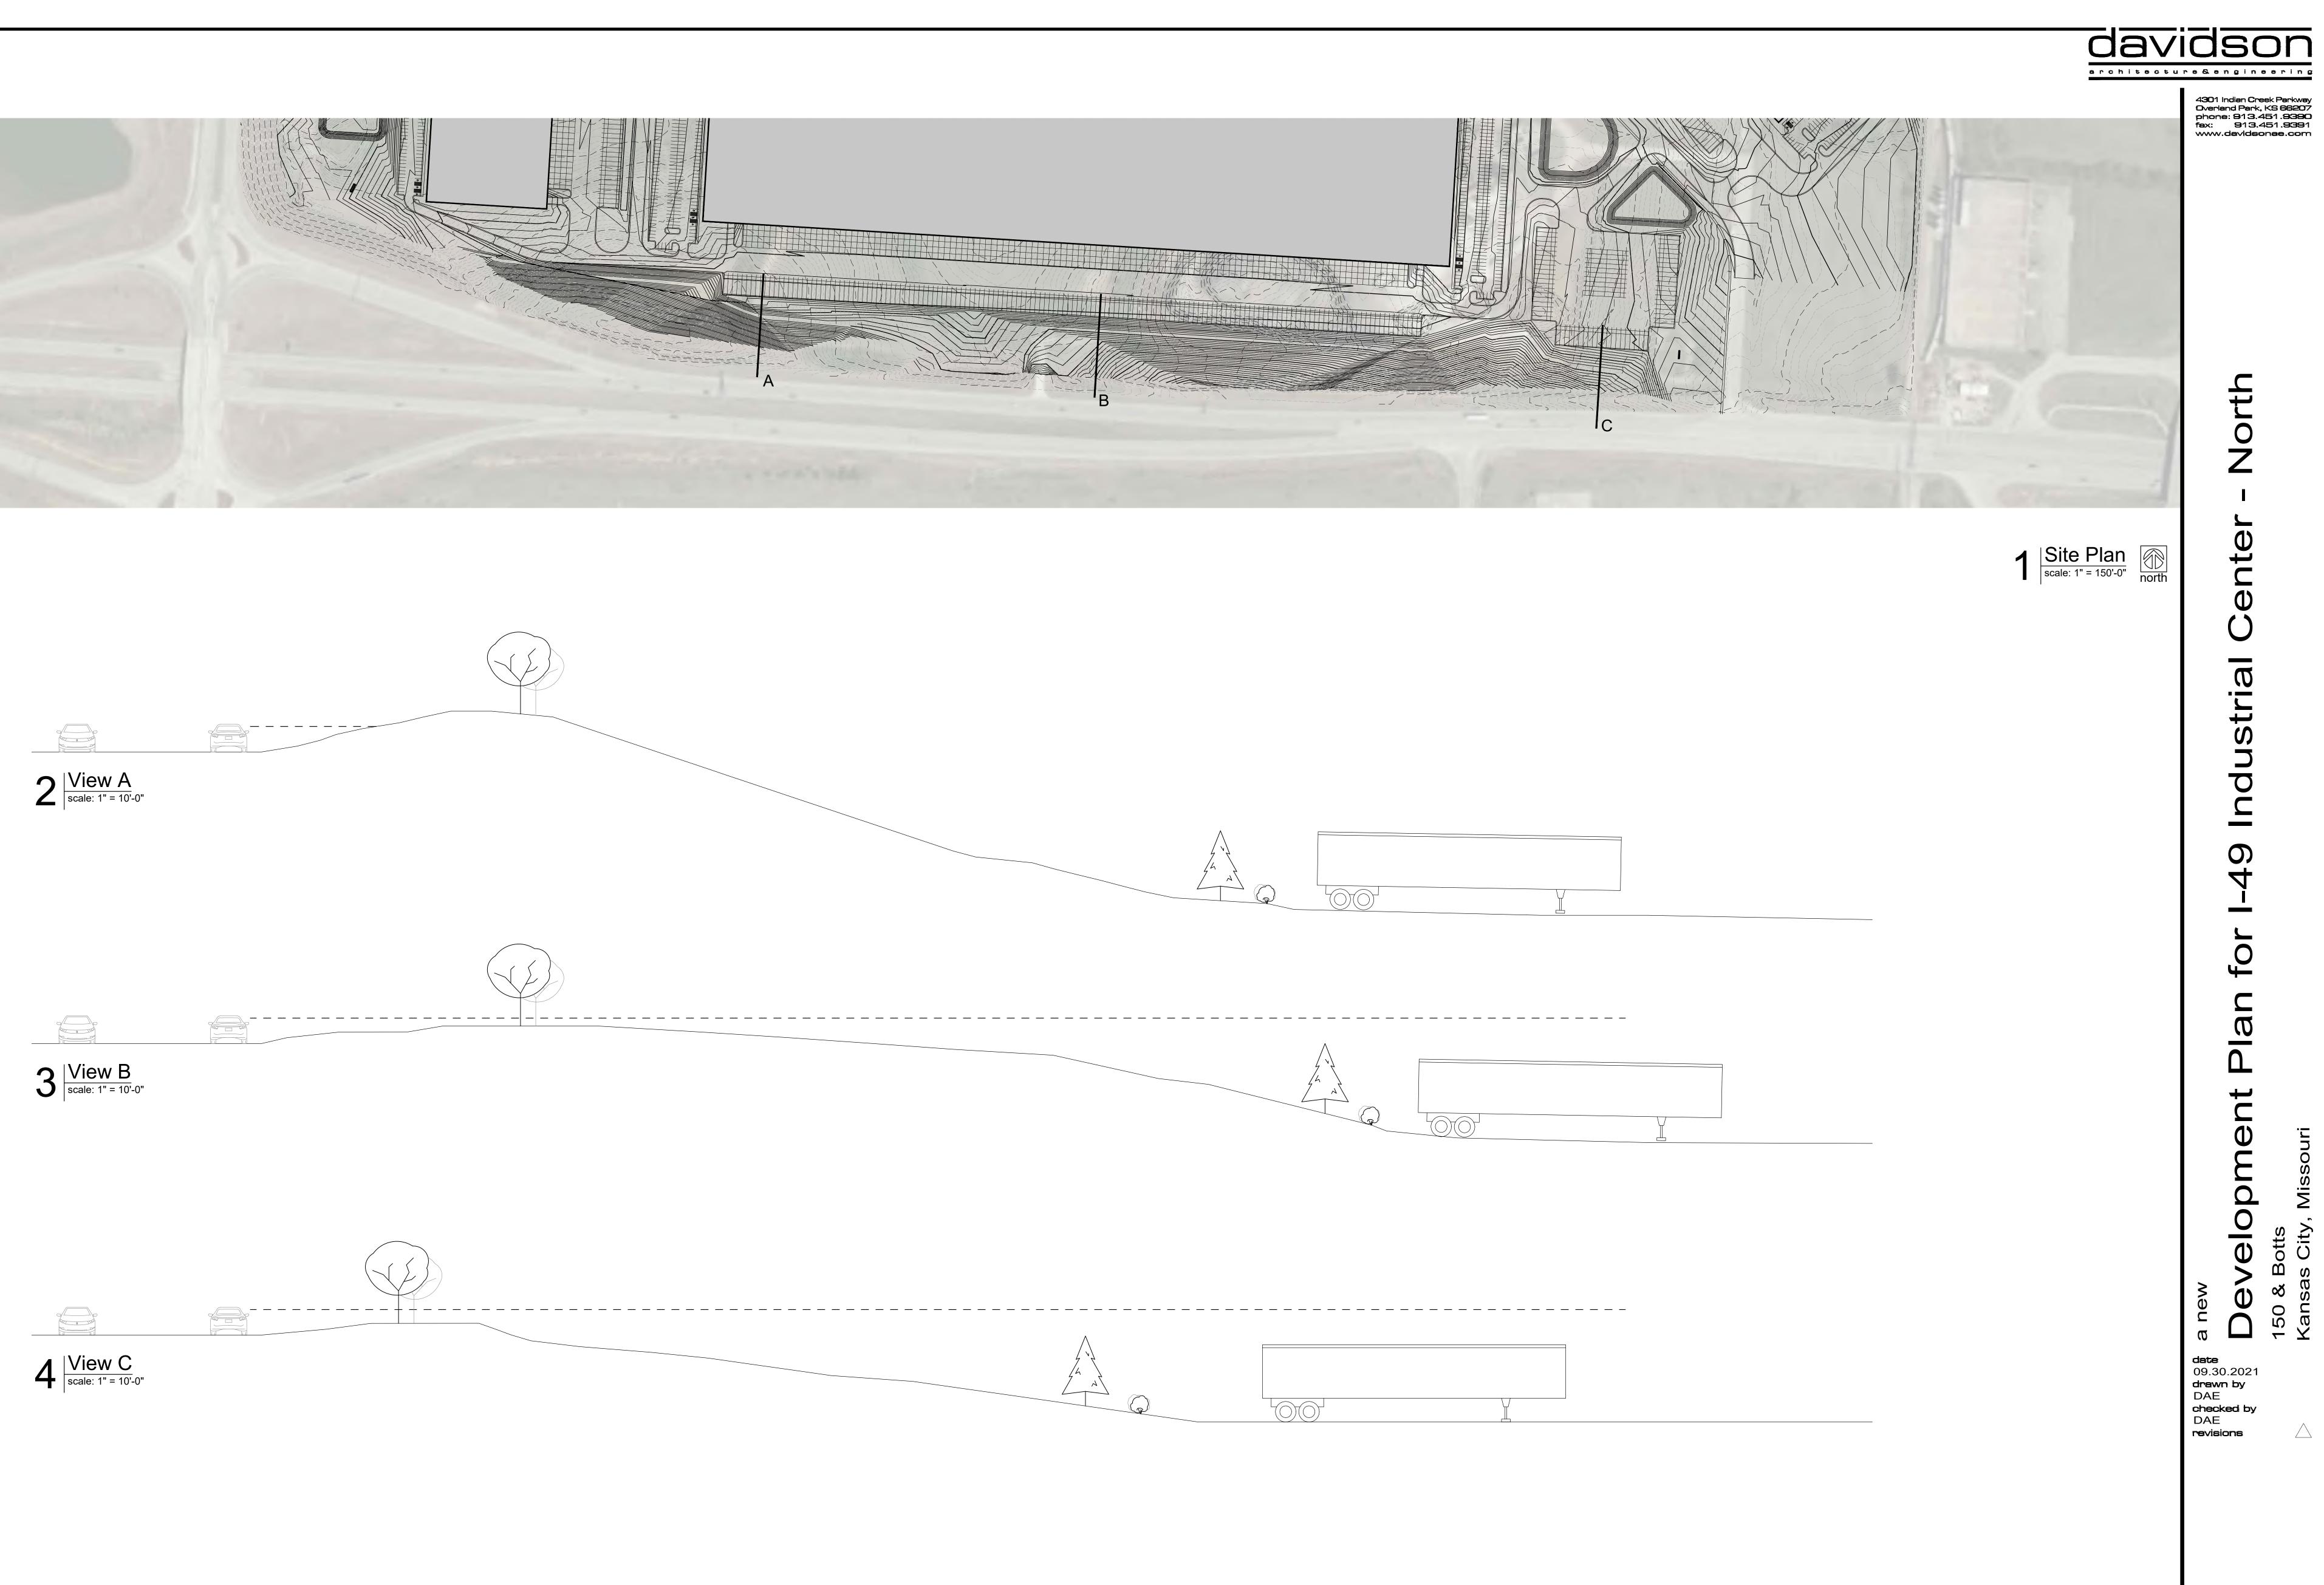

date
09.30.2021
drawn by
DAE
checked by
DAE
revisions

sheet number **drawing type** development plan

project number 19239

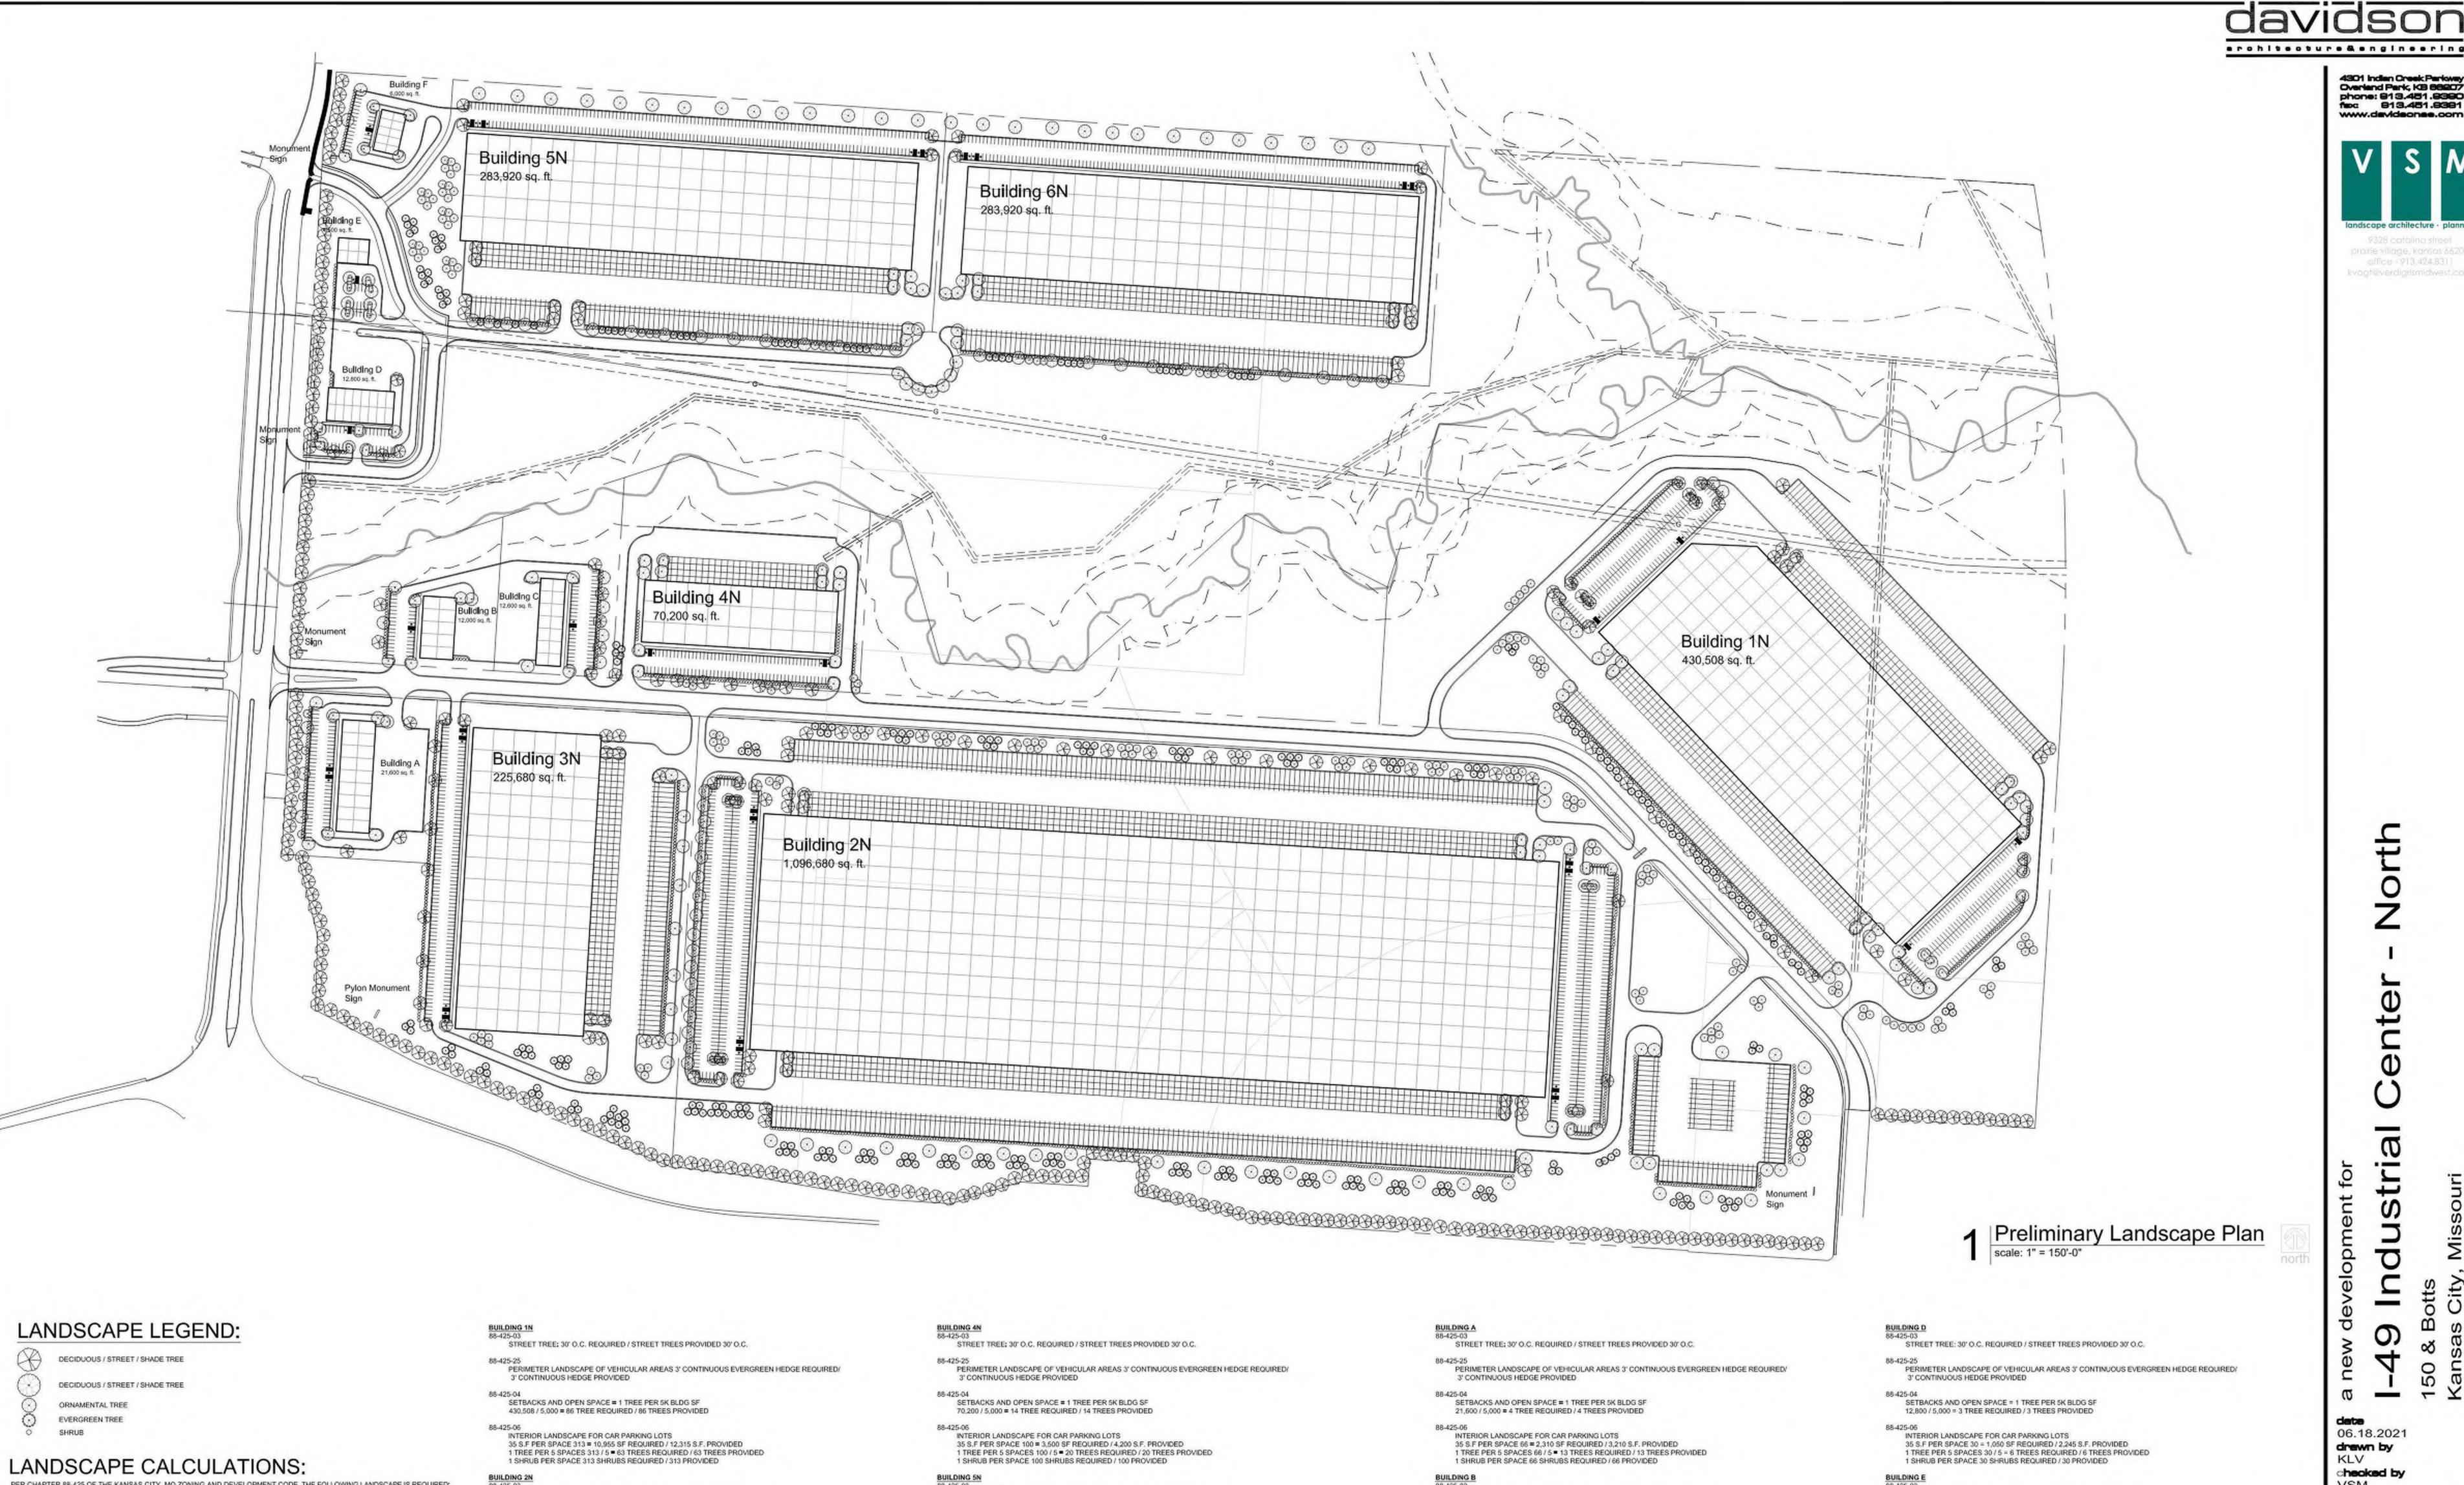

06.18.2021

checked by

drawn by

KLV

VSM

revisions

4301 Indian Creek Parkway Overland Park, KB 68207 phone: 913.451.9390 fax: 913.451.9391 www.davidsonse.com

office = 913,424,8311

STREET TREE: 30' O.C. REQUIRED / STREET TREES PROVIDED 30' O.C.

PERIMETER LANDSCAPE OF VEHICULAR AREAS 3' CONTINUOUS EVERGREEN HEDGE REQUIRED/

88-425-04 SETBACKS AND OPEN SPACE = 1 TREE PER 5K BLDG SF 4,500 / 5,000 = 1 TREE REQUIRED / 1 TREES PROVIDED

88-425-06 INTERIOR LANDSCAPE FOR CAR PARKING LOTS 35 S.F PER SPACE 19 = 665 SF REQUIRED / 1,250 S.F. PROVIDED 1 SHRUB PER SPACE 19 SHRUBS REQUIRED / 25 PROVIDED

1 TREE PER 5 SPACES 19 / 5 = 4 TREES REQUIRED / 4 TREES PROVIDED STREET TREE: 30' O.C. REQUIRED / STREET TREES PROVIDED 30' O.C.

88-425-25
PERIMETER LANDSCAPE OF VEHICULAR AREAS 3' CONTINUOUS EVERGREEN HEDGE REQUIRED/ 3' CONTINUOUS HEDGE PROVIDED

88-425-04 SETBACKS AND OPEN SPACE = 1 TREE PER 5K BLDG SF 6,000 / 5,000 = 1 TREE REQUIRED / 1 TREES PROVIDED

1 SHRUB PER SPACE 27 SHRUBS REQUIRED / 27 PROVIDED

PER CHAPTER 88-425 OF THE KANSAS CITY, MO ZONING AND DEVELOPMENT CODE. THE FOLLOWING LANDSCAPE IS REQUIRED:

PERIMETER LANDSCAPE OF VEHICULAR AREAS 3' CONTINUOUS EVERGREEN HEDGE REQUIRED / 3' CONTINUOUS HEDGE PROVIDED

SETBACKS AND OPEN SPACE ■ 1 TREE PER 5K BLDG SF

88-425-06 INTERIOR LANDSCAPE FOR CAR PARKING LOTS 35 S.F PER SPACE 1 TREE PER 5 SPACES 1 SHRUB PER SPACE

CITY LANDSCAPE REQUIREMENT:

STREET TREE; 30' O.C. REQUIRED / STREET TREES PROVIDED 30' O.C.

PERIMETER LANDSCAPE OF VEHICULAR AREAS 3' CONTINUOUS EVERGREEN HEDGE REQUIRED/

SETBACKS AND OPEN SPACE . 1 TREE PER 5K BLDG SF 1,096,680 / 5,000 = 219 TREE REQUIRED / 237 TREES PROVIDED

88-425-05 INTERIOR LANDSCAPE FOR CAR PARKING LOTS 35 S.F PER SPACE 565 = 19,775 SF REQUIRED / 23,256 S.F. PROVIDED 1 TREE PER 5 SPACES 565 / 5 = 113 TREES REQUIRED / 113 TREES PROVIDED 1 SHRUB PER SPACE 565 SHRUBS REQUIRED / 630 PROVIDED

STREET TREE: 30' O.C. REQUIRED / STREET TREES PROVIDED 30' O.C.

PERIMETER LANDSCAPE OF VEHICULAR AREAS 3' CONTINUOUS EVERGREEN HEDGE REQUIRED/ 3" CONTINUOUS HEDGE PROVIDED

88-425-04 SETBACKS AND OPEN SPACE = 1 TREE PER 5K BLDG SF 225,680 / 5,000 = 45 TREE REQUIRED / 45 TREES PROVIDED

88-425-05 INTERIOR LANDSCAPE FOR CAR PARKING LOTS 35 S.F PER SPACE 160 = 5,600 SF REQUIRED / 6,300 S.F. PROVIDED 1 TREE PER 5 SPACES 160 / 5 = 32 TREES REQUIRED / 32 TREES PROVIDED 1 SHRUB PER SPACE 160 SHRUBS REQUIRED / 214 PROVIDED

STREET TREE; 30' O.C. REQUIRED / STREET TREES PROVIDED 30' O.C.

PERIMETER LANDSCAPE OF VEHICULAR AREAS 3' CONTINUOUS EVERGREEN HEDGE REQUIRED/ 88-425-04

SETBACKS AND OPEN SPACE . 1 TREE PER 5K BLDG SF 283,920 / 5,000 = 57 TREE REQUIRED / 57 TREES PROVIDED

88-425-06 INTERIOR LANDSCAPE FOR CAR PARKING LOTS 35 S.F PER SPACE 248 = 8,680 SF REQUIRED / 9,265 S.F. PROVIDED 1 TREE PER 5 SPACES 248 / 5 = 50 TREES REQUIRED / 50 TREES PROVIDED 1 SHRUB PER SPACE 248 SHRUBS REQUIRED / 250 PROVIDED

BUILDING 6N STREET TREE: 30' O.C. REQUIRED / STREET TREES PROVIDED 30' O.C.

PERIMETER LANDSCAPE OF VEHICULAR AREAS 3' CONTINUOUS EVERGREEN HEDGE REQUIRED/ 3' CONTINUOUS HEDGE PROVIDED

88-425-04 SETBACKS AND OPEN SPACE * 1 TREE PER 5K BLDG SF 283,920 / 5,000 = 57 TREE REQUIRED / 57 TREES PROVIDED

INTERIOR LANDSCAPE FOR CAR PARKING LOTS 35 S.F PER SPACE 246 = 8,610 SF REQUIRED / 9,235 S.F. PROVIDED 1 TREE PER 5 SPACES 246 / 5 = 50 TREES REQUIRED / 50 TREES PROVIDED 1 SHRUB PER SPACE 246 SHRUBS REQUIRED / 246 PROVIDED

STREET TREE; 30' O.C. REQUIRED / STREET TREES PROVIDED 30' O.C. PERIMETER LANDSCAPE OF VEHICULAR AREAS 3' CONTINUOUS EVERGREEN HEDGE REQUIRED/

SETBACKS AND OPEN SPACE = 1 TREE PER 5K BLDG SF 12,000 / 5,000 = 2 TREE REQUIRED / 2 TREES PROVIDED

88-425-06 INTERIOR LANDSCAPE FOR CAR PARKING LOTS 35 S.F PER SPACE 33 = 1,155 SF REQUIRED / 2,125 S.F. PROVIDED 1 TREE PER 5 SPACES 33 / 5 = 7 TREES REQUIRED / 7 TREES PROVIDED 1 SHRUB PER SPACE 33 SHRUBS REQUIRED / 33 PROVIDED

STREET TREE: 30' O.C. REQUIRED / STREET TREES PROVIDED 30' O.C. 88-425-25
PERIMETER LANDSCAPE OF VEHICULAR AREAS 3' CONTINUOUS EVERGREEN HEDGE REQUIRED/

3' CONTINUOUS HEDGE PROVIDED 88-425-04 SETBACKS AND OPEN SPACE = 1 TREE PER 5K BLDG SF 12,600 / 5,000 = 3 TREE REQUIRED / 3 TREES PROVIDED

88-425-06 INTERIOR LANDSCAPE FOR CAR PARKING LOTS 35 S.F PER SPACE 50 = 1,750 SF REQUIRED / 2,225 S.F. PROVIDED 1 TREE PER 5 SPACES 50 / 5 = 10 TREES REQUIRED / 10 TREES PROVIDED 1 SHRUB PER SPACE 50 SHRUBS REQUIRED / 50 PROVIDED

88-425-05 INTERIOR LANDSCAPE FOR CAR PARKING LOTS 35 S.F PER SPACE 27 = 945 SF REQUIRED / 1,650 S.F. PROVIDED 1 TREE PER 5 SPACES 27 / 5 = 6 TREES REQUIRED / 6 TREES PROVIDED

eheet number drawing type preliminary project number

Luminaire So	chedule							
Symbol	Qty	Label	Arrangement	Total Lamp LumensLF	Description	Tag Lum. Watts	Total Watts	BUG Rating
→	149	RSXF2_LED_P6_40K_AWFDBV	SINGLE	N.A. 0.950	BUILDING WALL MOUNT LITHONIA RSXF2 LED P6 40K AWFD BV FLOOD	F 246.6347	36748.57	B4-U3-G2
<u></u>	103	RSX2_LED_P6_40K_R4	SINGLE	N.A. 0.950	AREA LIGHT LITHONIA RSX2 LED P6 40K R4	AP 246.63	25402.89	B3-U0-G4
—— <u>-</u>	48	RLX-1_T3_15L_4K	SINGLE	N.A. 0.950	ROADWAY VISIONAIRE RLX-1-T3-15L-4K-UNV	R3 114	5472	B3-U0-G3
	15	RSX2_LED_P6_40K_R5_1	BACK-BACK	N.A. 0.950	AREA TWIN HEAD RSX2 LED P6 40K R5	A5-2 246.63	7398.9	B5-U0-G4
	14	DSXW1_LED_20C_1000_40K_TFTM_M	SINGLE	N.A. 0.950	WALL MOUNT DSXW1 LED 20C 1000 40K TFTM MVOLT	W1 73.2	1024.8	B1-U0-G2
─ →	9	RSXF2_LED_P6_40K_AWFDFV_2	SINGLE	N.A. 0.950	FLOOD ON POLE RSXF2 LED P6 40K AWFD FV	A4F 246.6347	2219.712	B4-U2-G2



Numeric Summary	0.1.	11.4	A	N 4	N 4"	A /2 4:	N 4 / 1 4:
Label	CalcType	Units	Avg	Max	Min	Avg/Min	Max/Min
BLDG 2N AND 3N DRIVE	Illuminance	Fc	1.14	5.5	0.5	2.28	11.00
BLDG 3N DRIVELANE	Illuminance	Fc	1.36	3.7	0.4	3.40	9.25
BLDG 4N DRIVELANE	Illuminance	Fc	2.40	14.9	0.6	4.00	24.83
BLDG 5N AND 6N CENTER LANE	Illuminance	Fc	1.63	3.8	0.3	5.43	12.67
BLDG 5N DRIVELANE	Illuminance	Fc	1.39	3.7	0.9	1.54	4.11
BLDG 6N DRIVELANE	Illuminance	Fc	1.32	13.1	0.5	2.64	26.20
BUILDING 1 ROADWAY AND DRIVELANE	Illuminance	Fc	1.67	6.1	0.4	4.18	15.25
BUILDING 1N N EAST TRUCK DOCKS	Illuminance	Fc	2.27	5.7	0.5	4.54	11.40
BUILDING 1N N EAST TRUCK PARKIN	Illuminance	Fc	2.63	6.9	0.8	3.29	8.63
BUILDING 1N NORTH CAR PKG	Illuminance	Fc	1.86	5.5	0.6	3.10	9.17
BUILDING 1N S WEST TRAILER PARKI	Illuminance	Fc	2.50	6.7	1.2	2.08	5.58
BUILDING 1N S WEST TRUCK DOCKS	Illuminance	Fc	2.26	5.8	0.5	4.52	11.60
BUILDING 1N SOUTH CAR PKG	Illuminance	Fc	2.23	17.9	0.7	3.19	25.57
BUILDING 2 ROADWAY AND DRIVELANE	Illuminance	Fc	1.34	6.0	0.4	3.35	15.00
BUILDING 2N EAST CAR PKG	Illuminance	Fc	2.72	13.5	0.3	9.07	45.00
BUILDING 2N N TRAILER DOCKS	Illuminance	Fc	2.55	8.4	0.4	6.38	21.00
BUILDING 2N N TRAILER PARKING	Illuminance	Fc	2.22	6.8	1.2	1.85	5.67
BUILDING 2N SOUTH TRAILER DOCKS	Illuminance	Fc	2.56	7.7	0.5	5.12	15.40
BUILDING 2N SOUTH TRAILER PARKIN	Illuminance	Fc	2.35	6.3	1.0	2.35	6.30
BUILDING 2N WEST CAR PKG	Illuminance	Fc	2.53	12.9	0.5	5.06	25.80
BUILDING 3N TRAILER DOCKS	Illuminance	Fc	2.62	8.0	0.5	5.24	16.00
BUILDING 3N TRAILER PKG	Illuminance	Fc	2.36	6.5	1.3	1.82	5.00
BUILDING 3N WEST CAR PKG	Illuminance	Fc	1.63	6.5	0.5	3.26	13.00
BUILDING 4N N TRAILER DOCKS	Illuminance	Fc	3.76	11.1	0.6	6.27	18.50
BUILDING 4N SOUTH CAR PKG	Illuminance	Fc	2.02	6.6	0.8	2.53	8.25
BUILDING 5N N CAR PKG	Illuminance	Fc	3.12	13.6	0.5	6.24	27.20
BUILDING 5N S TRAILER DOCKS	Illuminance	Fc	2.58	8.4	0.5	5.16	16.80
BUILDING 5N S TRAILER PKG	Illuminance	Fc	2.40	6.5	1.2	2.00	5.42
BUILDING 6N N CAR PKG	Illuminance	Fc	3.20	12.3	0.6	5.33	20.50
BUILDING 6N S TRAILER DOCKS	Illuminance	Fc	2.54	8.6	0.2	12.70	43.00
BUILDING 6N S TRAILER PKG	Illuminance	Fc	2.24	6.3	0.8	2.80	7.88
BUILDING A	Illuminance	Fc	1.74	6.4	0.5	3.48	12.80
BUILDING B	Illuminance	Fc	1.89	6.9	0.5	3.78	13.80
BUILDING C	Illuminance	Fc	1.71	6.2	0.5	3.42	12.40
BUILDING D	Illuminance	Fc	2.13	6.6	0.7	3.04	9.43
BUILDING E	Illuminance	Fc	1.96	3.6	0.7	3.92	7.20
BUILDING F	Illuminance	Fc	1.83	6.0	0.5	3.66	12.00
NORTH ROADWAY ARTERY	Illuminance	Fc	1.74	3.6	0.3	5.80	12.00
PROPERTY LINE	Illuminance	Fc	0.07	0.5	0.0	N.A.	N.A.
ROADWAY ARTERY EAST TO WEST	Illuminance	Fc	1.58	6.2	0.0	3.95	15.50
SATTELITE PARKING ROADWAY	Illuminance	Fc	1.83	6.3	0.4	3.05	10.50
SOUTH EAST SATTELITE TRAILER PKG	Illuminance	Fc	1.83	6.1	0.0	6.57	20.33


30FT MOUNTING HEIGHT ON ALL FIXTURES. ALL POLE MOUNTS ARE FULL CUTOFF LUMINAIRES. ROADWAY LUMINAIRES TYPE R3, HAVE 5 FT MAST ARMS.




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149 INDUSTRIAL- SITE 2- NORTH PREMIER LIGHTING

Page 1 of 2



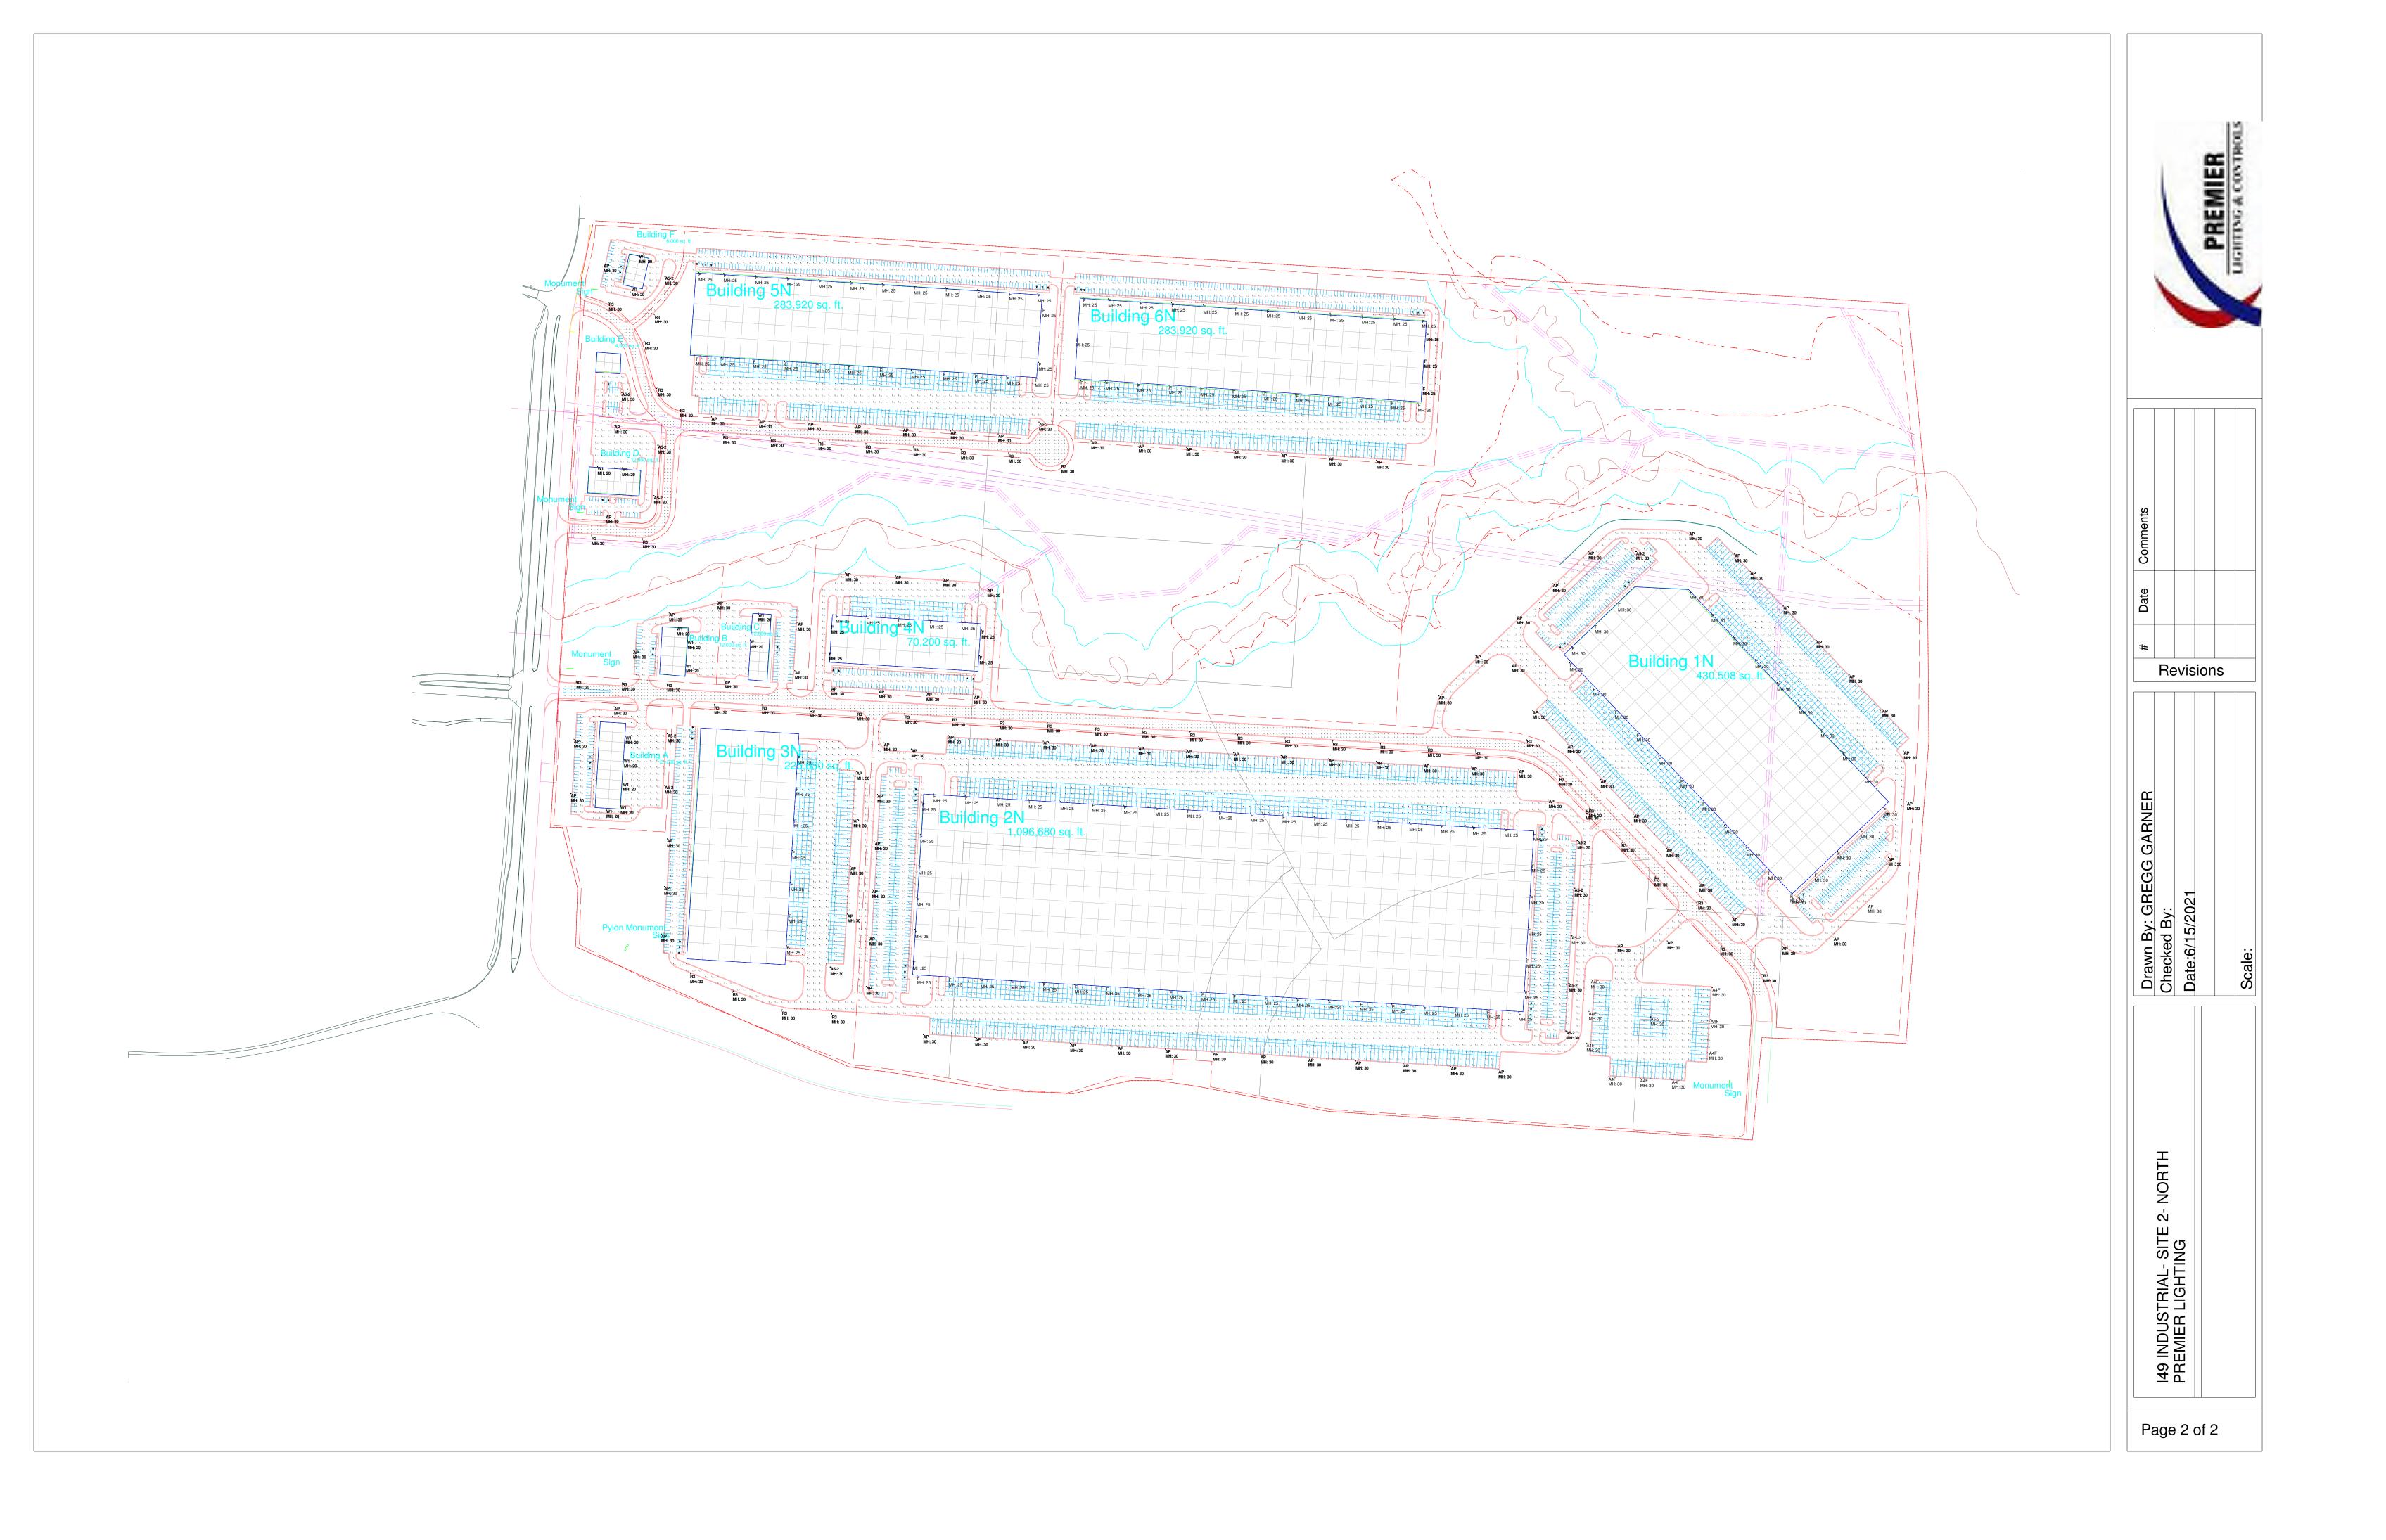

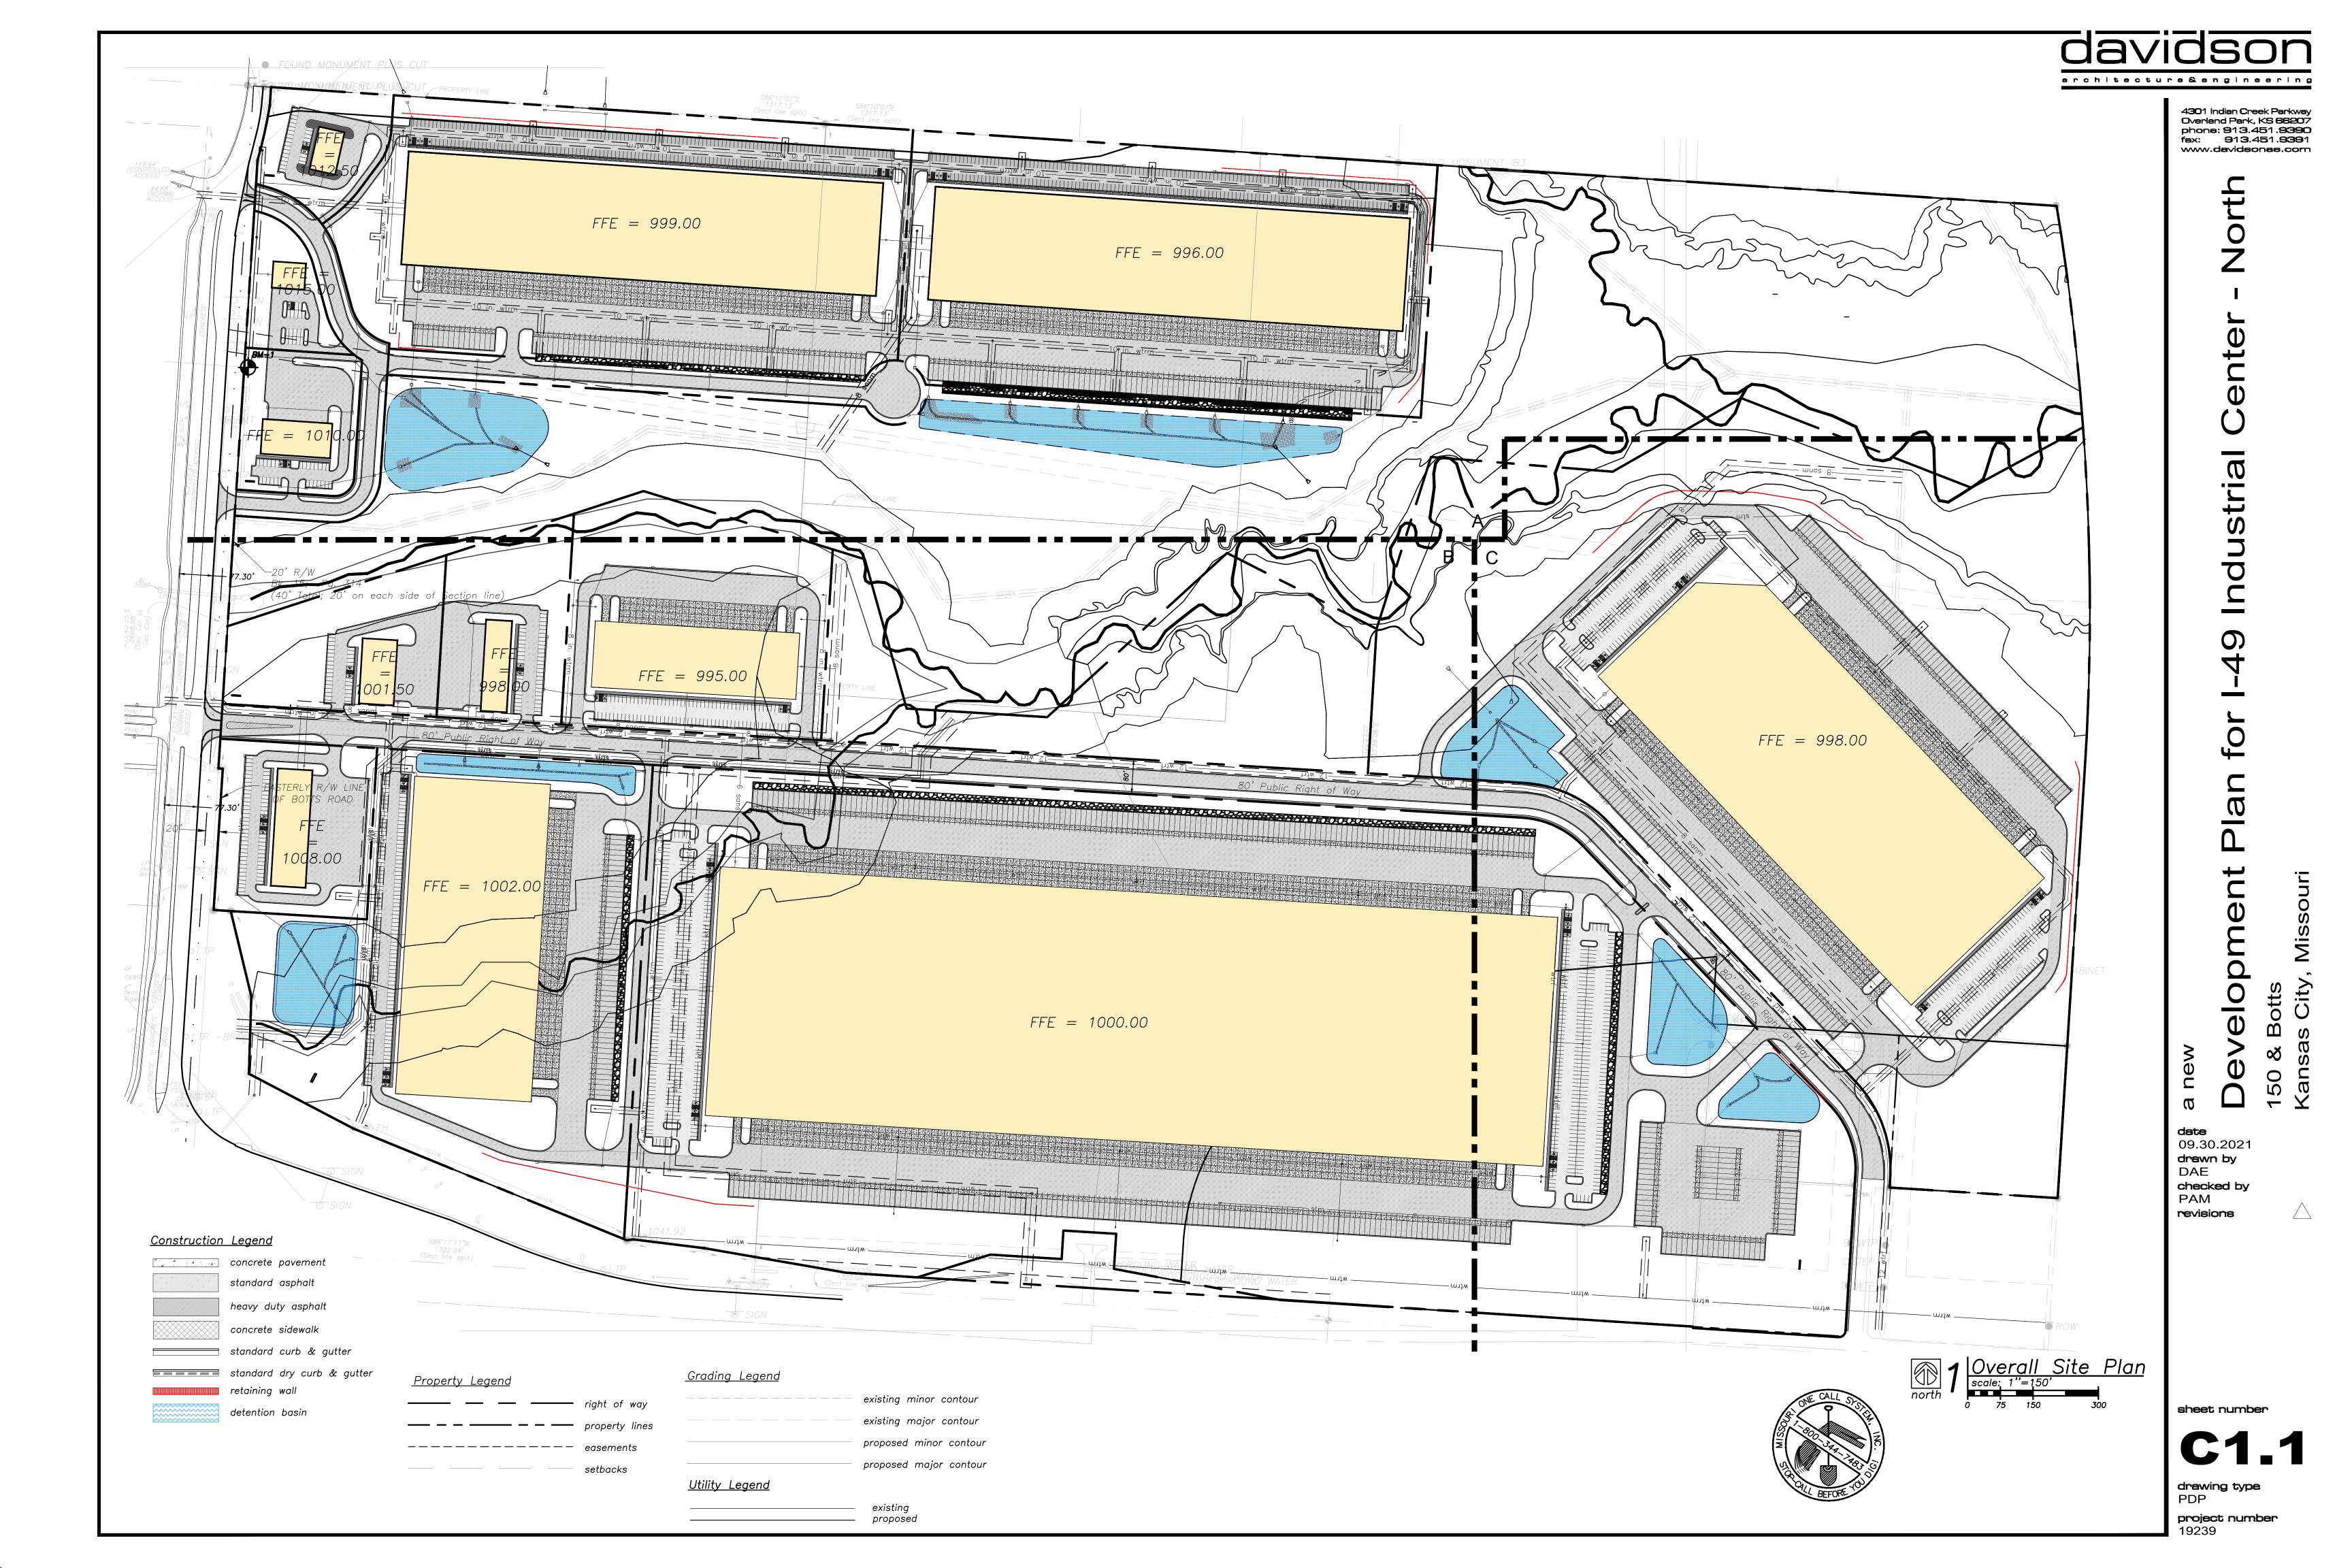architecture & engineering


4301 Indian Creek Parkway Overland Park, KS 66207 phone: 913.451.9390 fax: 913.451.9391 www.davidsonae.com

dete 09.30.2021


drawn by DAE checked by PAM revisions

sheet number

drawing type PDP project number 19239

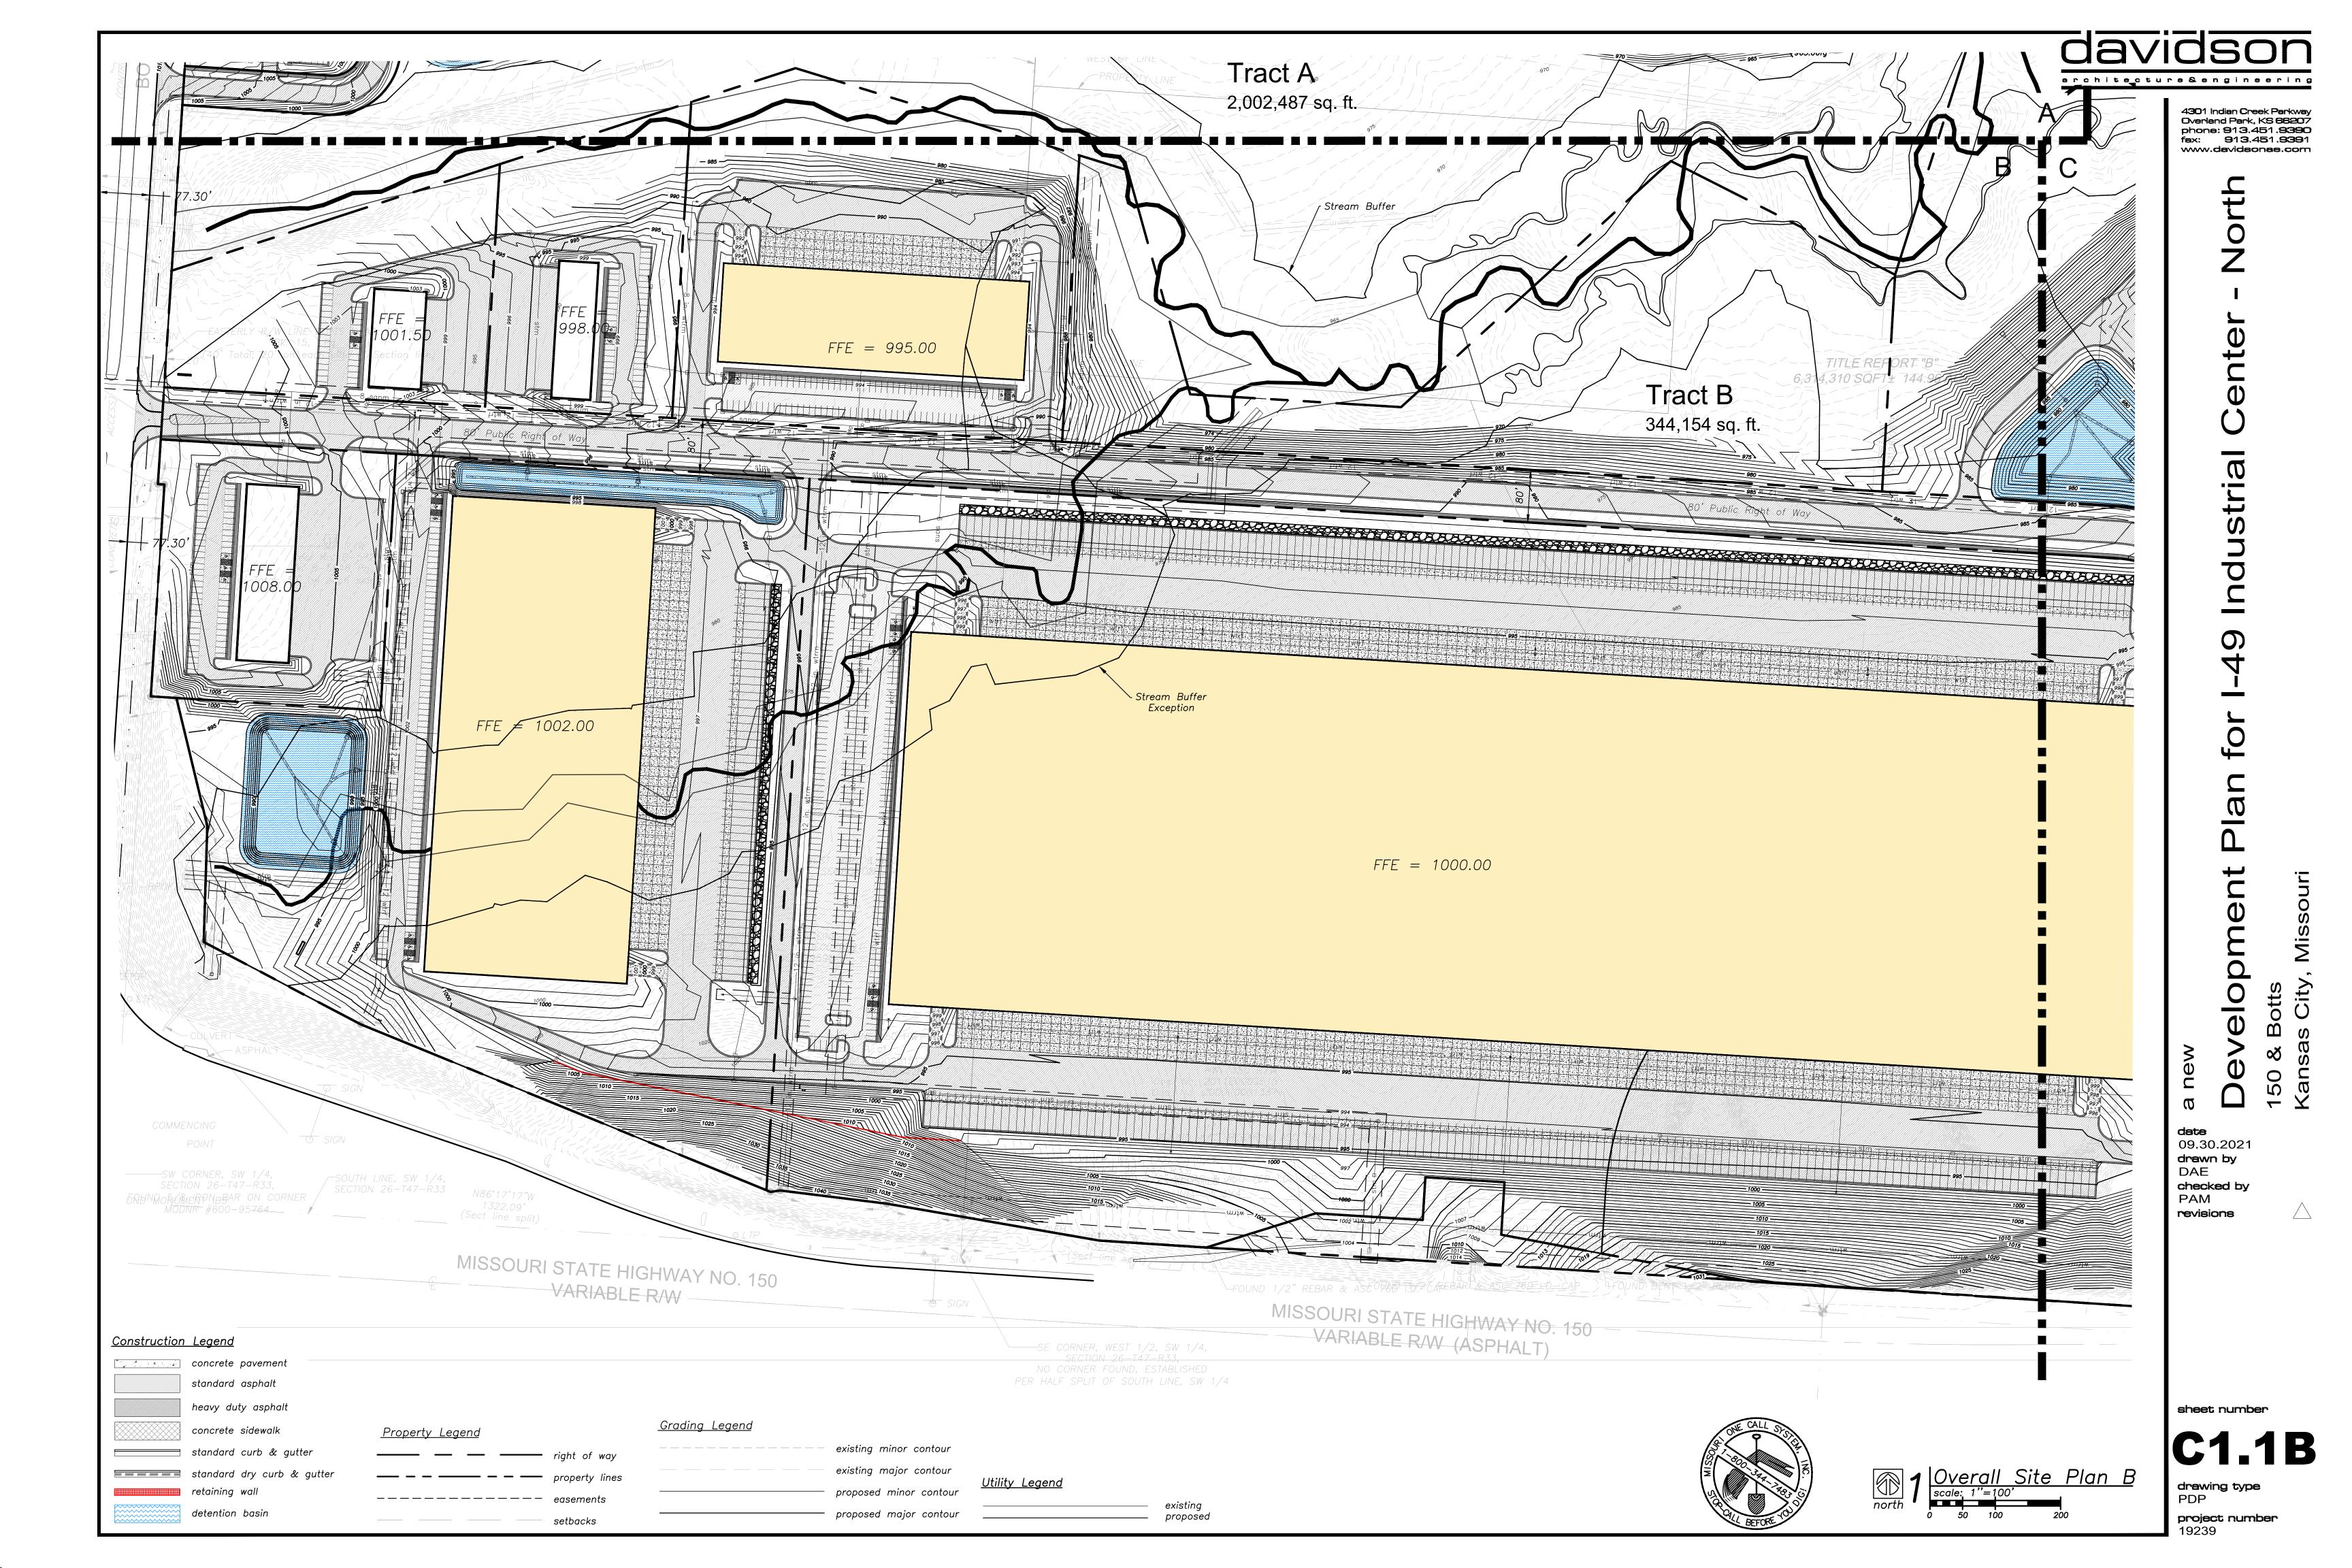



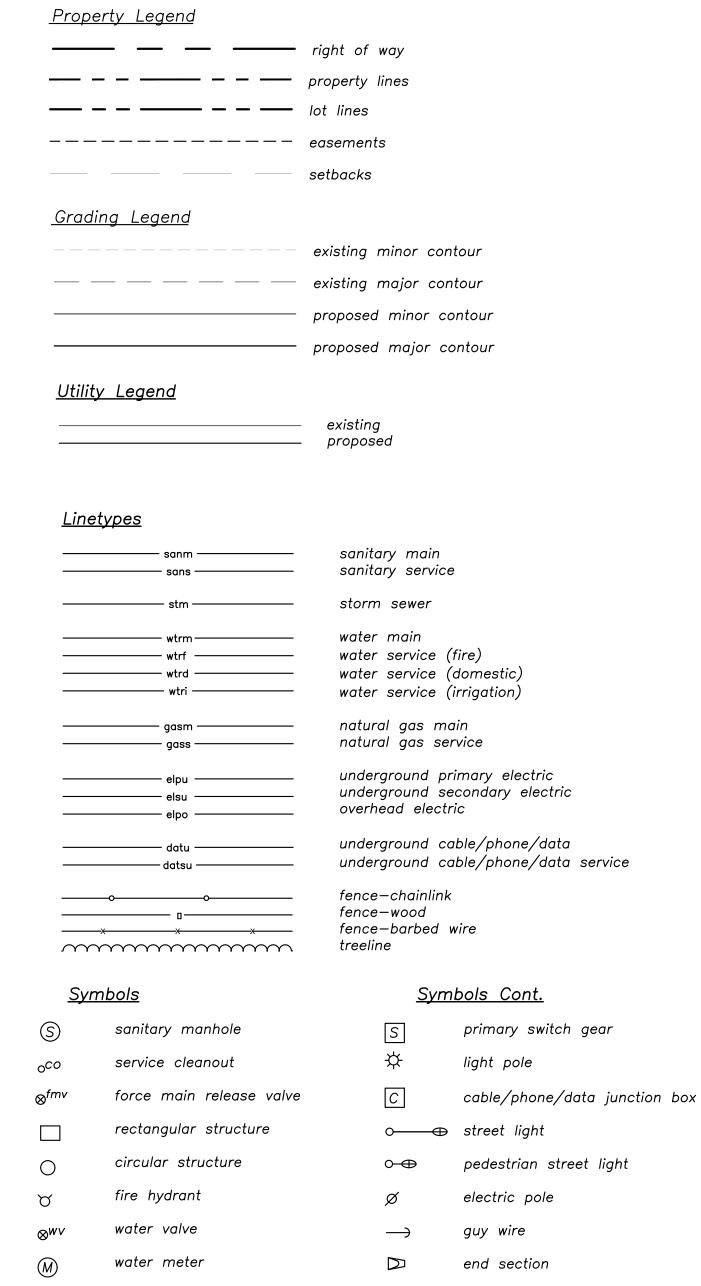

backflow preventer

natural gas meter

service transformer (pad mount)



opment Plan for I-49 Industrial Center - No

dete 09.30.2021 drawn by DAE checked by PAM


revisions

sheet number

C1.1C

drawing type
PDP

project number 19239

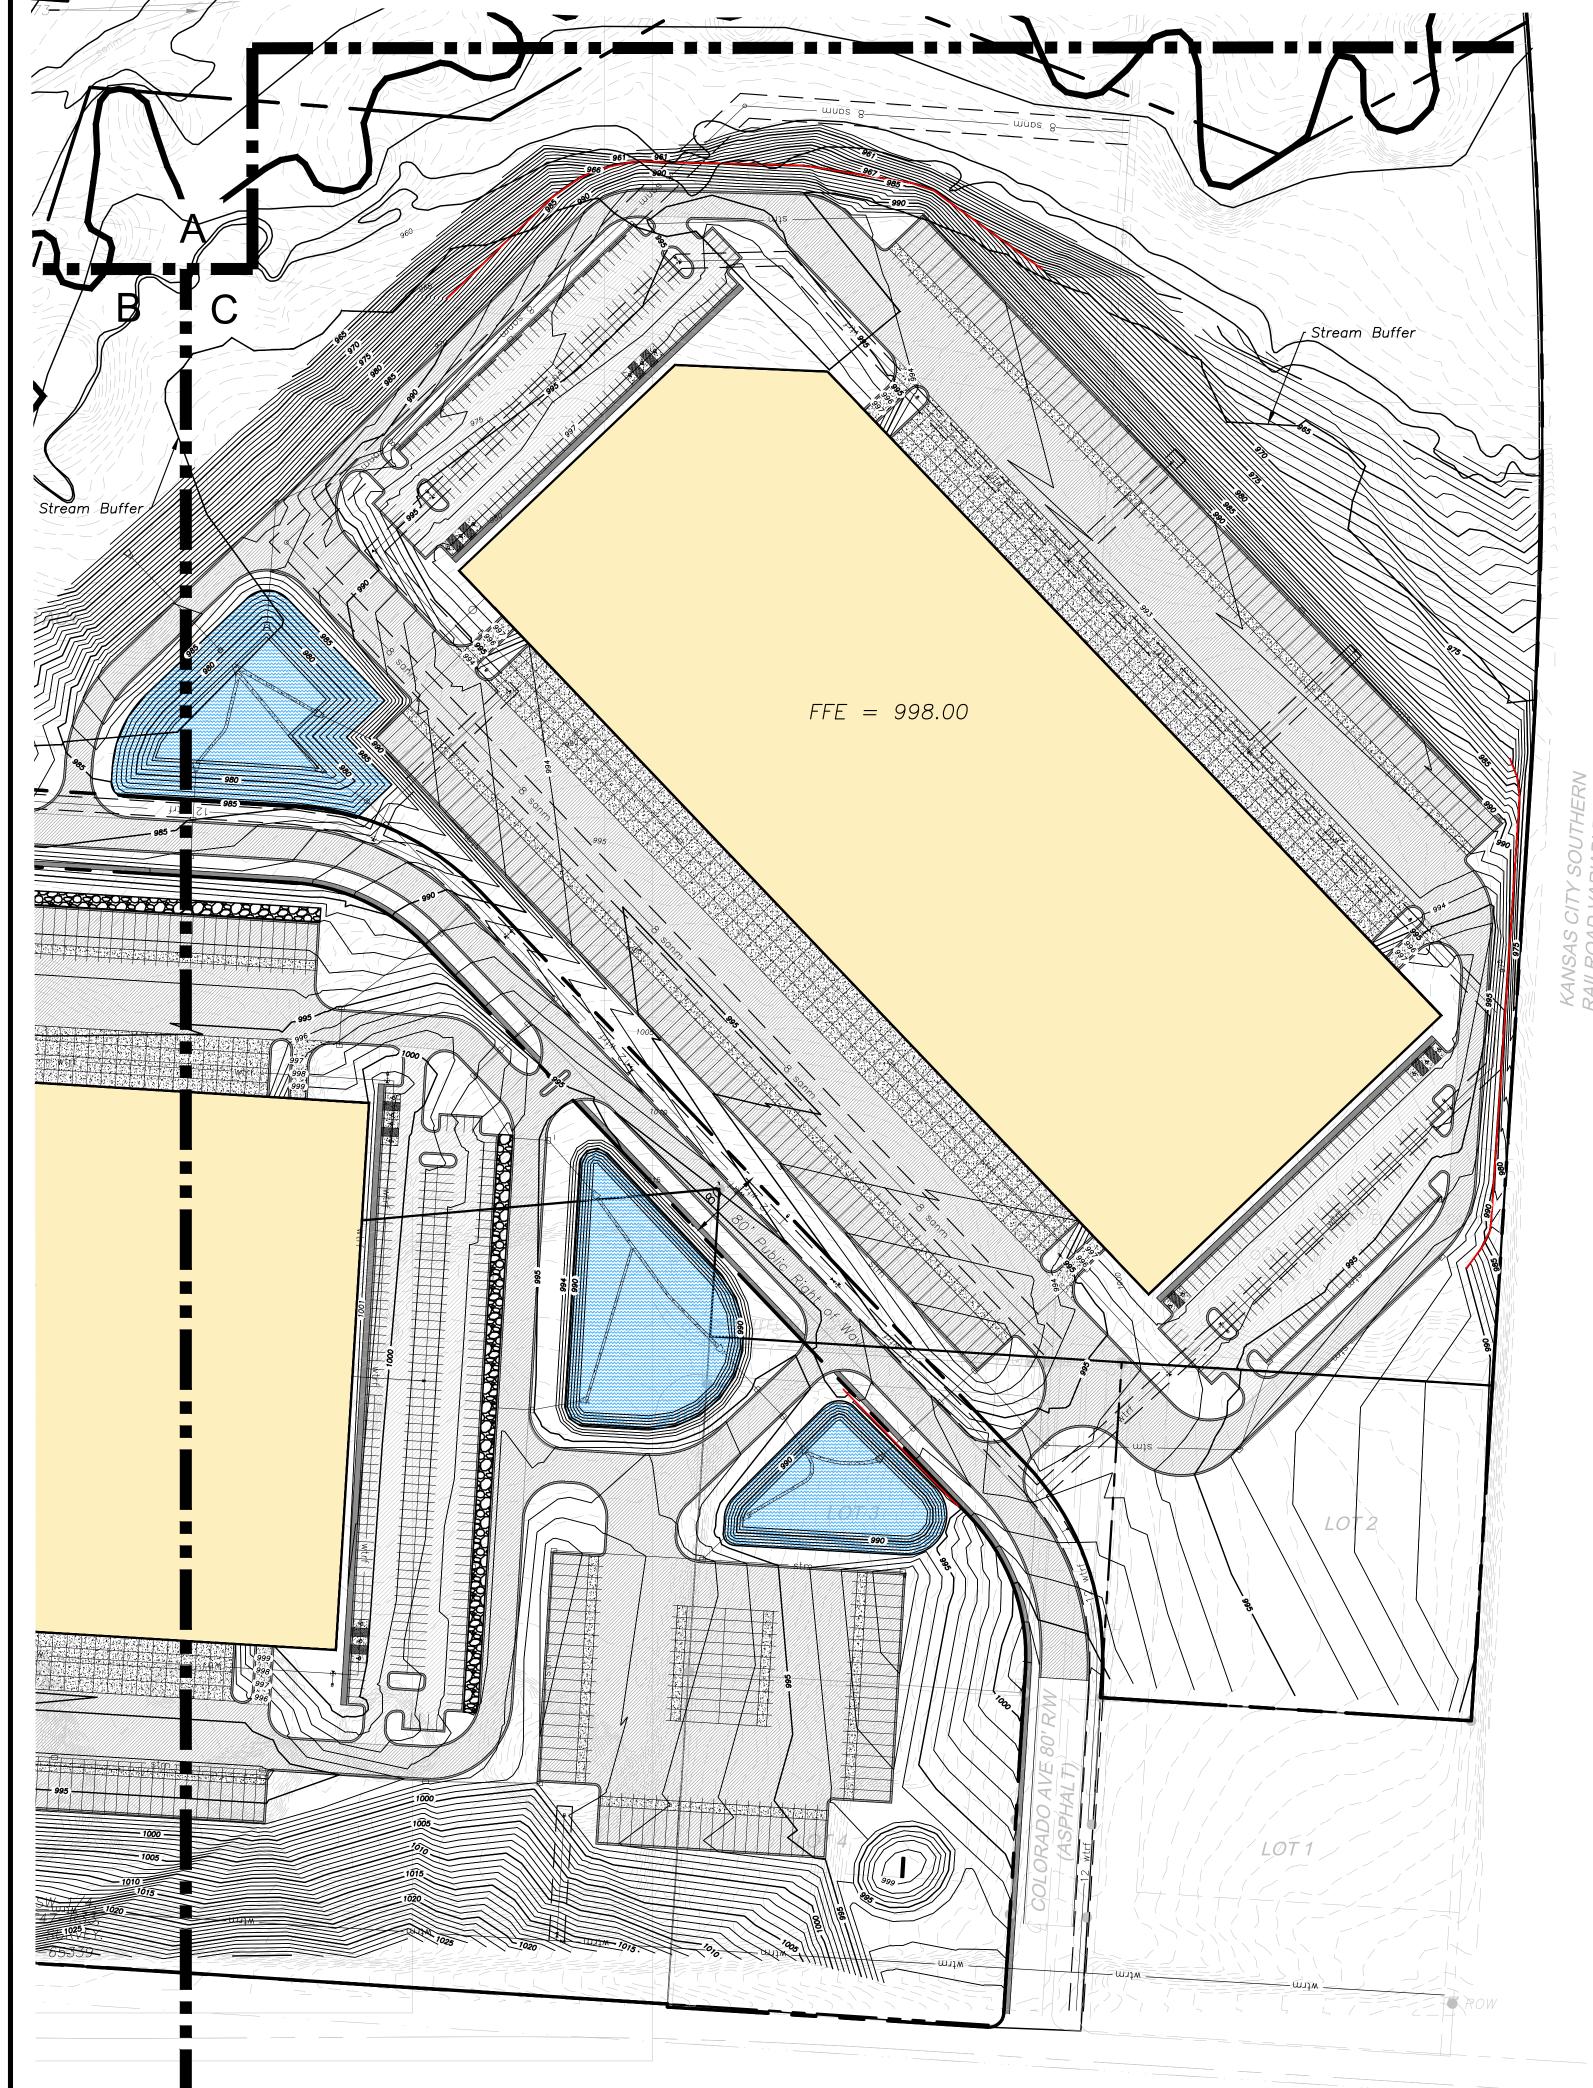

Overall Site Plan C

scale: 1"=100"

Construction Legend

concrete pavement

standard asphalt

heavy duty asphalt


concrete sidewalk

standard dry curb & gutter

detention basin

retaining wall


standard curb & gutter

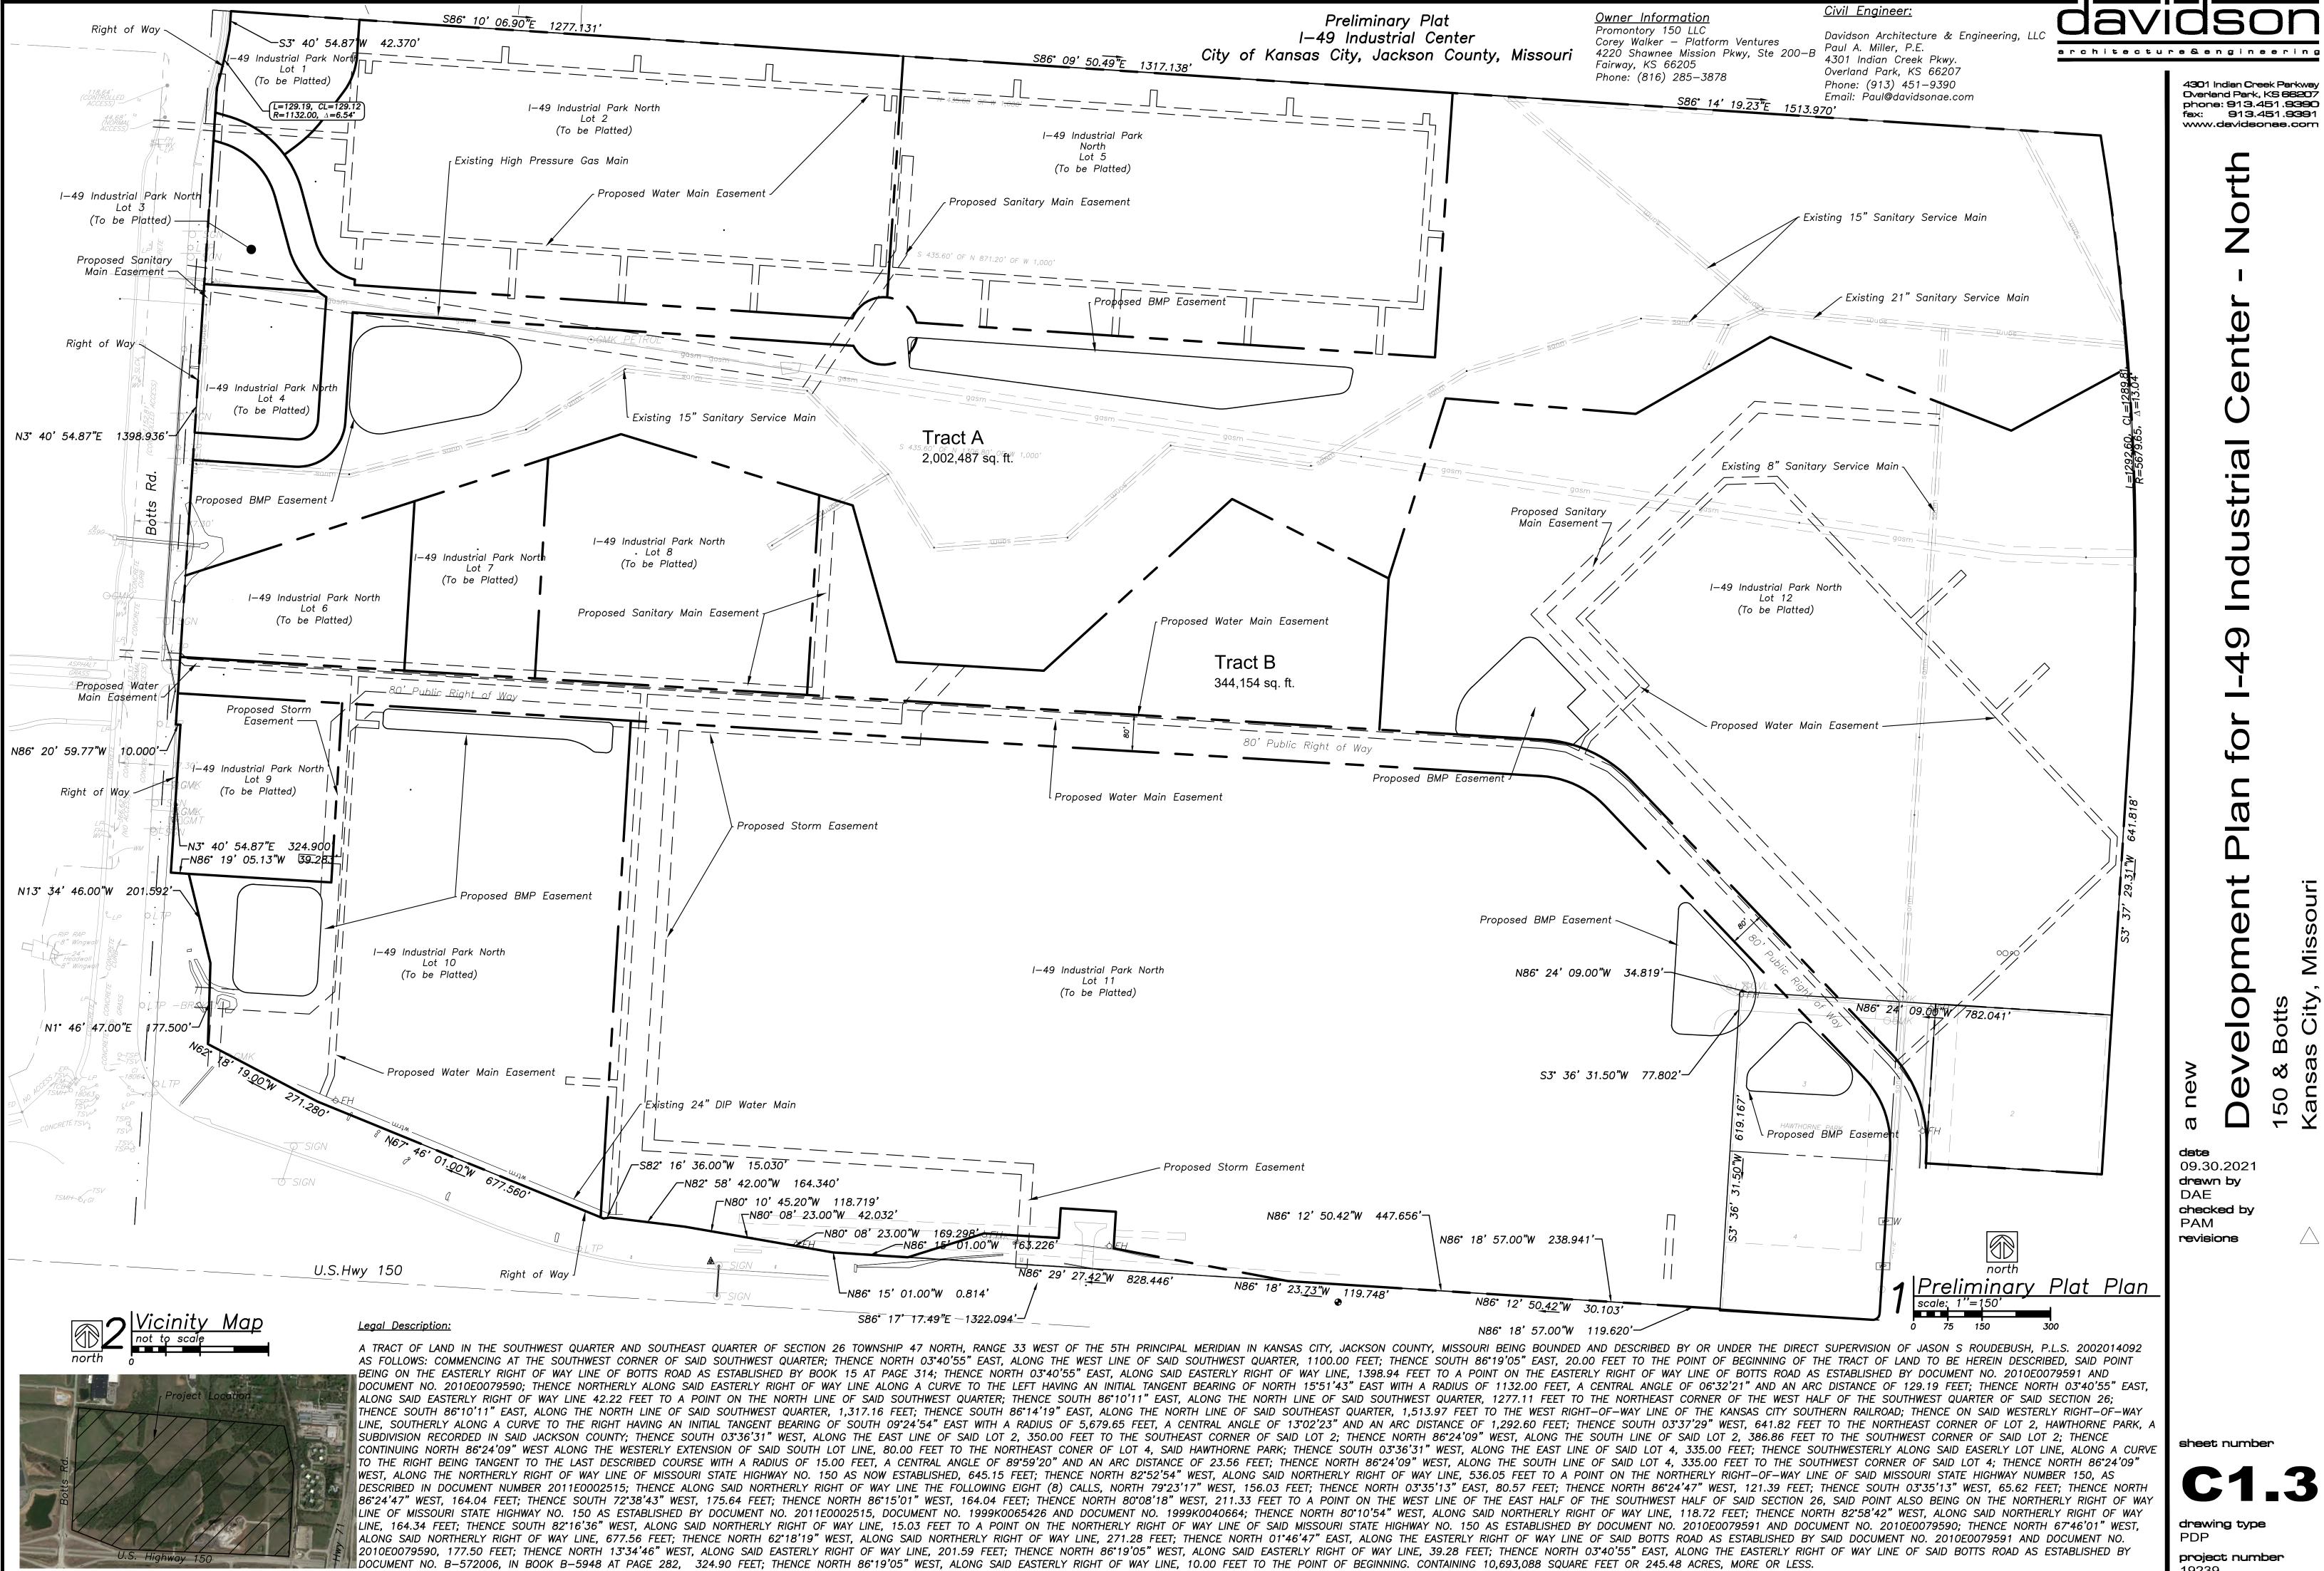

09.30.202 drawn by checked by

revisions

drawing type PDP project number

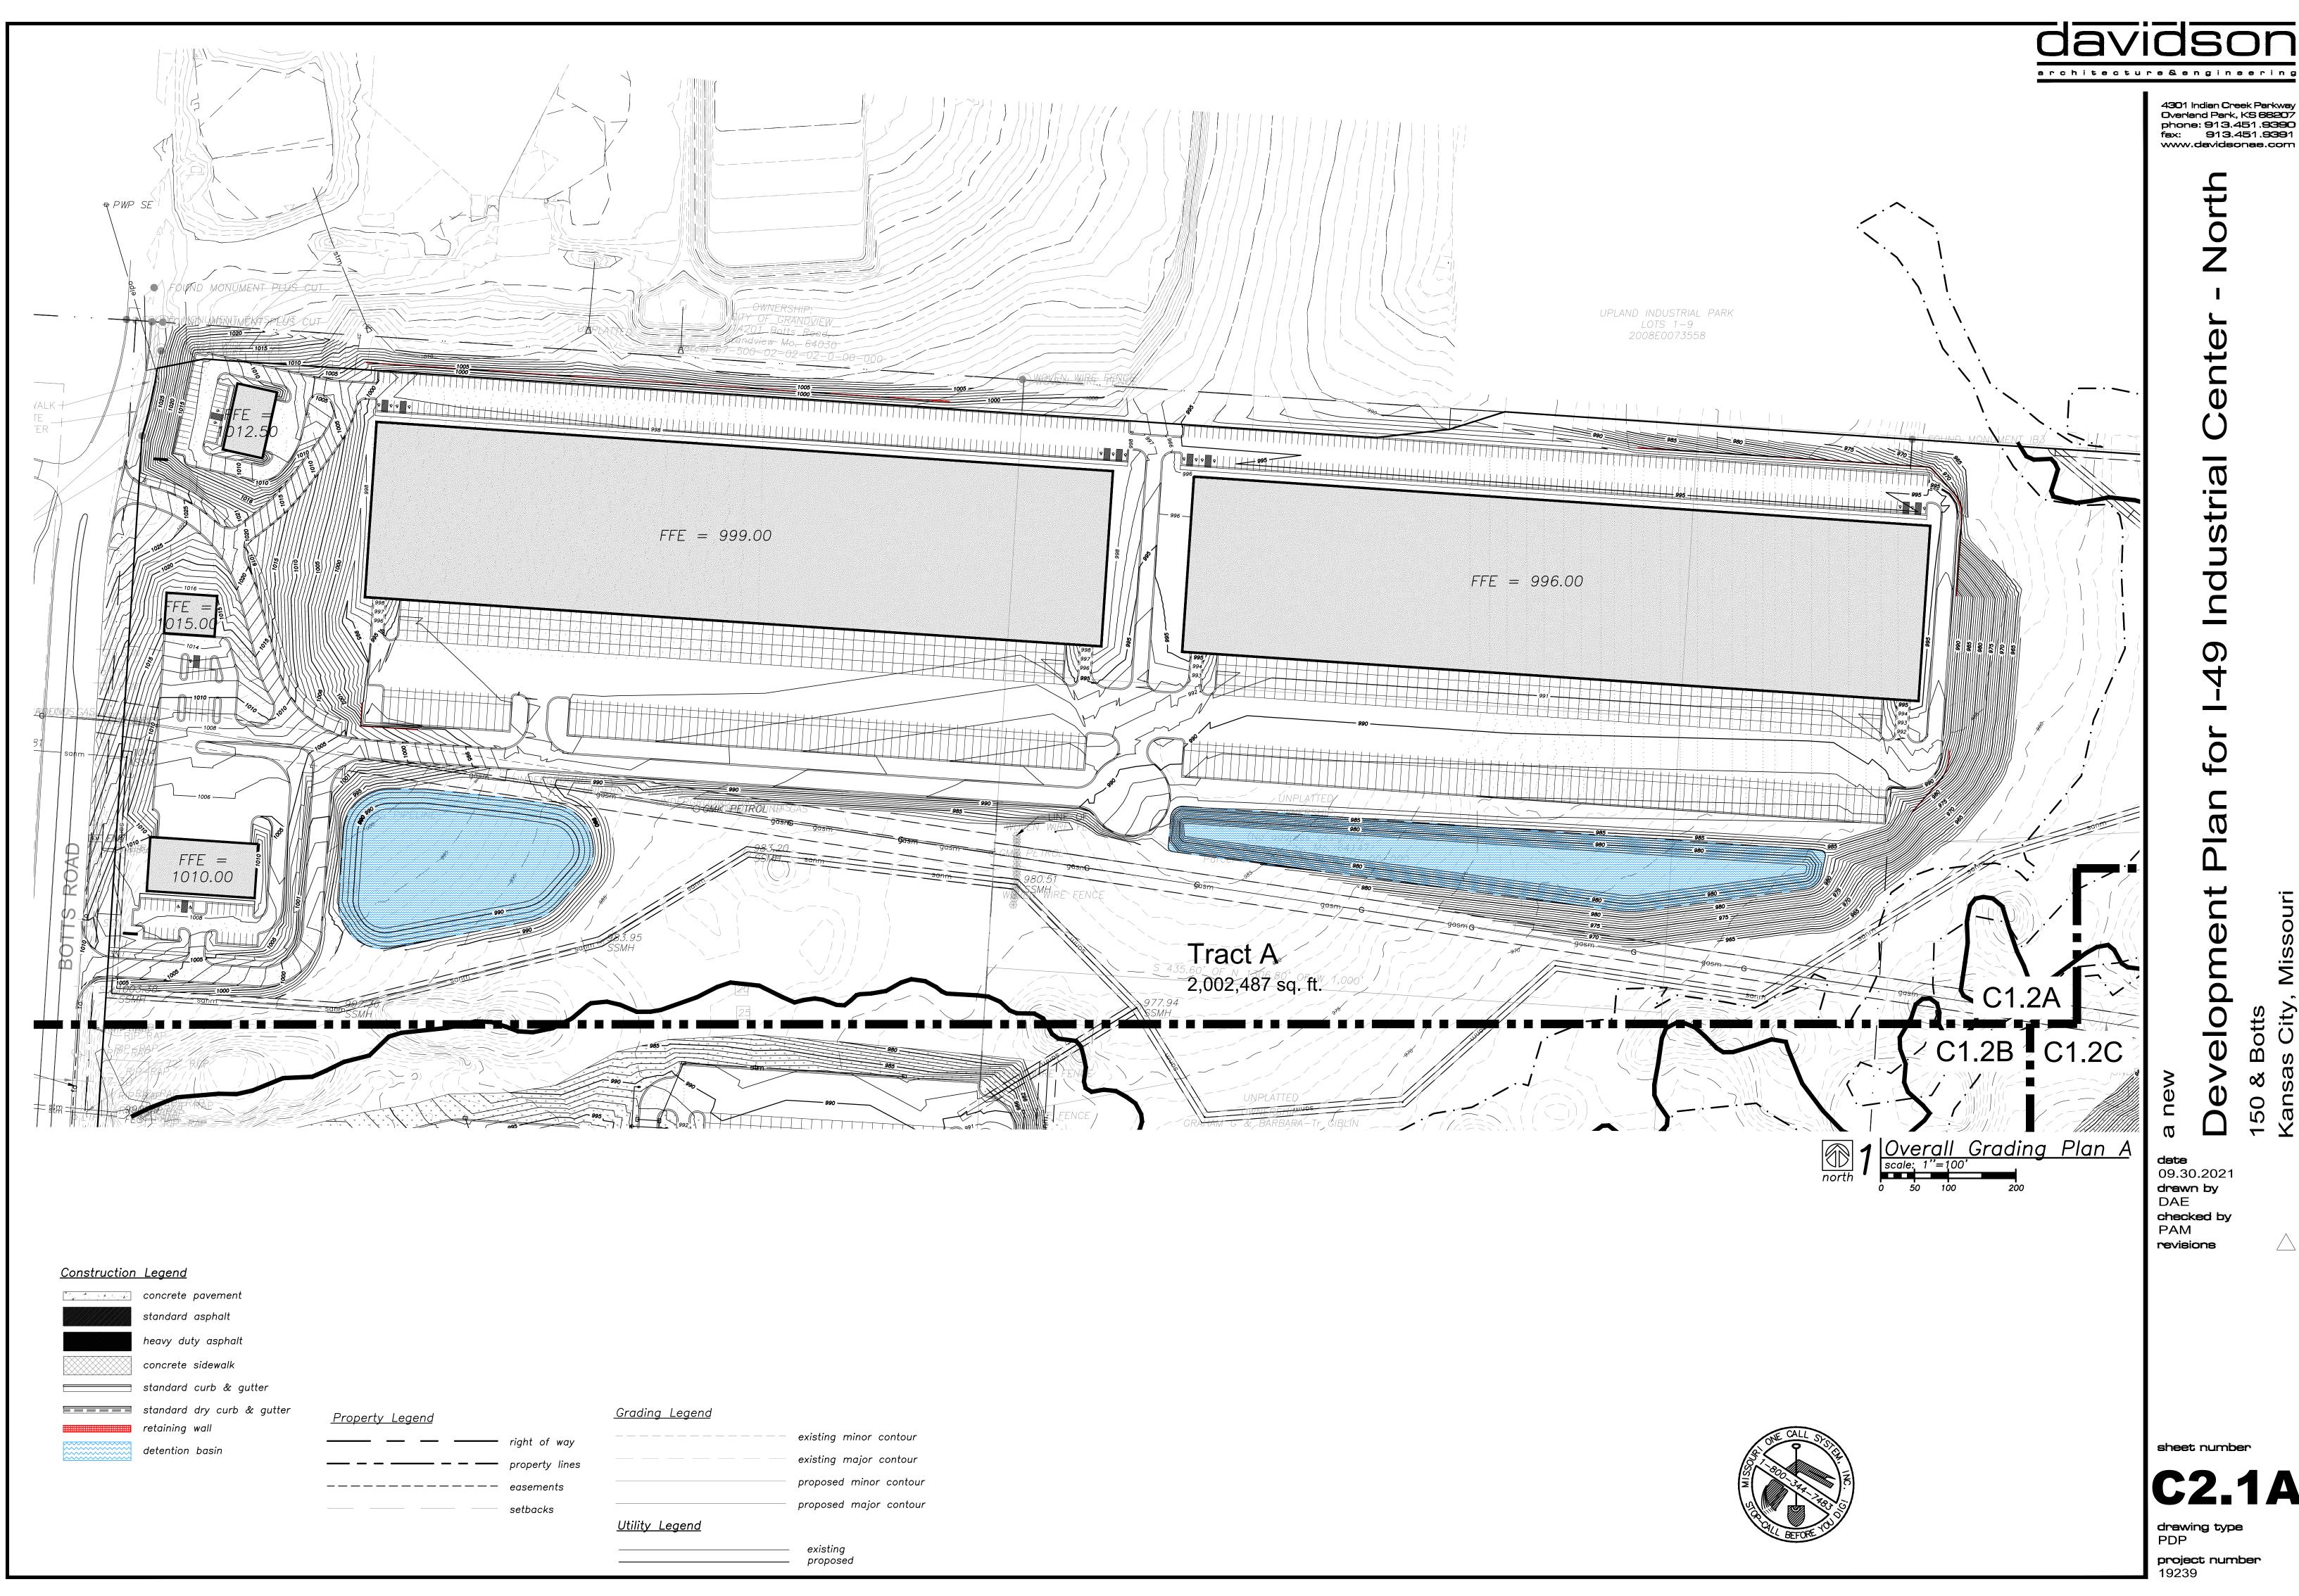


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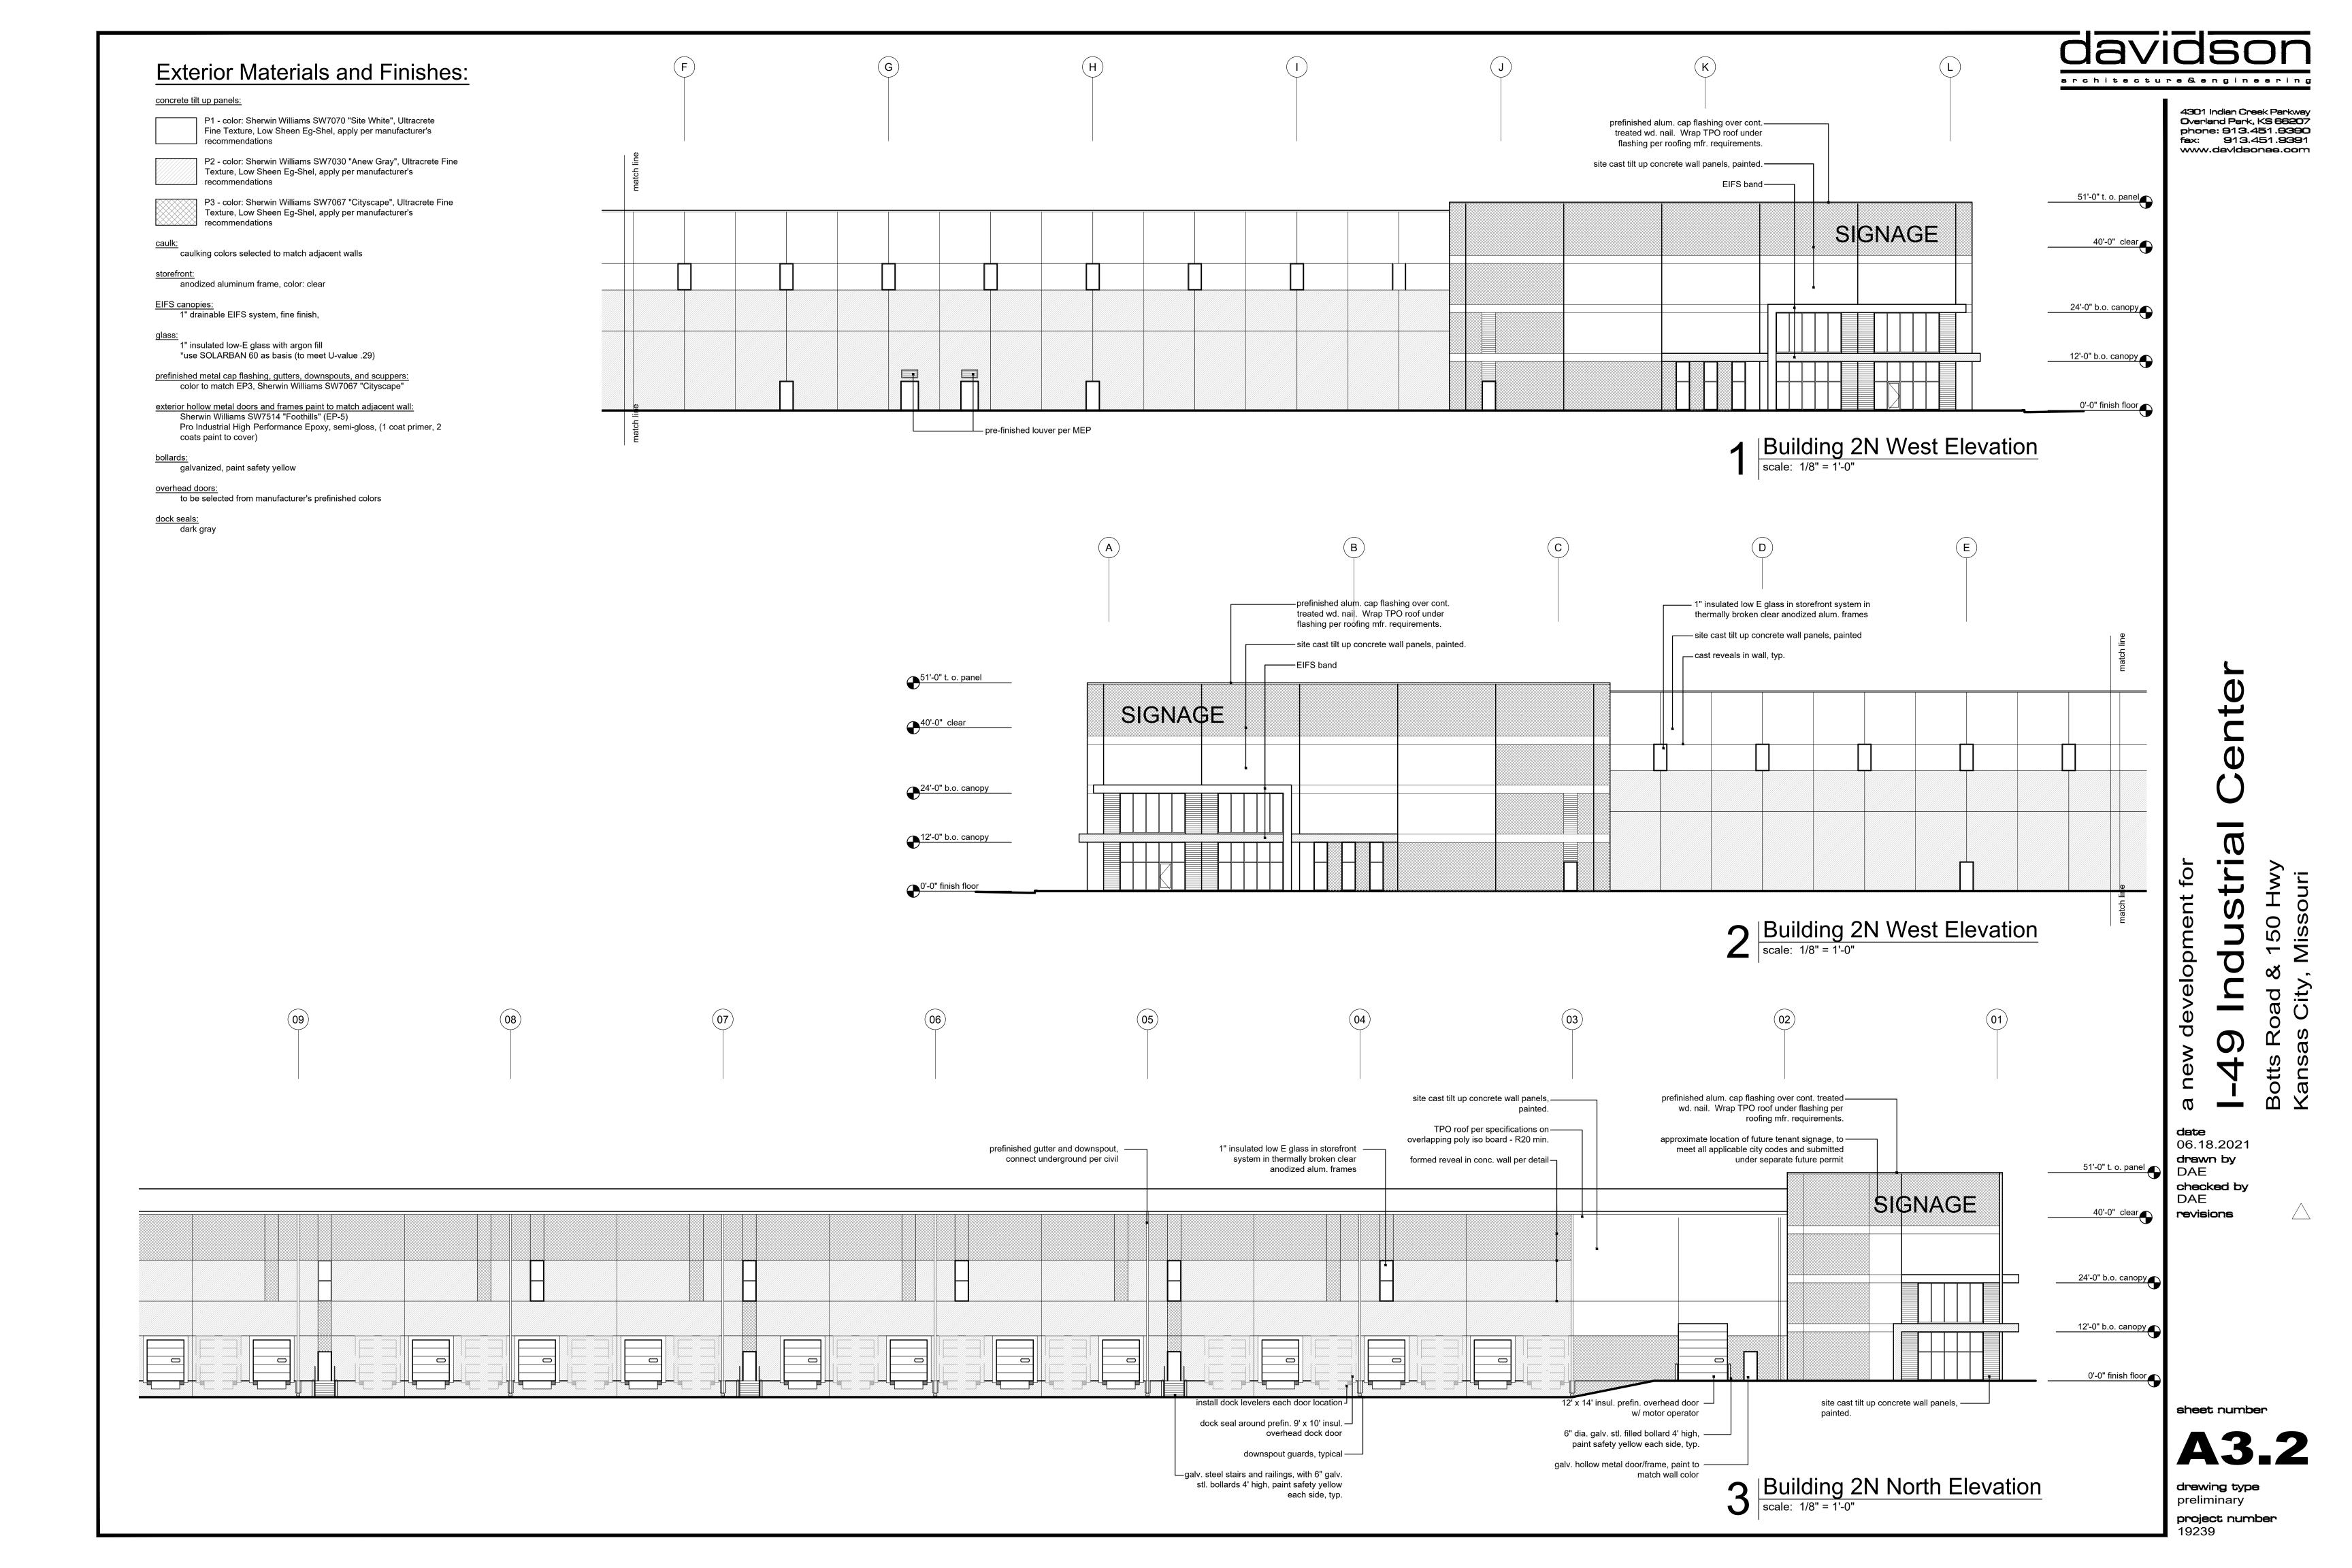
sheet number

drawing type PDP project number 19239



sheet number

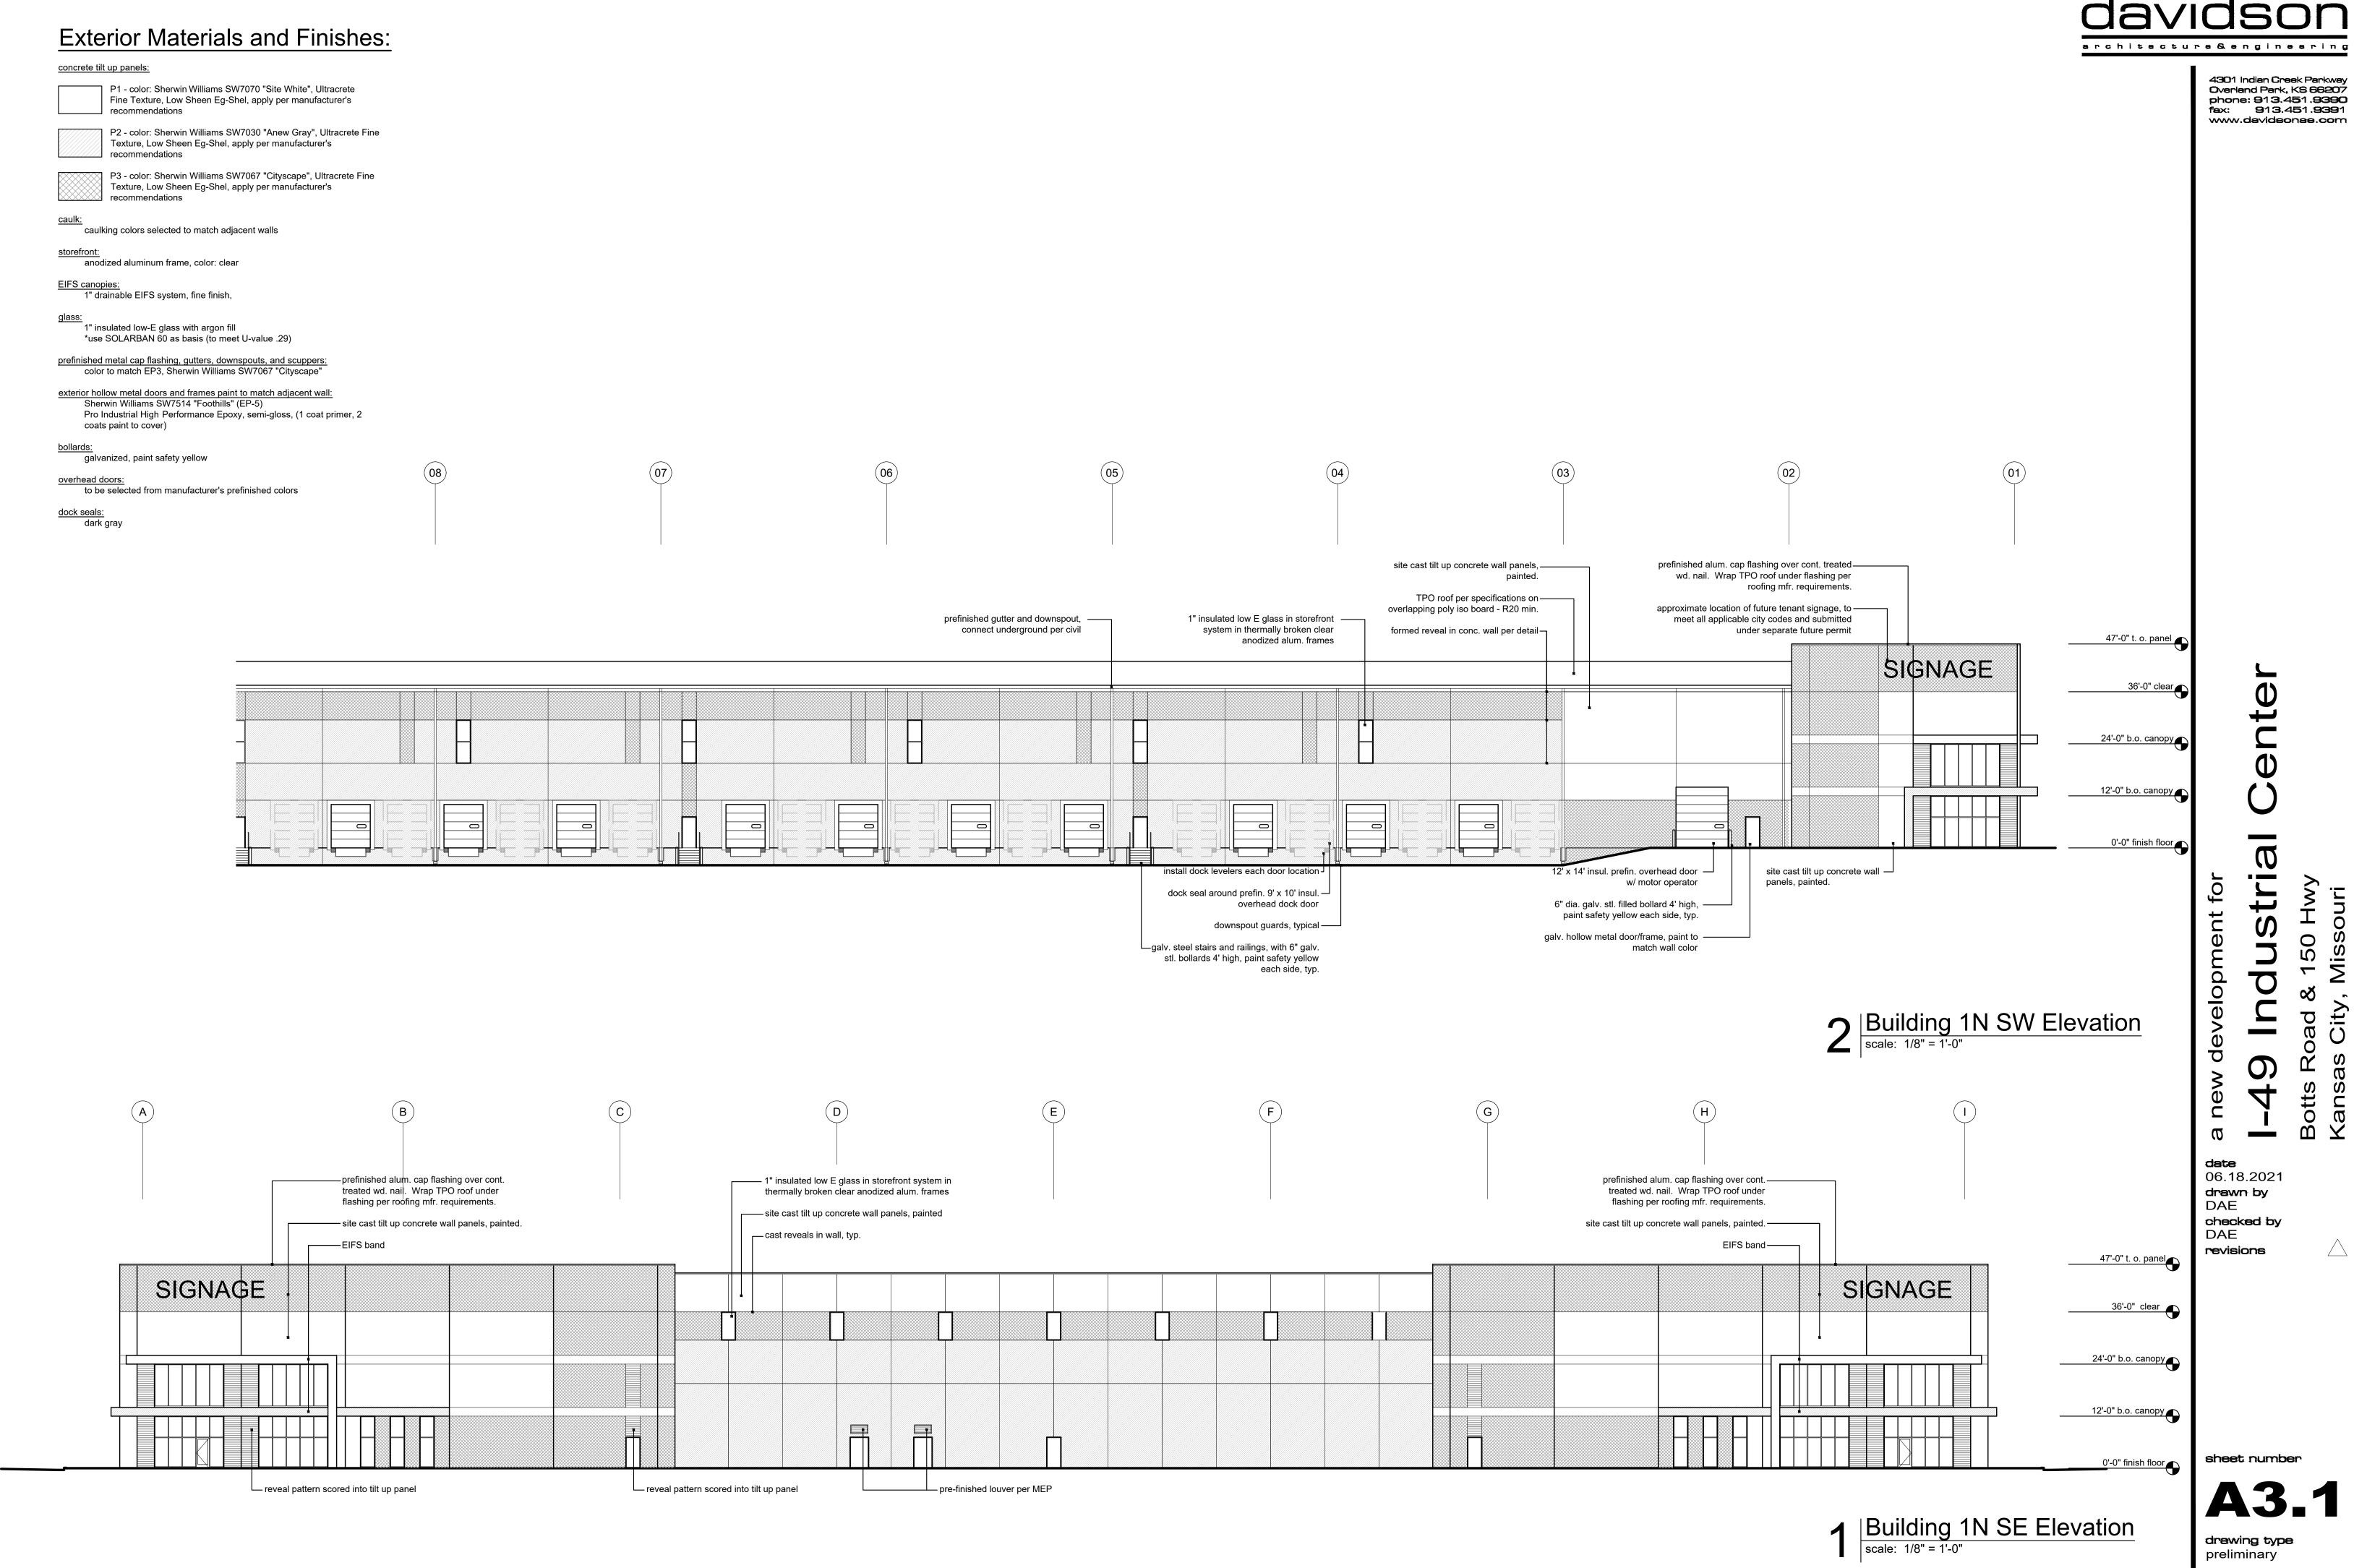project number



Exterior Materials and Finishes: concrete tilt up panels: P1 - color: Sherwin Williams SW7070 "Site White", Ultracrete Fine Texture, Low Sheen Eg-Shel, apply per manufacturer's P2 - color: Sherwin Williams SW7030 "Anew Gray", Ultracrete Fine Texture, Low Sheen Eg-Shel, apply per manufacturer's recommendations P3 - color: Sherwin Williams SW7067 "Cityscape", Ultracrete Fine Texture, Low Sheen Eg-Shel, apply per manufacturer's recommendations caulking colors selected to match adjacent walls storefront:
anodized aluminum frame, color: clear EIFS canopies:
1" drainable EIFS system, fine finish, glass:

1" insulated low-E glass with argon fill

1" insulated low-E glass with argon fill

1" insulated low-E glass with argon fill *use SOLARBAN 60 as basis (to meet U-value .29) prefinished metal cap flashing, gutters, downspouts, and scuppers: color to match EP3, Sherwin Williams SW7067 "Cityscape" exterior hollow metal doors and frames paint to match adjacent wall: Sherwin Williams SW7514 "Foothills" (EP-5) Pro Industrial High Performance Epoxy, semi-gloss, (1 coat primer, 2 coats paint to cover) galvanized, paint safety yellow to be selected from manufacturer's prefinished colors dock seals: dark gray prefinished alum. cap flashing over cont. treated wd. nail. Wrap TPO roof under flashing per roofing mfr. requirements. site cast tilt up concrete wall panels, painted. EIFS band 1" inculated law E alace in starofront evetom in

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4301 Indian Creek Parkway Overland Park, KS 66207 phone: 913.451.9390 fex: 913.451.9391 www.davidsonae.com

32'-0" t.o. panel

12'-0" b. o. canopy

2 Building A South Elevation scale: 1/8" = 1'-0"

Building A West Elevation
scale: 1/8" = 1'-0"

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prefinished alum. cap flashing over cont.—— treated wd. nail. Wrap TPO roof under flashing per roofing mfr. requirements.

EIFS band——

1" insulated low E glass in storefront system in — thermally broken clear anodized alum. frames

site cast tilt up concrete wall panels, painted.—

reveal pattern scored into tilt up panel —

0'-0" finish floor

47'-0" t. o. panel

32'-0" t.o. panel

12'-0" b. o. canopy

0'-0" finish floor

new development fo

date 06.18.2021 drawn by DAE **checked by** DAE revisions

sheet number

drewing type preliminary

project number 19239

Exterior Materials and Finishes:

concrete til up panels:

P1 - color: Sherwin Williams SW7070 "Site White", Ultracrete Fine Texture, Low Sheen Eg-Shet, apply per manufacturer's

P2 - solor: Sherwin Williams SW7000 "Anew Gray", Utracrete Fine Texture, Low Sheen Ep-Shel, apply per manufacturer's recommendations

P3 - color: Sherwin Williams SW7067 "Cityscape", Ultracrete Fine Texture, Low Sheen Eg-Shel, apply per manufacturer's

caulking colors selected to match adjacent walls

storefront, anodized aluminum frame, opior: clear

EIFS canopies: 1" drainable EIFS system, fine finish,

1" insulated low-E glass with argon fill *use SOLARBAN 60 as basis (to meet U-value ,29)

prefinished metal cap flashing, gullers, downspouls, and souppers-color to match EP3, Sherwin Williams SW7007 "Cityscape"

exterior hollow metal doors and Frames paint to match adjacent wall. Sherwin Milliams SWTE14 "Feethills" (EP-5) Pro Industrial High Performance Epoxy, semi-gloss, (1 cost primer, 2 costs paint to cover)

galvanized, paint safety yellow

to be selected from manufacturer's prefinished colors



dSD1 Indian Dreek Partikey Overtana Parti, KB 88807 phone: 813.451.8380 fex: 910.451.9391 www.davidsonee.com



1 Building 1N Render





2 Building A Render

dete 06.18.2021 drawn by DAE checked by DAE revisions

drawing type preliminary project number 19239

Meeting Sign-In Sheet

Project Name and Address

Project is located east of Botts, north of 150 Hwy, west of the BG&KC rail line, and bounded on the north by the line between Kansas City and Grandview.

Name	Address	Phone	Email
Lonnie Moore	14212 Denver St. Grandview, MO 64030		pmoore0317@att.net
Patty Moore	14212 Denver St. Grandview, MO 64030		pmoore0317@att.net
Bettie Tanquary	14215 Denver St. Grandview, MO 64030	816.761.5917	
Chris Chiodini City of Grandview	1200 Main St. Grandview, MO 64030	816.316.4820	cchiodini@grandview .org
James Mulick Port KC	110 Berkley Plaza, Kansas City MO 64120	816.559.3750	
Kevin Breslin RB LLP	4220 SMP Fairway, KS 66205		kbreslin@rb-llp.com
Corey Walker Platform Ventures	4220 SMP Fairway, KS 66205	816.285.3878	corey.walker@ platformv.com
Jason Romero Platform Ventures	4220 SMP Fairway, KS 66205	816.285.3878	jason.romero@ platformv.com
Will Dubois Davidson AE	4301 Indian Creek Pkwy Overland Park, KS 66207	913.451.9390	will@davidsonae.com



CITY PLANNING & DEVELOPMENT

Public Meeting Summary Form

Three nearby residents of Grandview joined and expressed their concerns. The most discussed concerns involved visibility from their property to the project, storm water runoff, and connection of the site to their residential street.

Ownership and representatives highlighted the large portions of land by the stream that will not be developed and will provide a visual buffer, explained some of the civil engineering involving the storm water, and noted that the project does not connect to Denver St- which is unlikely to ever be a viable connection from the site into the community due to the stream location.

A representative from Port KC attended and expressed support for the project. They mentioned the relocation of the asphalt plant, something all participants were in support of.

The Grandview Director of Community Development joined the call to listen to the presentation and gather info he could take back to the community.