

CITY PLAN COMMISSION STAFF REPORT

City of Kansas City, Missouri
City Planning & Development Department
www.kcmo.gov/cpc

June 18, 2024

Project Name

LivSmart Studios KCI

Docket #1

Request

CD-CPC-2024-00019 Non-Residential Development Plan

Applicant

Kaitlin Raynor Kimley Horn

Owner

Paroya Petroleum Inc

Location 10000 North Polo Drive

Area About 2.4 Acres

Zoning B3-3
Council District 1st
County Platte
School District Park Hill

Surrounding Land Uses

North: NW Tiffany Springs Parkway, zoned B3-3

South: Commercial, zoned B3-3

East: Commercial, zoned B3-3

West: Interstate 29, zoned B3-3

KC Spirit Playbook Alignment

CD-CPC-2024-00019 LRP determination: NA

Land Use Plan

The KCIA Area Plan recommends Commercial for this location.

Major Street Plan

NW Tiffany Springs Parkway identified as an Established Parkway on the City's Major Street Plan.

APPROVAL PROCESS

Staff
Review City Plan
Commission City Council

PROJECT TIMELINE

The application for the subject request was filed on 02/23/2024. Scheduling deviations from 2024 Cycle 4.2 have occurred to provide the applicant with additional time to submit updated plans.

NEIGHBORHOOD AND CIVIC ORGANIZATIONS NOTIFIED

The subject site is not located within a registered neighborhood or homes association.

REQUIRED PUBLIC ENGAGEMENT

Public engagement as required by 88-505-12 does apply to this request. Applicant hosted a meeting on March 12, 2024. A summary of the meeting is attached to the staff report, see Attachment #3.

EXISTING CONDITIONS

The subject property has an existing surface parking lot.

SUMMARY OF REQUEST + KEY POINTS

The applicant is seeking approval of a development plan to allow for the construction of a hotel (lodging) in district B3-3.

CONTROLLING + RELATED CASES

Ordinance No. 951109 – City Council moved to hold the application on docket for an amendment to the ShoLodge GP-3 plan on October 19, 1995.

PROFESSIONAL STAFF RECOMMENDATION

Docket #1 Approval with Conditions

PLAN REVIEW

The applicant is requesting approval of a four-story hotel with 109 guest rooms and associated amenities. The hotel amenities include an outdoor patio, eating area, indoor pool, gym, and surface parking. The site has an future trail easement along the western property line.

NW Tiffany Springs is identified as an established parkway in the City's Major Street Plan. The applicant has worked with staff to revise the site layout and building materials. The applicant is proposing parking on the eastern side of the building, there are approximately 10 parking spaces in front of the building approximately 11 feet from the parkway. The Zoning and Development Code does not allow for parking to be in front of the building when adjacent to and within 150 feet of a parkway. The applicant has stated they would like to proceed with a variance request to allow for the parking to remain, staff is including a condition requiring approval of a variance to the parkway standard. Staff has also added a condition requiring the applicant to work with the Police Department regarding outstanding corrections regarding addressing and standard operating procedures prior to ordinance request.

There are two existing accesses off North Polo Drive. There is an existing sidewalk on North Polo Drive and NW Tiffany Springs Parkway, the applicant is proposing to connect to the sidewalk on North Polo and is providing a connection to the future trail to the west. The applicant is proving bicycle parking in compliance with the Zoning and Development Code.

The proposed hotel has four-sided architecture, the applicant has revised their elevations to minimize the amount of blank walls on the building. The proposed building materials include dark brick, different colors of EIFS, Nichiha wood cedar, and louver finish.

PLAN ANALYSIS

*indicates adjustment/deviation

Standards	Applicability	Meets	More Information
Lot and Building Standards (88-120)*	Yes	Yes	See Below
Accessory or Use- Specific Standards (88-305 – 385)	No	NA	NA
Boulevard and Parkway Standards (88-323)	Yes	No	See below
Parkland Dedication (88-408)	No	NA	
Tree Preservation and Protection (88-424)	No	NA	NA
Parking and Loading Standards (88-420)	Yes	Yes	
Landscape and Screening Standards (88-425)	Yes	Yes, subject to conditions	
Outdoor Lighting Standards (88-430)	Yes	Yes, subject to conditions	

Sign Standards (88-445)	Yes	Yes, subject to conditions	
Pedestrian Standards (88-450)	Yes	Yes, subject to conditions	

Lot and Building Standards (88-120-04): Per Table 120-2 the maximum allowed building height for all buildings that are not mixed use is 55' (feet). The applicant is requesting approval of a deviation to allow for a 60' (foot) tall building.

Surface Parking – Boulevard and Parkway Standards (88-323-02-B): If adjacent to and within 150 feet of a parkway, parking located on the side of the building shall be set back a minimum of 10 feet behind the front building line or 30 feet from the right-of-way, whichever is greater. The site plan shows parking on the east side of the building that is not compliant with this section of code. The applicant will be required to apply for and receive approval of a variance to the parkway standards.

SPECIFIC REVIEW CRITERIA

Development Plans, Project Plan, or Site Plan (88-516-05)

In order to be approved, a development plan, project plan, or site plan must comply with all of the following criteria:

A. The plan must comply with all standards of the Zoning and Development Code and all other applicable city ordinances and policies;

The plan does not comply with the parkway standards as previously discussed in this staff report. Staff has included a condition requiring the applicant to apply for and receive approval of a variance to the parkway standards. The applicant worked with staff to improve not only the site layout but also the elevations facing Interstate 29 and NW Tiffany Springs Parkway, approval of the variance will make the plan compliant with the standards in the Zoning and Development Code.

- B. The proposed use must be allowed in the district in which it is located;
 - The proposed use is allowed in a B3-3 district, a development plan is required due to the size of the proposed structure.
- C. Vehicular ingress and egress to and from the site, and circulation within the site must provide for safe, efficient, and convenient movement of traffic not only within the site but on adjacent roadways;
 There are two vehicular accesses off North Polo Drive, both provide efficient, convenient, and safe movement of vehicles on and off the site.
- D. The plan must provide for safe, efficient, and convenient non-motorized travel opportunities, being pedestrian and bicycle movement, on the subject site;

The plan is providing safe, efficient, and convenient non-motorized travel opportunities. There is a future trail easement on the site, the applicant is proposing a connection from the future trail to the back of

the proposed building. The site also provides connectivity around the entirety of the building and to the existing sidewalk on North Polo Drive.

E. The plan must provide for adequate utilities based on City standards for the particular development proposed.

Adequate utilities based on City Standards will be provided for the proposed development.

- F. The location, orientation, and architectural features, including design and material, of buildings and other structures on the site must be designed to be compatible with adjacent properties.
 - The location and orientation of the proposed structure is compatible with the adjacent properties. The proposed structure backs onto Interstate 29 and faces a parkway. The applicant worked with staff to provide four-sided architecture to avoid blank walls along the back (Interstate 29). Additionally, the applicant revised the side of the building facing NW Tiffany Spring Parkway to include more transparency along the ground floor to comply with the parkway standards.
- G. Landscaping, berms, fences, and/or walls must be provided to buffer the site from undesirable views, noises, lighting, or other off-site negative influences and to buffer adjacent properties from negative influences that may be created by the plan.
 - The applicant is proposing landscaping in compliance with the Zoning and Development Code, the proposed landscaping provides a sufficient buffer from the parking areas to adjacent properties.
- H. The design of streets, drives, and parking areas within the project should result in a minimum of area devoted to asphalt or other impervious surfaces consistent with the needs of the project and city code requirements.
 - There is an existing surface parking lot on the site that the applicant is using as a part of their development. The proposed use is increasing the impervious surfaces on the site, the applicant is providing excessive parking spaces for the proposed use. The applicant has stated that the amount of parking provided is less than what the operating requirements are for the hotel brand.
- The plan must identify trees to be removed and trees to be preserved during the development of the subject property with the goal of saving trees that are not required to be removed for the development of the property.

The landscape plan submitted shows the trees to be preserved and removed.

ATTACHMENTS

- 1. Conditions Report
- 2. Applicants Submittal
- 3. Public Engagement Materials

PROFESSIONAL STAFF RECOMMENDATION

City staff recommends **Approval with Conditions** as stated in the conditions report.

Respectfully Submitted,

Larisa Chambi, AICP

Larsa Shamb

Lead Planner

Plan Conditions



Report Date: May 30, 2024

Case Number: CD-CPC-2024-00019
Project: LivSmart Studios KCI

Condition(s) by City Planning and Development Department. Contact Larisa Chambi at (816) 513-8822 / Larisa.Chambi@kcmo.org with questions.

1. Signage has not been reviewed with this application, all signage shall conform to 88-445 and shall require a sign permit prior to installation.

- 2. The developer shall screen all roof and/or ground mounted mechanical and utility equipment in compliance with 88-425-08.
- 3. The developer shall submit an affidavit, completed by a landscape architect licensed in the State of Missouri, verifying that street trees have been installed in accordance with the approved street tree planting plan and are healthy prior to Certificate of Occupancy.
- 4. The developer shall submit an affidavit, completed by a landscape architect licensed in the State of Missouri, verifying that all landscaping required of the approved plan has been installed in accordance with the plan and is healthy prior to Certificate of Occupancy.
- 5. The developer shall submit an affidavit, prepared by an engineer licensed in the State of Missouri, verifying that all outdoor lighting has been installed in accordance with approved plans and that lighting levels do not exceed that shown on the approved lighting plan at the property lines prior to Certificate of Occupancy.
- 6. The developer shall work with the Police Department to resolve the following remain conditions prior to ordinance request: a. Provide standard operating characteristics including but not limited to: security measure, lighting, hours of operation, noise, access requirements (keycard access/code access).
 - b. Confirm addressing location on proposed structures.
 - c. Dumpster screening needs to be raised 6 inches to 1 foot from the ground on at least one side if solid screening materials are proposed.
- 7. The developer shall apply for and receive approval of a variance to 88-323-02-B-2, prior to certificate of occupancy. Should a variance be denied by the Board of Zoning Adjustment the developer shall revise the plans to be compliant with the Zoning and Development Code.
- 8. Approving a deviation to Table 120-2 (Lot and Building Standards for O and B Districts) to allow a 60' (foot) tall building.

Condition(s) by City Planning and Development Department. Contact Terry Thomas at (816) 513-2510 / Terry.A.Thomas@kcmo.org with questions.

- 9. The developer shall submit plans for grading, siltation, and erosion control to Land Development Division for review and acceptance, provide a copy of the Storm Water Pollution Prevention (SWPP) plan submitted to the Missouri Dept. of Natural Resources (MDNR) and secure a Site Disturbance permit for any proposed disturbance area equal to one acre or more prior to beginning any construction activities.
- 10. The developer shall submit verification of vertical and horizontal sight distance for the drive connection to public right-of-way to the Land Development Division and make improvements to ensure local jurisdiction and/or minimum AASHTO adequate sight distance standards are met, prior to issuance of any certificate of occupancy.
- 11. The developer shall submit a letter to the Land Development Division from a Licensed Civil Engineer, Licensed Architect, or Licensed Landscape Architect, who is registered in the State of Missouri, that identifies sidewalks, curbs, and gutters in disrepair as defined by Public Works Department's "OUT OF REPAIR CRITERIA FOR SIDEWALK, DRIVEWAY AND CURB revised 11/5/2013" and based on compliance with Chapters 56 and 64 of the Code of Ordinances for the sidewalks, curbs, and gutters where said letter shall identify the quantity and location of sidewalks, curbs, gutters that need to be constructed, repaired, or reconstructed to remedy deficiencies and/or to remove existing approaches no longer needed by this project. The developer shall secure permits to repair or reconstruct the identified sidewalks, curbs, and gutters as necessary along all development street frontages as required by the Land Development Division and prior to issuance of any certificate of occupancy permits including temporary certificate occupancy permits.

Condition(s) by City Planning and Development Department. Contact Terry Thomas at (816) 513-2510 / Terry.A.Thomas@kcmo.org with questions.

- 12. The developer shall submit a storm drainage analysis from a Missouri-licensed civil engineer to the Land Development Division, in accordance with adopted standards, including a BMP level of service analysis prior to approval and issuance of any building permits, and that the developer secure permits to construct any improvements as required by the Land Development Division prior to issuance of any certificate of occupancy.
- 13. The developer shall obtain the executed and recorded City approved grading, temporary construction, drainage/sewer, or any other necessary easements from the abutting property owner(s) that may be required prior to submitting any public improvements crossing properties not controlled by the developer and include said document(s) within the public improvement applications submitted for permitting
- 14. The developer shall submit a streetscape plan for approval and permitting by the Land Development Division prior to beginning construction of the streetscape improvements in the public right of way, and construct ADA compliant ramps at all required locations where new private drives are being added, or where existing sidewalks are modified or repaired.
- 15. The developer shall grant a BMP and/or Surface Drainage Easement to the City as required by the Land Development Division, prior to recording the plat or issuance of any building permits.
- 16. The developer shall submit an analysis to verify adequate capacity of the existing sewer system as required by the Land Development Division prior to issuance of a building permit to connect private system to the public sewer main and depending on adequacy of the receiving system, make other improvements as may be required.
- 17. The developer shall pay impact fees as required by Chapter 39 of the City's Code of ordinances as required by the Land Development Division.

Condition(s) by Fire Department. Contact Michael Schroeder at (816) 513-4604 / michael.schroeder@kcmo.org with questions.

- 18. The developer shall meet the fire flow requirements as set forth in Appendix B of the project International Fire Code 2018. (IFC-2018 § 507.1)
- 19. Buildings equipped with a fire standpipe system shall have an operable fire hydrant within 100 feet of the Fire Department Connection (FDC). (IFC2018 § 507.5.1.1) All Fire Department Connections (FDC) shall be threaded connections, Storz connections are not allowed in the City of Kansas City, Missouri (IFC-2018 § 903.3.6; NFPA 13-2010 § 6.8.1).
- 20. A required fire department access roads shall be an all weather surface. (IFC-2012: § 503.2.3) Fire Department access roads shall be provided prior to construction/demolition projects begin. (IFC-2018 § 501.4 and 3310.1; NFPA 241-2013 § 7.5.5) Required fire department access roads shall designed to support a fire apparatus with gross axle weight of 85,000 pounds. (IFC-2018: § 503.2.3) The turning radius for fire department access roads shall be 30 feet inside and 50 feet outside radius. (IFC-2018: § 503.2.4) Shall provide fire lane signage on fire access drives.
- 21. Aerial Fire Apparatus access roads shall be provided for any building that is 30 feet in height or greater. Aerial Fire Apparatus Roads are a minimum 26 feet wide, at least 15 feet away from the building but not more than 30 feet from the structure. (IFC-2018 § D105).

Condition(s) by Water Services Department. Contact Heather Massey at (816) 513-2111 / heather.massey@kcmo.org with questions.

- 22. The developer shall have a water flow test done to ensure there is adequate water pressure to serve the development. South of River contact Patrick Lewis 816-513-0423 North of River contact - Pedro Colato 816-513-4892
- 23. The developer shall ensure that water and fire service lines should meet current Water Services Department Rules and Regulations. Prior to C of O. https://www.kcwater.us/wp-content/uploads/2022/05/2022-Rules-and-Regulations-for-Water-Service-Lines-Final.pdf

Condition(s) by Water Services Department. Contact Kirk Rome at (816) 513-0368 / kirk.rome@kcmo.org with questions.

24. Obtain KC Water approval of the final grading plan within the existing 24" transmission main easement along the west side of the property. The grading plan shall retain 5' min. cover and no more than 15' of cover. Follow the requirements of the existing water easement such as no structures within the easement. Storm drain pipes parallel to the water main shall be located a minimum of 10' away.

Condition(s) by Water Services Department. Contact Lucas Kaspar at (816) 513-2131 / Lucas.Kaspar@kcmo.org with questions.

25. The developer must grant a BMP Easement to the City prior to issuance of any building permits.

PROJECT TEAM

VICINITY MAP

<u>DEVELOPER</u>

ALTIRA HOTELS KCI, LLC 2323 GRAND BOULEVARD, SUITE 1100 KANSAS CITY, MO 64108 CONTACT: MIKE PATEL EMAIL: MIKEPATEL@MARQUEEHOSPITALITY.COM

CIVIL ENGINEER, LANDSCAPE ARCHITECT

KIMLEY-HORN & ASSOCIATES, INC.
805 PENNSYLVANIA AVENUE, SUITE 150
KANSAS CITY, MO 64105
TEL: (816) 652-0350
PRIMARY CONTACT: MATTHEW KIST, P.E.
EMAIL: MATT.KIST@KIMLEY-HORN.COM
SECONDARY CONTACT: KAITLIN RAYNOR
EMAIL: KAITLIN.RAYNOR@KIMLEY-HORN.COM


ARCHITECT, LIGHTIN

TYPE SIX
920 S MAIN ST, SUITE 150
GRAPEVINE TX, 76051
TEL: (682) 365-3381
PRIMARY CONTACT: JAMES LUSTY
EMAIL: JAMES.LUSTY@TYPE-SIX.COM
SECONDARY CONTACT: DYLAN SCOTT
EMAIL: DYLAN.SCOTT@TYPE-SIX.COM

LEGAL DESCRIPTION

TRACT A OF THE CERTAIN LOT SPLIT SURVEY OF LOTS 12D, 12E AND 12F, EXECUTIVE HILLS NORTH, BLOCKS 12 AND 26, KANSAS CITY, PLATTE COUNTY, MISSOURI MORE PARTICULARLY DESCRIBED AS FOLLOWS: BEGINNING AT THE SOUTHWEST CORNER OF SAID LOT SPLIT, THENCE NORTH 13 DEGREES 32 MINUTES 44 SECONDS EAST, A DISTANCE OF 512.96 FEET; THENCE NORTH 25 DEGREES 46 MINUTES 55 SECONDS EAST, A DISTANCE OF 54.91 FEET TO A POINT ON THE SOUTHERLY RIGHT-OF-WAY LINE OF TIFFANY SPRINGS PARKWAY SAID POINT ALSO BEING A POINT OF CURVATURE; THENCE CONTINUING WITH SAID SOUTHERLY RIGHT-OF-LINE OF TIFFANY SPRINGS PARKWAY, ON A CURVE TO THE RIGHT, HAVING A RADIUS OF 272.00 FEET, A CENTRAL ANGLE OF 15 DEGREES 26 MINUTES 25 SECONDS, AN INITIAL TANGENT BEARING SOUTH 72 DEGREES 36 MINUTES 33 SECONDS EAST, AN ARC DISTANCE OF 73.38 FEET; THENCE CONTINUING WITH SAID SOUTHERLY RIGHT-OF-LINE OF TIFFANY SPRINGS PARKWAY, SOUTH 57 DEGREES 00 MINUTES 00 SECONDS EAST, A DISTANCE OF 146.18 FEET TO A POINT OF CURVATURE SAID POINT ALSO BEING ON THE WESTERLY RIGHT-OF-LINE OF NORTH POLO DRIVE; THENCE CONTINUING WITH SAID WESTERLY RIGHT-OF-LINE OF NORTH POLO DRIVE, ON A CURVE TO THE RIGHT, HAVING A RADIUS OF 35.00 FEET, A CENTRAL ANGLE OF 53 DEGREES 28 MINUTES 54 SECONDS, AN INITIAL TANGENT BEARING OF SOUTH 27 DEGREES 18 MINUTES 29 SECONDS EAST, AN ARC DISTANCE OF 32.67 FEET; THENCE ON A CURVE TO LEFT, HAVING A RADIUS OF 734.67 FEET, A CENTRAL ANGLE OF 29 DEGREES 56 MINUTES 16 SECONDS, AN ARC DISTANCE OF 375.91 FEET; THENCE SOUTH 88 DEGREES 18 MINUTES 00 SECONDS WEST, A DISTANCE OF 246.12 FEET TO THE POINT OF BEGINNING. THE ABOVE DESCRIBED TRACT CONTAINS 103,622 SQUARE FEET OR 2.38 ACRES.

DEVELOPMENT PLANS FOR LIVSMART STUDIOS KANSAS CITY SECTION 36, TOWNSHIP 52, RANGE 34 CITY OF KANSAS CITY, PLATTE COUNTY, MISSOURI

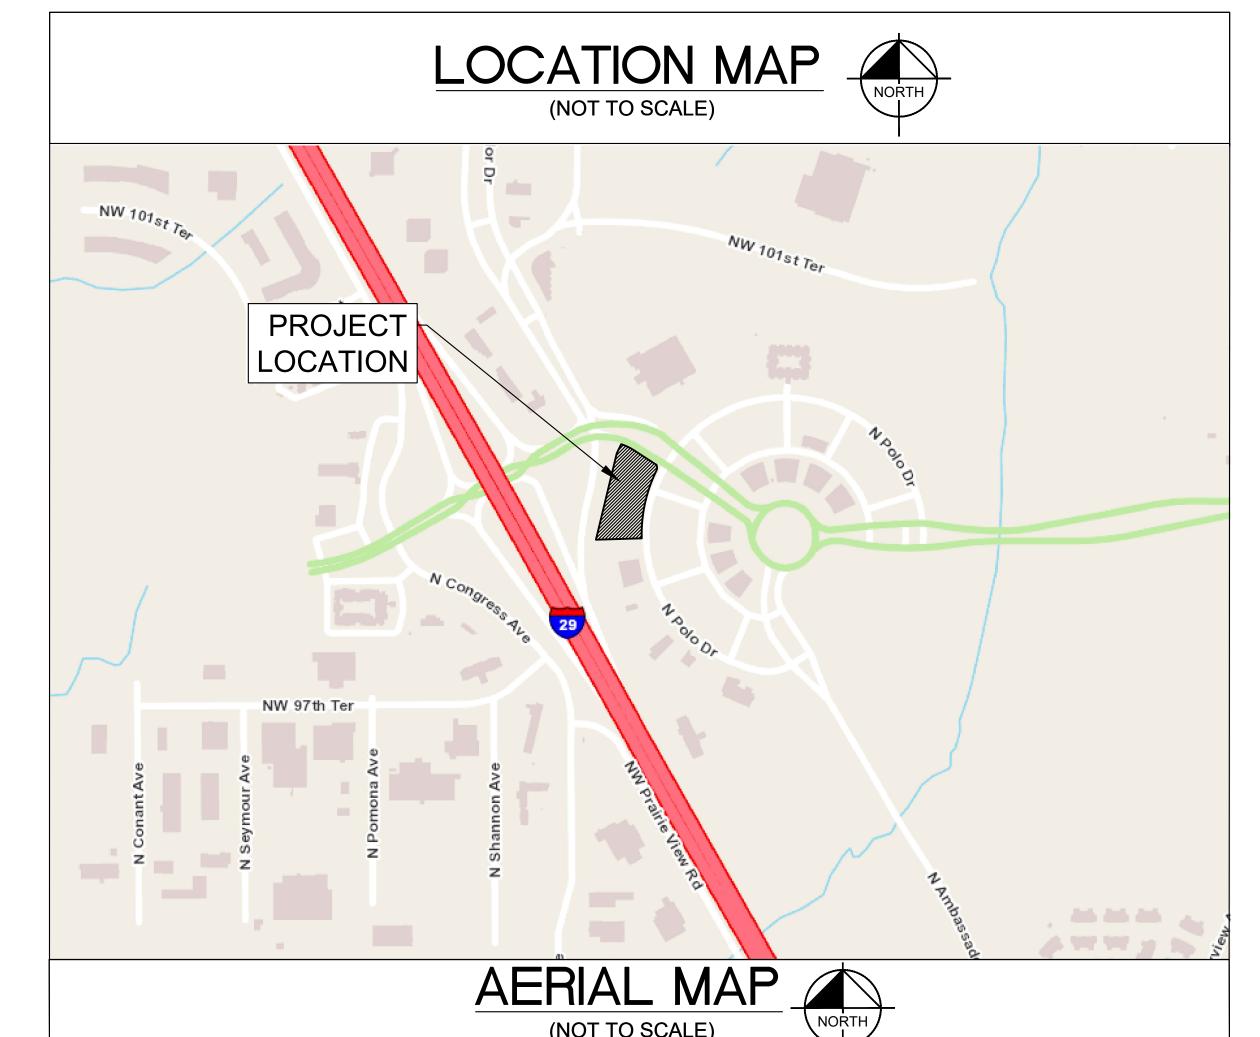

	(NOTTO SCALE)
	ATRIUM FINANCE II LP 7640 NW TIFFANY SPRINGS PKWY
PROJECT (ATRIUM FINANCE II LP 7620 NW TIFFANY SPRINGS PKWY
LOCATION	
	CORPORATE CIRCLE APARTMENTS LLC 7410 NW TIFFANY SPRINGS PKWY
	SPONI
	SPRINGS PARMAN
	WAL THE RESERVE TO TH
	CORPORATE CIRCLE OFFICES LLC 7509 NW TIFFANY SPRINGS PKWY
	CORPORATE CIRCLE OFFICES LLC 7505 NW TIFFANY SPRINGS PKWY
S4 PROPERT 9800 N POI	TES LLC
	300' PROPERTY
	BOUNDARY OFFSET
	E Control of the cont

	Sheet List Table
Sheet Number	Sheet Title
C0	COVERSHEET
C1	EXISTING CONDITIONS
C2	SITE PLAN
C3	GRADING PLAN
C4	UTILITY PLAN
C5	FIRE TRUCK TURNING
L1	LANDSCAPE ARCHITECTURAL PLAN
A20.00	3D BUILDING VIEWS
A1.01	01 DIMENSION PLAN
A1.02	02 DIMENSION PLAN
A5.01	BUILDING ELEVATIONS
A5.02	BUILDING ELEVATIONS
A0.03	SITE ELEMENTS
PH1.01	PHOTOMETRICS
PH1.02	LIGHT FIXTURE DETAILS

Property Owner	Property Address	Mailing Address
S4 Properties LLC	9800 N Polo Dr	118 N Conistor Ln Ste B
34 Troperties ELC	3800 14 1 010 01	#504 Liberty, MO 64068
	7505 NW Tiffany Springs	7505 NW Tiffany Springs
Corporate Circle Offices LLC	Pkwy, 7509 NW Tiffany	Pkwy Ste 100 Kansas City,
	Springs Pkwy	MO 64153
	7410 NIM Tiffany Carings	7505 NW Tiffany Springs
Corporate Circle Apartments LLC	7410 NW Tiffany Springs	Pkwy Ste 100 Kansas City,
	Pkwy	MO 64153
	7620 NW Tiffany Springs	12725 Marris Dd Eyt Cta
Atrium Finance II LP	Pkwy, 7640 NW Tiffany	12735 Morris Rd, Ext, Ste
	Springs Pkwy	400 Alpharetta, GA 30004

DEVELOPMENT PLAN DEVIATIONS

BUILDING HEIGHT EXCEEDS MAXIMUM HEIGHT OF 55' ALLOWED FOR ZONING
 B3-3. REQUESTING DEVIATION TO ALLOW FOR INCREASE OF MAXIMUM
 BUILDING HEIGHT BY 5' TO ALLOW FOR 60' MAX.

2.

DEVELOPMENT PLAN VARIANCES

1. PER SECTION 88-323-02-B, IF ADJACENT TO AND WITHIN 150 FEET OF A PARKWAY, PARKING LOCATED ON THE SIDE OF A BUILDING SHALL BE SET BACK A MINIMUM OF 10 FEET BEHIND THE FRONT BUILDING LINE OR 30 FEET FROM THE RIGHT-OF-WAY, WHICHEVER IS GREATER. WITH THE PLATTED 50' BUILDING SETBACK FROM NW TIFFANY SPRING PARKWAY, THIS REQUIREMENT CREATES A 60' PARKING SETBACK (10' FURTHER THAN THE PLATTED SETBACK). DUE TO SITE CONSTRAINTS, THE PLAN IS SEEKING A VARIANCE FROM THE ABOVE SECTION, TO ALLOW PARKING WITHIN 10' OF THE EXISTING R/W LINE. IF THE VARIANCE IS NOT GRANTED BY THE BZA, THE PLAN WILL BE REVISED TO RECONFIGURE THE 10 PARKING SPACES IDENTIFIED IN THIS PLAN, LOCATED OFF THE NORTHEAST CORNER OF THE BUILDING.

DESIGNED BY: KMR
DRAWN BY: KMR
CHECKED BY: MDK

PRELIMINARY CONSTRUCTION


OVERSHEET


VSMART STUDIOS
KANSAS CITY
DEVELOPMENT PLAN
10000 N POLO DR.
KANSAS CITY, MO 64153


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> 268432000 SHEET NUMBER


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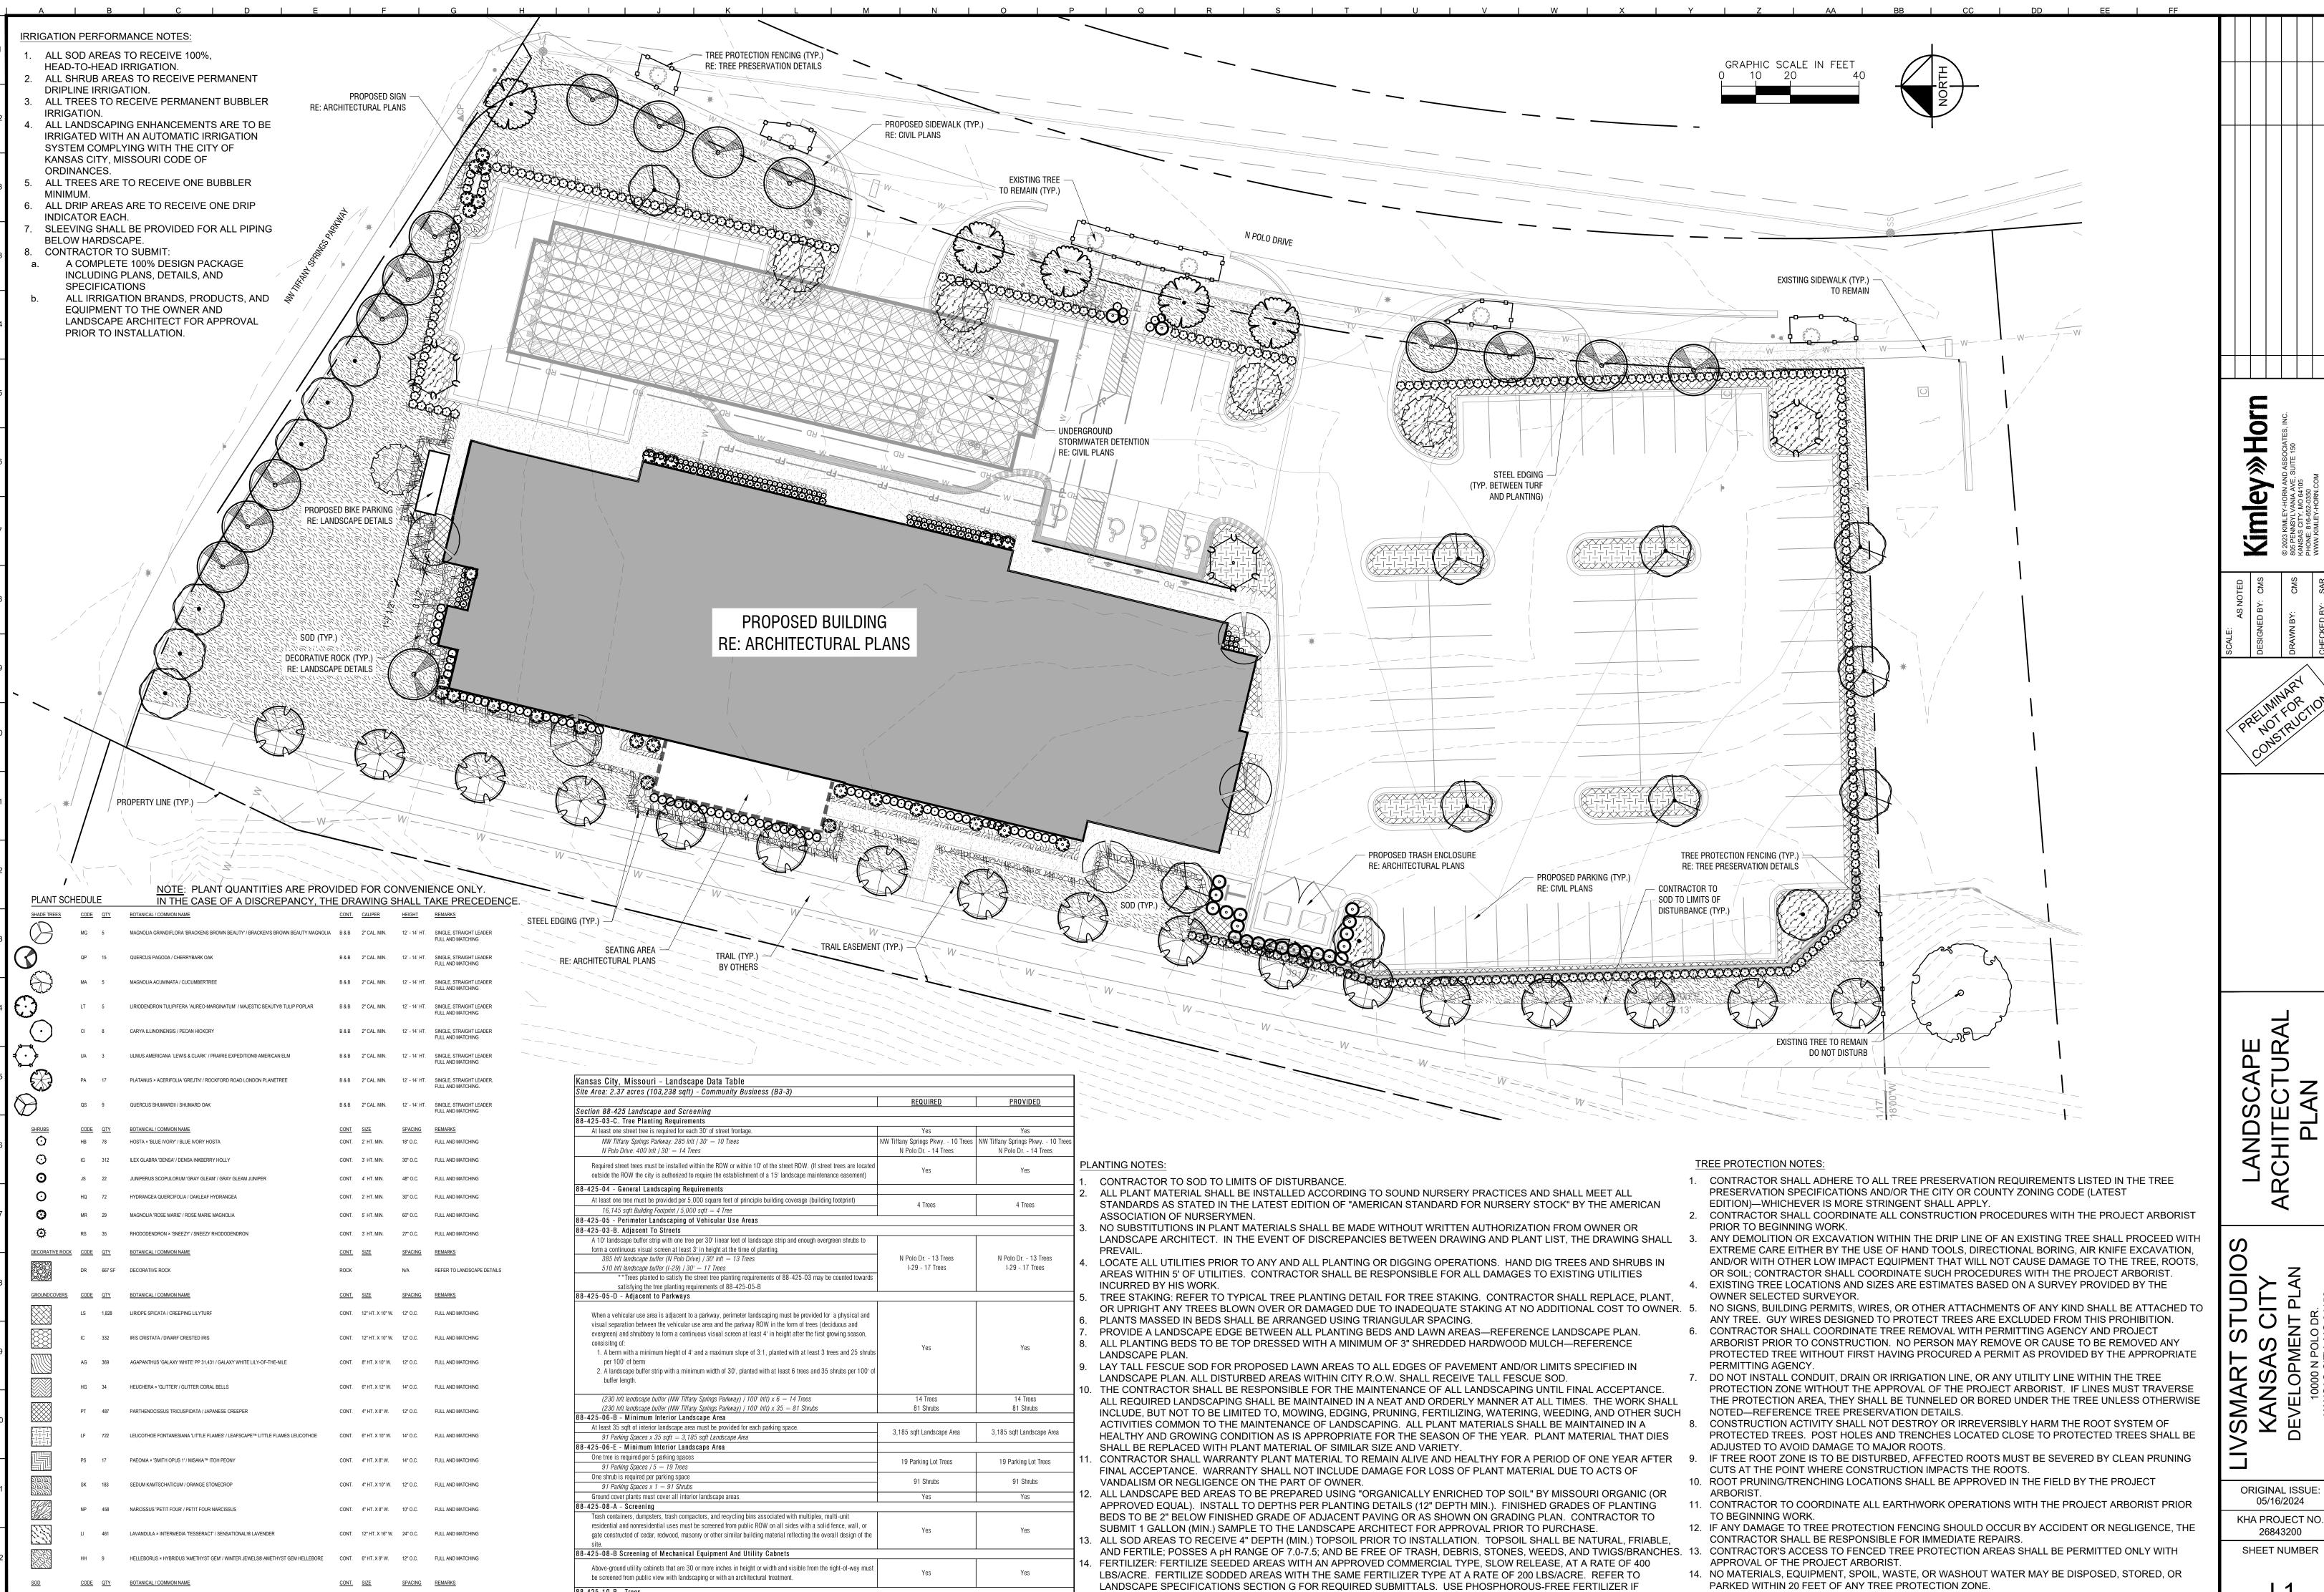




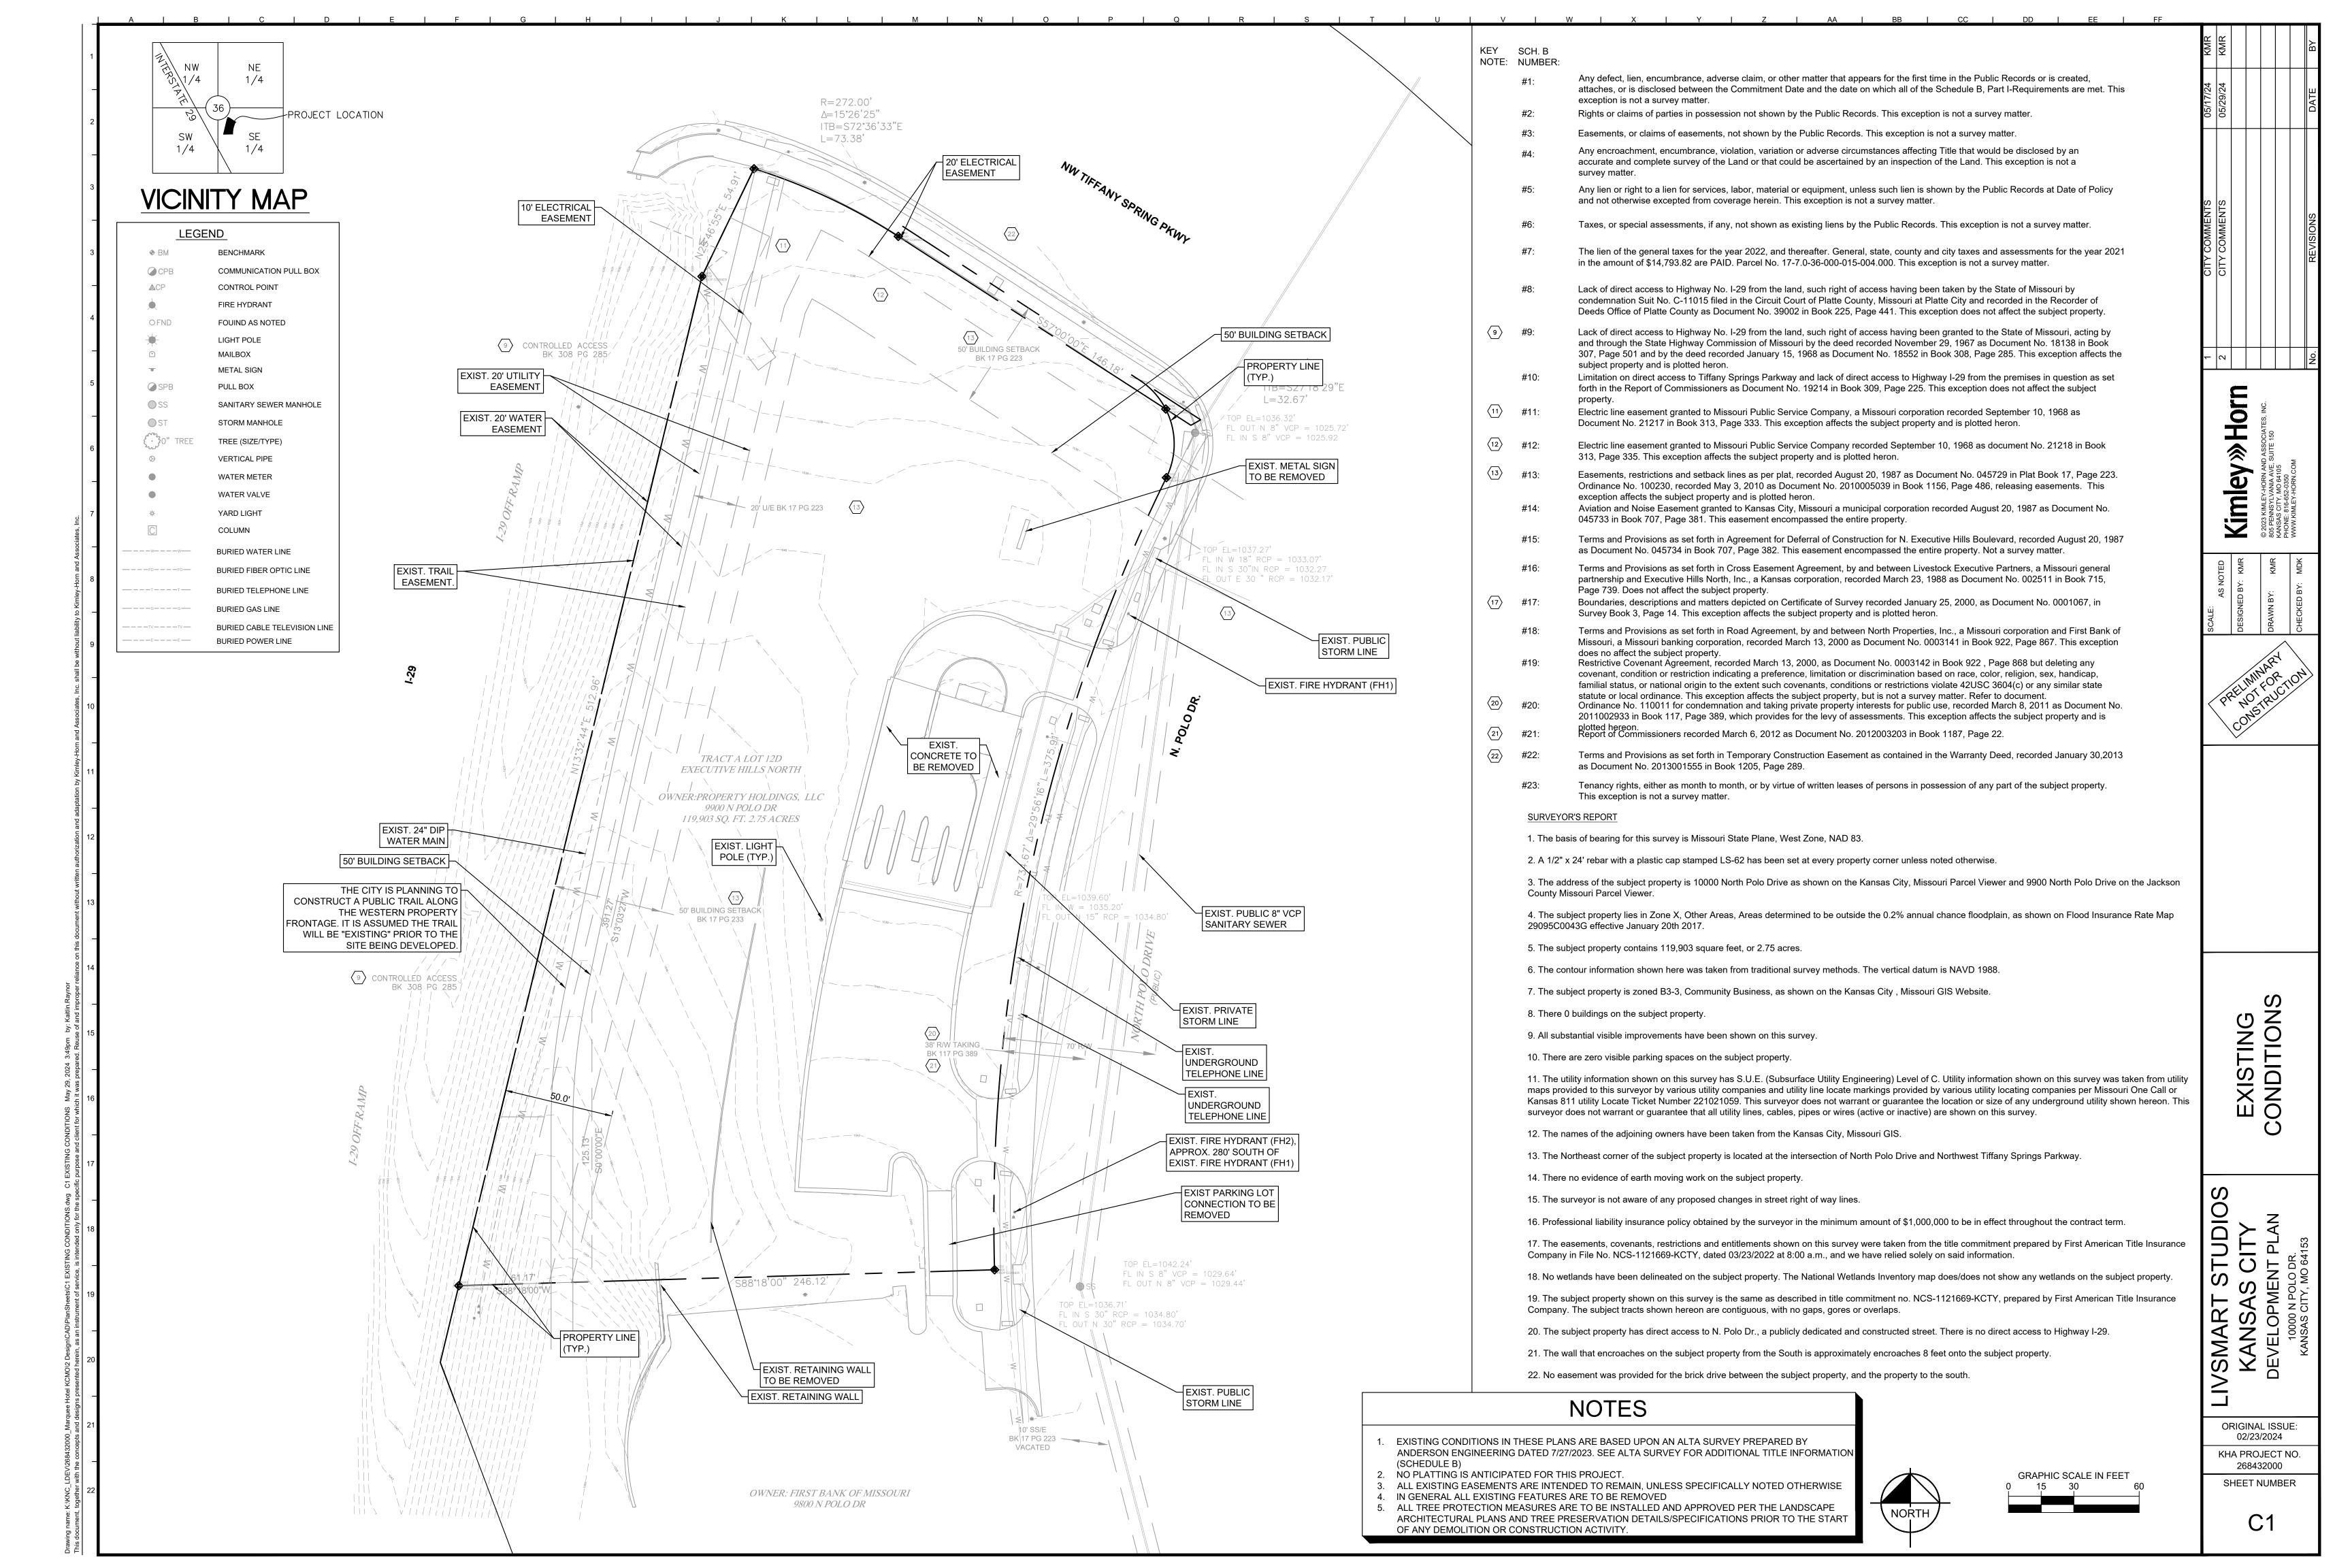

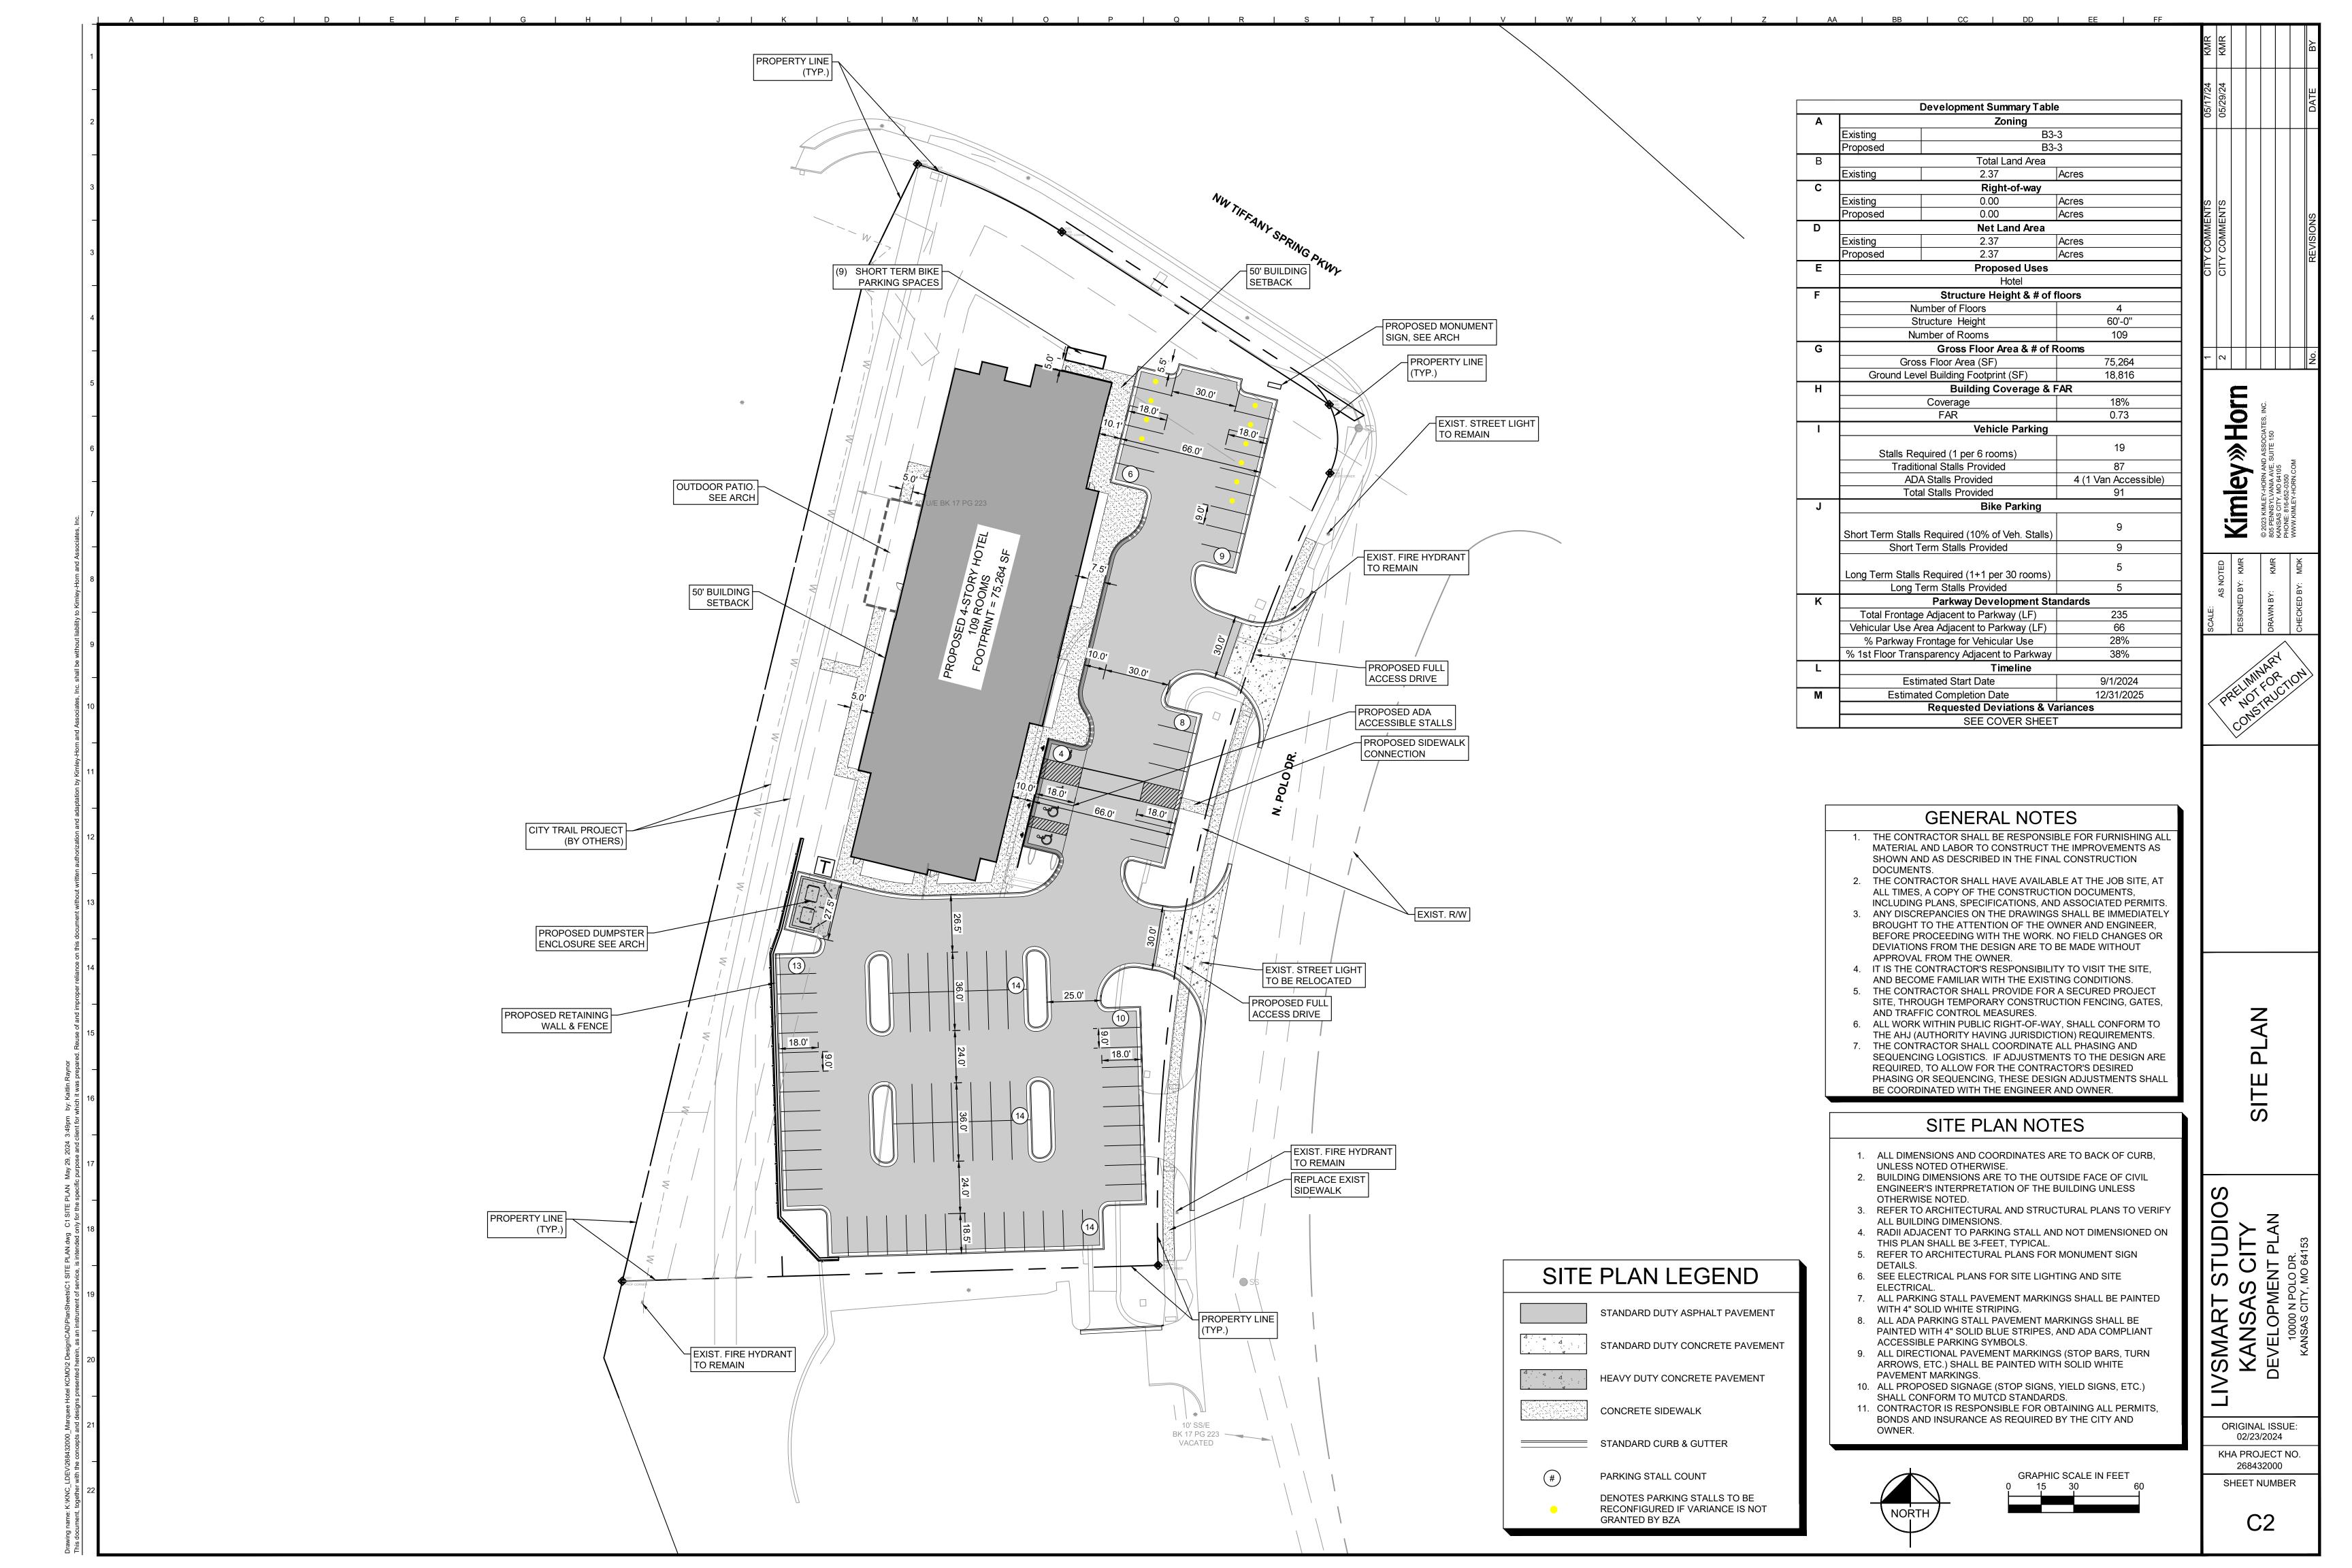

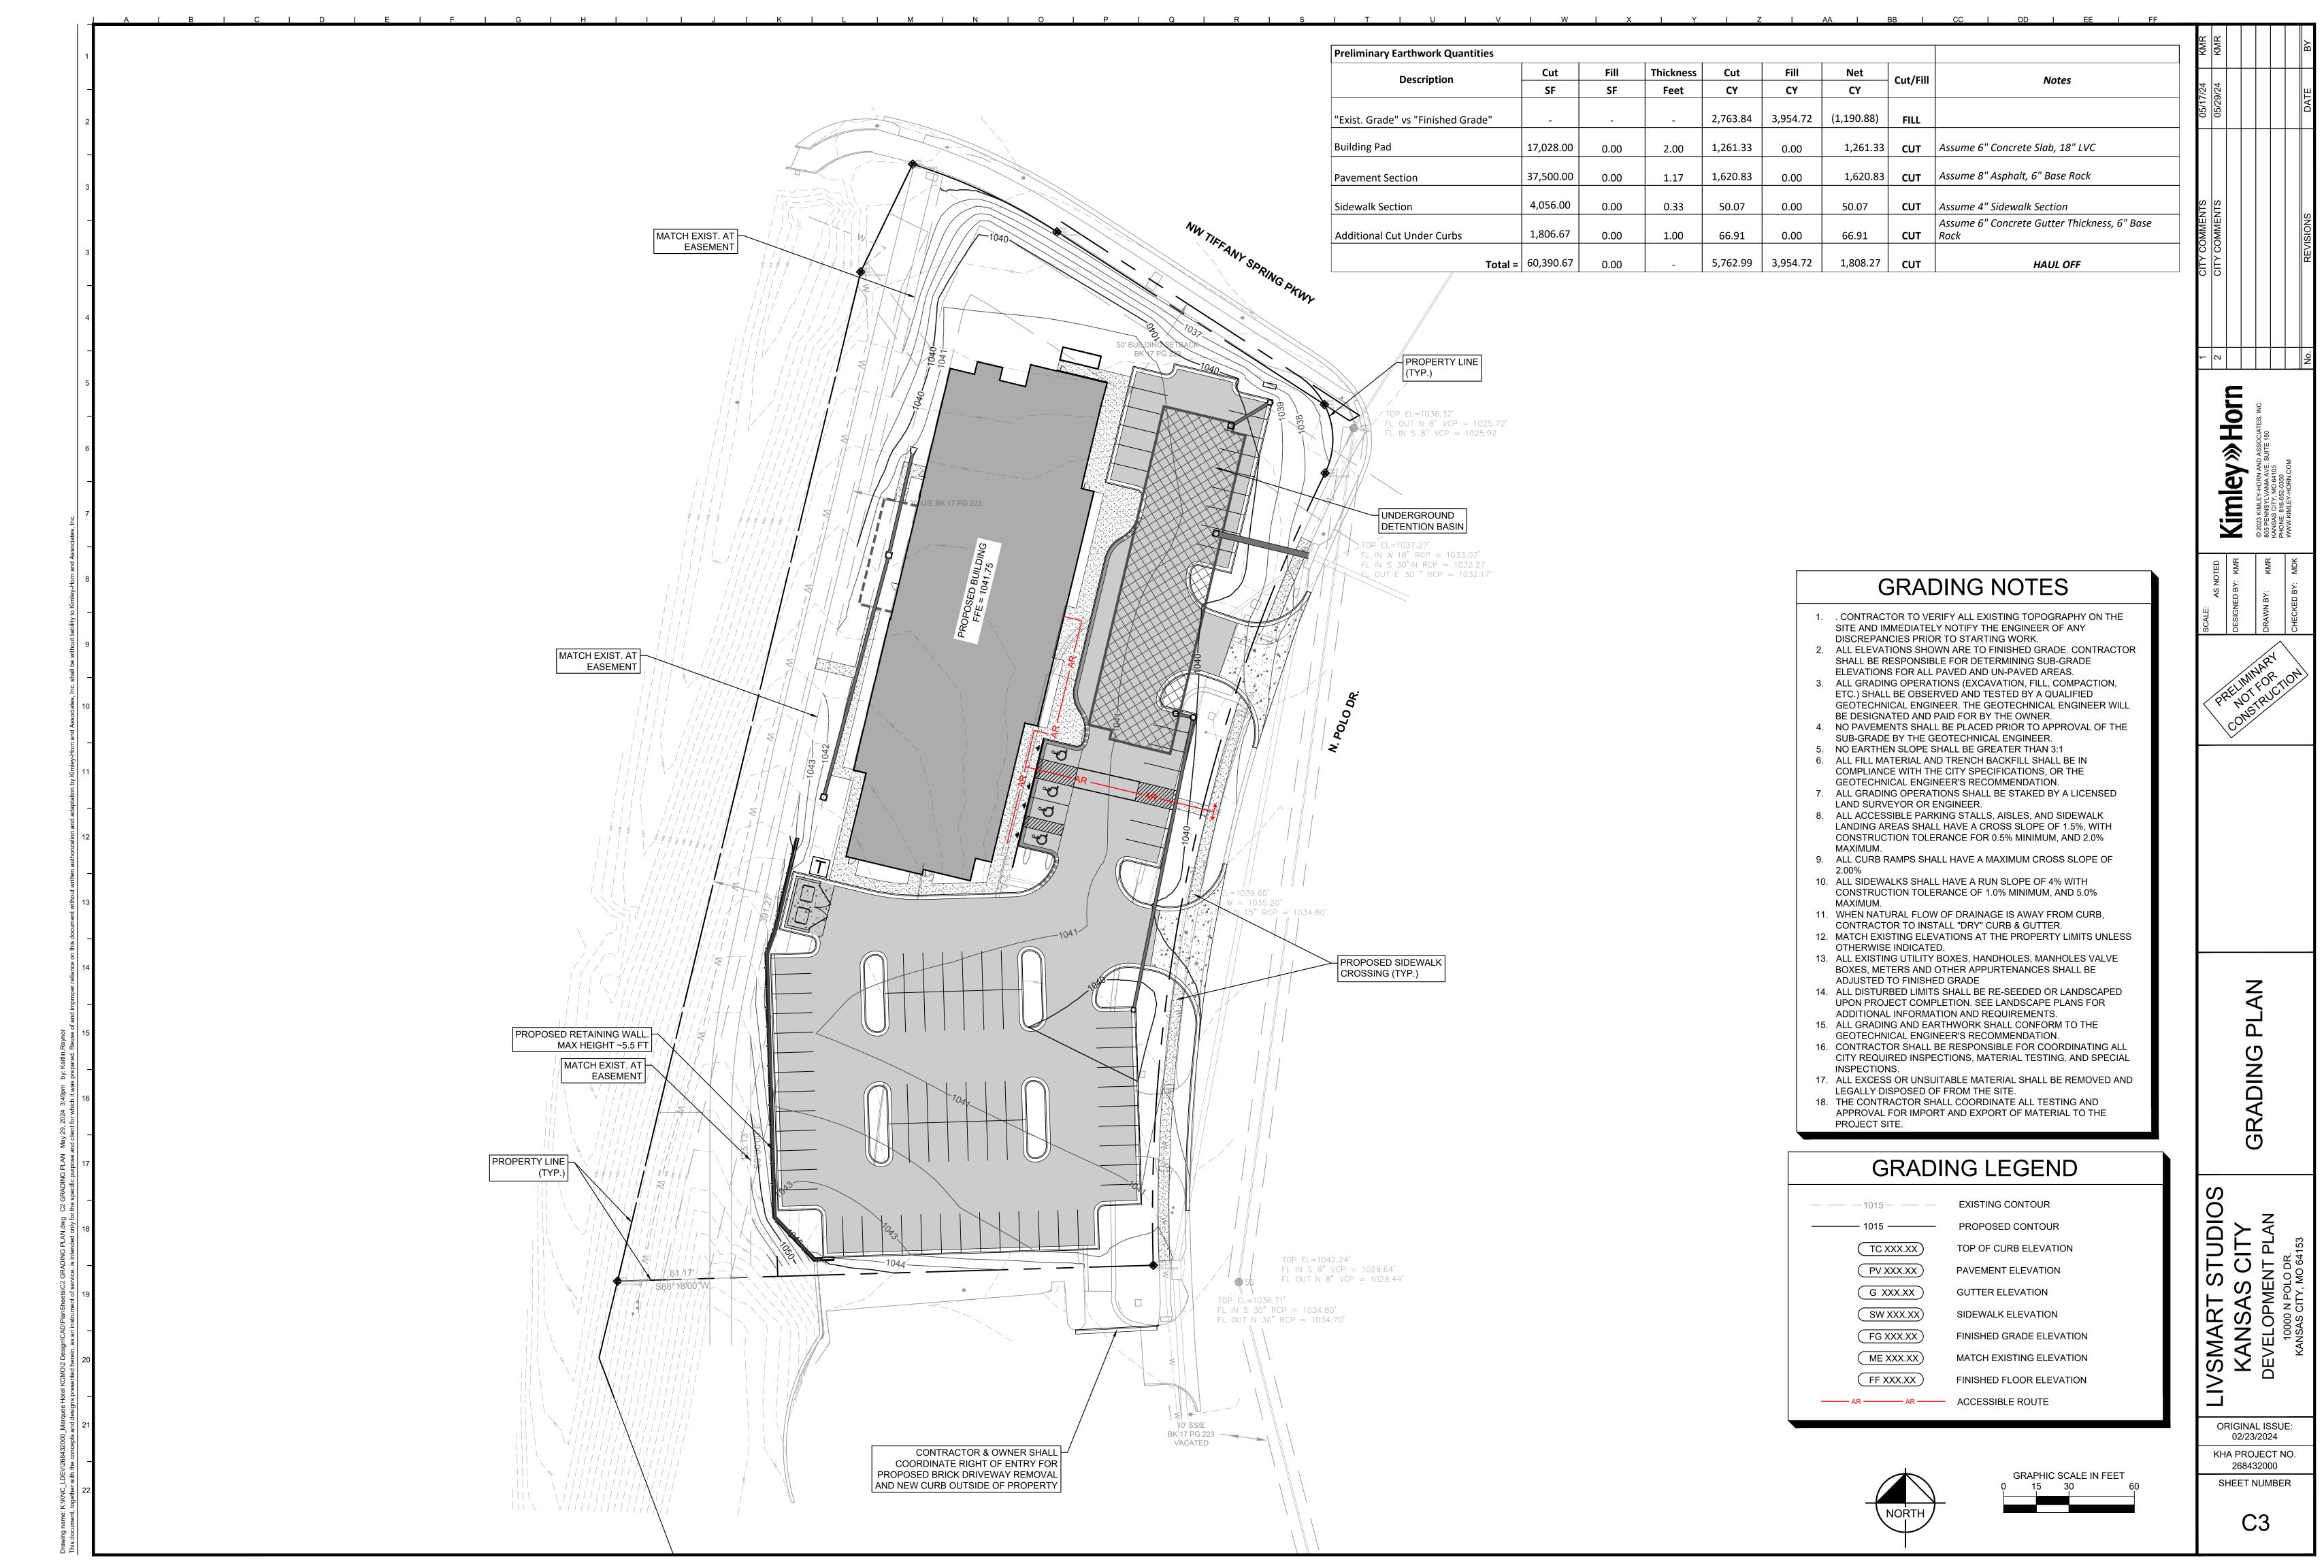

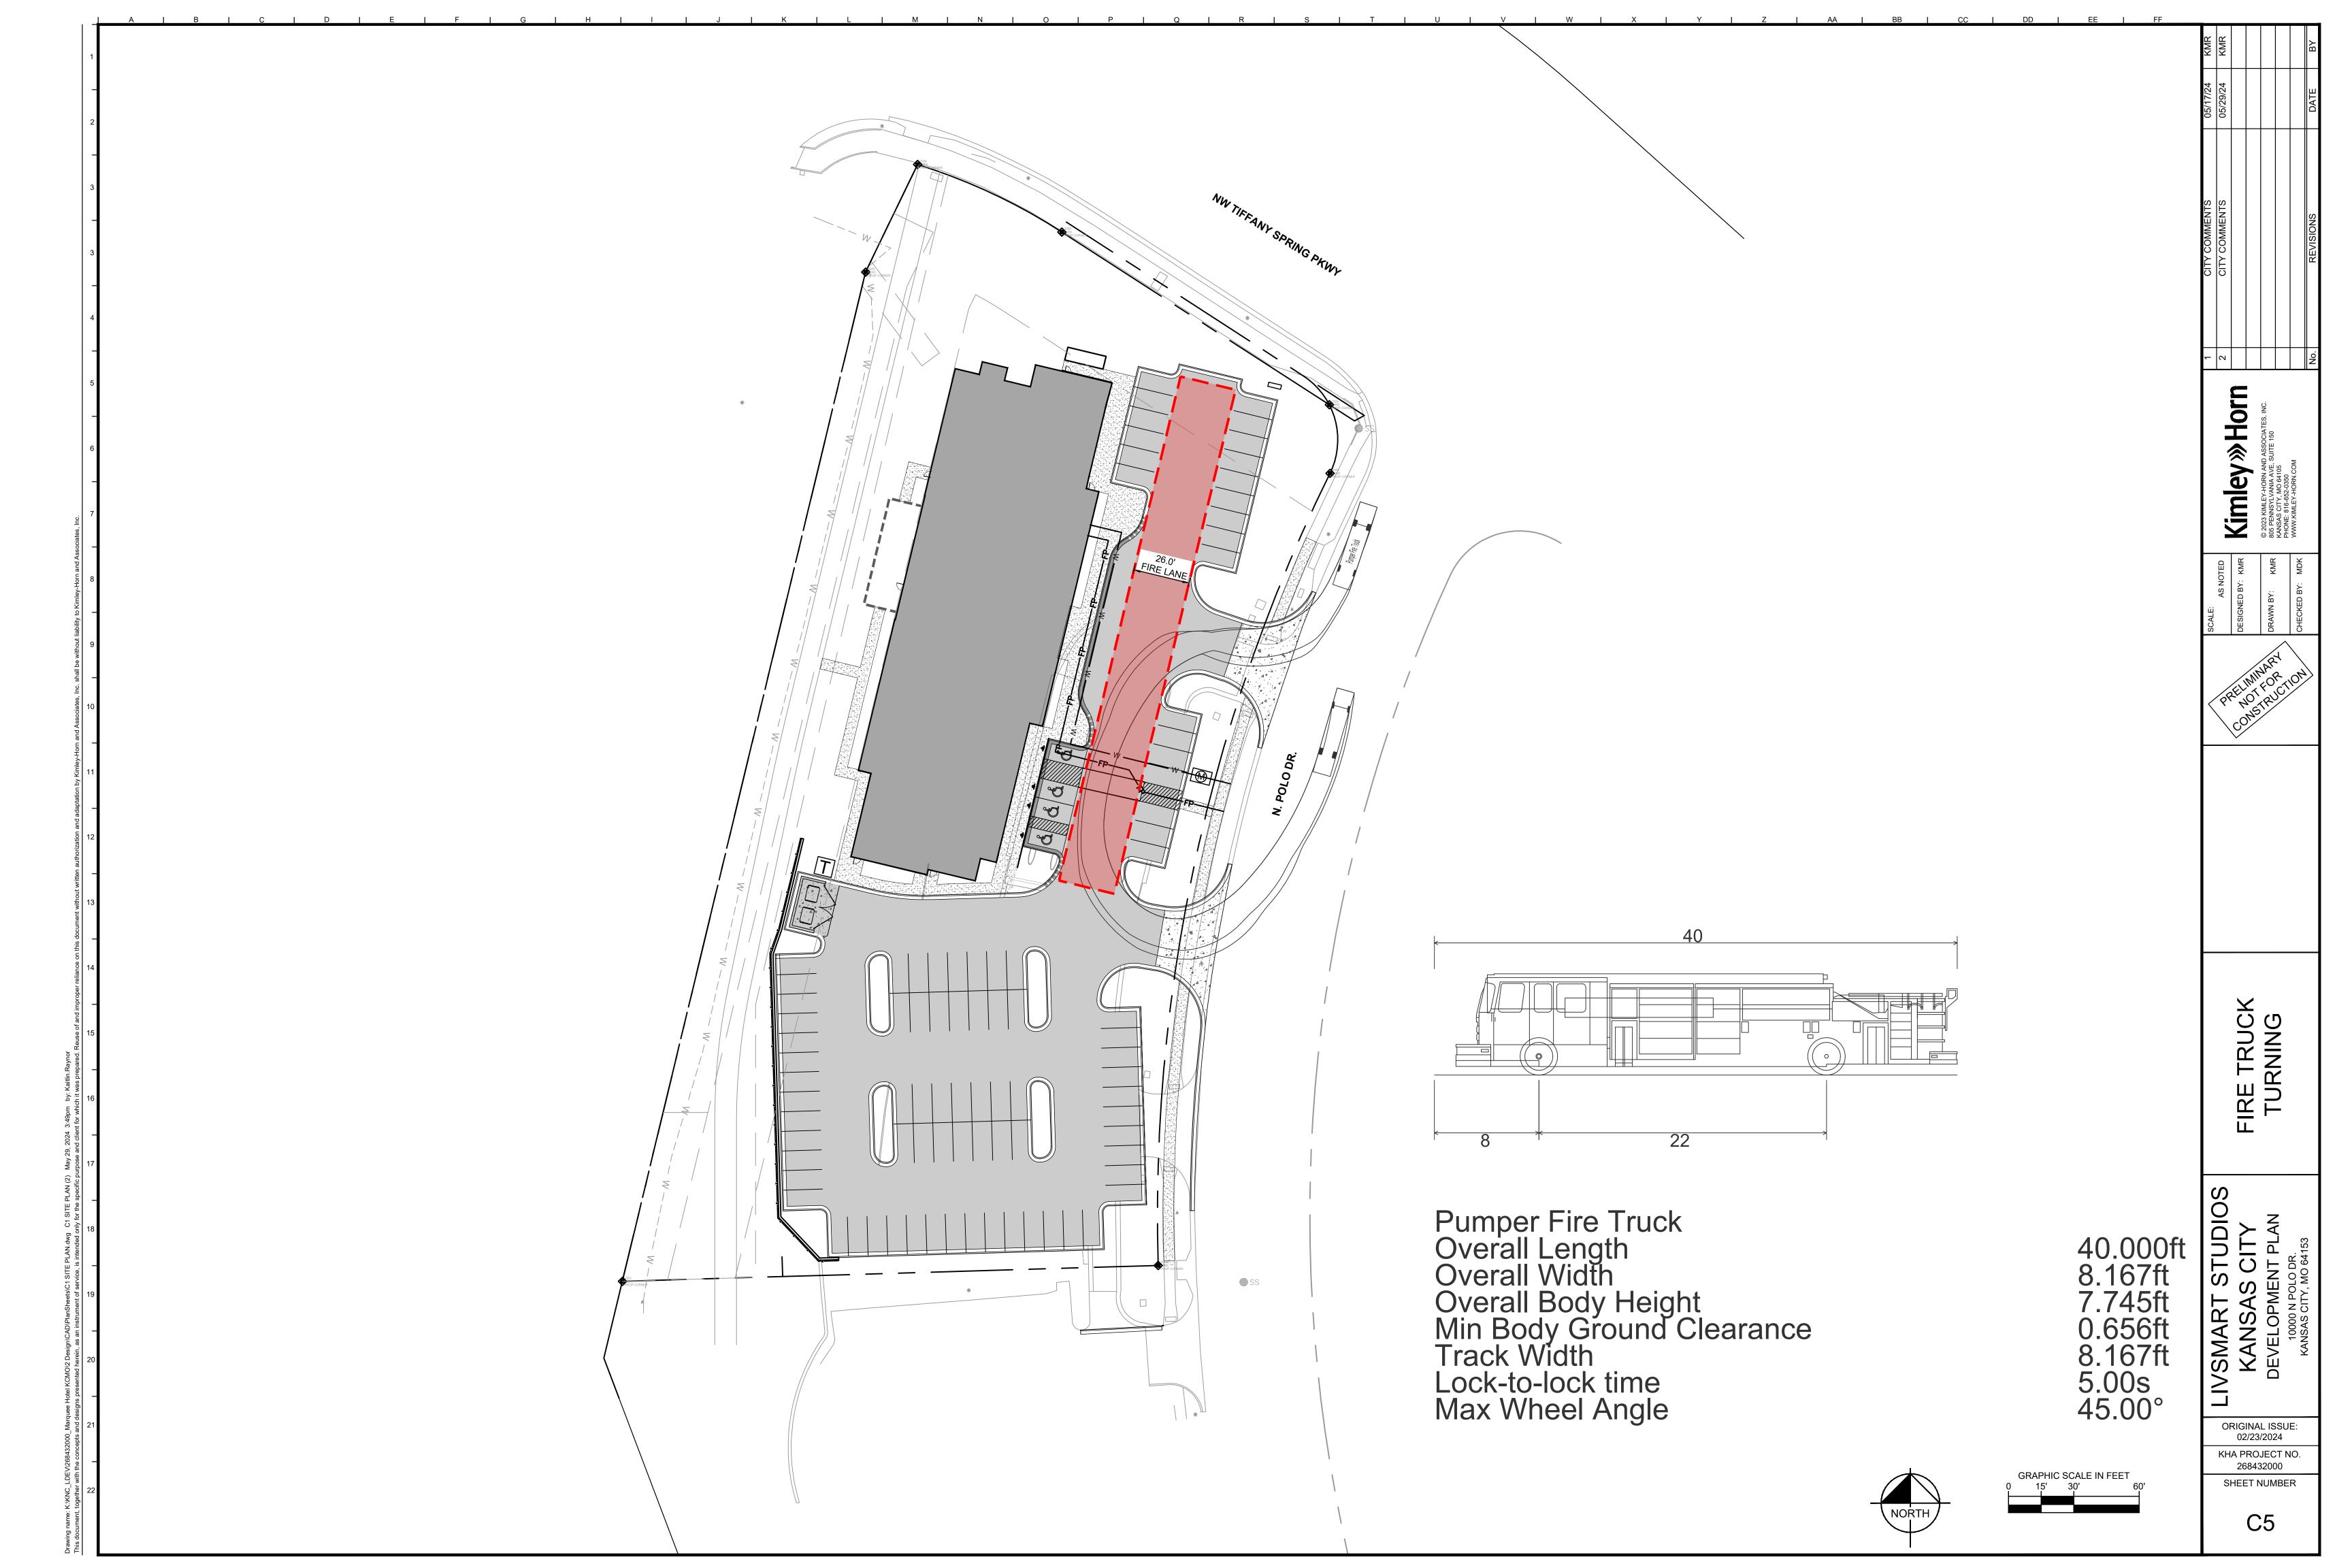

REQUIRED BY LOCAL CODE.

15. REFER TO THE LANDSCAPE SPECIFICATIONS FOR REQUIRED SUBMITTALS.

88-425-10-B - Trees

no more than 25% may be of a single species.

If more than 8 trees are required, no more than 40% may be of a single species. If more than 25 trees are required,

SOD 16,249 SF TALL FESCUE / FESTUCA ARUNDINACEA

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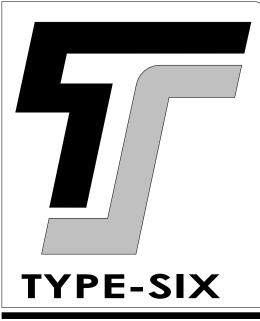
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ORIGINAL ISSUE: 05/16/2024

26843200 SHEET NUMBER

15. CONTRACTOR SHALL COORDINATE WITH THE PROJECT ARBORIST PRIOR TO REMOVAL OF TREE

PROTECTION FENCING.



TYPE-SIX
DEVELOPMENT SERVICES, LLC 910 SOUTH MAIN STREET #150 GRAPEVINE, TEXAS 76054 972.677.9075

ARCHITECT

D. HAYES HINKLE

ISSUE DATE 17 MAY 2024 ISSUED FOR

REVIEW

Revision


SHEET NAME RENDER CONCEPT

SHEET NUMBER

A20.00





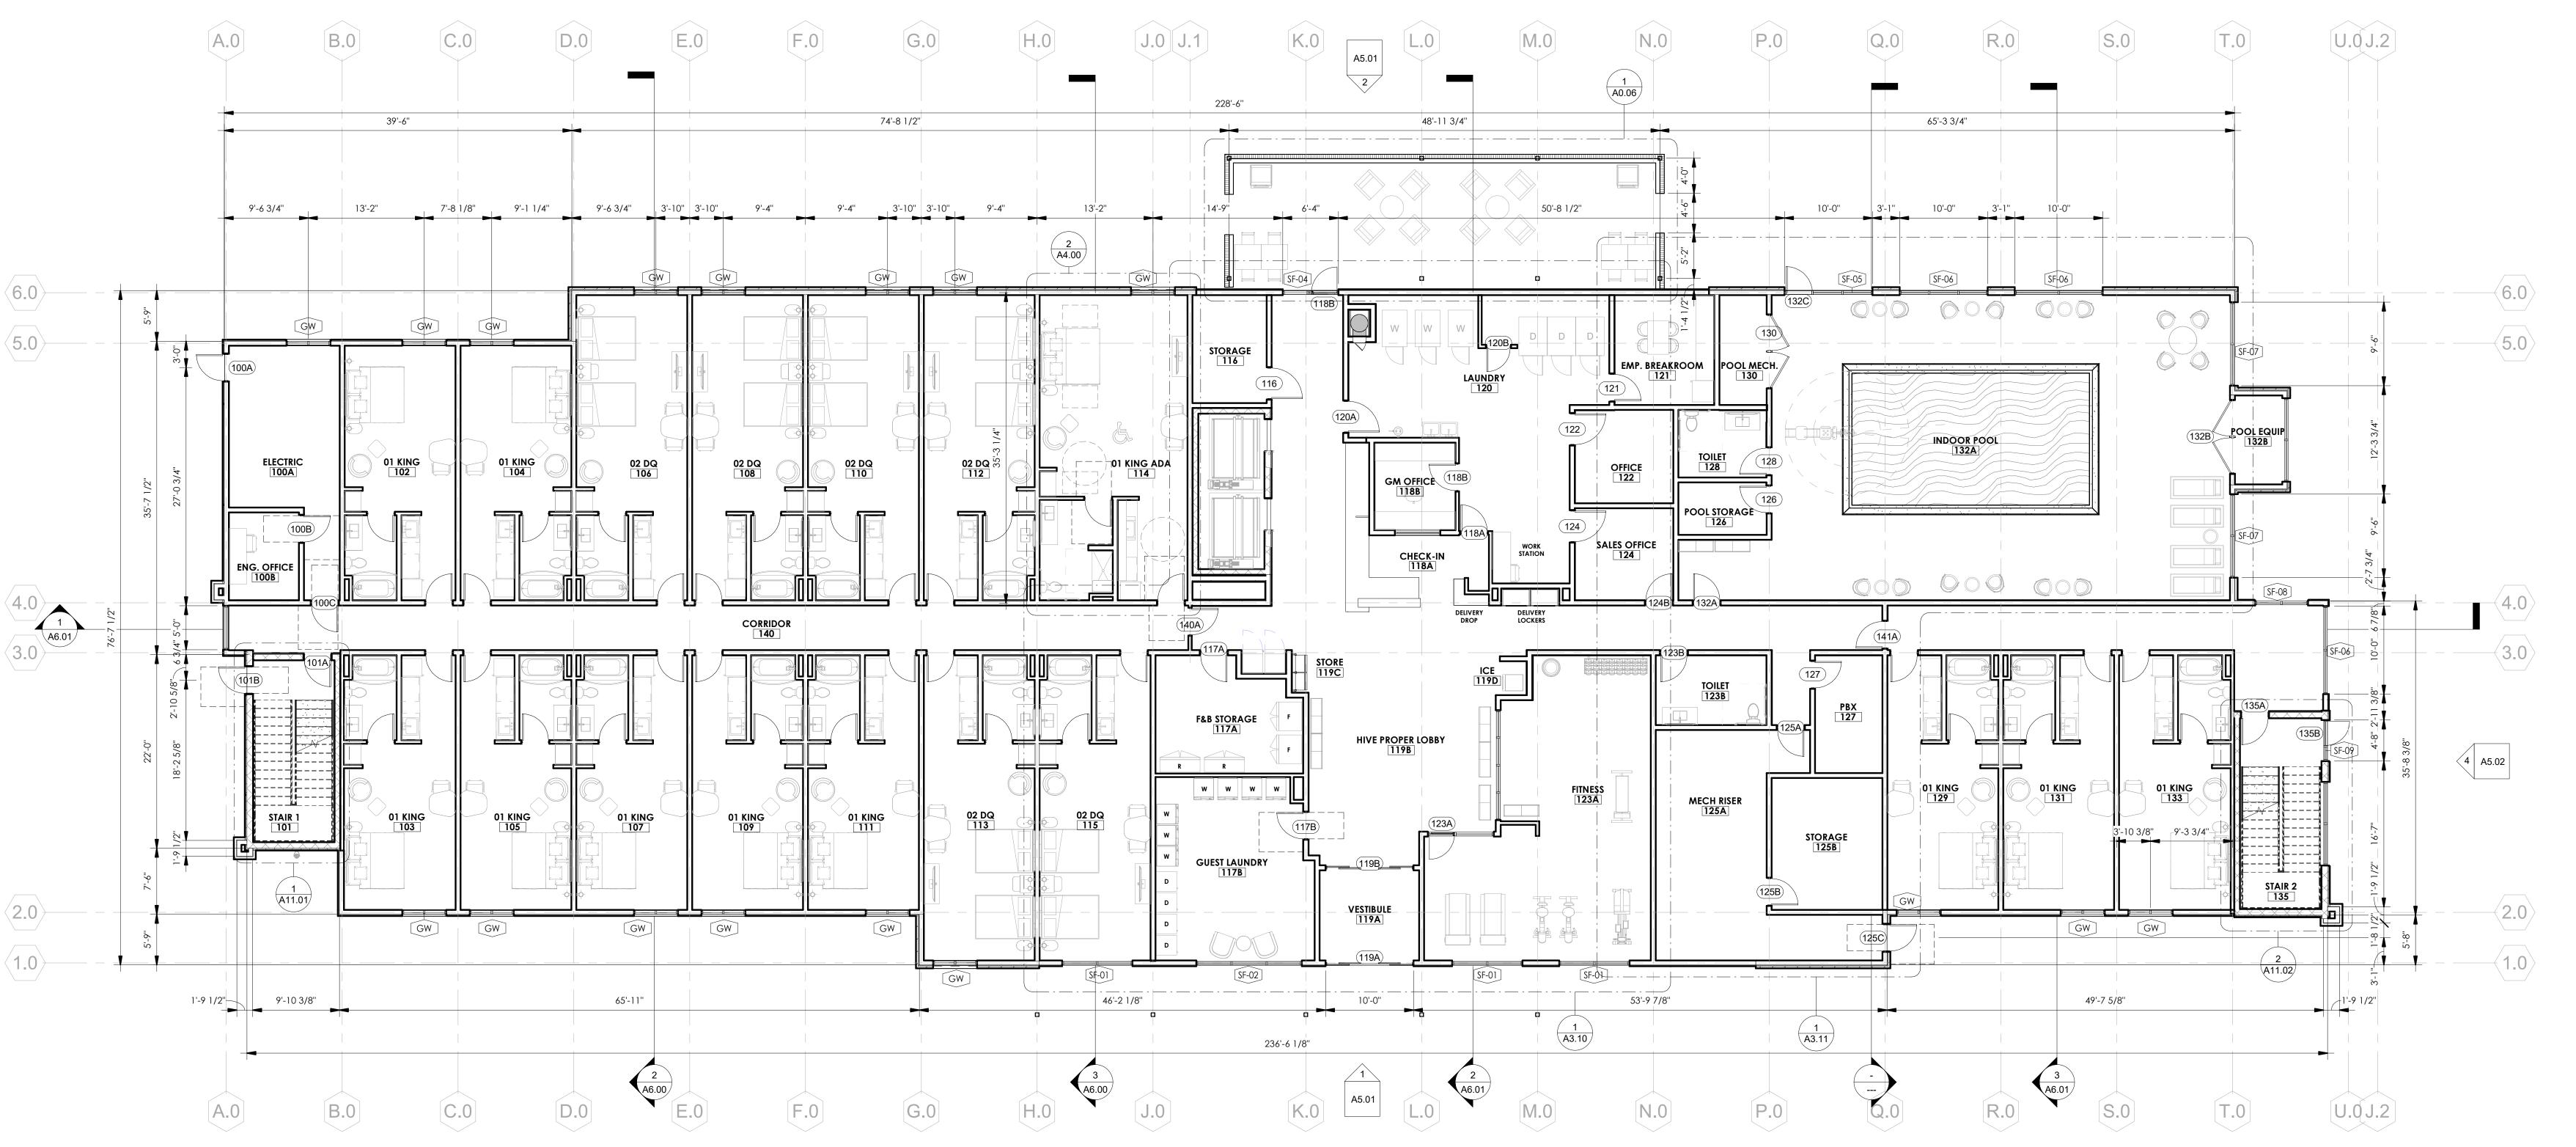

GENERAL FLOOR PLAN NOTES PROVIDE TACTILE SIGNAGE OUTSIDE THE TOILET ROOM PER 24. ALL STRUCTURAL STEEL COLUMNS AND BEAMS REQUIRED TO 18. TYPICAL AT EXPOSED SIDES OF CONCRETE COLUMNS 1. THE GENERAL CONTRACTOR SHALL NOTIFY THE ARCHITECT BE PROTECTED TO MEET A FIRE RATING SHALL BE 1110.1 AND ICC/ANSI A117.1. MOUNT BOTTOM OF UNLESS OTHERWISE NOTED -PROVIDE 5/8" GYPSUM BOARD OF ANY DISCREPANCIES BETWEEN THE DRAWINGS, THESE CHARACTERS AT 48" MIN. AND 60" MAX ABOVE FLOOR. INDIVIDUALLY PROTECTED PRIOR TO INSTALLATION OF OVER 1 1/2" METAL STUDS AT 16" O.C. AND EXTEND ABOVE NOTES AND FIELD CONDITIONS BEFORE COMMENCING ADJACENT PARTITIONS, WALLS, CEILINGS OR ROOF ANY WORK AND REQUEST CLARIFICATION. PROVIDE STAINLESS STEEL CORNER GUARDS AT ALL OUTSIDE CORNERS IN KITCHEN, LAUNDRY ROOMS, STORAGE, ALL GYPSUM BD. FINISH FACES OF DIFFERING SUBSTRATES 2. REFER TO A8.00 FOR PARTITION TYPES 11. FURNITURE, FIXTURES AND EQUIPMENT (FFE) ARE TO BE MAINTENANCE AND BACK-OF-HOUSE CORRIDORS. (i.e. 1 1/2" MTL. FURRING ADJACENT TO 3 5/8" METAL STUDS) COORDINATED WITH OWNER. CONTRACTOR TO PROVIDE PROVIDE PLASTIC CORNER GUARDS AT ALL OUTSIDE REFER TO SHEET A15.00 FOR DOOR SCHEDULES, DOOR RESPONSIBILITY MATRIX TO ENSURE ALL ELEMENTS ARE **GENERAL FLOOR PLAN SYMBOLS** CORNERS IN BACK-OF-HOUSE WORK ROOMS AND OFFICES. HOTEL INFORMATION FRAMES AND DOOR TYPES REFERENCE SPECIFICATION SECTION 102600 FOR TYPES AND 26. ACCOUNTED FOR. REFER TO A9 SHEETS FOR ENLARGED GUESTROOM HEIGHTS OF CORNER GUARD. ALL OUTSIDE CORNERS AT INFORMATION. REFER TO G SERIES SHEETS FOR CODE REFERENCES, CODE **BUILDING SF** PROVIDE NECESSARY BLOCKING FOR SURFACE MOUNTED BACK-OF-HOUSE AREAS ARE TO HAVE CORNER GUARDS. KEYNOTE TAG - REFENCE KEYNOTE SCHEDULE COMPLIANCE PLANS, PENETRATION DETAILS AND FIXTURES, ACCESSORIES, AND EQUIPMENT. REFER TO INTERIOR DESIGN DRAWING FOR CORNER FINAL ROOM NAMES AND SIGNAGE SHALL BE CONFIRMED ACCESSIBILITY INFORMATION. GUARDS AT PUBLIC AREAS TO BE PROVIDED BY GC. BY OWNER PRIOR TO PURCHASE AND INSTALLATION. UPPER FLOOR SF: 18,816 SF 101 DOOR TAG - REFENCE DOOR SCHEDULE A15.00 13. FINISHES SHALL MEET PROPER FLAME SPREAD AND SMOKE 75,264 SF TOTAL SF: PROVIDE ACCESSIBLE GUEST ROOMS PER THE TEXAS SPREAD, 2015 IFC, SECTION 803. 20. ALL WALL OUTLETS ON ELEVATIONS ARE DIMENSIONED TO ACCESSIBILITY STANDARDS. REFER TO G SERIES SHEETS FOR CENTER LINE, UNLESS NOTED OTHERWISE. ADDITIONAL INFORMATION. BUILDING INFORMATION STORFRONT TAG - REFERENCE WINDOW SCHEDULE A16.00 14. CAULK CONTINUOUSLY AT PERIMETER OF DOOR AND NUMBER OF FLOORS: 4 FLOORS WINDOW FRAMES. CAULK AFTER WALL COVERING IS 21. ALL DEVICES ADJACENT TO WET AREAS SHALL BE GFCI PER 6. ALL DIMENSIONS ARE TO FACE OF STUD, CONCRETE, NUMBER OF GUESTROOMS: 109 NEC REQUIREMENTS. INSTALLED. WINDOW TAG - REFERENCE WINDOW SCHEDULE A16.00 MASONRY OR TO THE GRID LINE, UNLESS NOTED OTHERWISE. REFER TO STRUCTURAL FOR SLAB DIMENSIONS. REFER TO MOUNTING HEIGHT SCHEDULE FOR TOILET AND 22. ALL WOOD BLOCKING AND PLYWOOD IN EXTERIOR WALLS, PARAPETS, AND ROOF CONSTRUCTION SHALL BE EXTERIOR BATH ACCESSORIES IN ALL BATHROOMS. **AMENITIES** PARTITION TAG - REFERENCE PARTITION SCHEDULE A8.00 7. ALL GRID LOCATIONS AND GRID DIMENSIONS ARE TO BE (PRESSURE) AND FIRE RETARDANT-TREATED (FRTW). ALL INDOOR POOL VERIFIED BY CONTRACTOR PRIOR TO COMMENCEMENT OF SIGNAGE IS OWNER PROVIDED. SIGNAGE SHALL MEET INTERIOR PLYWOOD SHALL BE FIRE RETARDANT-TREATED OUTDOOR LOUNGE BUILDING CODE REQUIREMENTS AND ANSI A117.1 (FRTW). ONLY INTERIOR MISCELLANEOUS WOOD BLOCKING room ada symbol REQUIREMENTS FOR ACCESSIBILITY. SHALL BE ALLOWED TO BE NON FIRE-RETARDANT TREATED CORPORATE OFFICE ALL MISCELLANEOUS SUPPORT STEEL EXPOSED TO THE AND INTERIOR WOOD BLOCKING ADJACENT TO CONCRETE EXTERIOR SHALL BE GALVANIZED AND COATED WITH A 17. PROVIDE TACTILE EXIT SIGNS AT EXIT DOOR LOCATIONS. OR MASONRY SHALL BE PRESSURE TREATED. GUESTROOM MIX HIGH-PERFORMANCE COATING, UNLESS NOTED ROOM HEARING IMPAIRED SYMBOL SIGNAGE SHALL COMPLY WITH ICC/ANSI A117.1. AT OTHERWISE. STOREFRONT LOCATION, PROVIDE TACTILE SIGN THAT FITS WHERE MECHANICAL AND ELECTRICAL DEVICES AND FLOOR 1 2 3 4 TOTAL WITHIN THE STOREFRONT MULLION FRAME WIDTH. MOUNT PARTS ARE CONCEALED AND REQUIRE ACCESS, PROVIDE CR CARD READER PROVIDE AUTOMATIC FIRE SUPPRESSION SYSTEM FOR 19 20 65 BOTTOM OF CHARACTERS AT 48"MIN. AND 60"MAX. ABOVE ACCESS DOORS AND FRAMES PER SPECIFICATIONS. FIRE ENTIRE BUILDING PER NFPA 13. SYSTEM SHALL BE UNDER RATED ASSEMBLIES SHALL BE MAINTAINED. FINISH FLOOR. K | 11 11 11 11 44 SEPARATE PERMIT. COORDINATE WITH CERTIFIED FIRE FIRE EXTINGUISHER SPRINKLER CONTRACTOR. TOTAL GUESTROOMS 109

TYPE-SIX

TYPE-SIX DEVELOPMENT SERVICES, LLC 910 SOUTH MAIN STREET #150 Grapevine, texas 76054

972.677.9075

ARCHITECT

D. HAYES HINKLE

ISSUE DATE 29 MAY 2024


ISSUED FOR **REVIEW**

Revision

SHEET NAME

01 DIMENSION PLAN

SHEET NUMBER

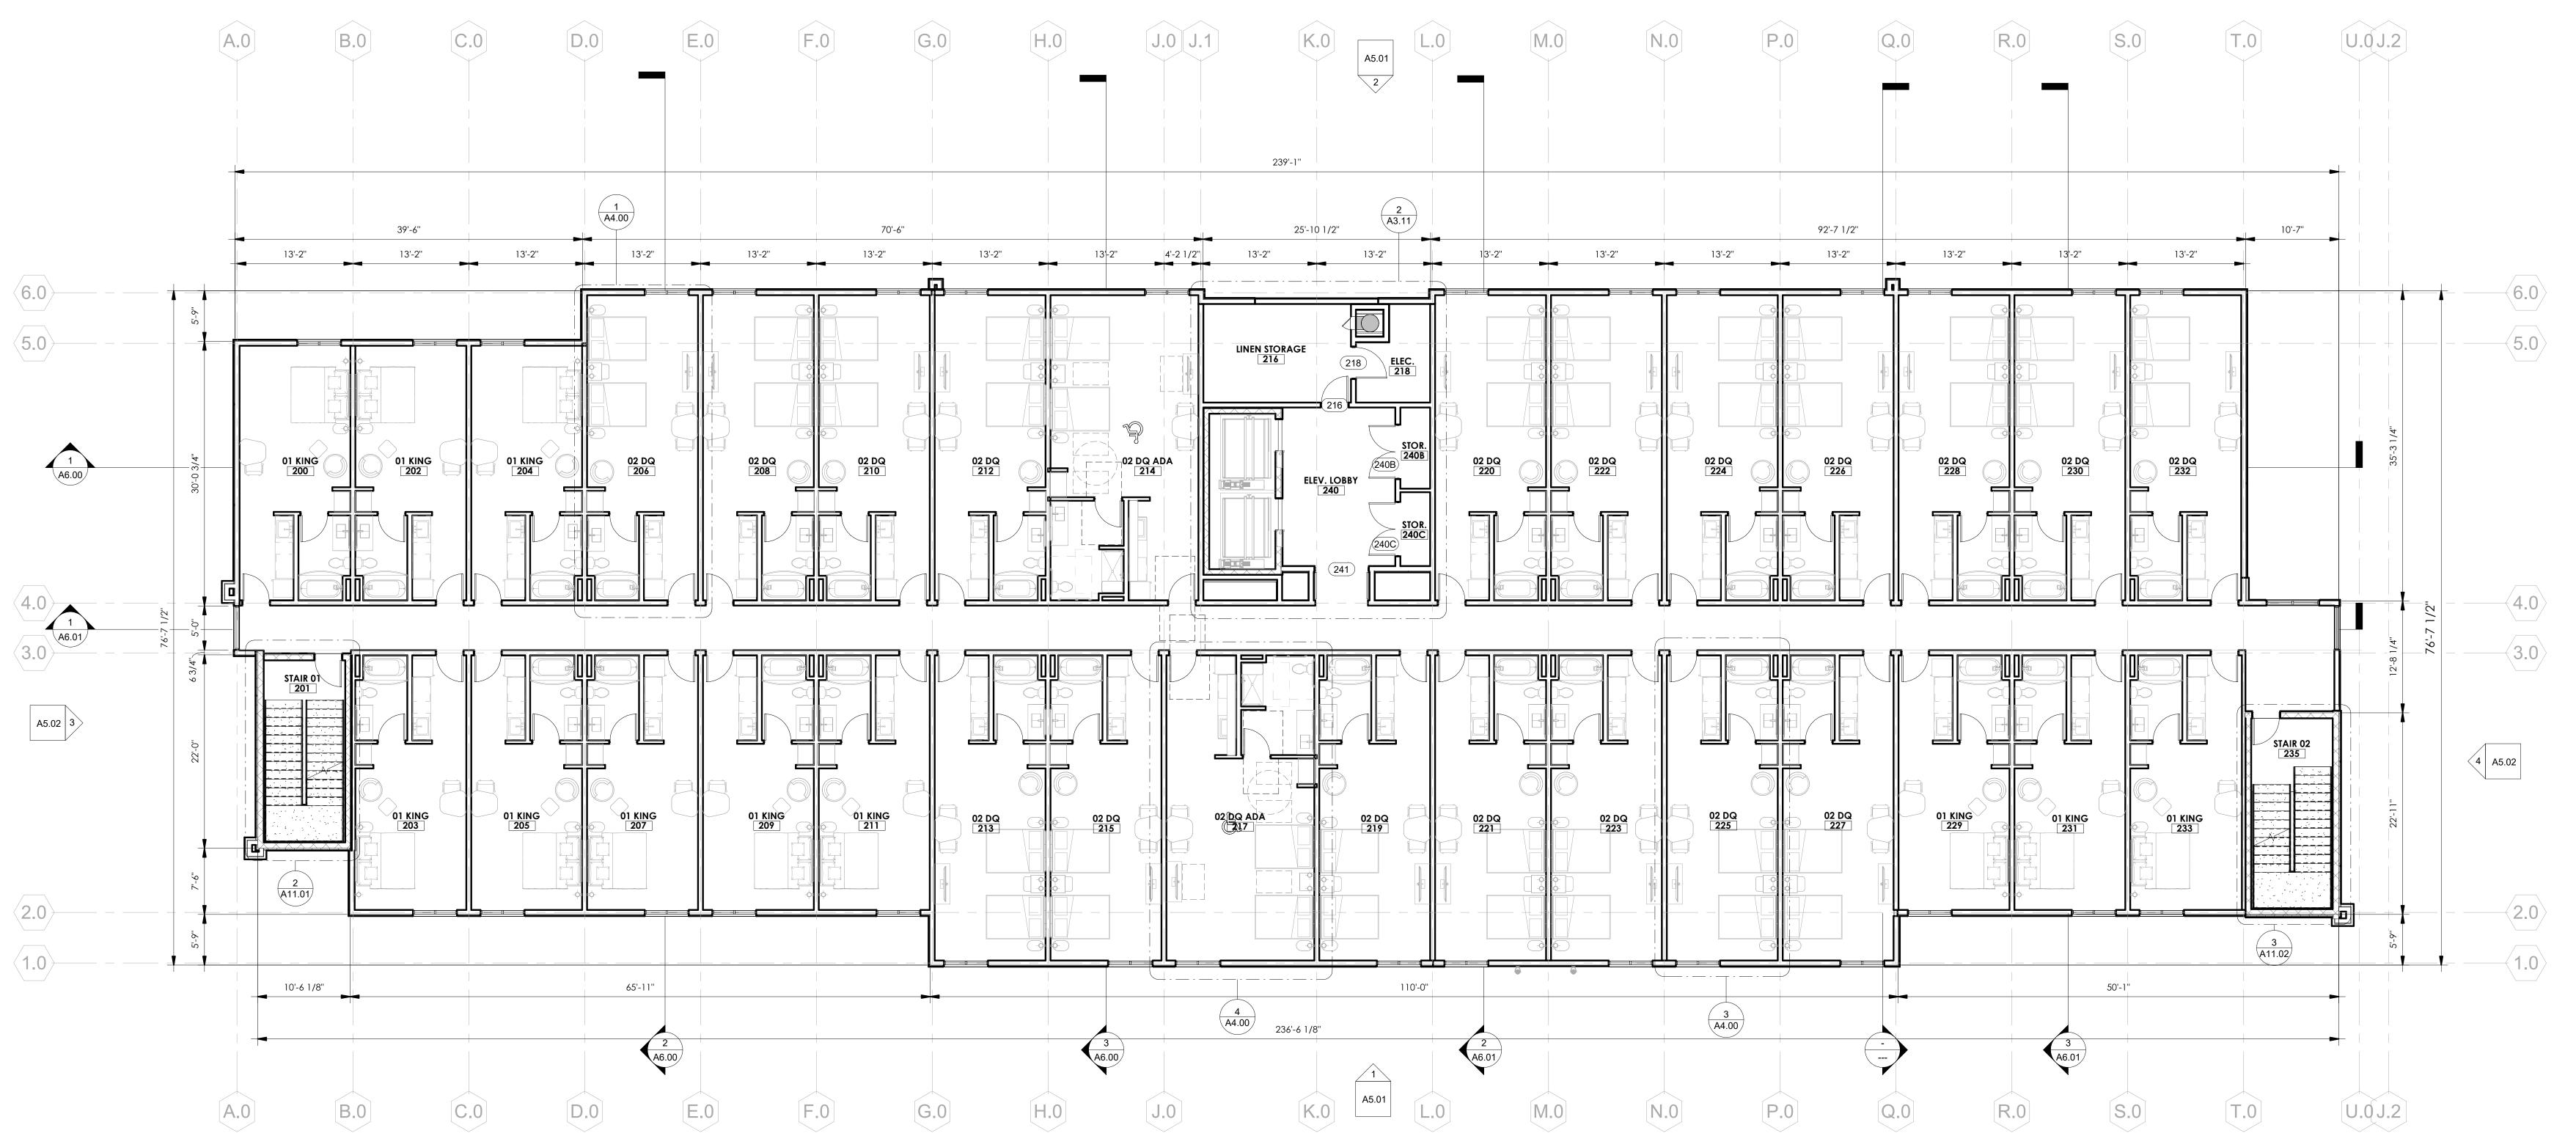

1/8" = 1'-0"

GENERAL FLOOR PLAN NOTES

10. ALL STRUCTURAL STEEL COLUMNS AND BEAMS REQUIRED TO 18. PROVIDE TACTILE SIGNAGE OUTSIDE THE TOILET ROOM PER THE GENERAL CONTRACTOR SHALL NOTIFY THE ARCHITECT TYPICAL AT EXPOSED SIDES OF CONCRETE COLUMNS 1110.1 AND ICC/ANSI A117.1. MOUNT BOTTOM OF BE PROTECTED TO MEET A FIRE RATING SHALL BE UNLESS OTHERWISE NOTED -PROVIDE 5/8" GYPSUM BOARD OF ANY DISCREPANCIES BETWEEN THE DRAWINGS, THESE CHARACTERS AT 48" MIN. AND 60" MAX ABOVE FLOOR. INDIVIDUALLY PROTECTED PRIOR TO INSTALLATION OF OVER 1 1/2" METAL STUDS AT 16" O.C. AND EXTEND ABOVE NOTES AND FIELD CONDITIONS BEFORE COMMENCING ADJACENT PARTITIONS, WALLS, CEILINGS OR ROOF CEILING. ANY WORK AND REQUEST CLARIFICATION. PROVIDE STAINLESS STEEL CORNER GUARDS AT ALL OUTSIDE CORNERS IN KITCHEN, LAUNDRY ROOMS, STORAGE, 25. ALL GYPSUM BD. FINISH FACES OF DIFFERING SUBSTRATES REFER TO A8.00 FOR PARTITION TYPES 11. FURNITURE, FIXTURES AND EQUIPMENT (FFE) ARE TO BE MAINTENANCE AND BACK-OF-HOUSE CORRIDORS. (i.e. 1 1/2" MTL. FURRING ADJACENT TO 3 5/8" METAL STUDS) COORDINATED WITH OWNER. CONTRACTOR TO PROVIDE PROVIDE PLASTIC CORNER GUARDS AT ALL OUTSIDE REFER TO SHEET A15.00 FOR DOOR SCHEDULES, DOOR RESPONSIBILITY MATRIX TO ENSURE ALL ELEMENTS ARE CORNERS IN BACK-OF-HOUSE WORK ROOMS AND OFFICES. HOTEL INFORMATION GENERAL FLOOR PLAN SYMBOLS FRAMES AND DOOR TYPES REFERENCE SPECIFICATION SECTION 102600 FOR TYPES AND 26. ACCOUNTED FOR. REFER TO A9 SHEETS FOR ENLARGED GUESTROOM HEIGHTS OF CORNER GUARD. ALL OUTSIDE CORNERS AT REFER TO G SERIES SHEETS FOR CODE REFERENCES, CODE **BUILDING SF** PROVIDE NECESSARY BLOCKING FOR SURFACE MOUNTED (6) KEYNOTE TAG - REFENCE KEYNOTE SCHEDULE BACK-OF-HOUSE AREAS ARE TO HAVE CORNER GUARDS. COMPLIANCE PLANS, PENETRATION DETAILS AND FIXTURES, ACCESSORIES, AND EQUIPMENT. ACCESSIBILITY INFORMATION. FINAL ROOM NAMES AND SIGNAGE SHALL BE CONFIRMED FIRST FLOOR SF: 18,816 SF GUARDS AT PUBLIC AREAS TO BE PROVIDED BY GC. BY OWNER PRIOR TO PURCHASE AND INSTALLATION. UPPER FLOOR SF: 18,816 SF (101) DOOR TAG - REFENCE DOOR SCHEDULE A15.00 13. FINISHES SHALL MEET PROPER FLAME SPREAD AND SMOKE TOTAL SF: 75,264 SF PROVIDE ACCESSIBLE GUEST ROOMS PER THE TEXAS SPREAD, 2015 IFC, SECTION 803. 20. ALL WALL OUTLETS ON ELEVATIONS ARE DIMENSIONED TO ACCESSIBILITY STANDARDS. REFER TO G SERIES SHEETS FOR CENTER LINE, UNLESS NOTED OTHERWISE. ADDITIONAL INFORMATION. BUILDING INFORMATION SF-00 STORFRONT TAG - REFERENCE WINDOW SCHEDULE A16.00 14. CAULK CONTINUOUSLY AT PERIMETER OF DOOR AND NUMBER OF FLOORS: 4 FLOORS 21. ALL DEVICES ADJACENT TO WET AREAS SHALL BE GFCI PER WINDOW FRAMES. CAULK AFTER WALL COVERING IS ALL DIMENSIONS ARE TO FACE OF STUD, CONCRETE, NUMBER OF GUESTROOMS: 109 INSTALLED. NEC REQUIREMENTS. A WINDOW TAG - REFERENCE WINDOW SCHEDULE A16.00 MASONRY OR TO THE GRID LINE, UNLESS NOTED OTHERWISE. REFER TO STRUCTURAL FOR SLAB DIMENSIONS. ALL WOOD BLOCKING AND PLYWOOD IN EXTERIOR WALLS, REFER TO MOUNTING HEIGHT SCHEDULE FOR TOILET AND BATH ACCESSORIES IN ALL BATHROOMS. PARAPETS, AND ROOF CONSTRUCTION SHALL BE EXTERIOR **AMENITIES** PARTITION TAG - REFERENCE PARTITION SCHEDULE A8.00 ALL GRID LOCATIONS AND GRID DIMENSIONS ARE TO BE (PRESSURE) AND FIRE RETARDANT-TREATED (FRTW). ALL INDOOR POOL VERIFIED BY CONTRACTOR PRIOR TO COMMENCEMENT OF INTERIOR PLYWOOD SHALL BE FIRE RETARDANT-TREATED SIGNAGE IS OWNER PROVIDED. SIGNAGE SHALL MEET OUTDOOR LOUNGE BUILDING CODE REQUIREMENTS AND ANSI A117.1 (FRTW). ONLY INTERIOR MISCELLANEOUS WOOD BLOCKING ROOM ADA SYMBOL REQUIREMENTS FOR ACCESSIBILITY. SHALL BE ALLOWED TO BE NON FIRE-RETARDANT TREATED ALL MISCELLANEOUS SUPPORT STEEL EXPOSED TO THE CORPORATE OFFICE AND INTERIOR WOOD BLOCKING ADJACENT TO CONCRETE EXTERIOR SHALL BE GALVANIZED AND COATED WITH A 17. PROVIDE TACTILE EXIT SIGNS AT EXIT DOOR LOCATIONS. OR MASONRY SHALL BE PRESSURE TREATED. **GUESTROOM MIX** HIGH-PERFORMANCE COATING, UNLESS NOTED ROOM HEARING IMPAIRED SYMBOL SIGNAGE SHALL COMPLY WITH ICC/ANSI A117.1. AT OTHERWISE. STOREFRONT LOCATION, PROVIDE TACTILE SIGN THAT FITS WHERE MECHANICAL AND ELECTRICAL DEVICES AND FLOOR 1 2 3 4 TOTAL WITHIN THE STOREFRONT MULLION FRAME WIDTH. MOUNT PARTS ARE CONCEALED AND REQUIRE ACCESS, PROVIDE PROVIDE AUTOMATIC FIRE SUPPRESSION SYSTEM FOR CR CARD READER QQ 6 20 19 20 BOTTOM OF CHARACTERS AT 48"MIN. AND 60"MAX. ABOVE ACCESS DOORS AND FRAMES PER SPECIFICATIONS. FIRE ENTIRE BUILDING PER NFPA 13. SYSTEM SHALL BE UNDER FINISH FLOOR. RATED ASSEMBLIES SHALL BE MAINTAINED. K 11 11 11 11 SEPARATE PERMIT. COORDINATE WITH CERTIFIED FIRE **FE** FIRE EXTINGUISHER SPRINKLER CONTRACTOR. TOTAL GUESTROOMS 109

TYPE-SIX

DEVELOPMENT SERVICES, LLC 910 SOUTH MAIN STREET #150 GRAPEVINE, TEXAS 76054 972.677.9075

ARCHITECT

D. HAYES HINKLE

29 MAY 2024 ISSUED FOR


ISSUE DATE

REVIEW

Revision

SHEET NAME 02 DIMENSION PLAN

SHEET NUMBER

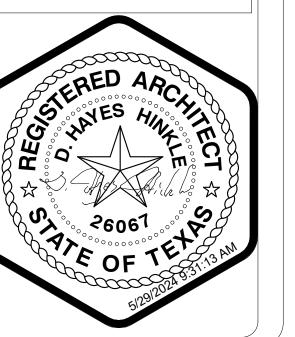

MATERIAL CALLOUTS **ADDITIONAL NOTES:** ELEVATION KEYNOTES **B-1** DARK BRICK - KING SIZE ACME MANGANESE IRONSPOT OR SIMILAR ALL SIGNAGE SUBJECT TO BUILDING INSPECTION DEPARTMENT **EF-1** DARK COLOR EIFS MECHANICAL UNITS SHALL BE SCREENED IN ACCORDANCE WITH LOCAL CITY AND ZONING ORDINANCES. **EF-2** GREY COLOR EIFS UTILITY BOXES AND CONDUIT SHALL BE PAINTED TO MATCH **BUILDING COLOR** EF-3 WHITE EIFS KING SIZE, FACE BRICK, WITH 3/8" CONCAVE GROUT JOINT-MORTAR TO BE MATCHED TO GROUT **EF-4** TAUPE COLOR EIFS CONTRACTOR TO ENSURE METAL PANELS ARE INSTALLED IN ACCORDANCE WITH MANUFACTURERS RECOMMENDATION. NH-1 NICHIHA VINTAGE WOOD CEDAR OR SIMILAR SIGN DESIGNED AND FABRICRATED BY APPROVED VENDOR TO MEET BRAND STANDARDS, FOR LOCATION ONLY ALL UTILITY BOXES AND METERS SHALL BE PAINTED TO MATCH **LF-1** LOUVER FINISH - DARK BRONZE TO MATCH STOREFRONT SURROUNDING BUILDING FACADE. FINAL SIGN DESIGN TO BE DRAFTER BY THIRD PARTY CONTRACTOR **AF-1** ALUMINUM PARAPET FLASHING TO MATCH STOREFRONT TO ENSURE FINAL SIGN PACKAGE IS SUBMITTED APPROVED BY THE GL EXTERIOR WINDOWS: STOREFRONT WINDOW SYSTEM 38% TRANSPARENCY ON 1ST FLOOR > 33% PARKWAY REQUIREMENTS STOREFRONT - KAWNEER - "DARK BRONZE #40" SPANDREL

WEST ELEVATION1/8" = 1'-0"



1 EAST ELEVATION 1/8" = 1'-0"



ARCHITECT

TYPE-SIX

DEVELOPMENT SERVICES, LLC

910 South main street #150 Grapevine, texas 76054

TYPE-SIX

972.677.9075

D. HAYES HINKLE ISSUE DATE 29 MAY 2024 ISSUED FOR REVIEW


Revision


SHEET NAME **BUILDING ELEVATIONS**

SHEET NUMBER





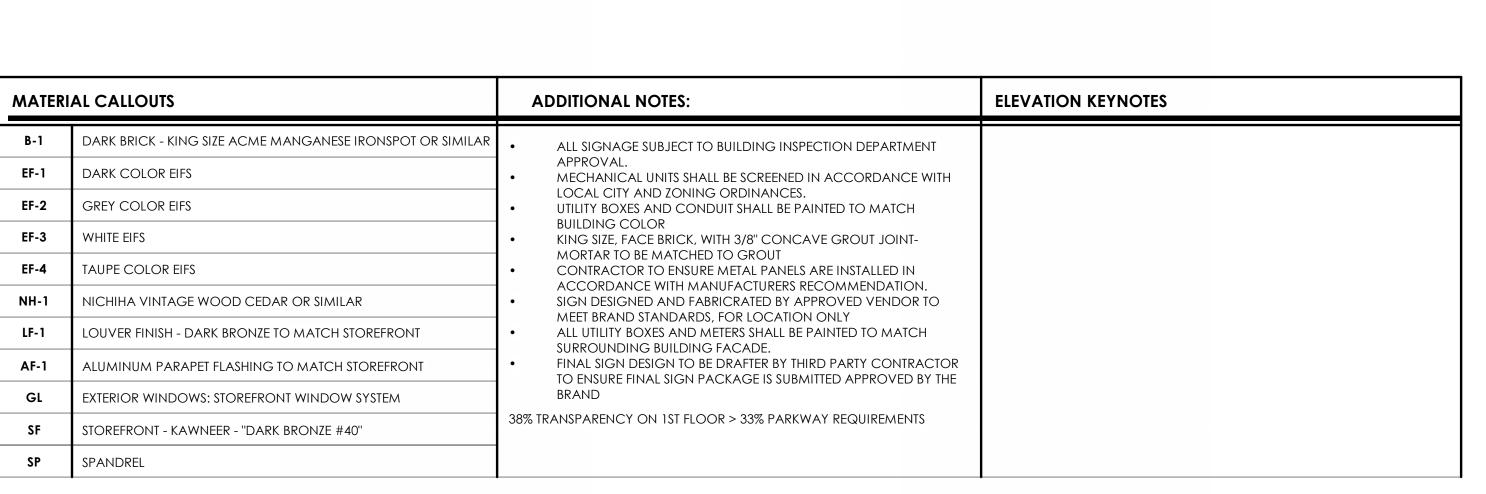

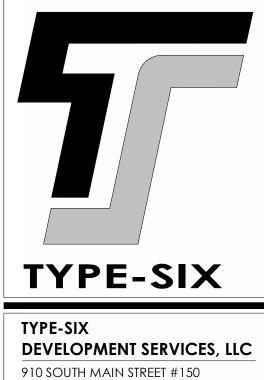



910 SOUTH MAIN STREET #150 GRAPEVINE, TEXAS 76054 972.677.9075


MARQUEE H
10000 N POLO DR
KANSAS CITY, MO 64153
PROJECT # 00000 ARCHITECT D. HAYES HINKLE **ISSUE DATE** 29 MAY 2024

ISSUED FOR REVIEW Revision SHEET NAME

> BUILDING ELEVATIONS SHEET NUMBER

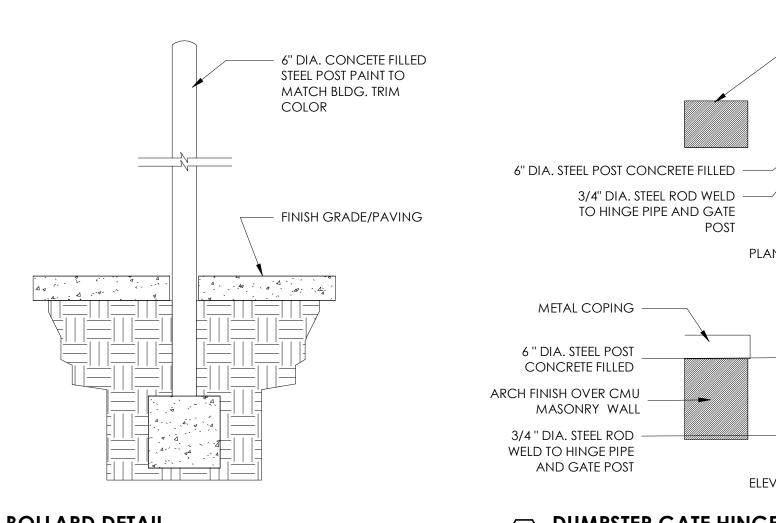

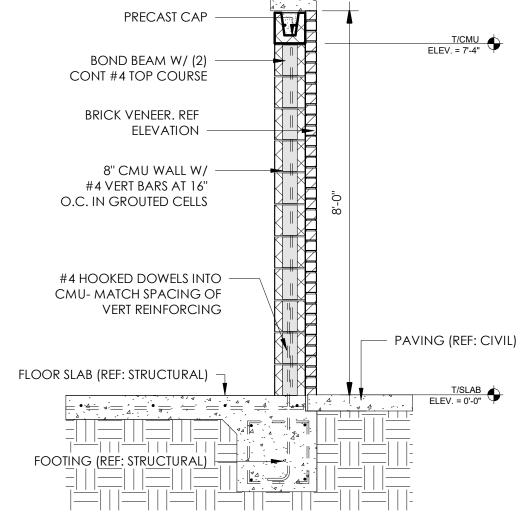

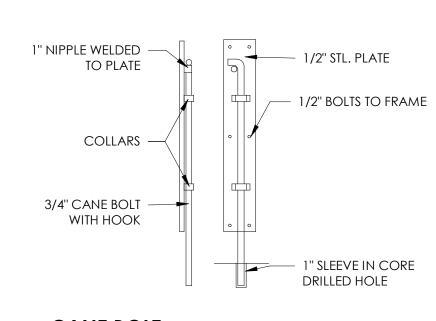

— ARCH FINISH OVER CMU MASONRY WALL

1/2" TH. STEEL HINGE PLATE

— 1"X1" 11 GAUGE TUBE STEEL

GATE FRMING WITH 16

GAUGE F-DECKING

– 3/4" DIA. HINGE PIN

1/2" TH. STEEL HINGE PLATE

- 3/4" I.D. PIPE

1"X1" 11 GAUGE TUBE STEEL GATE FRAMING WITH 16 GAUGE F-


– 3/4" DIA. HINGE PIN

- 3/4" I.D. PIPE


DECKING

PLAN VIEW (SIM)


ELEVATION (SIM)

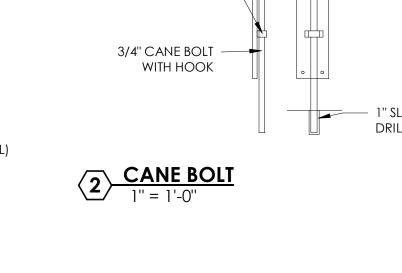

9 DUMPSTER ENCLOSURE SECTION 1/2" = 1'-0"

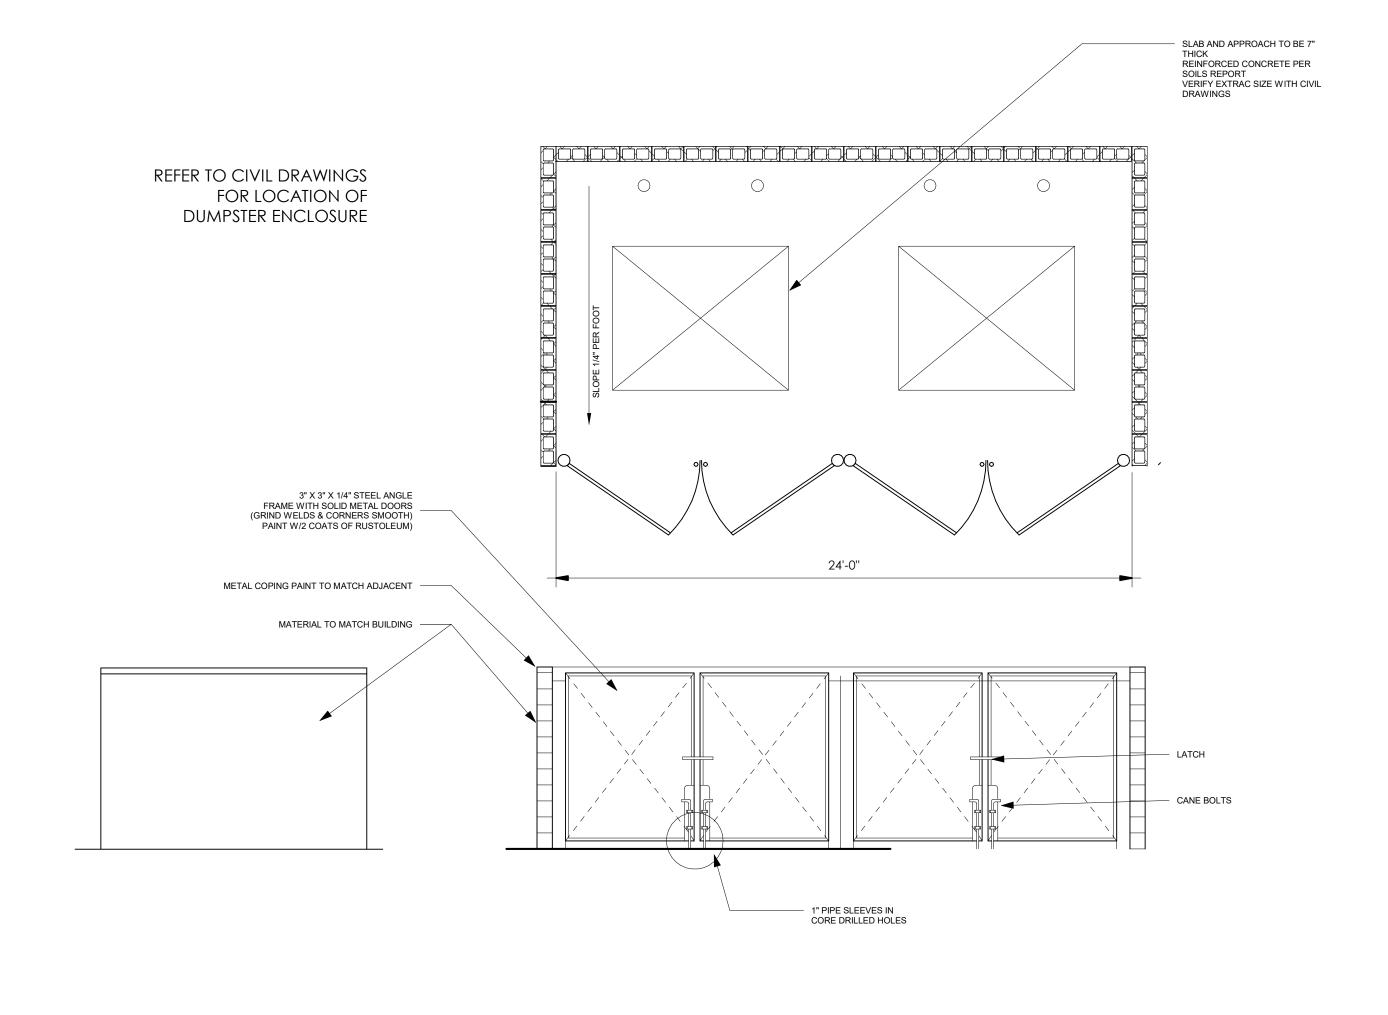

3 DUMPSTER ENCLOSURE

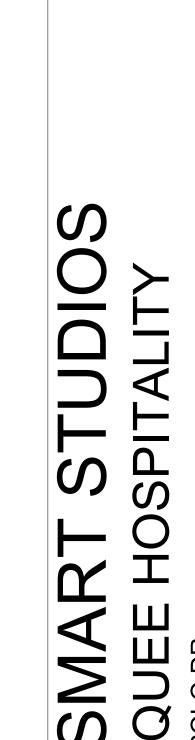

TYPE-SIX

DEVELOPMENT SERVICES, LLC

910 SOUTH MAIN STREET #150 GRAPEVINE, TEXAS 76054

TYPE-SIX

972.677.9075

ARCHITECT

D. HAYES HINKLE

29 MAY 2024

ISSUE DATE


ISSUED FOR REVIEW

Revision

SHEET NAME SITE ELEMENTS

SHEET NUMBER

A0.03

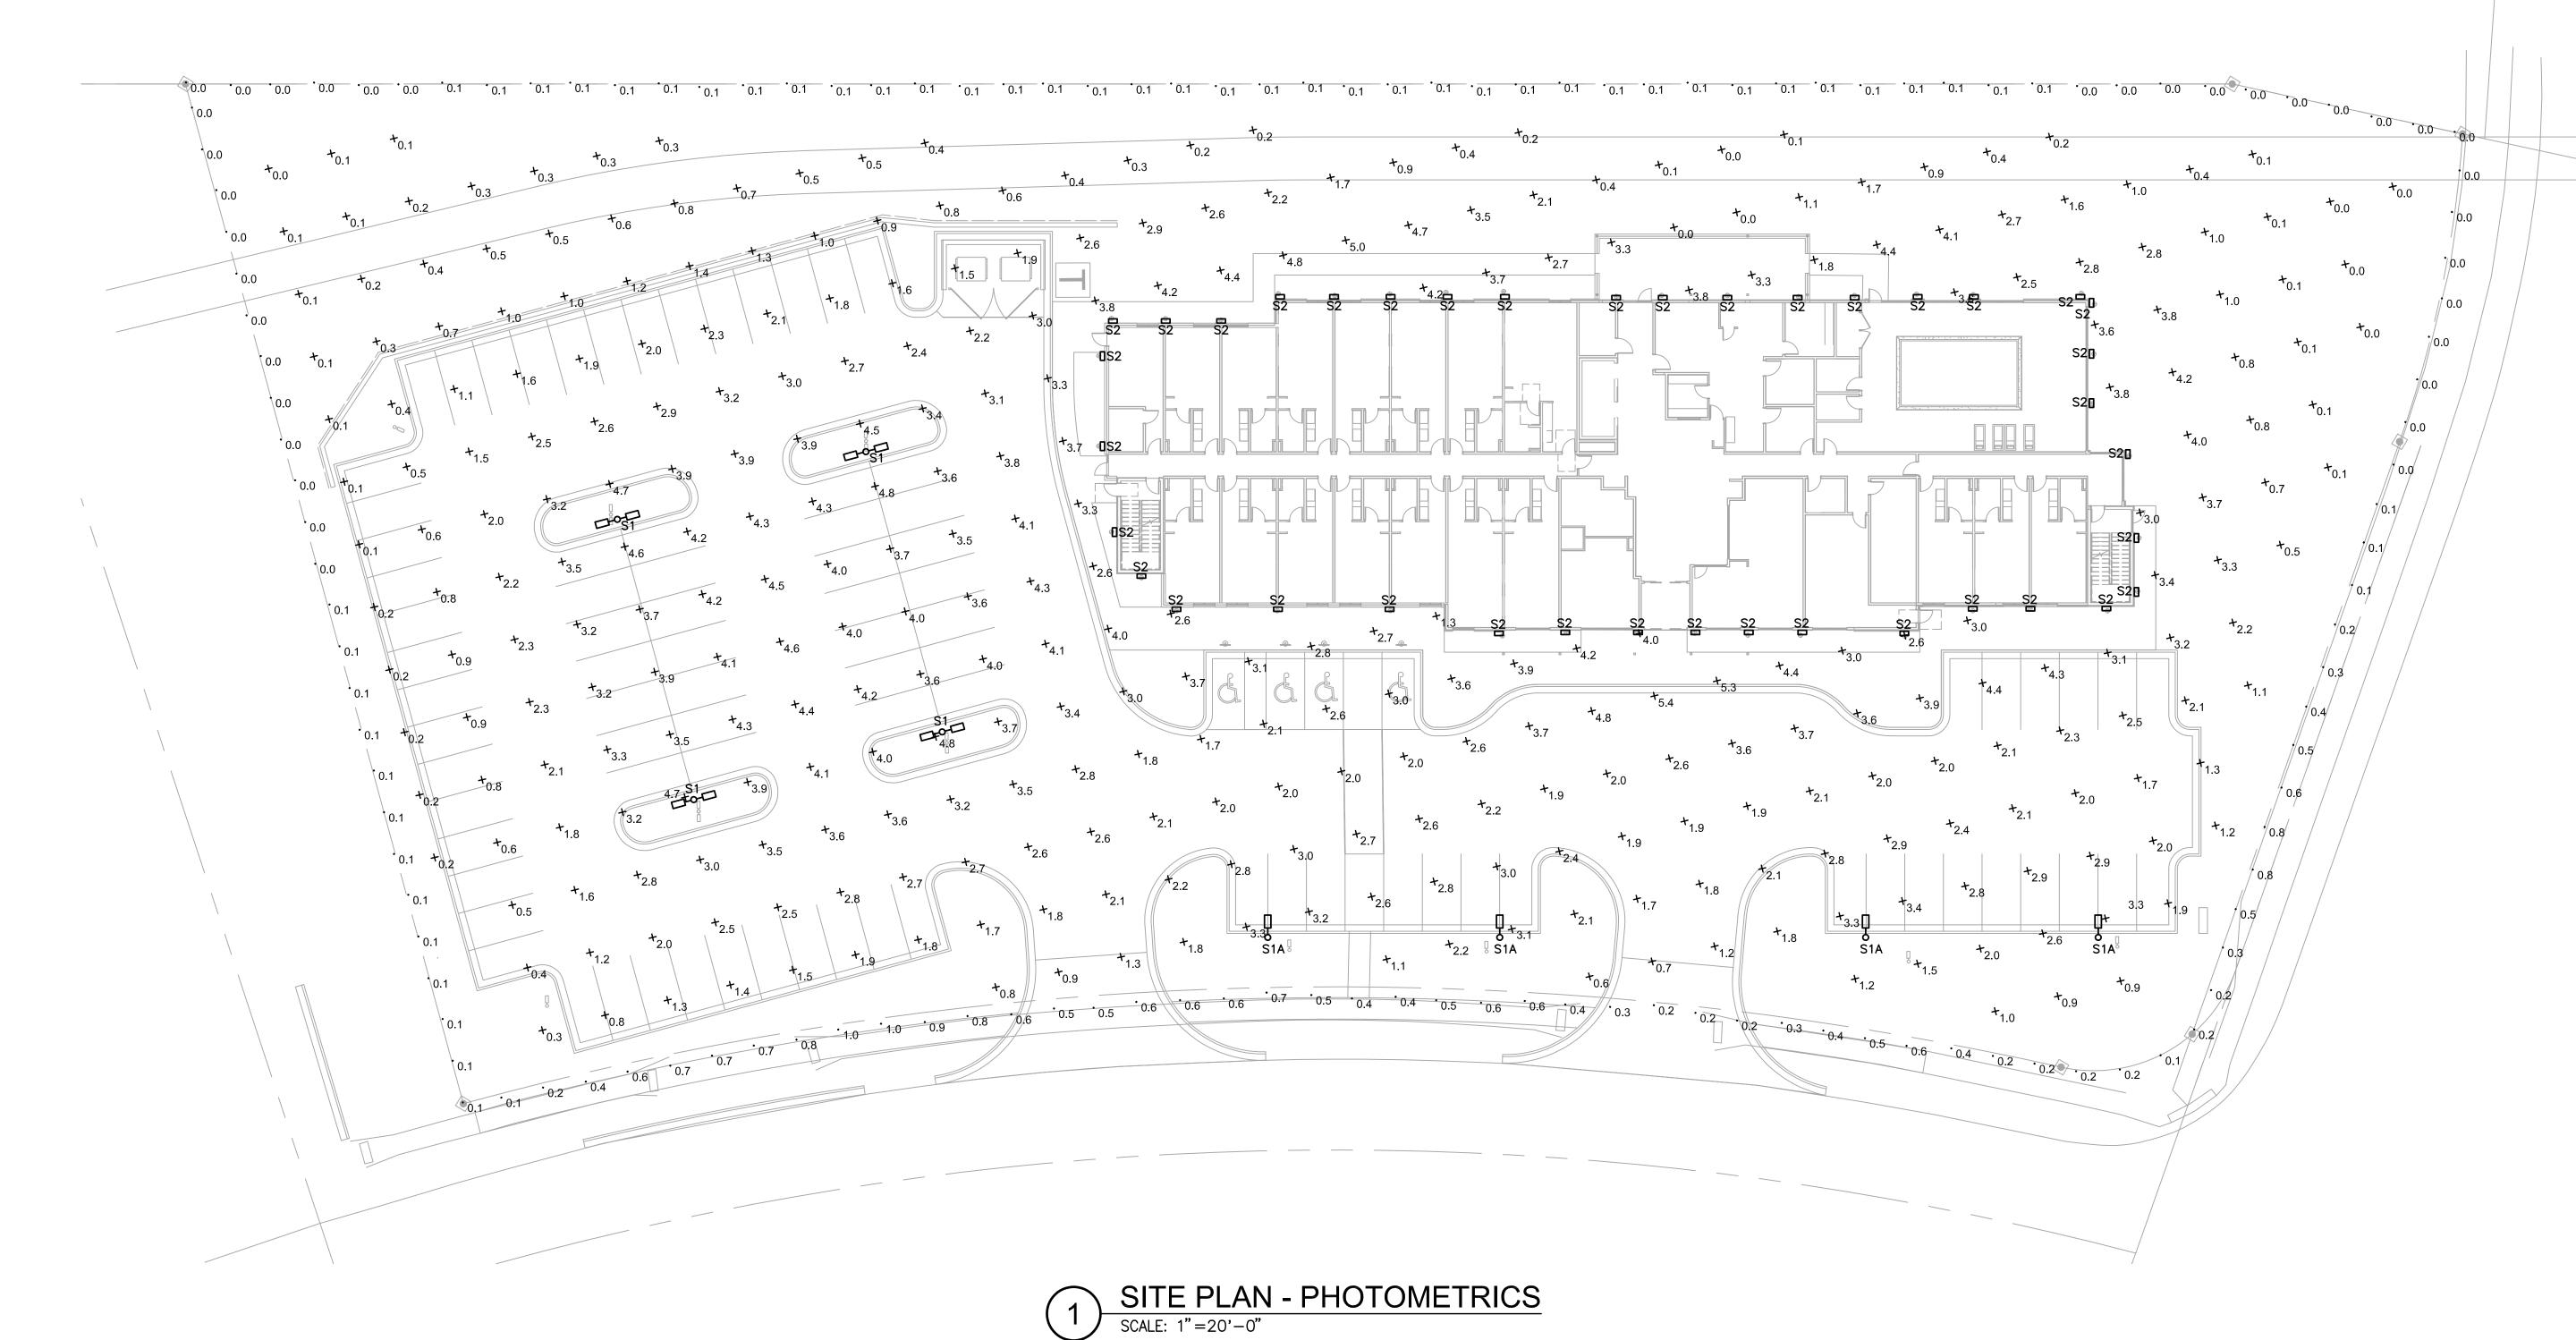

	LIGHTING SCHEDULE									
			LAMP			FIXTURE				
TYPE	DESCRIPTION	VOLTAGE	NO.	TYPE	MOUNTING	MANUFACTURER/ CAT. #				
S1	LED POLE MOUNTED SITE LIGHT	120	1	104W	POLE	LITHONIA				
				LED	20'	DSX1-LED-P3-40K-80CRI-T2M-XX-XX-HS-XX				
S1A	LED POLE MOUNTED SITE LIGHT	120	1	104VV	POLE	LITHONIA				
				LED	20'	DSX1-LED-P3-40K-80CRI-T4M-MVOLT-XX-XX-HS-XX				
S2	LED BUILDING MOUNTED SITE LIGHT	120	1		SURFACE	LITHONIA				
				LED	13'	DSXW1-LED-10C-700-40K-TFTM-MVOLT-XX-HS-XX				
			•							

1.) ALL REQUESTS FOR SUBSITUTIONS/ALTERNATES MUST BE SUBMITTED TO ENGINEER 7 DAYS PRIOR TO BID FOR APPROVAL. ALL SUBMISSION SHALL INCLUDE DETAILED CUT SHEETS AND PERFORMANCE DATA FOR CONSIDERATION. 2.) CONTRACTOR MUST SUBMIT LAMPS AND BALLAST WITH FIXTURE SUBMITTALS.

3.) LIGHTING PACKAGE MUST BE ENERGY STAR LISTED FIXTURES AND/OR LAMPS

TYPE-SIX

TYPE-SIX DEVELOPMENT SERVICES, LLC 910 SOUTH MAIN STREET #150 GRAPEVINE, TEXAS 76054 972.677.9075

ARCHITECT

D. HAYES HINKLE

ISSUE DATE 17 MAY 2024

ISSUED FOR **REVIEW**

Revision


SHEET NAME SITE PLAN PHOTOMETRICS

SHEET NUMBER PH1.01



3 CONSULTING ENGINEERS

VIGILANT - VIABLE - VIRTUOUS V3 PROJECT #: 24010

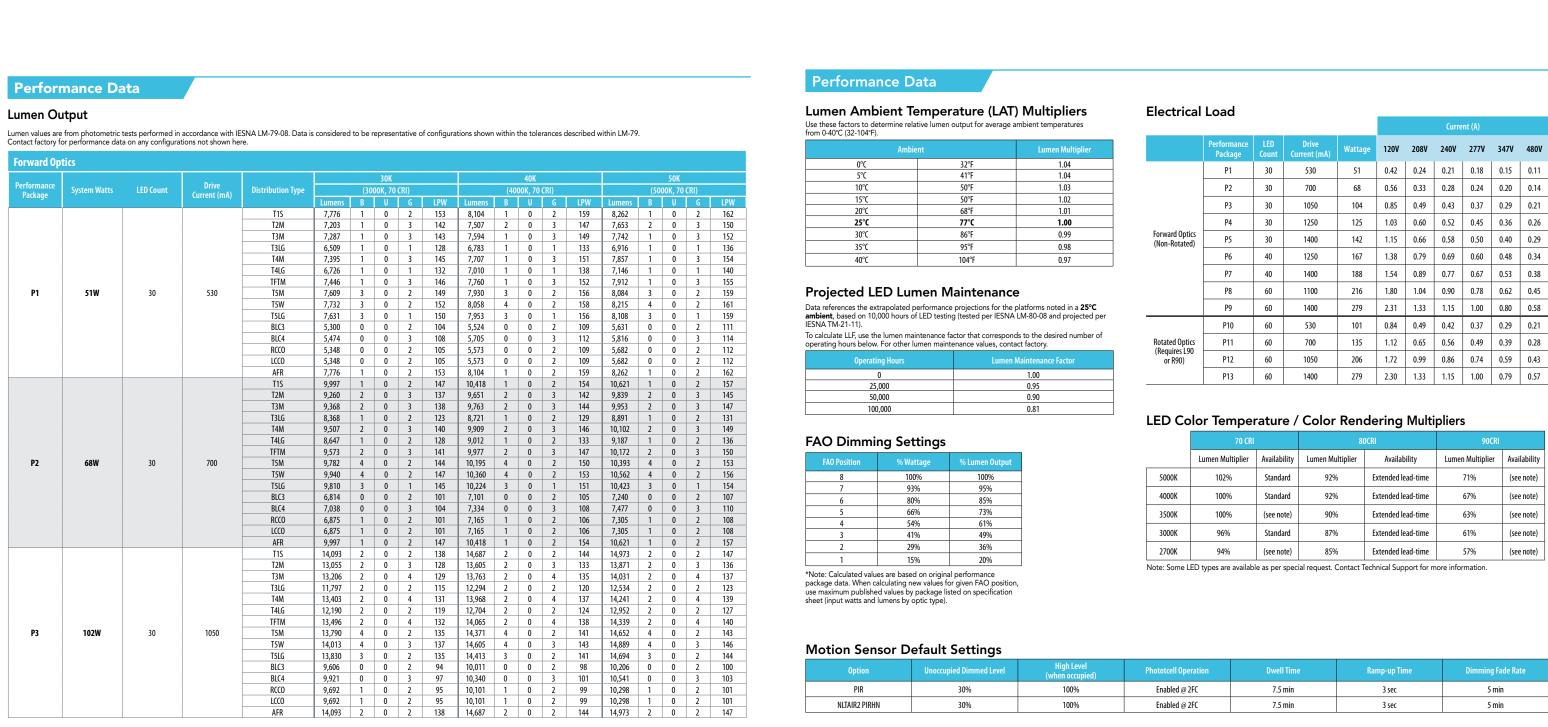


LITHONIA LIGHTING.

COMMERCIAL OUTDOOR

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perating hours below. For c Operating Ho O	ours of LED testi	ng (tested per IESNA factor that correspond	LM-80-08 and pro	jected per		P9 P10	60	1400 530	279 101	2.31 0.84	1.33 0.49	1.15 0.42	1.00 0.37	0.80	0.58
SNA TM-21-11). o calculate LLF, use the lumperating hours below. For congressing Ho	en maintenance	factor that correspond		, ,		P10	60	530	101	0.84	0.49	0.42	0.37	0.29	
erating hours below. For o Operating Ho O		calculate LLF, use the lumen maintenance factor that corresponds to the desired number of				1 10									0.21
0	or other lumen maintenance values, contact factory.			number of	Rotated Optics	P11	60	700	135	1.12	0.65	0.56	0.49	0.39	0.28
	urs	Lumen M	Maintenance Factor	r	(Requires L90 or R90)	P12	60	1050	206	1.72	0.99	0.86	0.74	0.59	0.43
25 000			1.00			P13	60	1400	279	2.30	1.33	1.15	1.00	0.79	0.57
	25,000 0.95 50,000 0.90														
100,000			0.90												
,					LED Col	or Temp	erature	/ Color	Rend	lering	Multi	pliers	3		
AO Dimming	Settinas					70	CRI		800	RI			900	RI	
FAO Position	% Wattage	% Luman Output				Lumen Multiplie	er Availability	Lumen Mu	ultiplier	Availab	ilitv	Lumer	n Multiplie	r Avai	lability
8	100%	% Lumen Output			5000K	102%	Standard	929		Extended le			71%		note)
7	93%	95%	95%												
6	80%	85%	4		4000K	100%	Standard	929	0	Extended le	ad-time		67%	(see	note)
5	66% 54%	73% 61%	-		3500K	100%	(see note)	909	6	Extended le	ad-time		63%	(see	note)
3	41%	49%			3000K	96%	Standard	879	6	Extended le	ad-time		61%	(see	note)
2	29%	36%			2700K	94%	(see note)	859	6	Extended le	ad-time		57%	(see	note)
1 ote: Calculated values are	15%	20%			Note: Some LEI	D types are avai	ilable as per spe	cial request.	Contact Te	chnical Sup	port for n	nore infor	mation.		
lotion Sensor	Default	Settings													
lotion Sensor		Settings pied Dimmed Level	High L		Phototcell Opera	ntion	Dwell Ti	ne	ſ	Ramp-up Tin	ne		Dimming	Fade Ra	te
			High L (when oc 100'	ccupied)	Phototcell Opera Enabled @ 2FG		Dwell Tir 7.5 mir		F	Ramp-up Tin 3 sec	ne			Fade Ra	te
Option		pied Dimmed Level	(when oc	ccupied) 0%		C			F		ne		5		te
Option Pir NLTAIR2 Pirhn	Unoccu	pied Dimmed Level	(when oc	ccupied) 0%	Enabled @ 2F0	C	7.5 mir 7.5 mir			3 sec	ne	Note	5	min	te
Option PIR NLTAIR2 PIRHN Controls Optio Nomendature	Unoccu	30% 30% 30% Description	(when oc 100' 100'	ccupied) 9% Allows the lumin	Enabled @ 2FG Enabled @ 2FG Functionality aire to be manually dimm	C	7.5 mir 7.5 mir			3 sec 3 sec	used with		5 5	min min	
Option PIR NLTAIR2 PIRHN Ontrols Optio Nomendature A0	Unoccu PIS Field adjustable luminaire; wired in Drivers wired in	30% 30% Description	(when oc 100' 100'	Allows the lumin effectively trimm	Enabled @ 2FG Enabled @ 2FG Functionality aire to be manually dimming the light output. wired to two separate circu	C C	7.5 mir 7.5 mir Primary	control devic		3 sec 3 sec Cannot be 0-10V lead	used with s	other cont	5 5 5 5 crols option	min min	ed the
Option PIR NLTAIR2 PIRHN Ontrols Optio Nomenclature (AO	Field adjustable luminaire; wired in operation	30% 30% 30% Description e output device installed d to the driver dimming	(when oc 100' 100'	Allows the lumin effectively trimm The luminaire is valuoing for 50/5	Enabled @ 2FG Enabled @ 2FG Functionality aire to be manually dimming the light output. wired to two separate circulorers of the properties of the circular th	C C C I I I I I I I I I I I I I I I I I	7.5 mir 7.5 mir Primary FAO device	control devic	e	3 sec 3 sec Cannot be 0-10V lead Requires tv AIR as a mo	used with s wo separat ore cost eff	other cont ely switch fective alte	5 5 5 5 5 5 5 5 5 5 5 5 5 5 5 5 5 5 5	min min is that neo	ed the nLight
Option PIR NLTAIR2 PIRHN Sontrols Optio Nomendature FAO DS (not available on DSX0)	Field adjustable luminaire; wired in operation	30% 30% Description coutput device installed d to the driver dimming	inside the leads.	Allows the lumin effectively trimm The luminaire is allowing for 50/5 Compatible with dusk to dawn ope	Enabled @ 2FG Enabled @ 2FG Functionality aire to be manually dimming the light output. wired to two separate circu	c C C C I I I I I I I I I I I I I I I I	7.5 mir 7.5 mir Primary FAO device	control device red drivers	e . Elite or	3 sec 3 sec Cannot be 0-10V lead	used with s vo separat ore cost eff to dimmin ide lumina	other cont ely switch fective alto g leads on iire. Canno	5 5 5 trols optior ed circuits. ernative. driver, Pin t be used v	min min s that nee	ed the nLight
Option PIR NLTAIR2 PIRHN Ontrols Optio Nomendature A0 OS (not available on DSX0) PERS or PER7	Field adjustable luminaire; wired in operation Twist-lock phot	Description Output device installed d to the driver dimming dependently for 50/50 le ocell receptacle	inside the leads.	Allows the lumin effectively trimm The luminaire is vallowing for 50/5 Compatible with dusk to dawn ope that provide 0-10	Enabled @ 2FG Enabled @ 2FG Functionality aire to be manually dimming the light output. wired to two separate circuto operation. standard twist-lock photoeration, or advanced contraction, or advanced contraction.	c C C I I I I I I I I I I I I I I I I I	7.5 mir 7.5 mir Primary FAO device Independently w	control devic red drivers ells such as DLL nodes such as I	e . Elite or	3 sec 3 sec Cannot be 0-10V lead Requires tv AIR as a m Pins 4 & 51 capped ins	used with s wo separat to dimmin ide lumina tions that used with	other cont ely switch fective alto g leads on ire. Canno need the (strols optior ed circuits. ernative. driver, Pin t be used v	min min s that nee Consider s 6 & 7 are with others.	ed the nLight
PIR NITAIR2 PIRHN Controls Optio	Field adjustable luminaire; wire operation Twist-lock phot Motion sensor for 8" to 40" mo	Description Output device installed d to the driver dimming dependently for 50/50 le ocell receptacle	inside the leads. uminaire ensor suitable n sensing,	Allows the lumin effectively trimm The luminaire is vallowing for 50/5 Compatible with dusk to dawn ope that provide 0-10 Luminaires dim v	Enabled @ 2FG Enabled @ 2FG Functionality aire to be manually dimming the light output. vired to two separate circuto operation. standard twist-lock photoration, or advanced contributions of the properties of	c C C C C C C C C C C C C C C C C C C C	7.5 mir 7.5 mir 7.5 mir Primary FAO device Independently w Twist-lock photocadvanced control	control devic red drivers ells such as DLL nodes such as I	e . Elite or	3 sec 3 sec Cannot be 0-10V lead Requires tv AlR as a m Pins 4 & 5 t capped ins controls op	used with s vo separat ore cost eff o dimmin dide lumina- tions that used with s. sensors ca ound usin	ely switch fective alto g leads on ire. Canno need the o other cont	ed circuits. ernative. driver, Pin ti be used v 0-10V lead trols optior	min s that nee Consider Consider s 6 & 7 arr with other s. s.	ed the nLight



NOTES

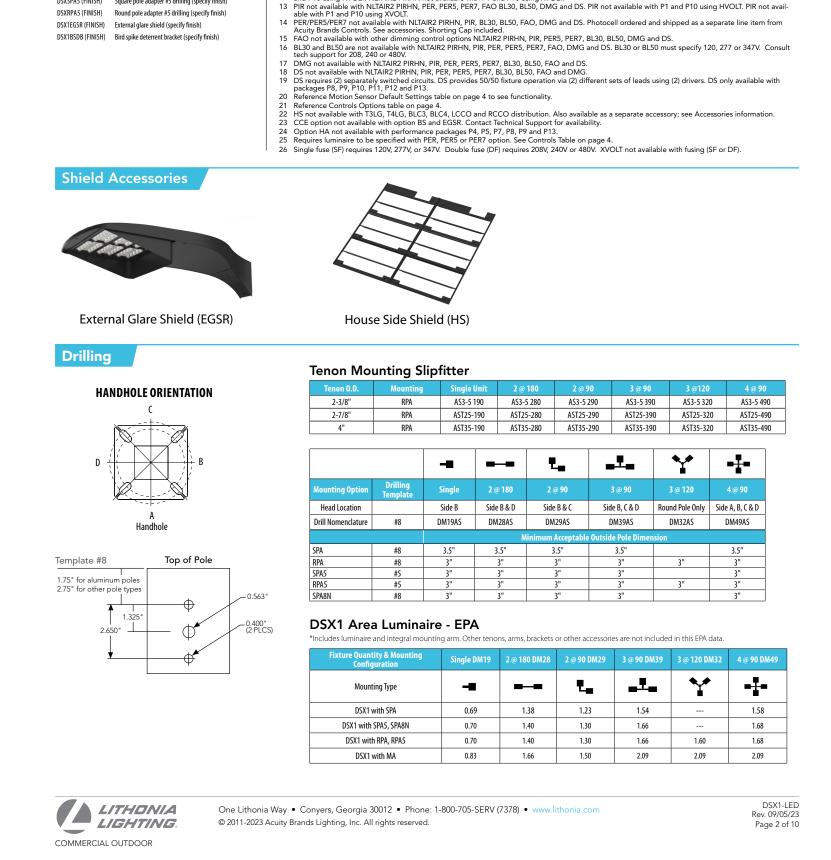Rotated optics available with packages P10, P11, P12 and P13. Must be combined with option L90 or R90.

30K, 40K, and 50K available in 70CRI and 80CRI. 27K and 35K only available with 80CRI. Contact Technical Support for other possible combinations.

T3LG, T4LG, BLC3, BLC4, LCCO, RCCO not available with option HS.

MVOLT driver operates on any line voltage from 120-277V (50/60 Hz).

HVOLT driver operates on any line voltage from 202-277V (50/60 Hz).

HVOLT not available with package P1 and P10 when combined with option NLTAIR2 PIRHN or option PIR.

XVOLT operates with any voltage between 277V and 480V (50/60 Hz).

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XVOLT operates with any voltage between 277V and 480V (50/60 Hz).

XVOLT operates with any voltage between 277V and 480V (50/60 Hz).

XVOLT operates with any voltage from 170 using 470 usin

Ordering Information

DLL480F 1.5 CUL JU Photocell - SSL twist-lock (480V) 25

DSHORT SBK Shorting cap 25

Accessories

Ordered and shipped separately. DLL127F 1.5 JU Photocell - SSL twist-lock (120-277V) 25 DLL347F 1.5 CUL JU Photocell - SSL twist-lock (347V) 25


DSX1HS P# House-side shield (enter package number 1-13 in place of #)

DSXRPA (FINISH) Round pole adapter (#8 drilling, specify finish)

DSXSPA5 (FINISH) Square pole adapter #5 drilling (specify finish)

DSXRPA5 (FINISH) Round pole adapter #5 drilling (specify finish)

DSX1EGSR (FINISH) External glare shield (specify finish)

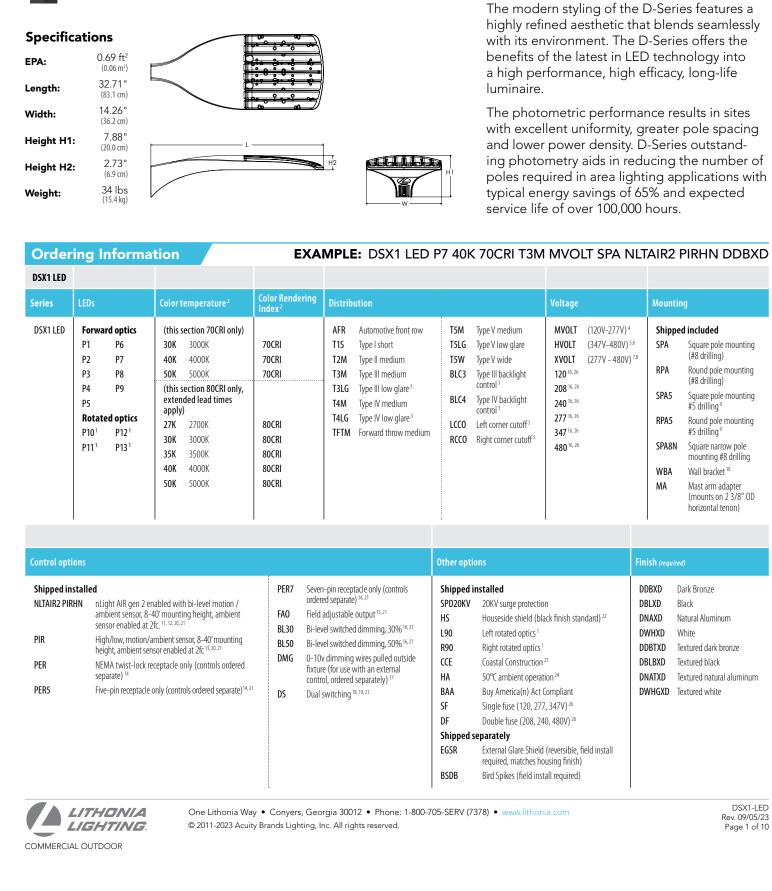

D-Series Size 1

d"series

LED Area Luminaire

Introduction



One Lithonia Way • Conyers, Georgia 30012 • Phone: 1-800-705-SERV (7378) • www.lithonia.com

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This product is assembled in the USA and meets the Buy America(n) government procurement requirements under FAR, DFARS and DOT regulations. Please refer to www.acuitybrands.co resources/buy-american for additional information.

Five-year limited warranty. This is the only warranty provided and no other statements in this

Note: Actual performance may differ as a result of end-user environment and application.

All values are design or typical values, measured under laboratory conditions at 25 °C. Specifications subject to change without notice.

disclaimed. Complete warranty terms located at: www.acuitybrands.com

specification sheet create any warranty of any kind. All other express and implied warranties are

LITHONIA LIGHTING

COMMERCIAL OUTDOOR

Rev. 1/18/23

driver is mounted to the door to thermally isolate it from the light engines for low operating temperatu and long life. Housing is completely sealed against moisture and environmental contaminants (IP65).

Exterior parts are protected by a zinc-infused Super Durable TGIC thermoset powder coat finish

that provides superior resistance to corrosion and weathering. A tightly controlled multi-stage process ensures a minimum 3 mils thickness for a finish that can withstand extreme climate

Precision-molded proprietary acrylic lenses provide multiple photometric distributions tailored

Light engine(s) consist of 10 high-efficacy LEDs mounted to a metal-core circuit board to maximize heat dissipation and promote long life (L88/100,000 hrs at 25°C). Class 1 electronic drivers have a power factor >90%, THD <20%, and a minimum 2.5KV surge rating. When ordering the SPD option, a separate surge protection device is installed within the luminaire which meets a minimum Category C Low (per ANSI/IEEE C62.41.2).


specifically to building mounted applications. Light engines are available in 3000 K (70 min. CRI),

changes without cracking or peeling. Available in textured and non-textured finishes.

4000 K (70 min. CRI) or 5000 K (70 min. CRI) configurations.


LITHONIA LIGHTING


COMMERCIAL OUTDOOR

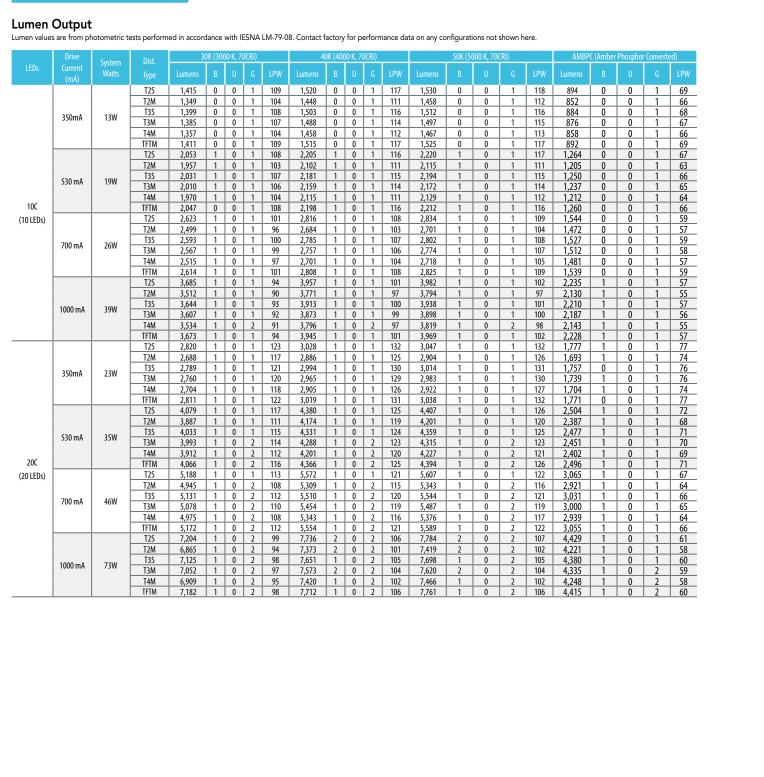

One Lithonia Way • Conyers, Georgia 30012 • Phone: 1-800-705-SERV (7378) • www.lithonia.com

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SHEET NAME

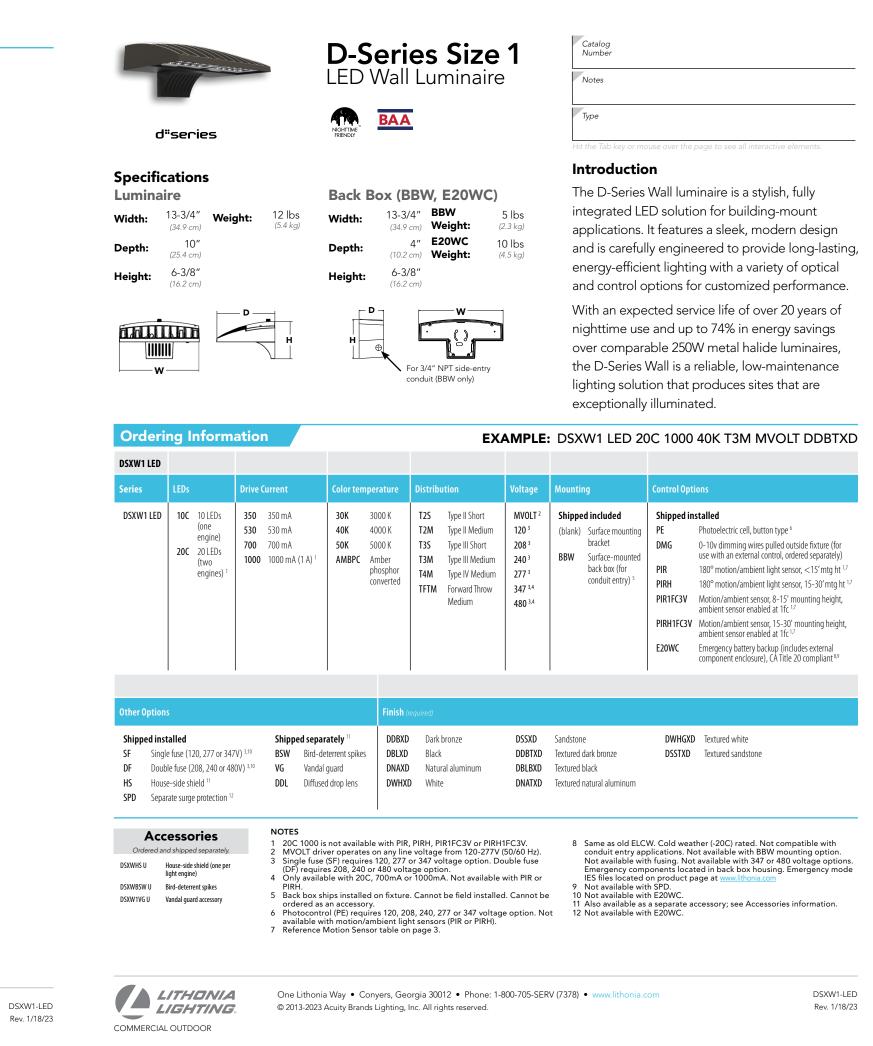LIGHT FIXTURE DETAILS

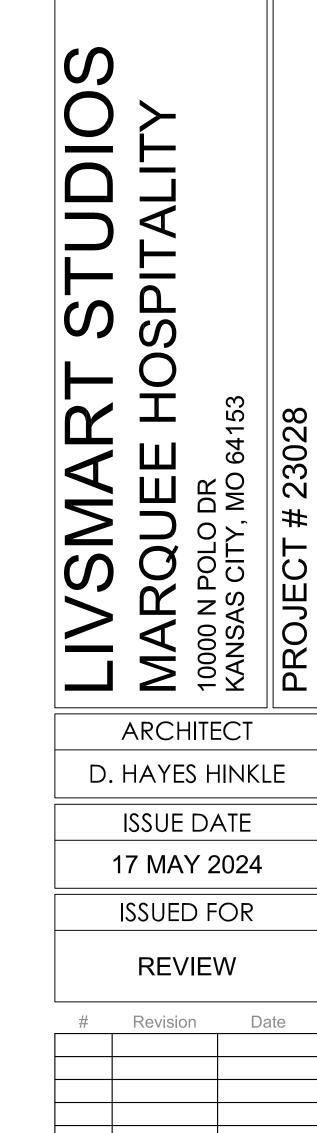SHEET NUMBER

PH1.02



TYPE-SIX DEVELOPMENT SERVICES, LLC

TYPE-SIX 910 SOUTH MAIN STREET #150

GRAPEVINE, TEXAS 76054

972.677.9075

S1&S1A





Public Meeting Summary Form

Project Case #
Meeting Date:
Meeting Location:
Meeting Time (include start and end time):
Additional Comments (optional):

Meeting Sign-In Sheet

Project Name and Ad	dress		

Name	Address	Phone	Email