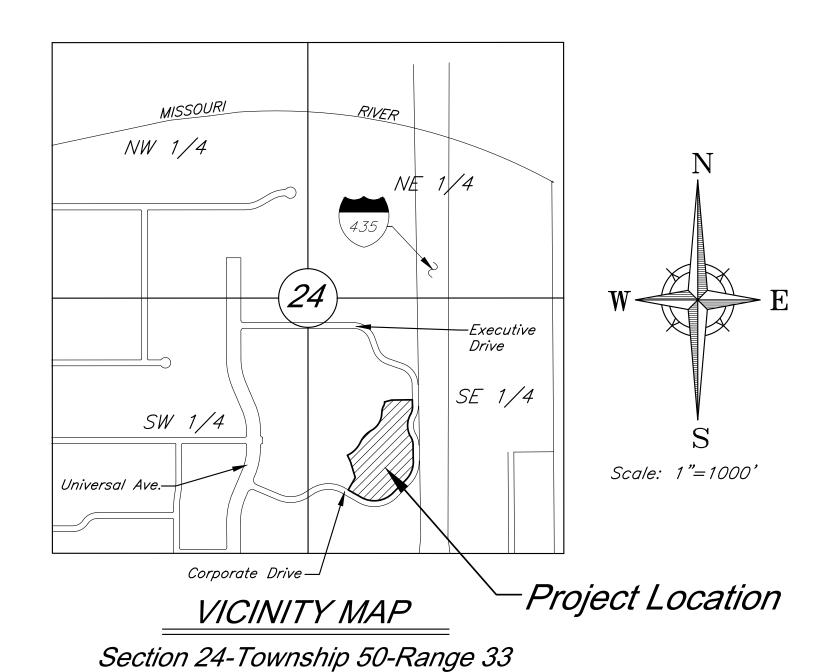
URD PRELIMINARY DEVELOPMENT PLAN FOR BLACK & McDONALD NEW BUILDING

Part of the SE 1/4
Section 24-Township 50S-Range 33E
in the
City of Kansas City
Jackson County, Missouri



INDEX OF SHEETS

Sht. No.	Description
CO	TITLE SHEET
C1.00	SITE PLAN
L 1.00	LANDSCAPE PLAN
L1.01	LANDSCAPE DETAILS
A3.01	BUILDING ELEVATIONS
E1.00	LIGHTING PLAN

PROJECT ENGINEER: JACOB SCHWEIKERT, P.E.

DATE:

APPROVED BY:

MANAGER, ENGINEERING SERVICES DIVISION:

DATE:

FLOODPLAIN:

According to FEMA Flood Insurance Rate Map Number 29095C0163H, Map Revised December 7, 2023, and Map Number 29095C0144H, Map Revised December, 2023, the site lies partially within Zone X, Areas of 0.2% annual chance flood; areas of 1% annual chance flood with average depths of less than 1 foot or with drainage areas less than 1 square mile; and areas protected by levees from 1% annual chance flood; and partially within Zone AH, Flood depths of 1 to 3 feet (usually areas of ponding); Base Flood Elevations determined.

PREPARED BY:
GEORGE BUTLER ASSOCIATES, INC.
9801 RENNER BOULEVARD
LENEXA, KANSAS 66219
PHONE: 913-492-0400
CONTACT: JACOB SCHWEIKERT

EMAIL: jschweikert@gbateam.com

EMAIL: beitzmann@blackandmcdonald.com

GRANDVIEW, MISSOURI 64030

CONTACT: BRYAN EITZMANN

PREPARED FOR: BLACK & McDONALD 4101 MAIN STREET

PHONE: 816-410-8606


City Plan Commission
Recommends Approval with Conditions
of Case No. CD-CPC-2025-00133 on 10/01/2025

MISSOURI

Sala Copelaila, FAIOF
Secretary of the City Plan Commission



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SITE DATA Existing Proposed Deviation M3-5 Zoning 476668.24 476668.24 Gross Land Area (SFT) N/A 10.94 Gross Land Area (AC) 10.94 N/A Right-of-way Dedication (SFI N/A Right-of-way Dedication (AC) N/A 476668.24 476668.24 Net Land Area (SFT) N/A 10.94 10.94 N/A Net Land Area (AC) Building Area (SFT) N/A 45600 N/A Floor Area Ratio N/A 0.096 N/A Residential Use Info N/A N/A Total Dwelling Units N/A Total Lots N/A Residential N/A Public/Civic Commercial N/A

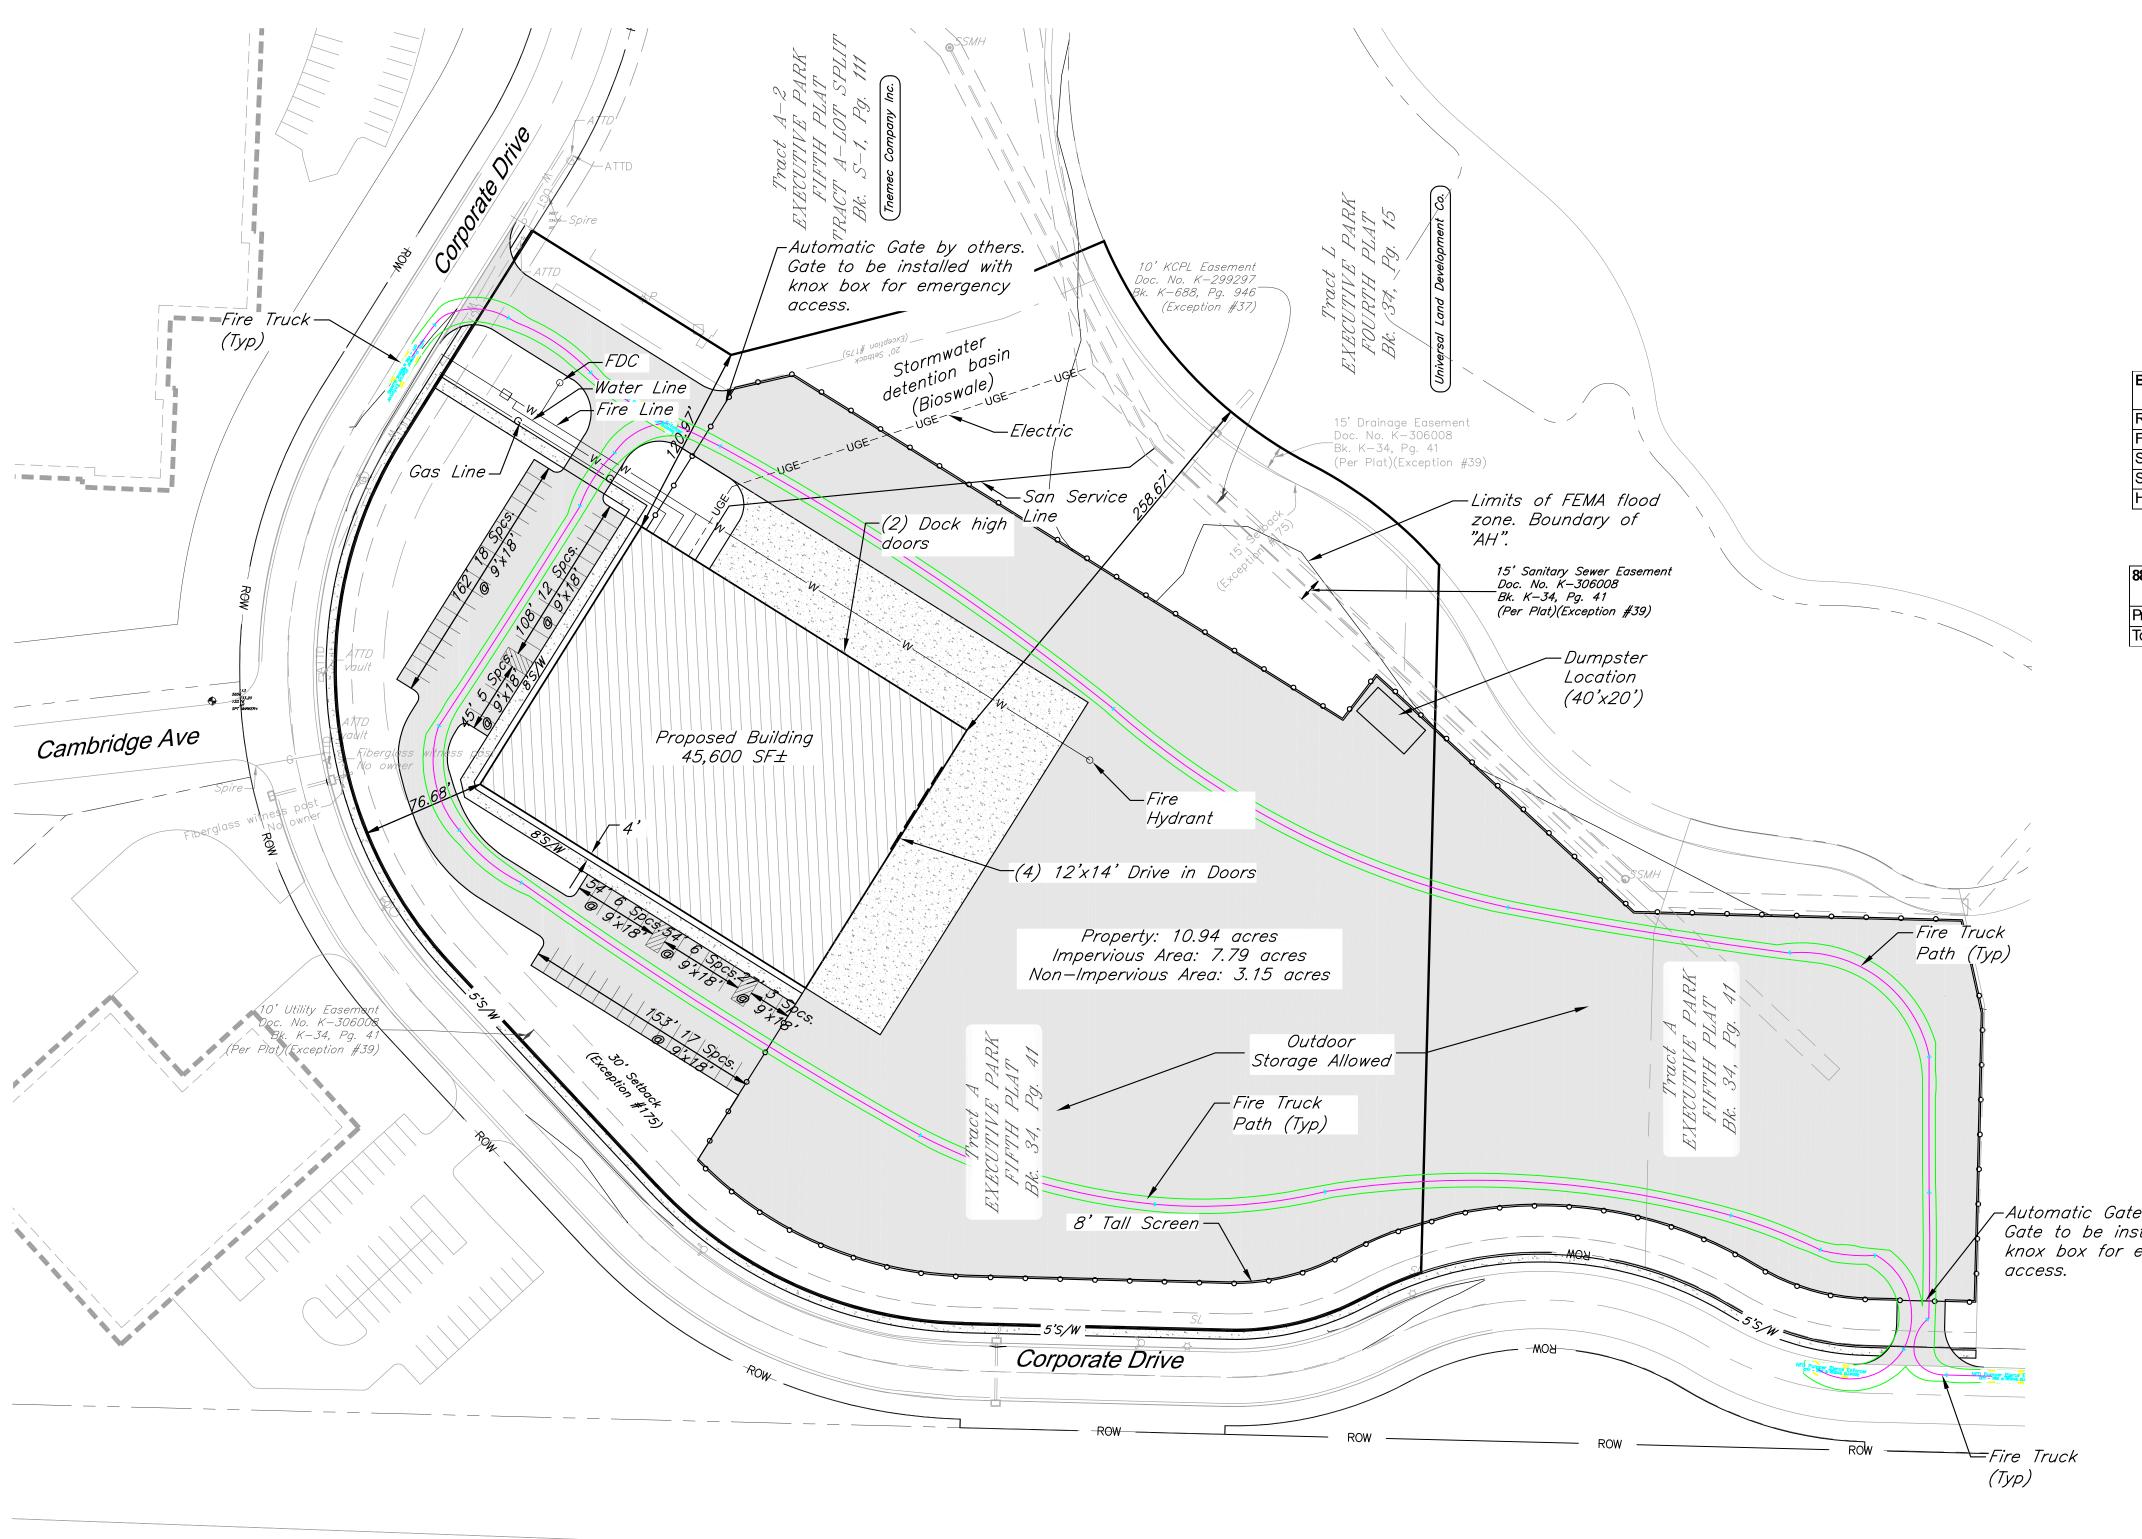Table 1: Site Data

Table 2: Ruilding Data

3 tracts 3 tracts

N/A

N/A

Industrial

Other

		Sullaing Dat	<i>u</i>	
BUILDING DATA	Required	Proposed	Deviation	Approved
			Requested?	
Rear Setback	None	258.67'	N/A	
Front Setback	None	76.68'	N/A	
Side Setback	None	120.97'	N/A	
Side Setback (abutting street)	N/A	N/A	N/A	
Height	None	38'	N/A	

Table 4: Parking

88-420 - PARKING	Vehicle Spaces		Bike Space	es	Alternatives Proposed?
	Required	Proposed	Required	Proposed	(See 88-420-16)
Proposed Use(s)	Employees		Employees		No
Total	15	67	10	0	140

Table 5: Other Development Standards

88-425 - OTHER DEVELOPMENT STANDARDS	Method of Compliance
88-430 Outdoor Lighting	See Photometric Plan
88-435 Outdoor Display, Storage and Work Areas	See Photometric Plan
88-445 Signs	
88-450 Pedestrian Standards	

FLOODPLAIN:

According to FEMA Flood Insurance Rate Map Number 29095C0163H, Map Revised December 7, 2023, and Map Number 29095C0144H, Map Revised December, 2023, the site lies partially within Zone X, Areas of 0.2% annual chance flood; areas of 1% annual chance flood with average depths of less than 1 foot or with drainage areas less than 1 square mile; and areas protected by levees from 1% annual chance flood; and partially within Zone AH, Flood depths of 1 to 3 feet (usually areas of ponding); Base Flood Elevations determined.

—Automatic Gate by others. Gate to be installed with knox box for emergency

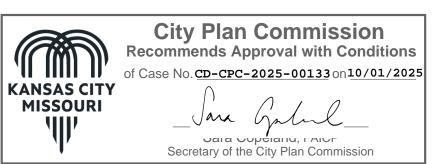
SCALE: 1 INCH = 60 FEET

34.25 18.17

Interstate-435

KCFD Fire Truck

feet : 8.00 Width : 8.00 Track Lock to Lock Time : 6.0 Steering Angle : 50.0



SL	Yard Light	o
] <i>TP</i>	Telephone Pedestal	
) WM	Water Meter	OHE
- PP	Power Pole	G
<u> </u>	Guy Anchor	
GV	Gas Valve	— UGE— — — UGE—
SSMH	Sanitary Sewer Manhole	UGT
BC/BC	Back of curb to	UGTV
5.44	back of curb	0
R/W	Right of Way	
		_/ / / / / / / /

<u>Legend</u>	
	Wood plank fence
o	Chain Link Fence
SAN	Sanitary Sewer Line
— OHE OHE —	Over Head Electric
G	Gas Line
	Water Line
— UGE— — — UGE— — —	Underground Electric
—— UGT —— —— ——	Underground Telephone
UGTV	Underground Cable TV
0	Denotes Property Corner found as noted
	Lack of Direct Access

architects engineers

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McDONALD S CONCEPT F BLACK & N BUILDING

PREPARED FOR: Black & McDonald 4101 Main Street Grandview. Mo. 64030

REVISION

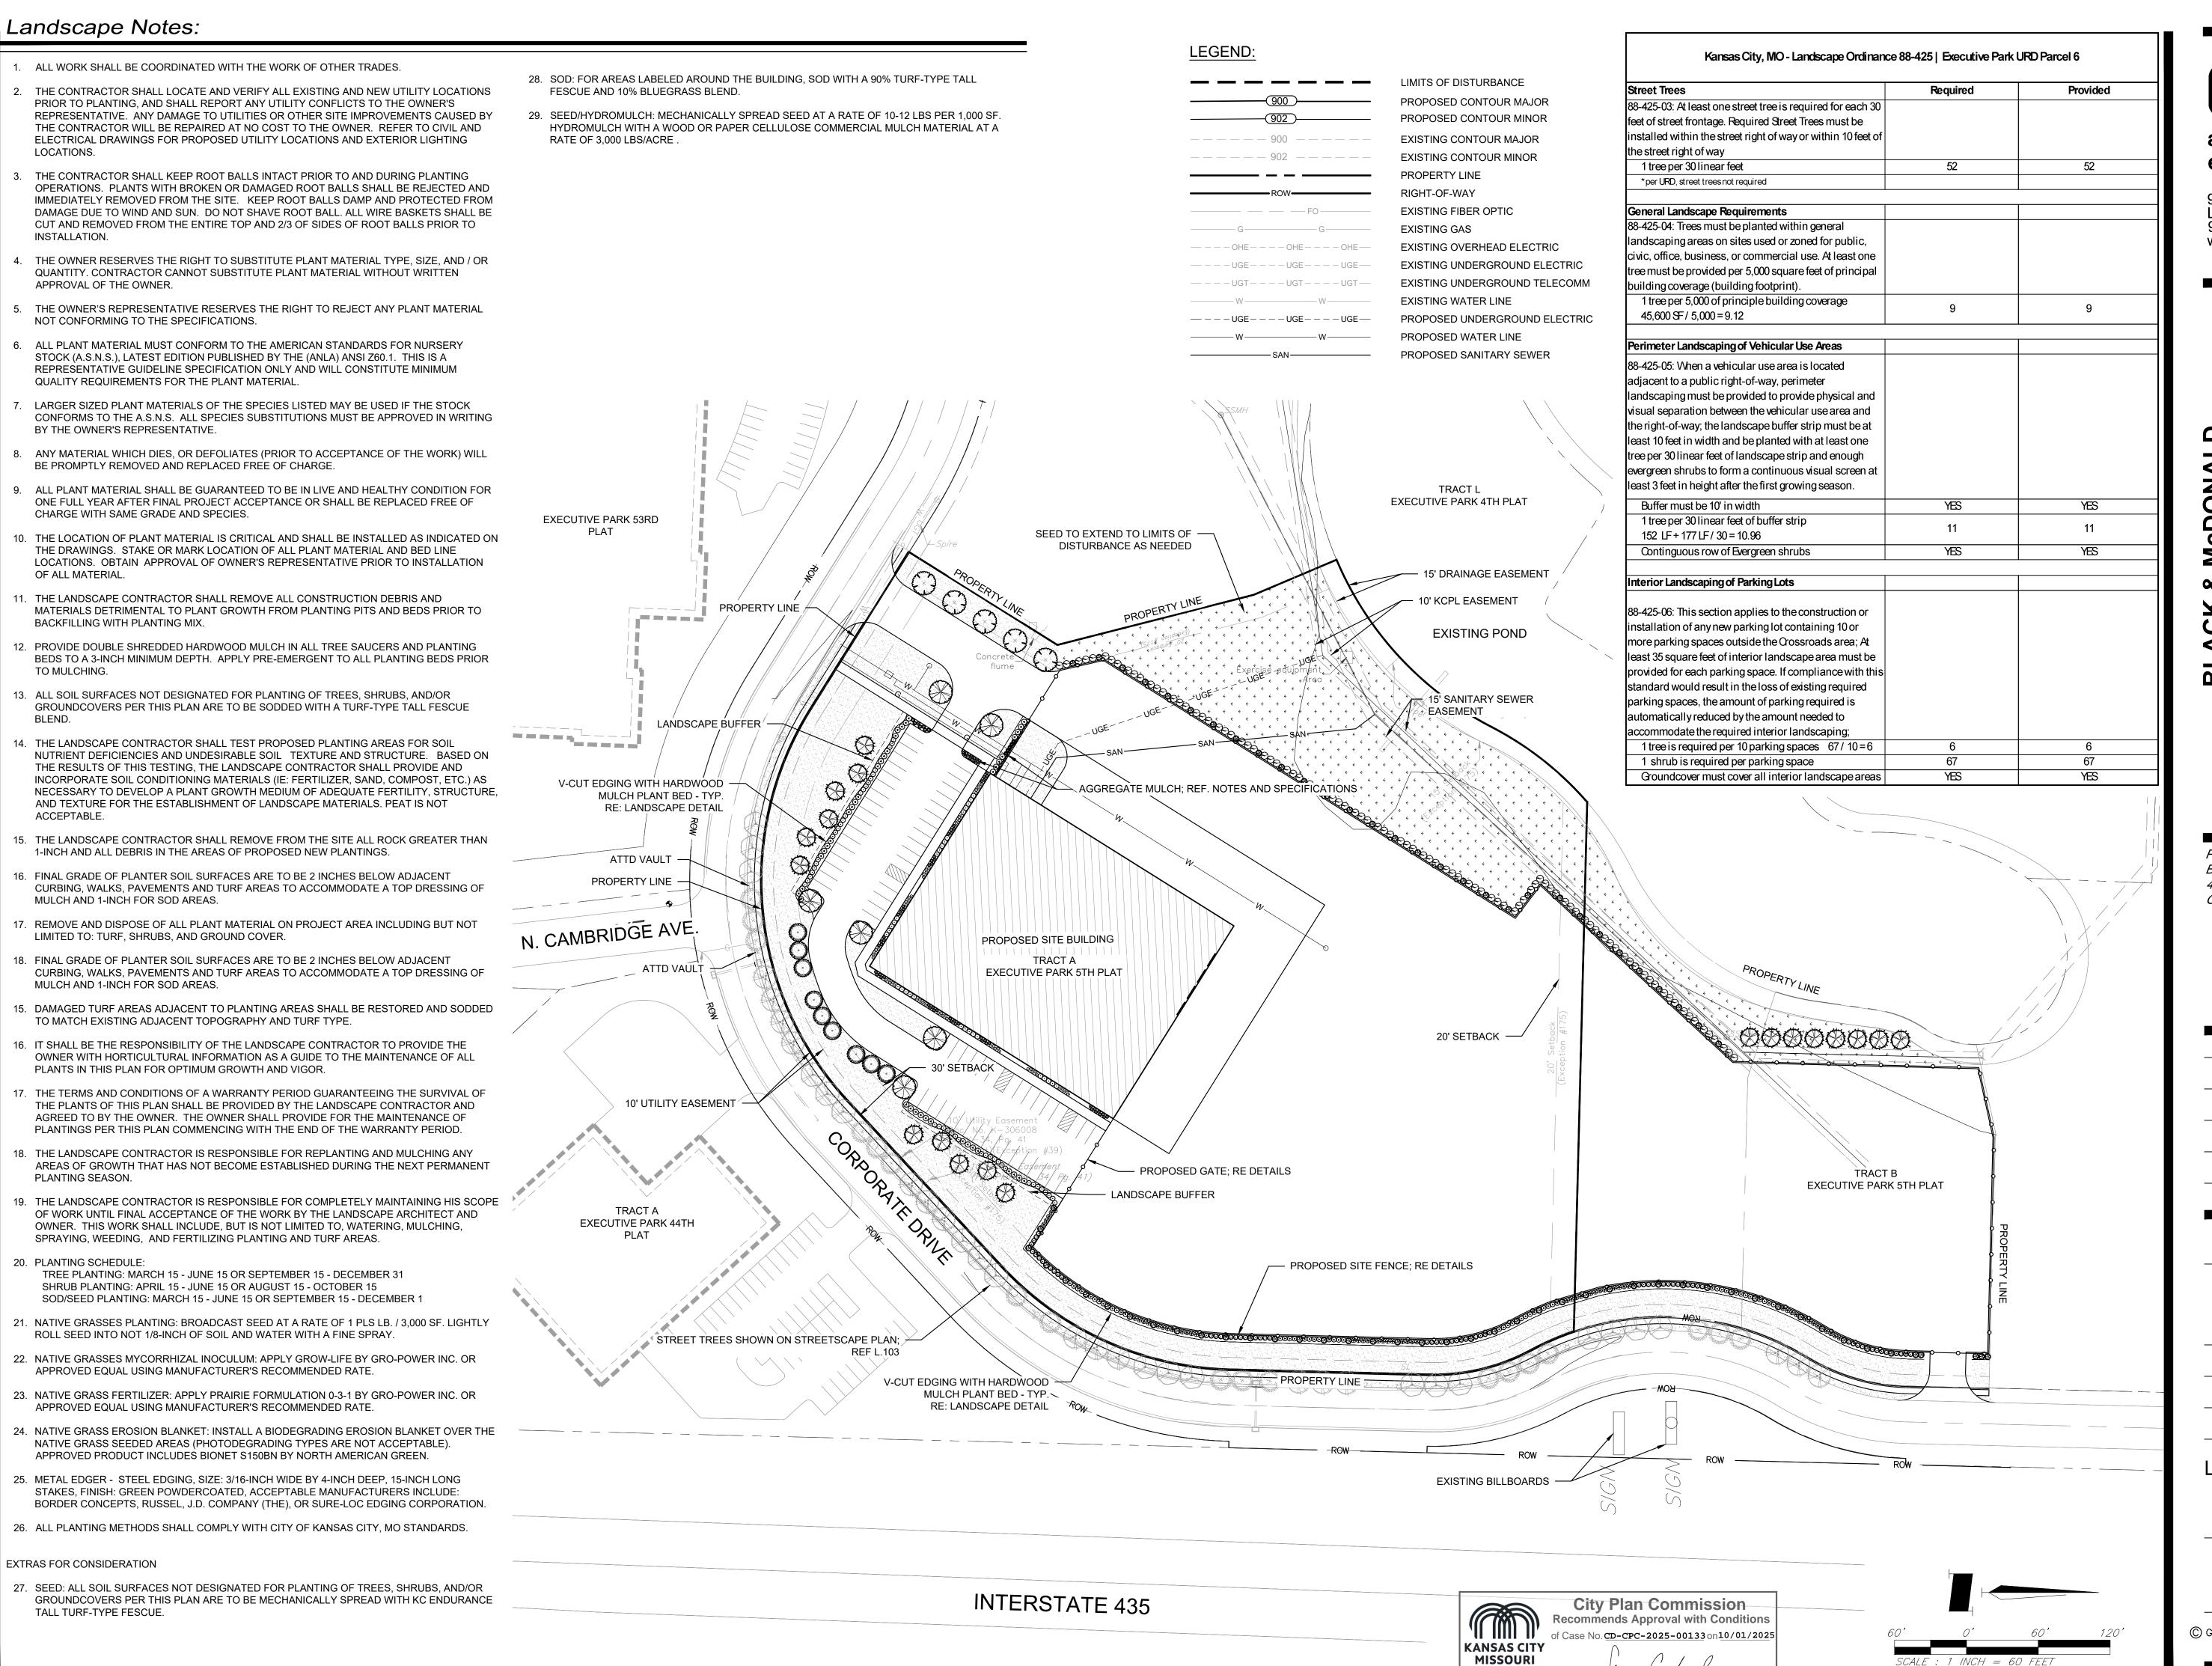
PROJECT NUMBER 16874.00 09/02/25

SITE PLAN

SHEET NUMBER

C1.00

© George Butler Associates, Inc. 2025 Architect 00212, Professional Engineer 000133 Landscape Architect 000025, Professional Land Surveyor 000059



architects engineers

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6830 N. CORPORATE DRIVE TRACT A, EXECUTIVE PARK FIFTH PLAT,

PREPARED FOR: Black & McDonald 4101 Main Street Grandview. Mo. 64030

REVISION

PROJECT NUMBER 16874.00

DATE 09/02/25

DESIGNED NJF DRAWN NJF REVIEWED JS

SHEET TITLE

LANDSCAPE PLAN

1400

SHEET NUMBER

L1.00

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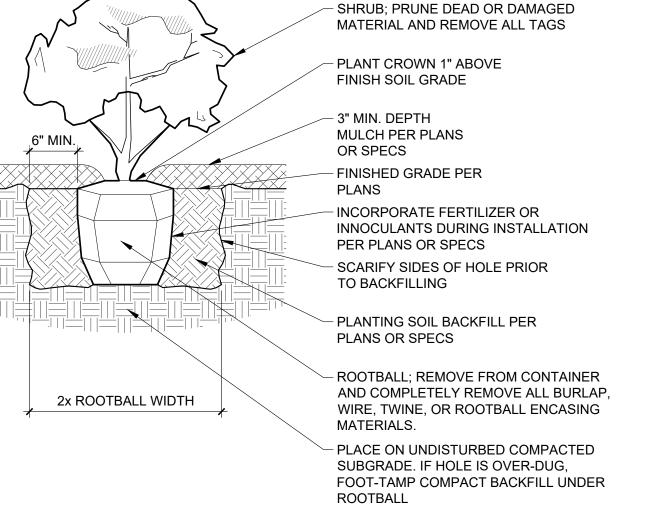
SYMBOL	CODE	BOTANICAL / COMMON NAME	SIZE	CONT.	QTY	REMARKS
TREES	CE	Cercis canadensis / Eastern Redbud Multi-trunk	2" Cal.	B&B	9	B&B, NURSERY GROWN, MATCHED, FULL, WELL-BRANCHED, STRONG CENTRAL LEADER
£ +)	GS	Gleditsia triacanthos inermis 'Skyline' / Skyline Honey Locust	2" Cal.	B&B	5	B&B, NURSERY GROWN, MATCHED, FULL, WELL-BRANCHED, STRONG CENTRAL LEADER
	JS	Juniperus chinensis 'Spartan' / Spartan Juniper	5'-6' Ht.	Container	75	CONTAINER, NURSERY GROWN, MATCHED, FULL, WELL-BRANCHED, STRONG CENTRAL LEADER
	JT	Juniperus virginiana 'Taylor' / Taylor Eastern Redcedar	5'-6' Ht.	Container	5	CONTAINER, NURSERY GROWN, MATCHED, FULL, WELL-BRANCHED, STRONG CENTRAL LEADER
	QS	Quercus shumardii / Shumard Oak	2" Cal.	B&B	6	B&B, NURSERY GROWN, MATCHED, FULL, WELL-BRANCHED, STRONG CENTRAL LEADER
	TD	Taxodium distichum / Bald Cypress	2" Cal.	B&B	19	B&B, NURSERY GROWN, MATCHED, FULL, WELL-BRANCHED, STRONG CENTRAL LEADER
SYMBOL	CODE	BOTANICAL / COMMON NAME	SIZE	CONTAINER	<u>QTY</u>	REMARKS .
SHRUBS						
· ·	BBA	Bouteloua gracilis 'Blonde Ambition' / Blonde Ambition Blue Grama	3 gal.	Pot	54	CONTAINER, NURSERY GROWN, MATCHED AND WELL ROOTED
£(**)}	BSW	Buxus sinica insularis 'Wintergreen' / Wintergreen Korean Boxwood	5 gal.	Pot	45	CONTAINER, NURSERY GROWN, MATCHED AND WELL ROOTED
	CKA	Calamagrostis x acutiflora 'Karl Foerster' / Karl Foerster Feather Reed Grass	3 gal.	Pot	7	CONTAINER, NURSERY GROWN, MATCHED AND WELL ROOTED
	CA	Callicarpa americana / American Beautyberry	3 gal.	Pot	52	CONTAINER, NURSERY GROWN, MATCHED AND WELL ROOTED
5 - 2 - 2 - 2 - 2 - 2 - 2 - 2 - 2 - 2 -	CF	Cornus sericea 'Farrow' / Arctic Fire® Red Twig Dogwood	3 gal.	Pot	60	CONTAINER, NURSERY GROWN, MATCHED AND WELL ROOTED
(·)	НВА	Hydrangea paniculata 'ILVOBO' / Bobo® Panicle Hydrangea	3 gal.	Pot	30	CONTAINER, NURSERY GROWN, MATCHED AND WELL ROOTED
,	JLC	Juniperus chinensis 'Gold Lace' / Gold Lace Juniper	5 gal.	Pot	42	CONTAINER, NURSERY GROWN, MATCHED AND WELL ROOTED
	JFC	Juniperus chinensis 'Sea Green' / Sea Green Juniper	5 gal.	Pot	95	CONTAINER, NURSERY GROWN, MATCHED AND WELL ROOTED
•	SHD	Sporobolus heterolepis / Prairie Dropseed	3 gal.	Pot	55	CONTAINER, NURSERY GROWN, MATCHED AND WELL ROOTED
**************************************	TMD	Taxus x media 'Densiformis' / Dense Anglo-Japanese Yew	5 gal.	Pot	48	CONTAINER, NURSERY GROWN, MATCHED AND WELL ROOTED
GROUND (COVERS					
	AO	Aggregate Mulch; Ref. Notes and Specifications / 1'-3' Missouri Rainbow Rock	Mulch		169 sf	REFER TO NOTES AND SPECIFICATIONS
\ \ \ \ \ \ \ \ \ \ \ \ \ \ \ \ \ \ \	FE2	Turfgrass Fescue Seed Mix / Fescue Seed Mix	Seed		55,822 sf	REFER TO NOTES AND SPECIFICATIONS
	FE	Turfgrass Fescue Sod / Fescue Sod	Sod		68,475 sf	REFER TO NOTES AND SPECIFICATIONS

NOTE: PLANT QUANTITIES ARE PROVIDED FOR CONVENIENCE ONLY IN THE CASE OF A DISCREPANCY, THE DRAWING SHALL TAKE PRECEDENCE.

NOTE: PLANTS ARE SPECIFIED BY HEIGHT, SPREAD AND/OR CONTAINER SIZE. ALL PLANTINGS ARE EXPECTED TO MEET ALL SPECIFICATIONS PROVIDED.

PLANTING BED MULCH PER PLANS

3 V-CUT NATURAL EDGE



SHRUB PLANTING

1" = 1'-0"

P-16874-03

City Plan Commission
Recommends Approval with Conditions of Case No. CD-CPC-2025-00133 on 10/01/2025 **KANSAS CITY MISSOURI** Secretary of the City Plan Commission REMOVE TWINE FROM BRANCHES ON TREES TIED FOR SHIPPING. SPRAY WITH WILT PRUF OR EQUAL (IF LEAFED OUT) - 12" X 1-1/2" NYLON/COTTON WEAVE TIES WITH 3/4" GROMMETS - 12 GA. WIRE; FASTEN TO TIES BELOW POINT OF MAJOR BRANCHING OR TO MAJOR OUTSIDE TRUNK. WRAP AROUND STAKE AND STAPLE - TREE WRAP (FROM BOTTOM UP); RE: PLANS OR SPECS
— PLANT CROWN, SET UPPERMOST ROOTS
WITHIN 1" OF FINISHED GRADE. DO NOT PLACE SOIL OR MULCH AGAINST TRUNK!! - 3" MIN. DEPTH MULCH; RE: PLANS OR SPECS 12" MIN. COMPLETELY REMOVE ALL TWINE, WIRE, BURLAP OR OTHER ROOT BALL ENCASEMENT PRIOR TO INSTALLATION. BACKFILL PLANTING MIX (RE: PLANS OR SPECS); NOTE: IF HOLE IS DUG TOO DEEP, COMPACT BACKFILL SOIL SUPPORTING NEW 2x ROOTBALL TREE TO PROVIDE A STABLE BASE FREE WIDTH FROM SETTLING COMPACTED SUBGRADE

DECIDUOUS TREE

P-16874-02

P-16874-01

GBA architects engineers

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G CONCEPT PLAN
CORPORATE DRIVE
EXECUTIVE PARK FIFTH PLAT,

6830 N. CORPORATE DRIVI PART OF TRACT A, EXECUTIVE PARK A SURDIVISION IN KANSAS CITY, JACKSON C

PREPARED FOR: Black & McDonald 4101 Main Street Grandview. Mo. 64030

REVISION

PROJECT NUMBER 16874.00

DATE 09/02/25

DESIGNED NJF DRAWN NJF REVIEWED JS

SHEET TITLE

LANDSCAPE

DETAILS

L1.01

SHEET NUMBER

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NG CONCEPT PLAN

N. CORPORATE DRIVE

T.A. EXECUTIVE PARK FIFTH PLAT,

PREPARED FOR: Black & McDonald 4101 Main Street

Grandview. Mo. 64030

PROJECT NUMBER 16874.00 DATE 09/02/25

> DESIGNED NJF DRAWN NJF REVIEWED

SHEET TITLE

LANDSCAPE PLAN

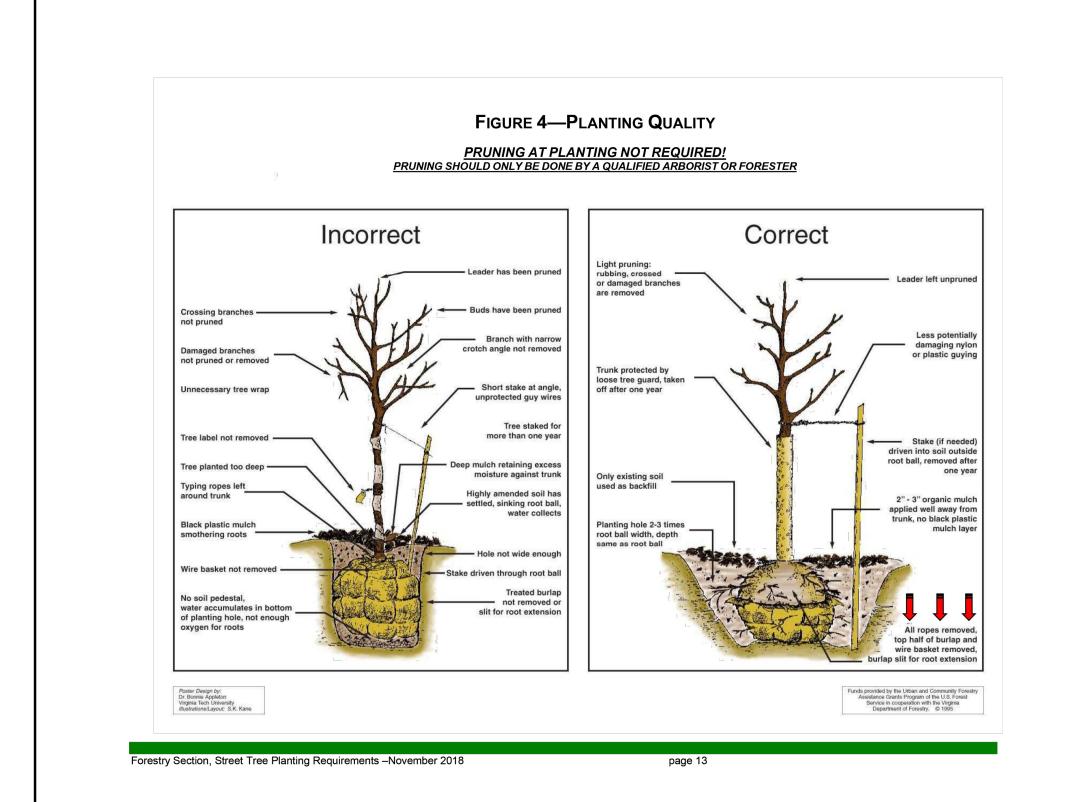
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Secretary of the City Plan Commission

FIGURE 5—TREE PROTECTION TREE PROTECTION AREA The area inside a perimeter established at the Critical Root Zone (CRZ). The CRZ is equal to the dripline (furthest extent of tree canopy) or is equal to one foot radially from the tree for every one inch of trunk diameter at breast height (DBH), whichever is greater. LOWER CANOPY PROTECTION. Contact City Forester if any pruning is needed prior to work if potential for damage exists. TRUNK PROTECTION. Required if construction equipment involved within ten feet or less (permitted inside the CRZ only if equipment is operated exclusively on existing hardscape and no soil compaction takes place). NOTES Fencing Height must be at least 48." Attach "Tree Protection Area" Signs (template ZONE 1 ROOT PROTECTION. available from City Forester) to Fencing every 50 Extends through entire tree protection area. The Tree Protection Area shall <u>not</u> be modified or removed prior to consent of the City Forester. Any digging, excavating, trenching, changing of grade, or other actions that may potentially Materials, debris, equipment, and site amenities shall not be stored within the Tree Protection impact the rooting environment must be authorized by the City Forester prior to work commencement. Work within the CRZ must take place in accordance with the conditions established by the City Forester. Entrance to the Tree Protection Area is not permitted without consent of the City Forester. Tree Protection Detail - Individual Tree



Forestry Section, Street Tree Planting Requirements –November 2018

City Plan Commission
Recommends Approval with Conditions
of Case No. CD-CPC-2025-00133 on 10/01/2025

KANSAS CITY
MISSOURI

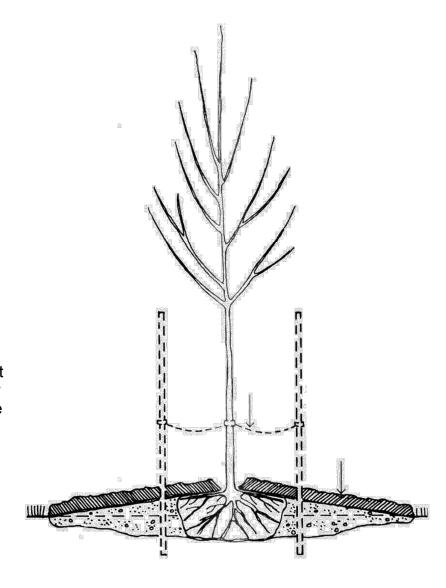
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Secretary of the City Plan Commission

FIGURE 3—TREE PLANTING IN COMPACTED SOIL DETAIL

To test for compacted soil, do a simple percolation test. Dig a hole 12 inches to 18 inches deep and fill it with water. If the water is still in the hole 12 to 18 hours later, then you have compacted or heavy clay soils.

Roots need oxygen, so dig a wide shallow hole three to four times the width of the root ball or container and only half as deep. Mound backfill soil slightly to the top of the root flare, covering the entire excavation. This creates a raised planting bed, which will improve the tree's performance. Soils that hold excessive moisture may need a subsurface drain tube installed below the root ball.



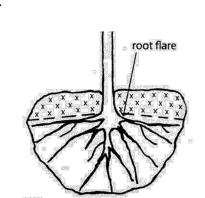
Forestry Section, Street Tree Planting Requirements –November 2018

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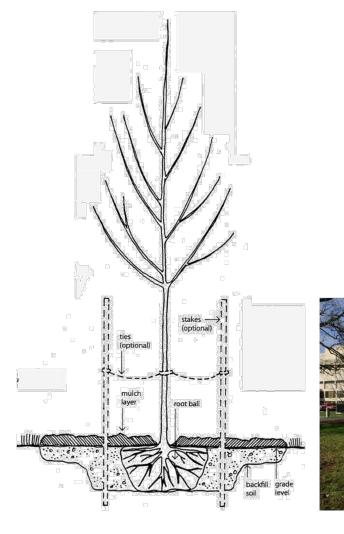
FIGURE 2— TREE PLANTING STANDARD DETAIL

Finding the Root Flare:

For balled-and-burlapped trees, probe the top of the soil ball chose to the trunk to find the first roots. You can do this with a stout wire. Check in two or more locations to make sure you've located the top major roots. Leave the burlap in place to make moving the tree easier. Measure the distance from the top of the soil ball to the root flare. Next, subtract that distance from the total depth of the burlapped soil ball.



The distance from the top-most buried root to the bottom of the ball is the correct depth to dig the pit.



Forestry Section, Street Tree Planting Requirements –November 2018

page 11

architects engineers

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CK & McDONALD
DING CONCEPT PLAN
6830 N. CORPORATE DRIVE
FRACT A, EXECUTIVE PARK FIFTH PLAT,

PART OF TRACT A, EXECUTII A SUBDIVISION IN KANSAS CITY, JA

PREPARED FOR: Black & McDonald 4101 Main Street Grandview. Mo. 64030

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REVISION	

PROJECT NUMBER 16874.00

09/02/25

DESIGNED NJF DRAWN


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SHEET TITLE

LANDSCAPE PLAN

SHEET NUMBER

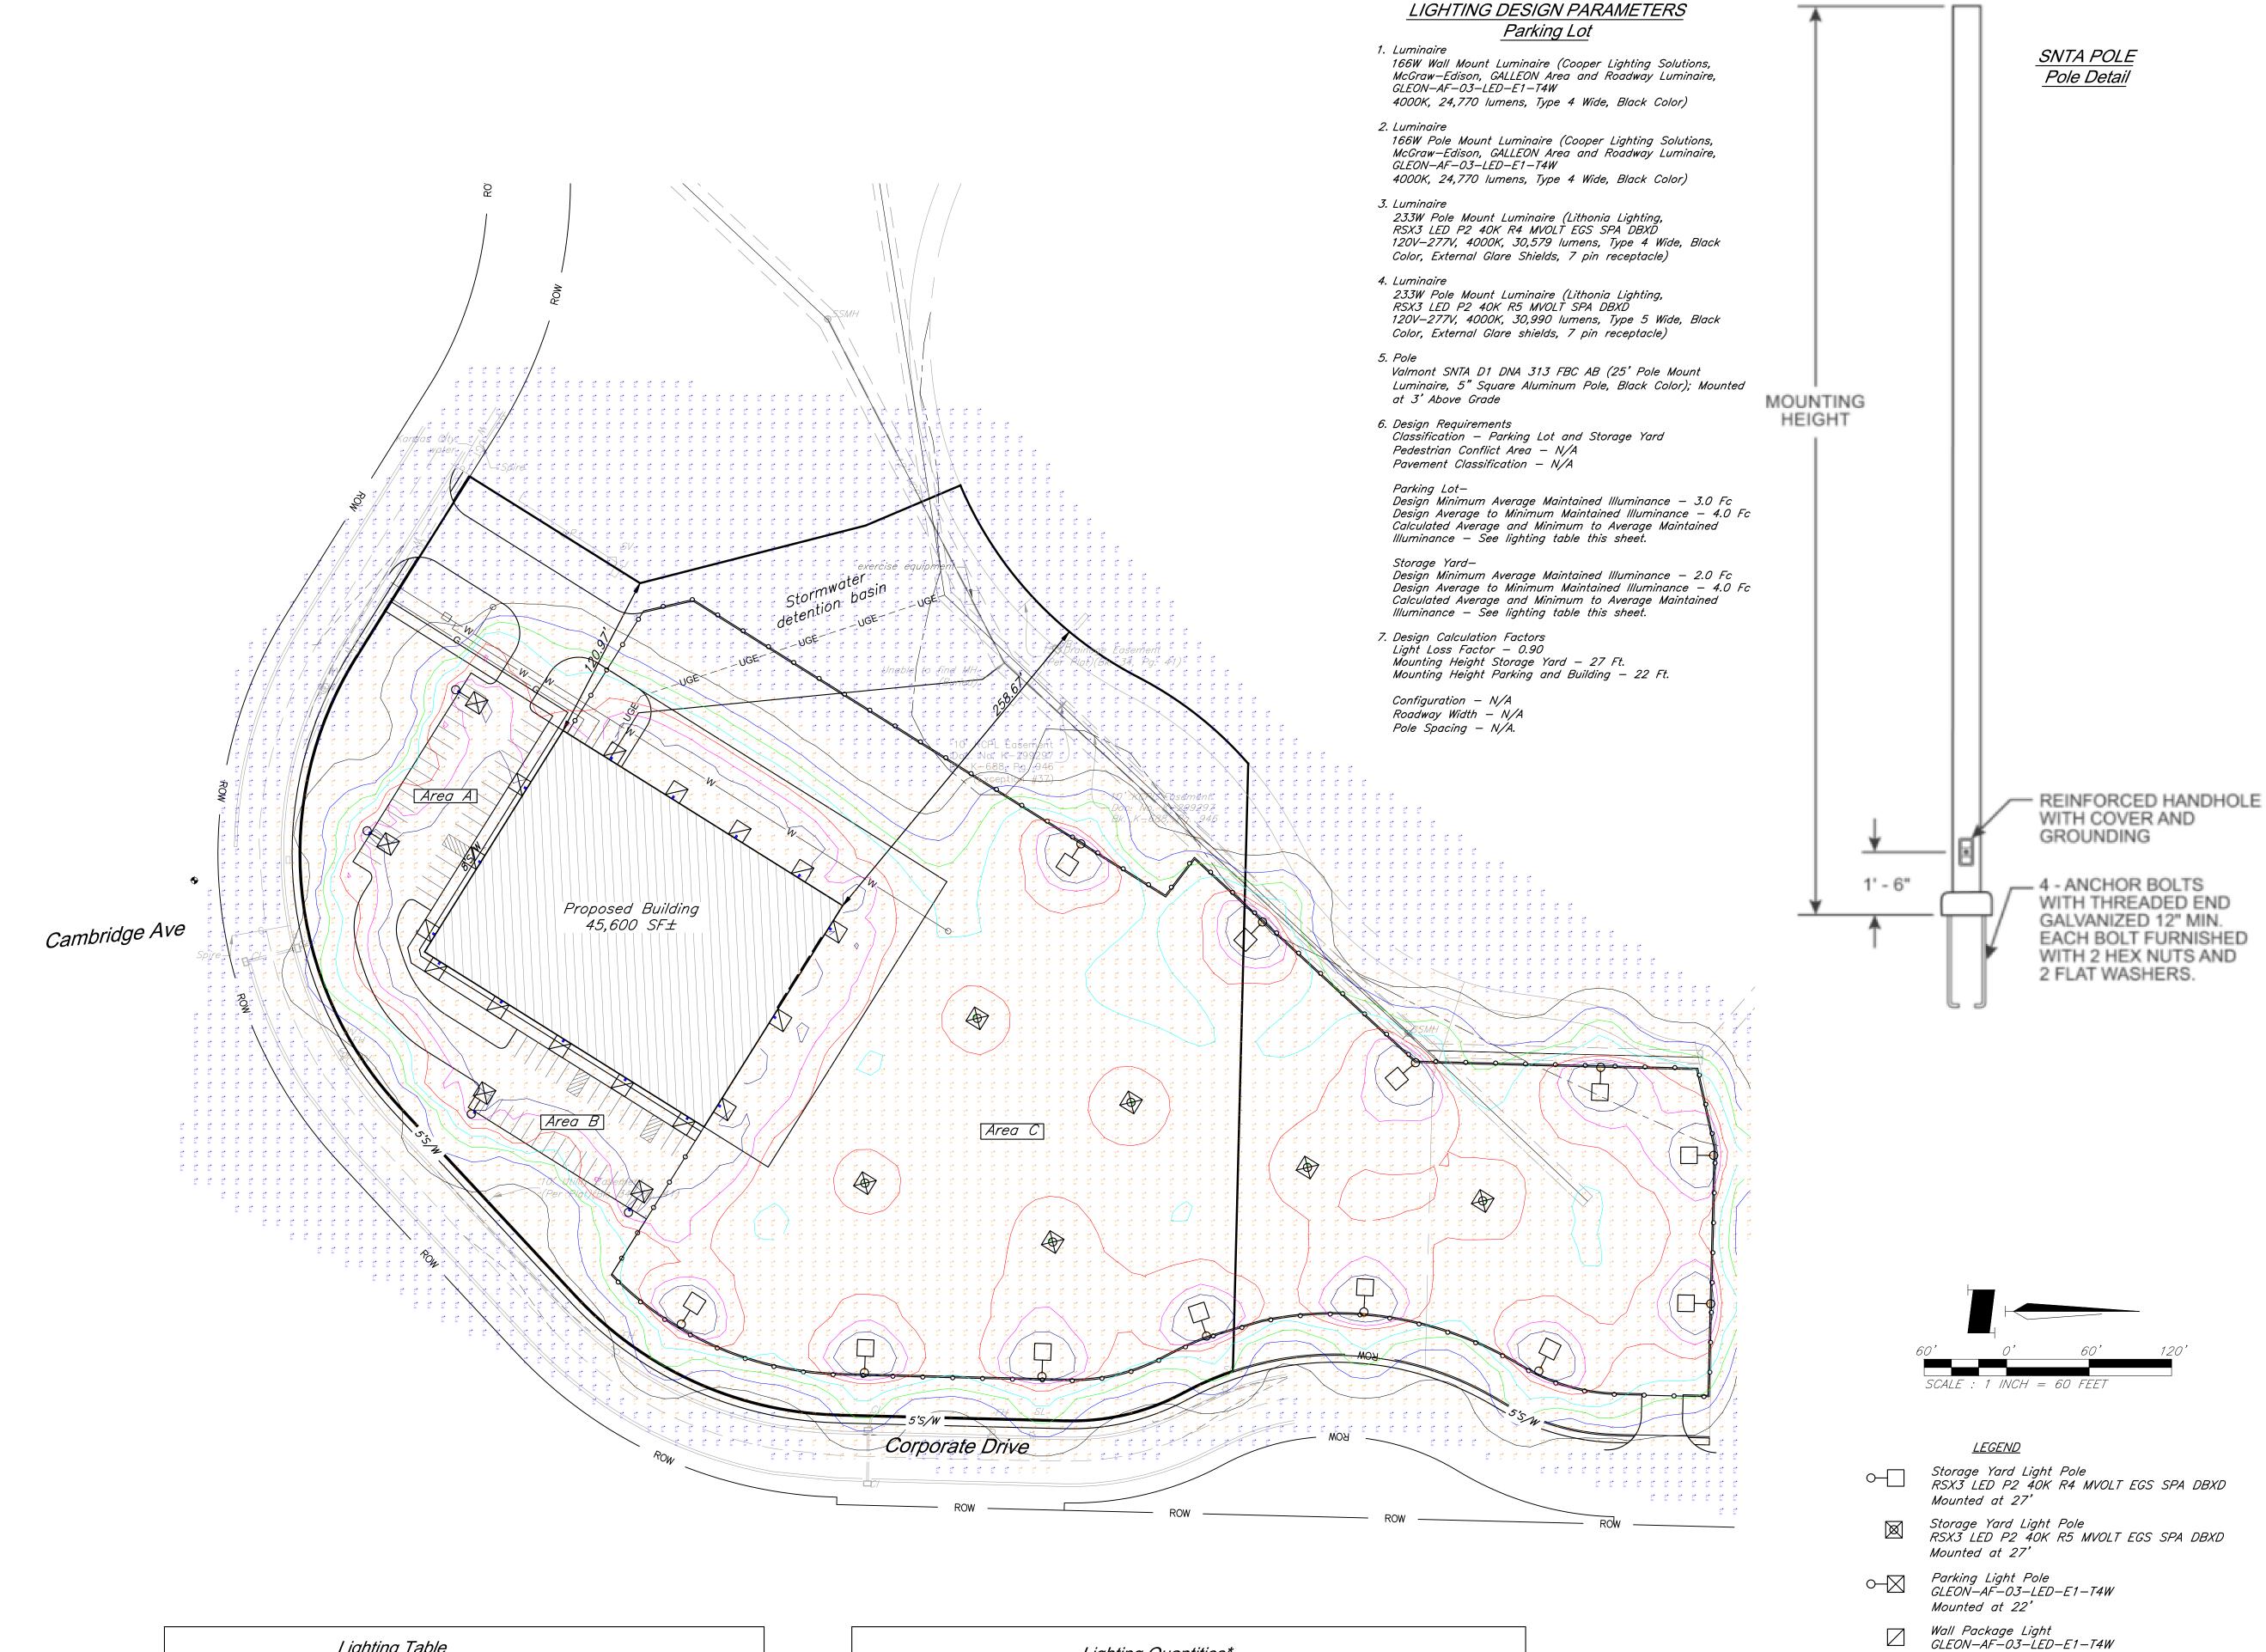L1.00



Lighting Table			
Proposed Lighting Area	А	В	С
Design Minimum Average Maintained Illuminance	3.0 Fc	3.0 Fc	2.0 Fc
Calculated Average Maintained Illuminance	3.66 Fc	4.19 Fc	2.13 Fc
Calculated Average/Min	3.33	4.66	4.26

Lighting Quantities*		
		Quantity
166W Wall Mount Luminaire (GLEON-AF-03-LED-E1-T4W)	Each	15
166W Pole Mount Luminaire (GLEON-AF-03-LED-E1-T4W)	Each	4
233W Pole Mount Luminaire (RSX3 LED P2 40K R4 MVOLT EGS SPA DBXD)	Each	12
233W Pole Mount Luminaire (RSX3 LED P2 40K R5 MVOLT SPA DBXD)	Each	6
25' Steel Pole (Valmont DS330 400W250 D1 FP MB FBC CB)	Each	22
24" Dia. Concrete Foundation (Pedestal with 3' Above Grade)	Each	22

* These approximate quantities were prepared solely for information only. It is not guaranteed that this list of materials constitutes all items required for the completion of the work.



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BLACK & McDONALD
BUILDING CONCEPT PLAN
6830 N. CORPORATE DRIVE
ART OF TRACT A, EXECUTIVE PARK FIFTH PLAT,
VISION IN KANSAS CITY, JACKSON COUNTY, MISSOURI

PREPARED FOR: Black & McDonald 4101 Main Street Grandview. Mo. 64030

REVISION

PROJECT NUMBER 16874.00 DATE 09/02/25

DESIGNED NJF DRAWN NJF REVIEWED

JS SHEET TITLE

LIGHTING PLAN

Mounted at 22'

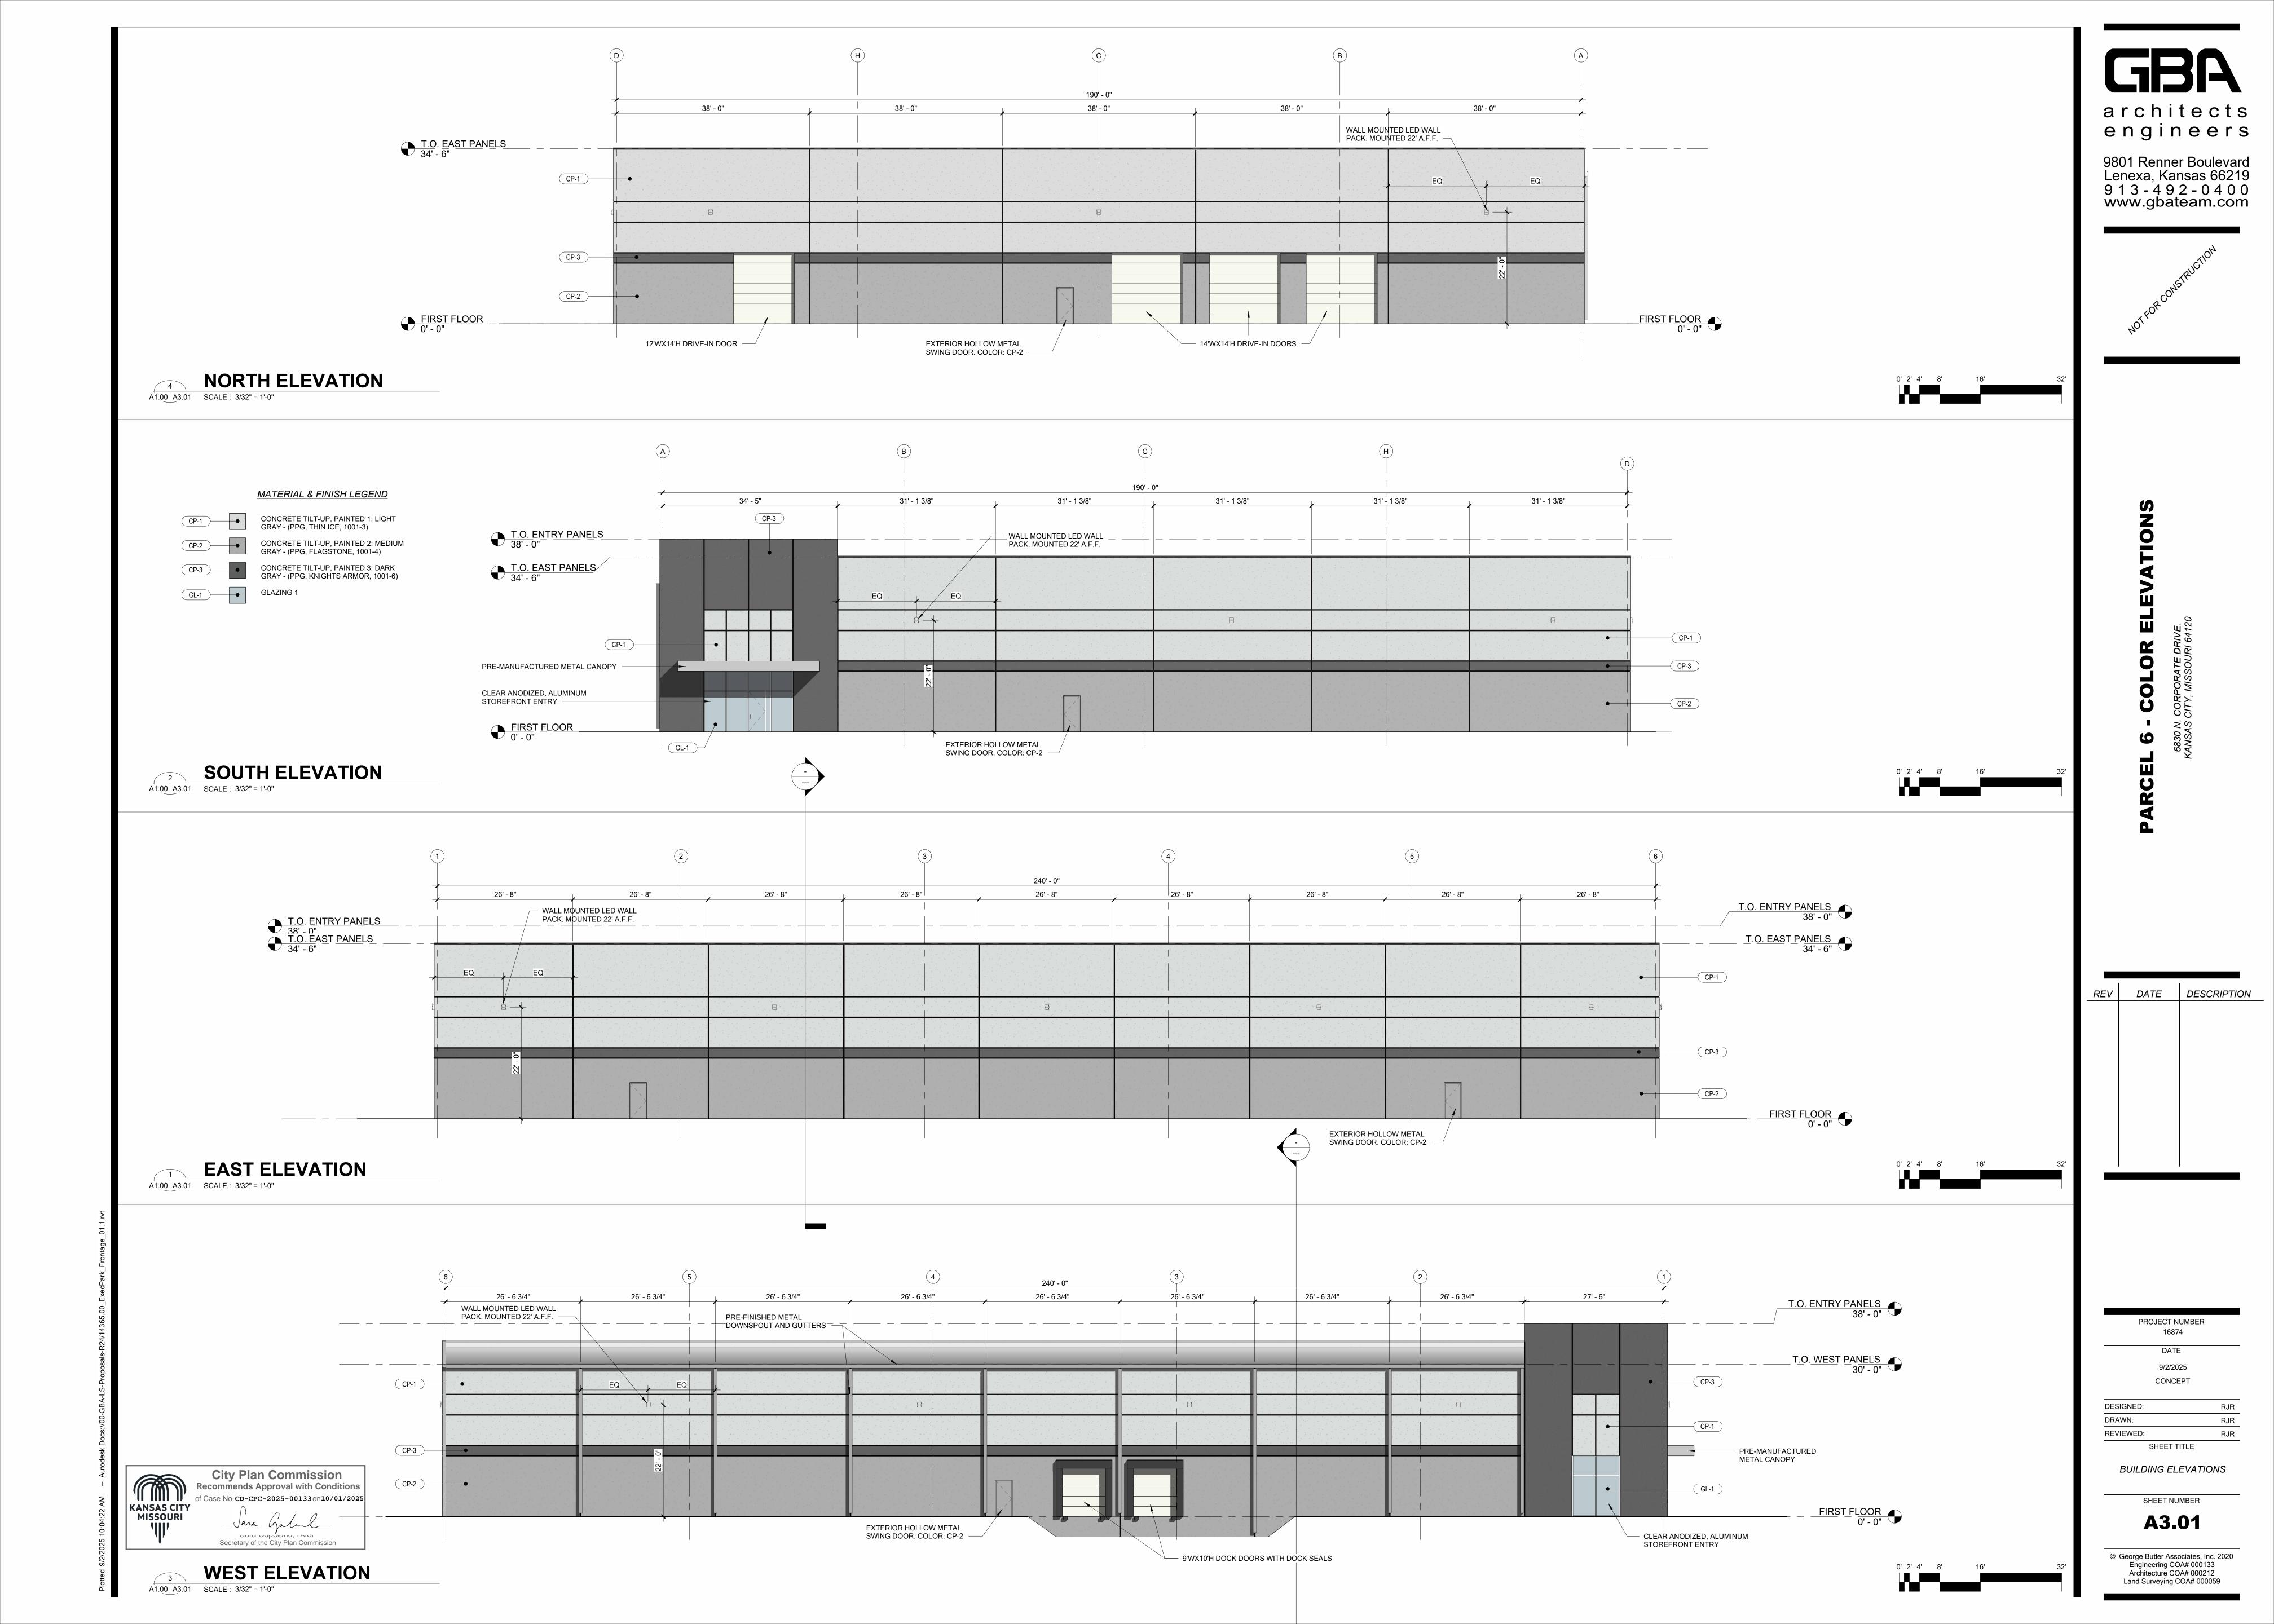
KANSAS CITY MISSOURI **City Plan Commission**

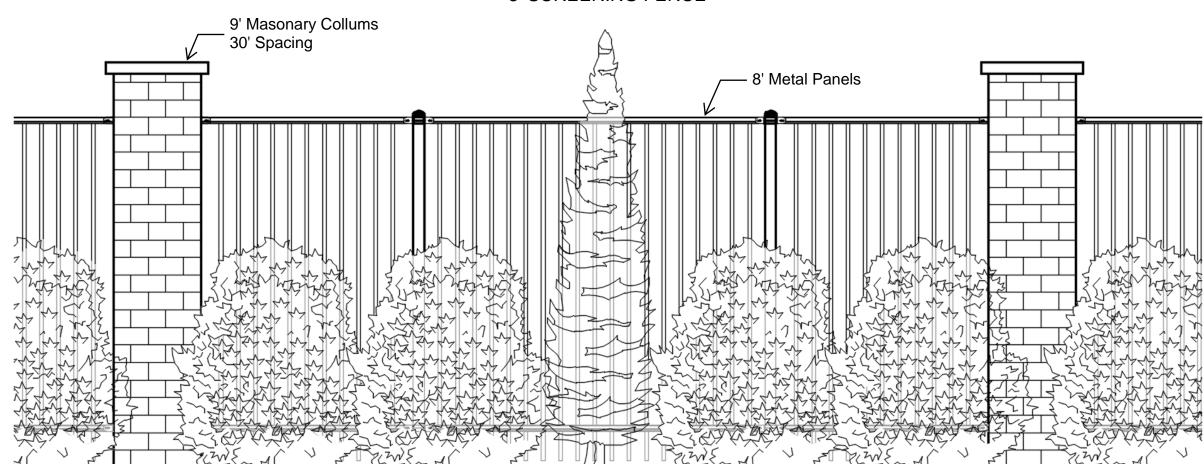
Recommends Approval with Conditions of Case No. CD-CPC-2025-00133 on 10/01/2025

Secretary of the City Plan Commission

SHEET NUMBER

E1.00







PLANT SCHEDULE

SYMBOL	CODE	BOTANICAL / COMMON NAME	SIZE	CONT.	QTY	REMARKS
TREES						
	CE	Cercis canadensis / Eastern Redbud Multi-trunk	2" Cal.	B&B	9	B&B, NURSERY GROWN, MATCHED, FULL, WELL-BRANCHED, STRONG CENTRAL LEADER
£ + 3	GS	Gleditsia triacanthos inermis 'Skyline' / Skyline Honey Locust	2" Cal.	B&B	5	B&B, NURSERY GROWN, MATCHED, FULL, WELL-BRANCHED, STRONG CENTRAL LEADER
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	TD	Taxodium distichum / Bald Cypress	2" Cal.	B&B	19	B&B, NURSERY GROWN, MATCHED, FULL, WELL-BRANCHED, STRONG CENTRAL LEADER
SYMBOL	CODE	BOTANICAL / COMMON NAME	SIZE	CONTAINER	QTY	REMARKS
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5 65 8 8 8 8 8 8 8 8 8 8 8 8 8 8 8 8 8 8	CF	Cornus sericea 'Farrow' / Arctic Fire® Red Twig Dogwood	3 gal.	Pot	60	CONTAINER, NURSERY GROWN, MATCHED AND WELL ROOTED
(\cdot)	HBA	Hydrangea paniculata 'ILVOBO' / Bobo® Panicle Hydrangea	3 gal.	Pot	30	CONTAINER, NURSERY GROWN, MATCHED AND WELL ROOTED
,	JLC	Juniperus chinensis 'Gold Lace' / Gold Lace Juniper	5 gal.	Pot	42	CONTAINER, NURSERY GROWN, MATCHED AND WELL ROOTED
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Exercise Services	TMD	Taxus x media 'Densiformis' / Dense Anglo-Japanese Yew	5 gal.	Pot	48	CONTAINER, NURSERY GROWN, MATCHED AND WELL ROOTED
GROUND (COVERS					
	AO	Aggregate Mulch; Ref. Notes and Specifications / 1'-3' Missouri Rainbow Rock	Mulch		169 sf	REFER TO NOTES AND SPECIFICATIONS
\ \ \ \ \ \ \ \ \ \ \ \ \ \ \ \ \ \ \	FE2	Turfgrass Fescue Seed Mix / Fescue Seed Mix	Seed		55,822 sf	REFER TO NOTES AND SPECIFICATIONS
	FE	Turfgrass Fescue Sod / Fescue Sod	Sod		68,475 sf	REFER TO NOTES AND SPECIFICATIONS
NOTE: PLANT QUANTITIES ARE PROVIDED FOR CONVENIENCE ONLY IN THE CASE OF A DISCREPANCY, THE DRAWING SHALL TAKE PRECEDENCE. NOTE: PLANTS ARE SPECIFIED BY HEIGHT, SPREAD AND/OR CONTAINER SIZE. ALL PLANTINGS ARE EXPECTED TO MEET ALL SPECIFICATIONS PROVIDED.						

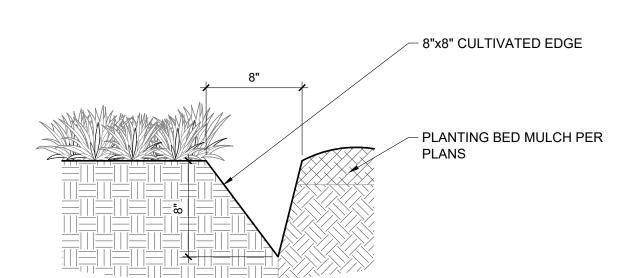
A DISCREPANCY, THE DRAWING SHALL TAKE PRECEDENCE.



P-16874-03

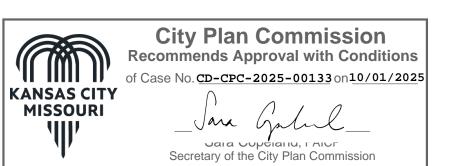

1 1/2" = 1'-0"

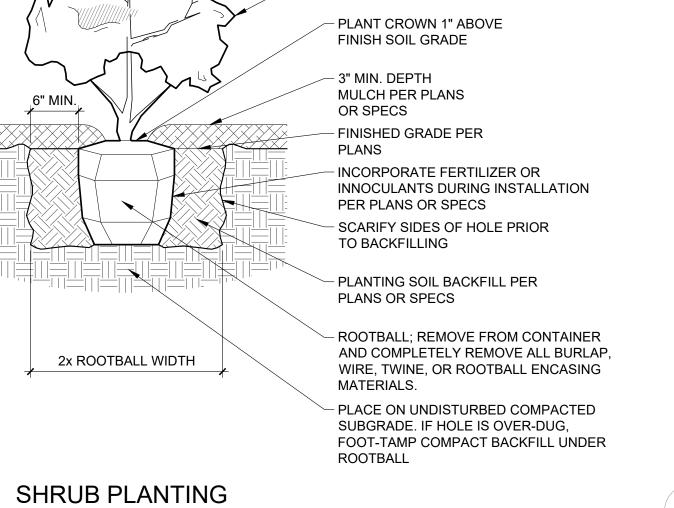

SHRUB; PRUNE DEAD OR DAMAGED

P-16874-02

MATERIAL AND REMOVE ALL TAGS

2x ROOTBALL

REMOVE TWINE FROM BRANCHES ON TREES TIED FOR SHIPPING. SPRAY WITH WILT PRUF OR EQUAL (IF LEAFED OUT) - 12" X 1-1/2" NYLON/COTTON WEAVE TIES WITH 3/4" GROMMETS

- 12 GA. WIRE; FASTEN TO TIES BELOW POINT OF MAJOR BRANCHING OR TO MAJOR OUTSIDE TRUNK. WRAP AROUND STAKE AND STAPLE - TREE WRAP (FROM BOTTOM UP); RE: PLANS OR SPECS
— PLANT CROWN, SET UPPERMOST ROOTS
WITHIN 1" OF FINISHED GRADE. DO NOT PLACE SOIL OR MULCH AGAINST TRUNK!!

- 3" MIN. DEPTH MULCH; RE: PLANS OR SPECS

COMPLETELY REMOVE ALL TWINE, WIRE, BURLAP OR OTHER ROOT BALL ENCASEMENT PRIOR TO INSTALLATION.

BACKFILL PLANTING MIX (RE: PLANS OR SPECS); NOTE: IF HOLE IS DUG TOO DEEP, COMPACT BACKFILL SOIL SUPPORTING NEW TREE TO PROVIDE A STABLE BASE FREE FROM SETTLING COMPACTED SUBGRADE

P-16874-01

architects engineers

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REVISION

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JS SHEET TITLE LANDSCAPE

DETAILS

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