VICINITY MAP

PROJECT TEAM

DEVELOPER

ALTIRA HOTELS KCI, LLC 2323 GRAND BOULEVARD, SUITE 1100 KANSAS CITY, MO 64108 CONTACT: MIKE PATEL EMAIL: MIKEPATEL@MARQUEEHOSPITALITY.COM

CIVIL ENGINEER, LANDSCAPE ARCHITECT

KIMLEY-HORN & ASSOCIATES, INC.
805 PENNSYLVANIA AVENUE, SUITE 150
KANSAS CITY, MO 64105
TEL: (816) 652-0350
PRIMARY CONTACT: MATTHEW KIST, P.E.
EMAIL: MATT.KIST@KIMLEY-HORN.COM
SECONDARY CONTACT: KAITLIN RAYNOR
EMAIL: KAITLIN.RAYNOR@KIMLEY-HORN.COM

ARCHITECT, LIGHTIN

TYPE SIX
920 S MAIN ST, SUITE 150
GRAPEVINE TX, 76051
TEL: (682) 365-3381
PRIMARY CONTACT: JAMES LUSTY
EMAIL: JAMES.LUSTY@TYPE-SIX.COM
SECONDARY CONTACT: DYLAN SCOTT
EMAIL: DYLAN.SCOTT@TYPE-SIX.COM


LEGAL DESCRIPTION


TRACT A OF THE CERTAIN LOT SPLIT SURVEY OF LOTS 12D, 12E AND 12F, EXECUTIVE HILLS NORTH, BLOCKS 12 AND 26, KANSAS CITY, PLATTE COUNTY, MISSOURI MORE PARTICULARLY DESCRIBED AS FOLLOWS: BEGINNING AT THE SOUTHWEST CORNER OF SAID LOT SPLIT, THENCE NORTH 13 DEGREES 32 MINUTES 44 SECONDS EAST, A DISTANCE OF 512.96 FEET; THENCE NORTH 25 DEGREES 46 MINUTES 55 SECONDS EAST, A DISTANCE OF 54.91 FEET TO A POINT ON THE SOUTHERLY RIGHT-OF-WAY LINE OF TIFFANY SPRINGS PARKWAY SAID POINT ALSO BEING A POINT OF CURVATURE; THENCE CONTINUING WITH SAID SOUTHERLY RIGHT-OF-LINE OF TIFFANY SPRINGS PARKWAY, ON A CURVE TO THE RIGHT, HAVING A RADIUS OF 272.00 FEET, A CENTRAL ANGLE OF 15 DEGREES 26 MINUTES 25 SECONDS, AN INITIAL TANGENT BEARING SOUTH 72 DEGREES 36 MINUTES 33 SECONDS EAST, AN ARC DISTANCE OF 73.38 FEET; THENCE CONTINUING WITH SAID SOUTHERLY RIGHT-OF-LINE OF TIFFANY SPRINGS PARKWAY, SOUTH 57 DEGREES 00 MINUTES 00 SECONDS EAST, A DISTANCE OF 146.18 FEET TO A POINT OF CURVATURE SAID POINT ALSO BEING ON THE WESTERLY RIGHT-OF-LINE OF NORTH POLO DRIVE; THENCE CONTINUING WITH SAID WESTERLY RIGHT-OF-LINE OF NORTH POLO DRIVE, ON A CURVE TO THE RIGHT, HAVING A RADIUS OF 35.00 FEET, A CENTRAL ANGLE OF 53 DEGREES 28 MINUTES 54 SECONDS, AN INITIAL TANGENT BEARING OF SOUTH 27 DEGREES 18 MINUTES 29 SECONDS EAST, AN ARC DISTANCE OF 32.67 FEET; THENCE ON A CURVE TO LEFT, HAVING A RADIUS OF 734.67 FEET, A CENTRAL ANGLE OF 29 DEGREES 56 MINUTES 16 SECONDS, AN ARC DISTANCE OF 375.91 FEET; THENCE SOUTH 88 DEGREES 18 MINUTES 00 SECONDS WEST, A DISTANCE OF 246.12 FEET TO THE POINT OF BEGINNING. THE ABOVE DESCRIBED TRACT CONTAINS 103,622 SQUARE FEET OR 2.38 ACRES.

DEVELOPMENT PLANS FOR

LIVSMART STUDIOS KANSAS CITY

SECTION 36, TOWNSHIP 52, RANGE 34 CITY OF KANSAS CITY, PLATTE COUNTY, MISSOURI

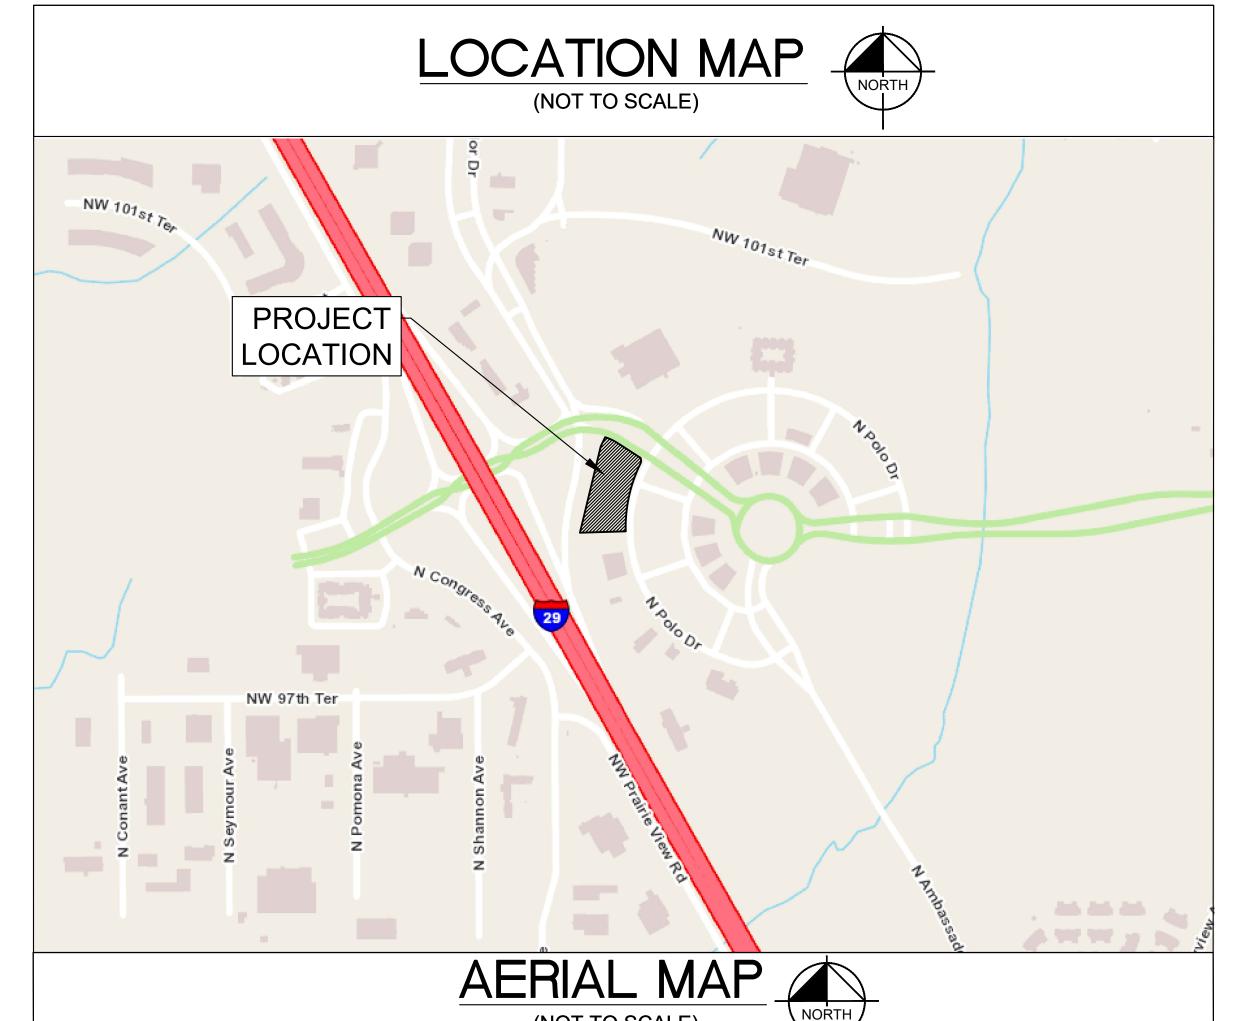


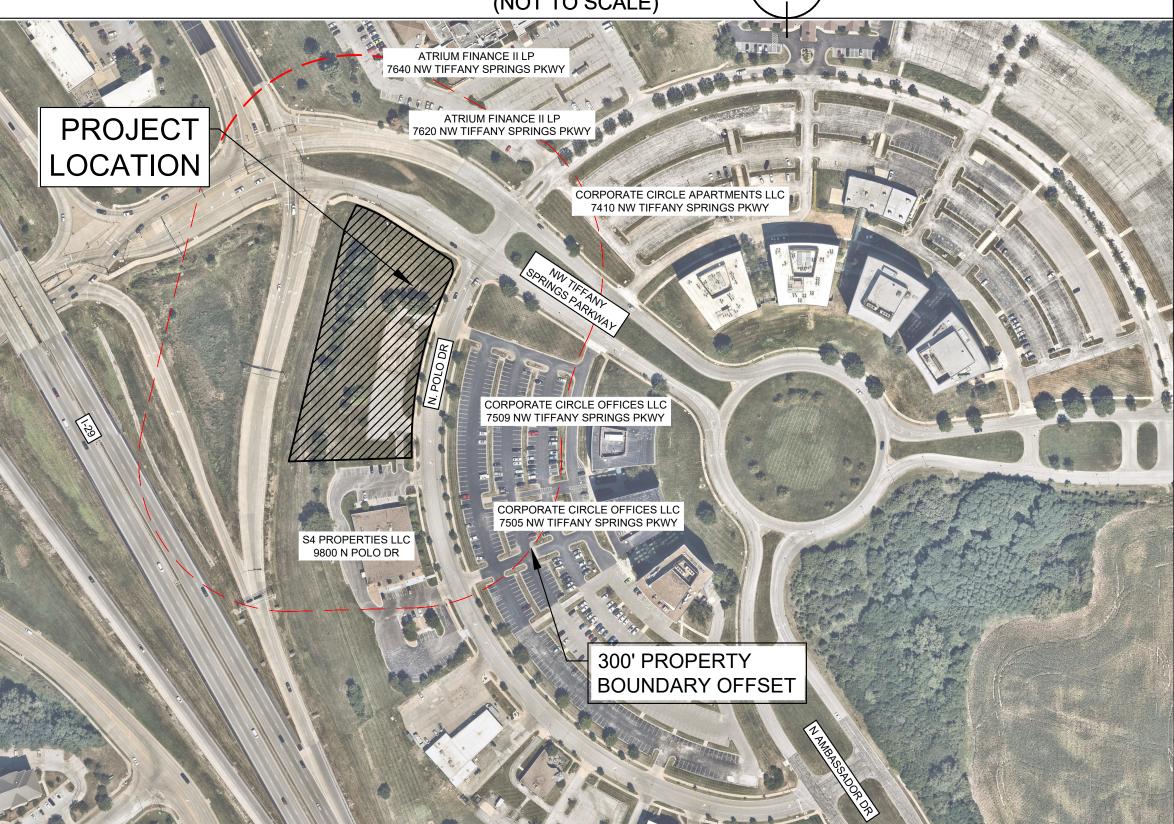



City Plan Commission Recommends Approval with Conditions

of Case No. <u>CD-CPC-2024-00019</u> on <u>06/18/202</u>4

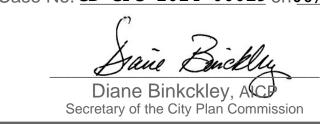

	Sheet List Table
Sheet Number	Sheet Title
C0	COVERSHEET
C1	EXISTING CONDITIONS
C2	SITE PLAN
C3	GRADING PLAN
C4	UTILITY PLAN
C5	FIRE TRUCK TURNING
L1	LANDSCAPE ARCHITECTURAL PLAN
A20.00	3D BUILDING VIEWS
A1.01	01 DIMENSION PLAN
A1.02	02 DIMENSION PLAN
A5.01	BUILDING ELEVATIONS
A5.02	BUILDING ELEVATIONS
A0.03	SITE ELEMENTS
PH1.01	PHOTOMETRICS
PH1.02	LIGHT FIXTURE DETAILS

Property Owner	Property Address	Mailing Address
S4 Proportios II C	9800 N Polo Dr	118 N Conistor Ln Ste B
S4 Properties LLC	9800 N POIO DI	#504 Liberty, MO 64068
	7505 NW Tiffany Springs	7505 NW Tiffany Springs
Corporate Circle Offices LLC	Pkwy, 7509 NW Tiffany	Pkwy Ste 100 Kansas City,
	Springs Pkwy	MO 64153
	7410 NW Tiffany Springs	7505 NW Tiffany Springs
Corporate Circle Apartments LLC	, . •	Pkwy Ste 100 Kansas City,
	Pkwy	MO 64153
	7620 NW Tiffany Springs	12725 Marris Dd Eyt Cta
Atrium Finance II LP	Pkwy, 7640 NW Tiffany	12735 Morris Rd, Ext, Ste
	Springs Pkwy	400 Alpharetta, GA 30004

DEVELOPMENT PLAN DEVIATIONS

BUILDING HEIGHT EXCEEDS MAXIMUM HEIGHT OF 55' ALLOWED FOR ZONING
 B3-3. REQUESTING DEVIATION TO ALLOW FOR INCREASE OF MAXIMUM
 BUILDING HEIGHT BY 5' TO ALLOW FOR 60' MAX.

2.

DEVELOPMENT PLAN VARIANCES

1. PER SECTION 88-323-02-B, IF ADJACENT TO AND WITHIN 150 FEET OF A PARKWAY, PARKING LOCATED ON THE SIDE OF A BUILDING SHALL BE SET BACK A MINIMUM OF 10 FEET BEHIND THE FRONT BUILDING LINE OR 30 FEET FROM THE RIGHT-OF-WAY, WHICHEVER IS GREATER. WITH THE PLATTED 50' BUILDING SETBACK FROM NW TIFFANY SPRING PARKWAY, THIS REQUIREMENT CREATES A 60' PARKING SETBACK (10' FURTHER THAN THE PLATTED SETBACK) DUE TO SITE CONSTRAINTS, THE PLAN IS SEEKING A VARIANCE FROM THE ABOVE SECTION, TO ALLOW PARKING WITHIN 10' OF THE EXISTING R/W LINE. IF THE VARIANCE IS NOT GRANTED BY THE BZA, THE PLAN WILL BE REVISED TO RECONFIGURE THE 10 PARKING SPACES IDENTIFIED IN THIS PLAN, LOCATED OFF THE NORTHEAST CORNER OF THE BUILDING.

OMMENTS 05/29/24 OMMENTS 05/29/24 ISIONS DATE	CITY COMMENTS 05/17/24 CITY COMMENTS 05/29/24 REVISIONS DATE					-
OMMENTS OMMENTS	CITY COMMENTS CITY COMMENTS REVISIONS	05/17/24	05/29/24			DATE
OMMENTS OMMENTS	CITY COMMENTS CITY COMMENTS REVISIONS					
	CITY C	OMMENTS	OMMENTS			/ISIONS

(Im ley) HOLL
© 2023 KIMLEY-HORN AND ASSOCIATES, INC.
806 PENNSYLVANIA AVE, SUITE 150
AND SESSOCIATES, INC.
PHONES 16-6552-0350
AWWW.KIMLEY-HORN.COM

DRAWN BY: KMR 88 86 KY CHECKED BY: MDK




OVERSHEET


KANSAS CITY
EVELOPMENT PLAN
10000 N POLO DR.


ORIGINAL ISSUE: 02/23/2024 KHA PROJECT NO

> 268432000 SHEET NUMBER

> > C0

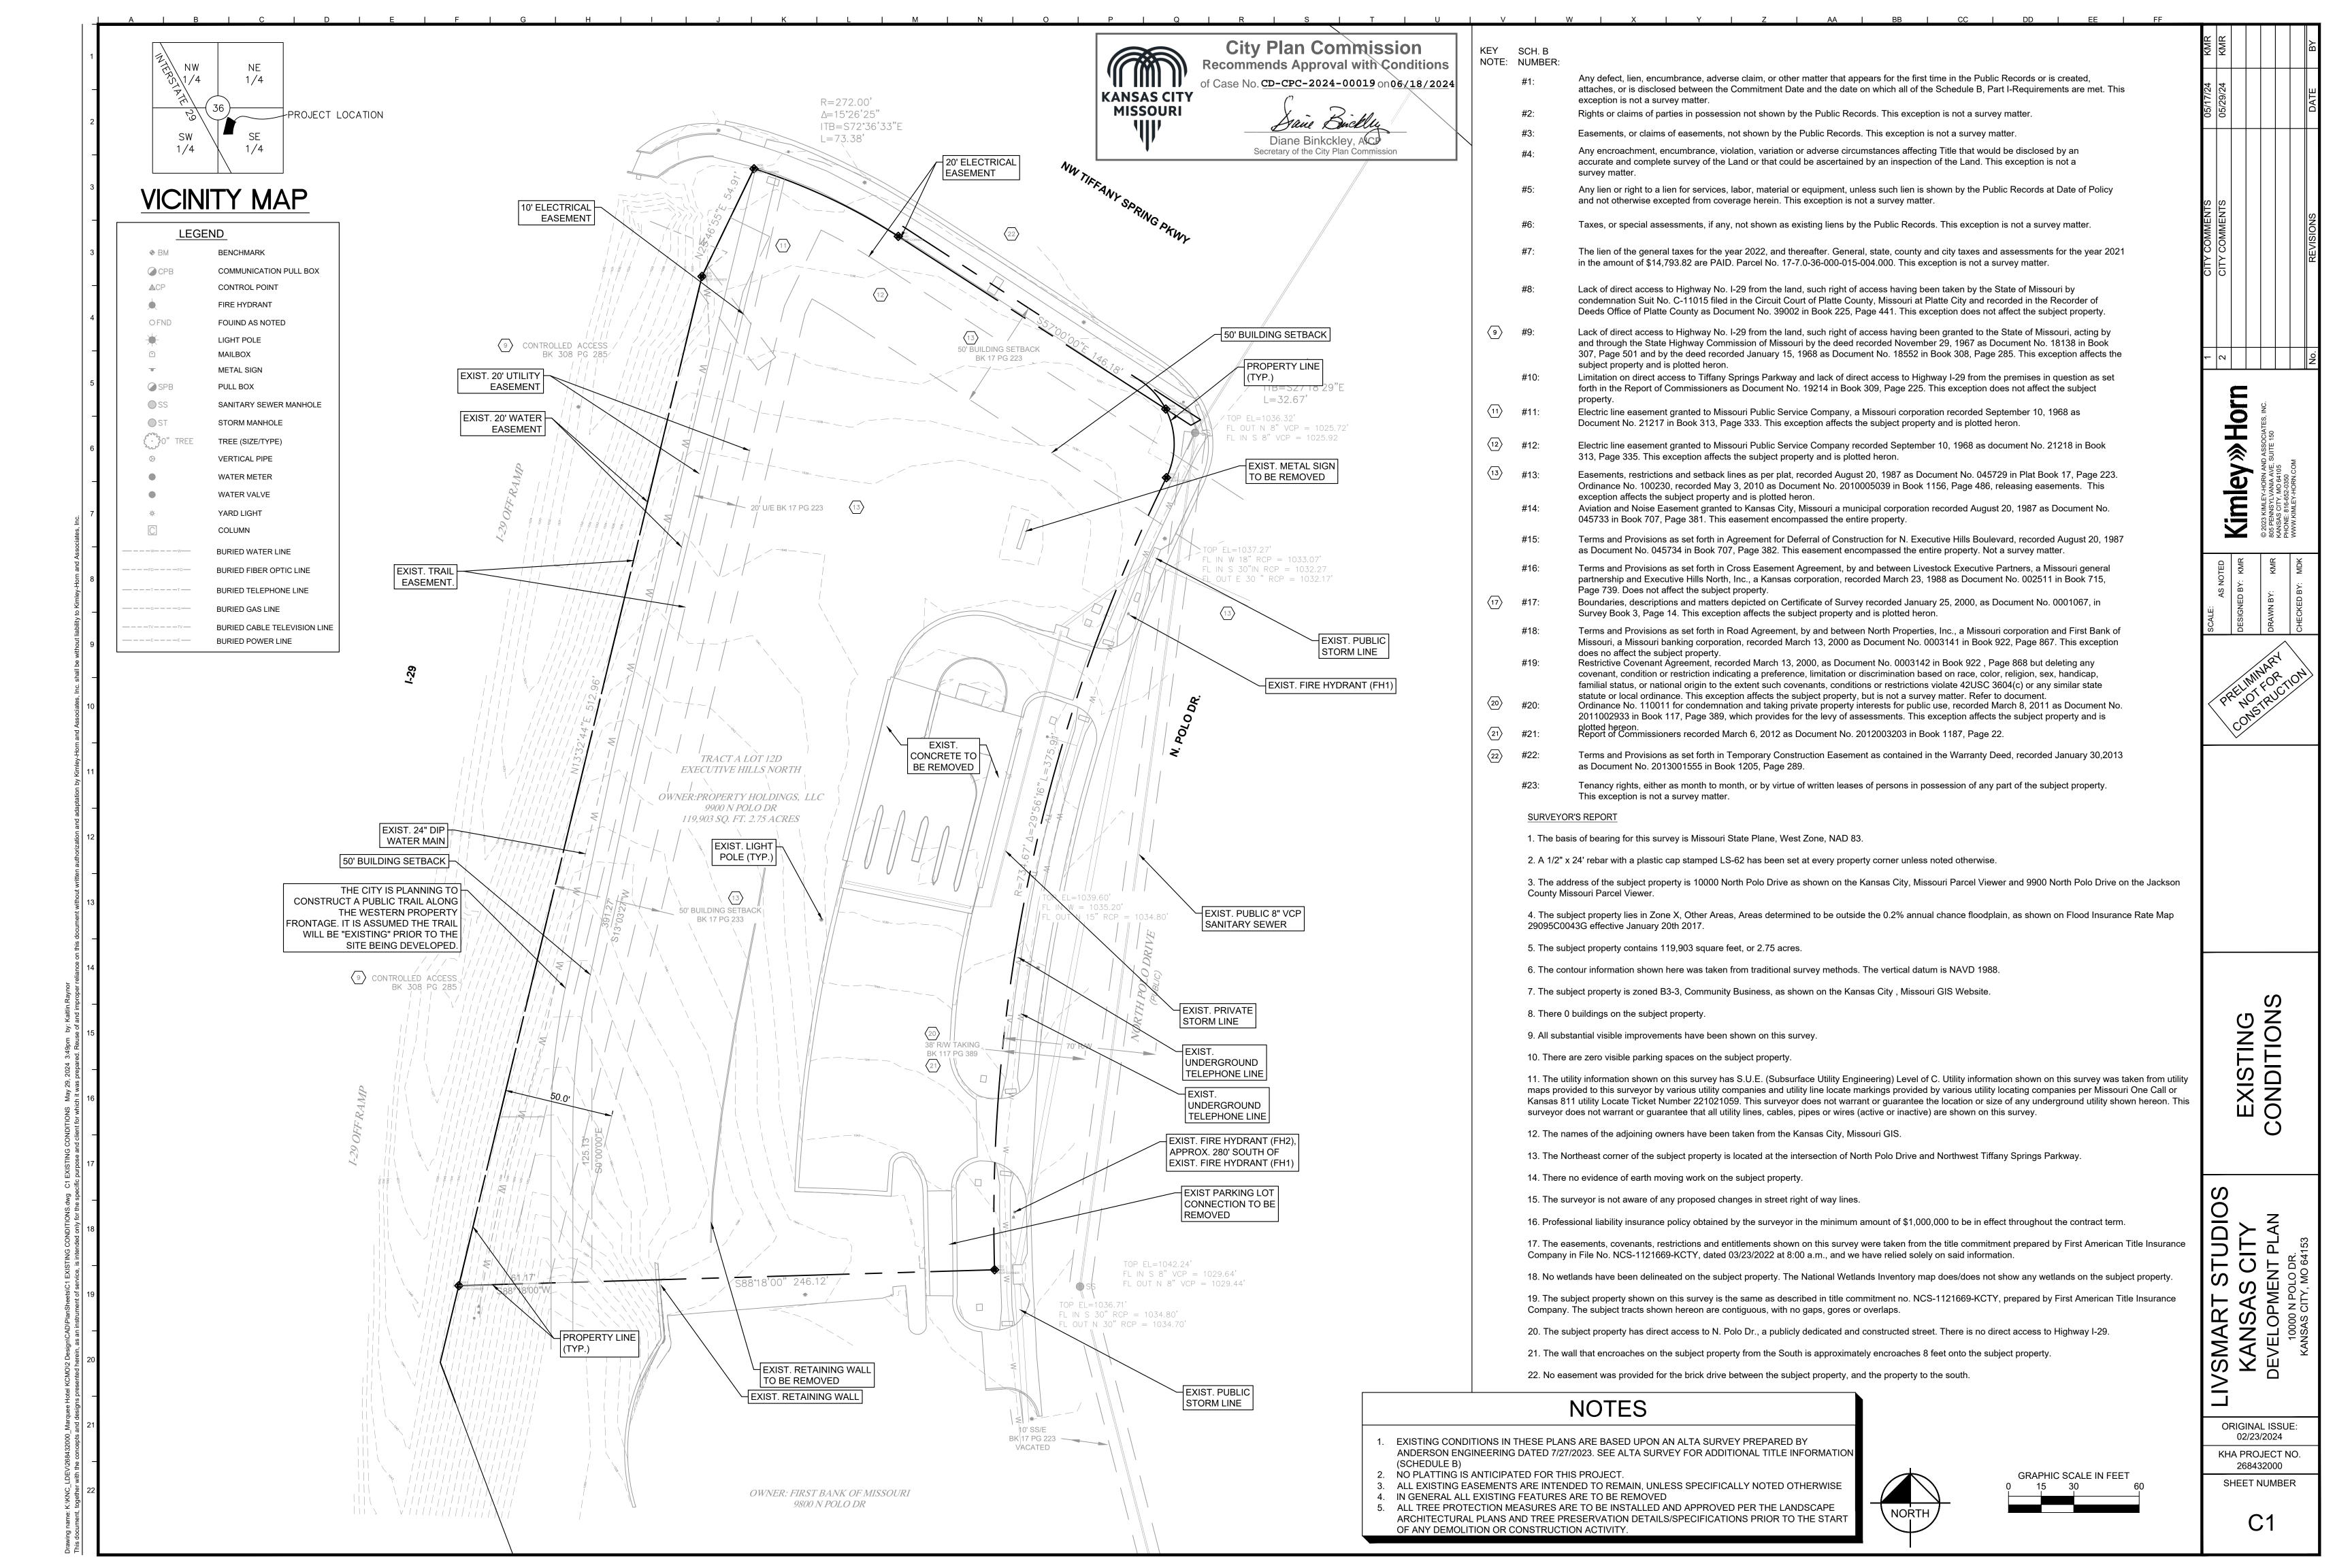

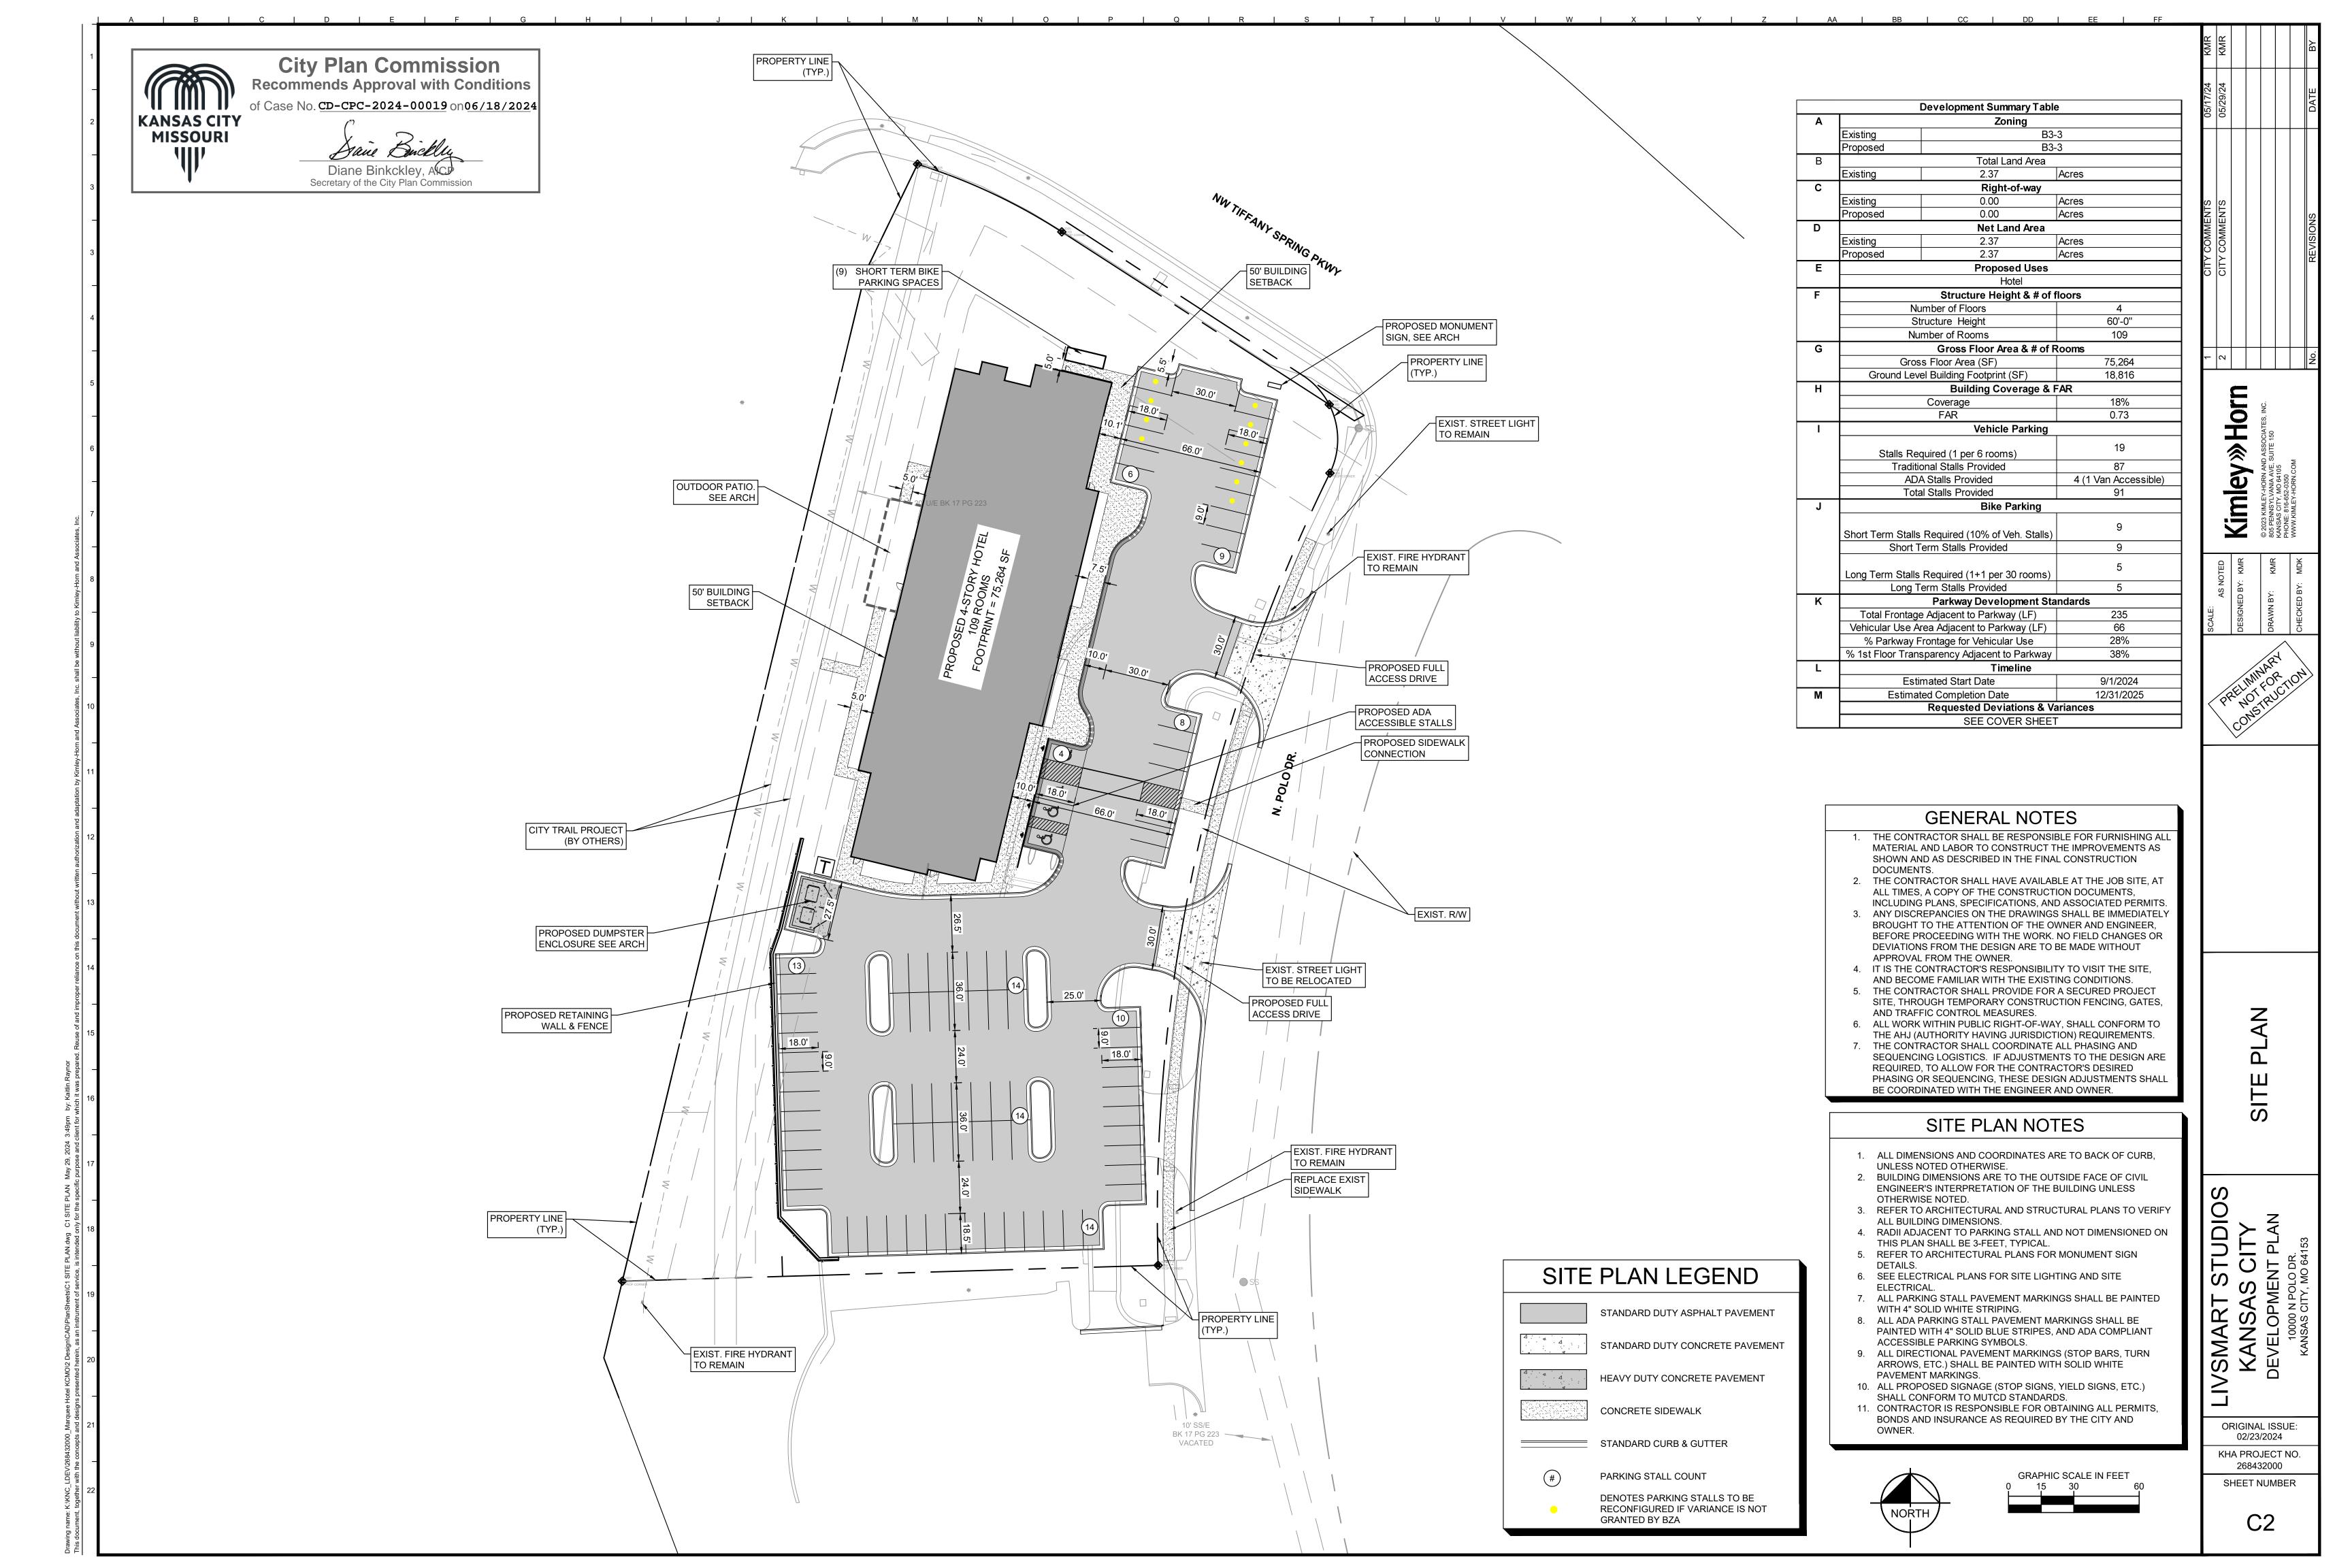

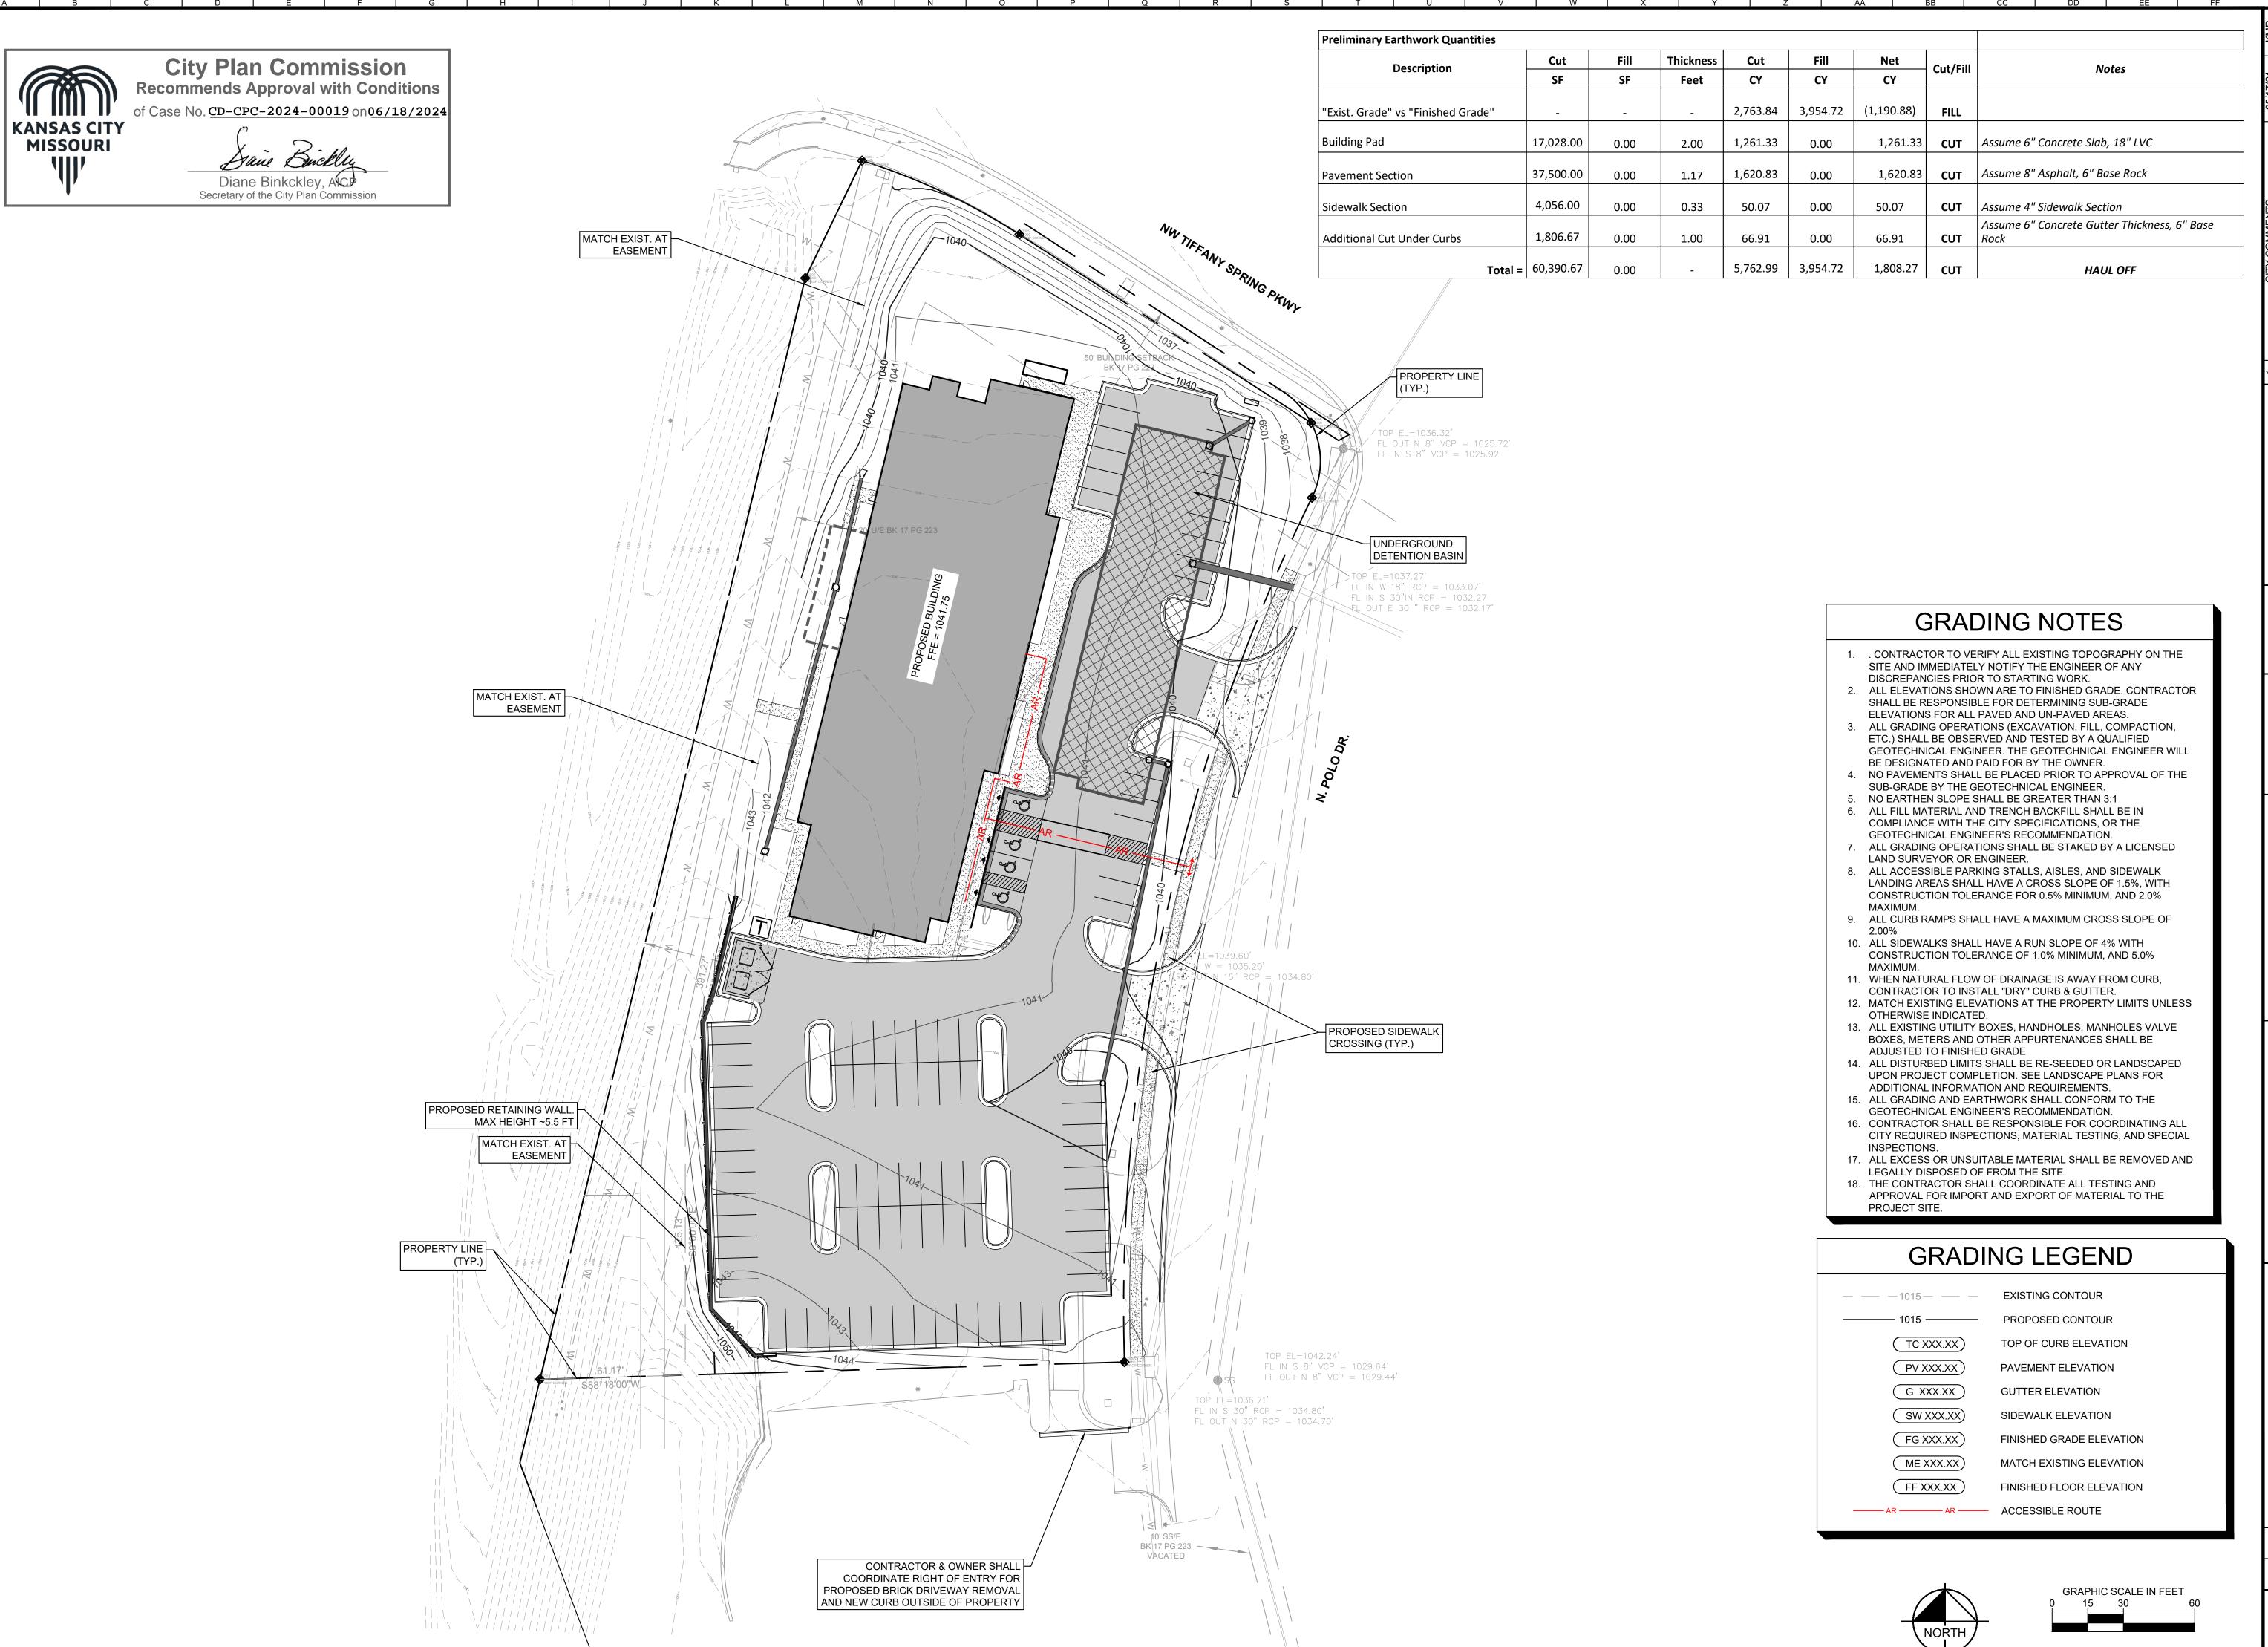

CITY COMMENTS 05/29/2
CITY COMMENTS 05/29/2
REVISIONS DATE

Kimley >>> Horn
© 2023 KIMLEY-HORN AND ASSOCIATES, INC.
RANSAS CITY, MO 64105
PHONE: 816-655-0350

DRAWN BY: KMR KANS, KANS, PHON CHECKED BY: MDK

REININARY COMSTRUCTION


RADING PLAN


KANSAS CITY
DEVELOPMENT PLAN
10000 N POLO DR.

ORIGINAL ISSUE: 02/23/2024 KHA PROJECT NO. 268432000

SHEET NUMBER

C3

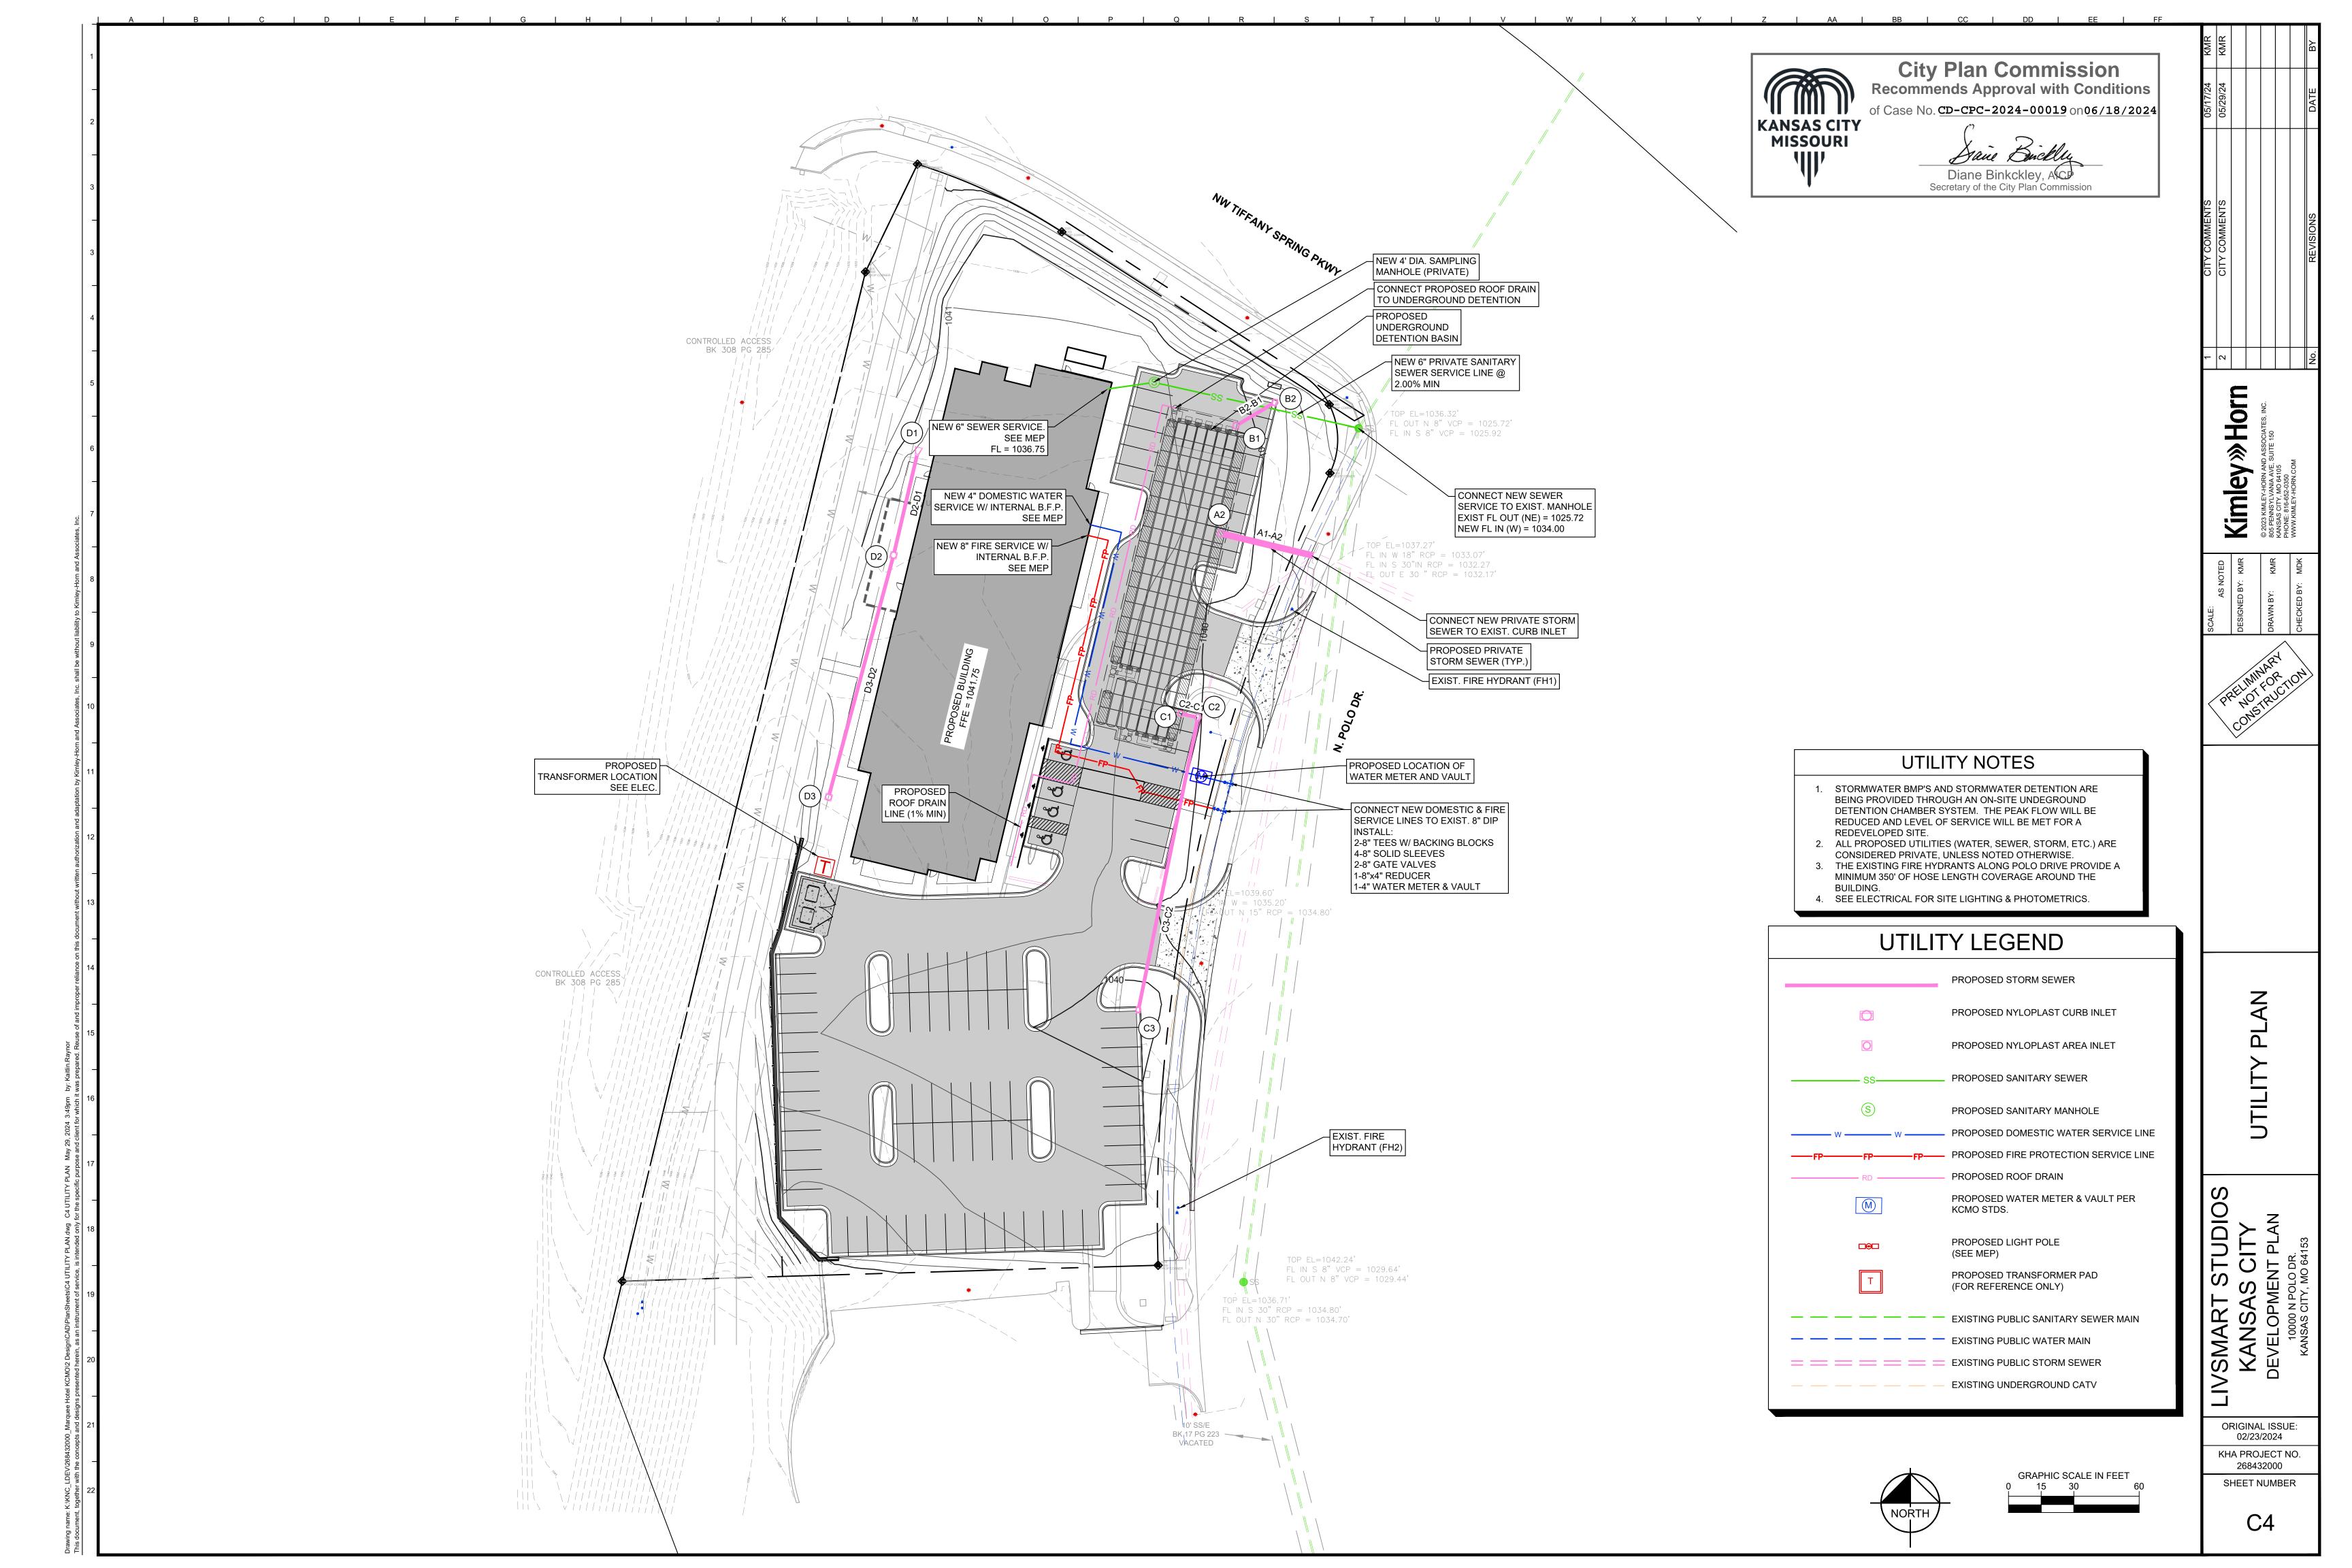


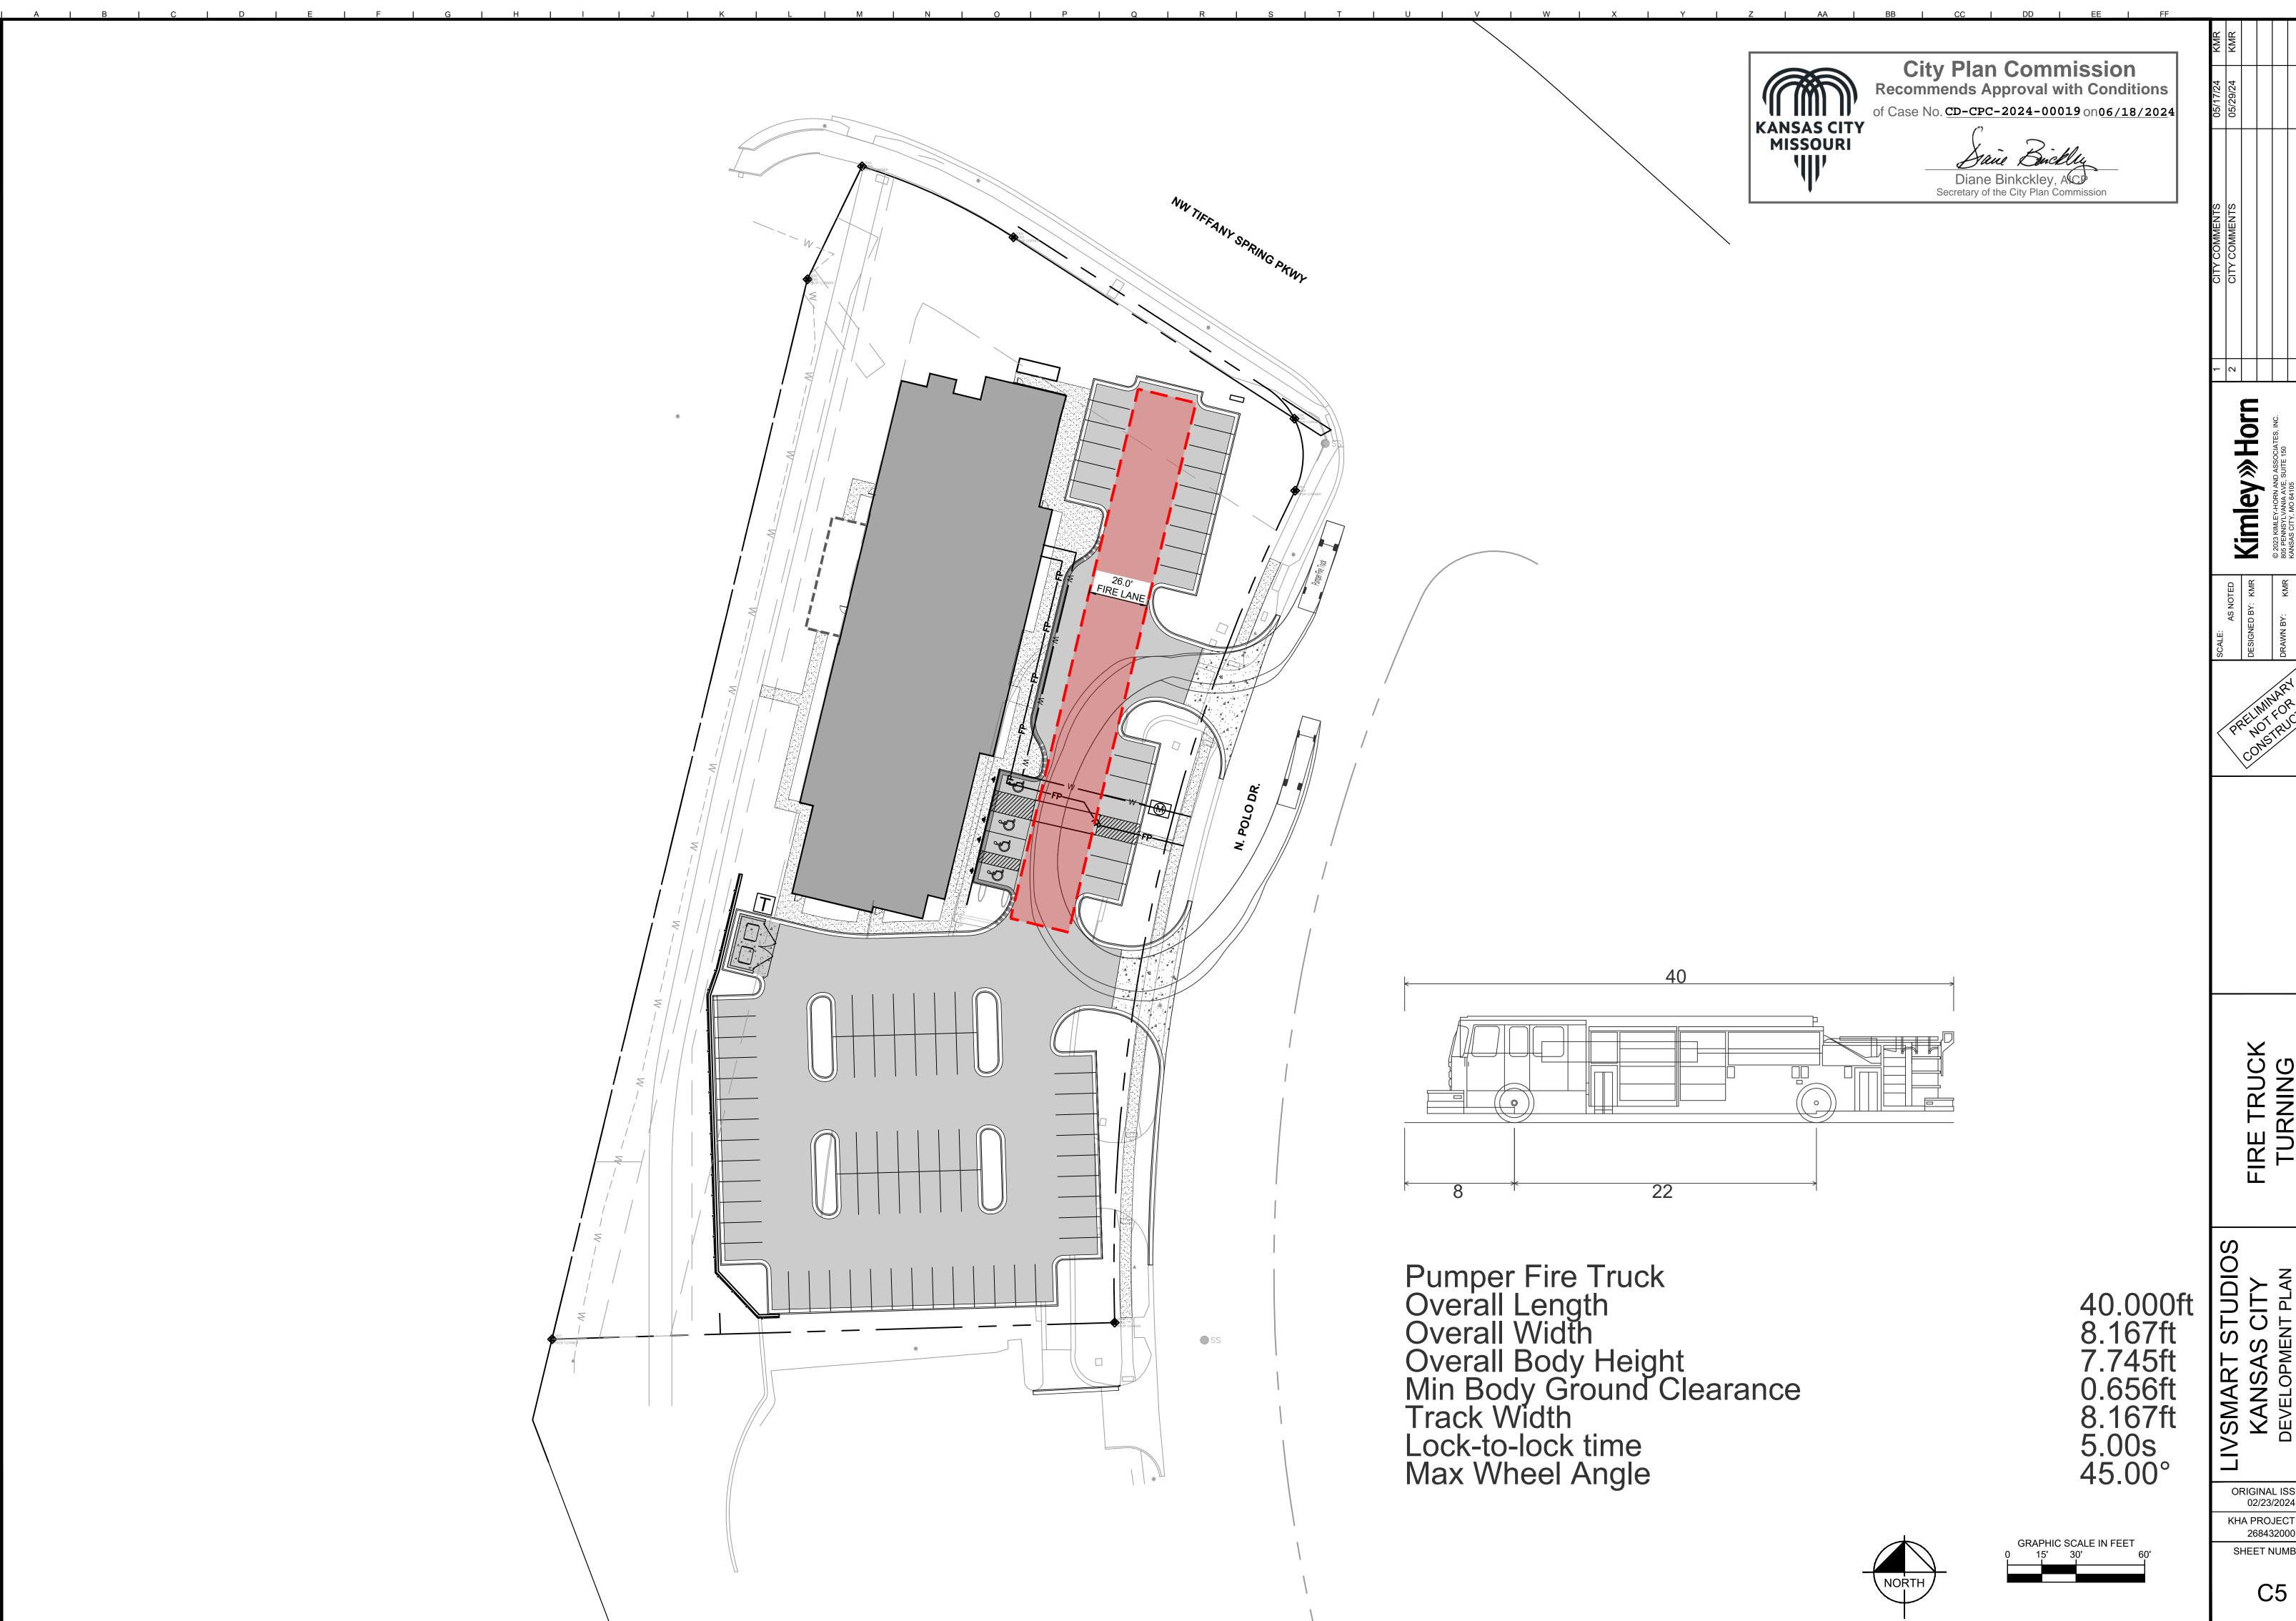


FIRE TRUCK TURNING

ORIGINAL ISSUE: 02/23/2024

KHA PROJECT NO. 268432000 SHEET NUMBER

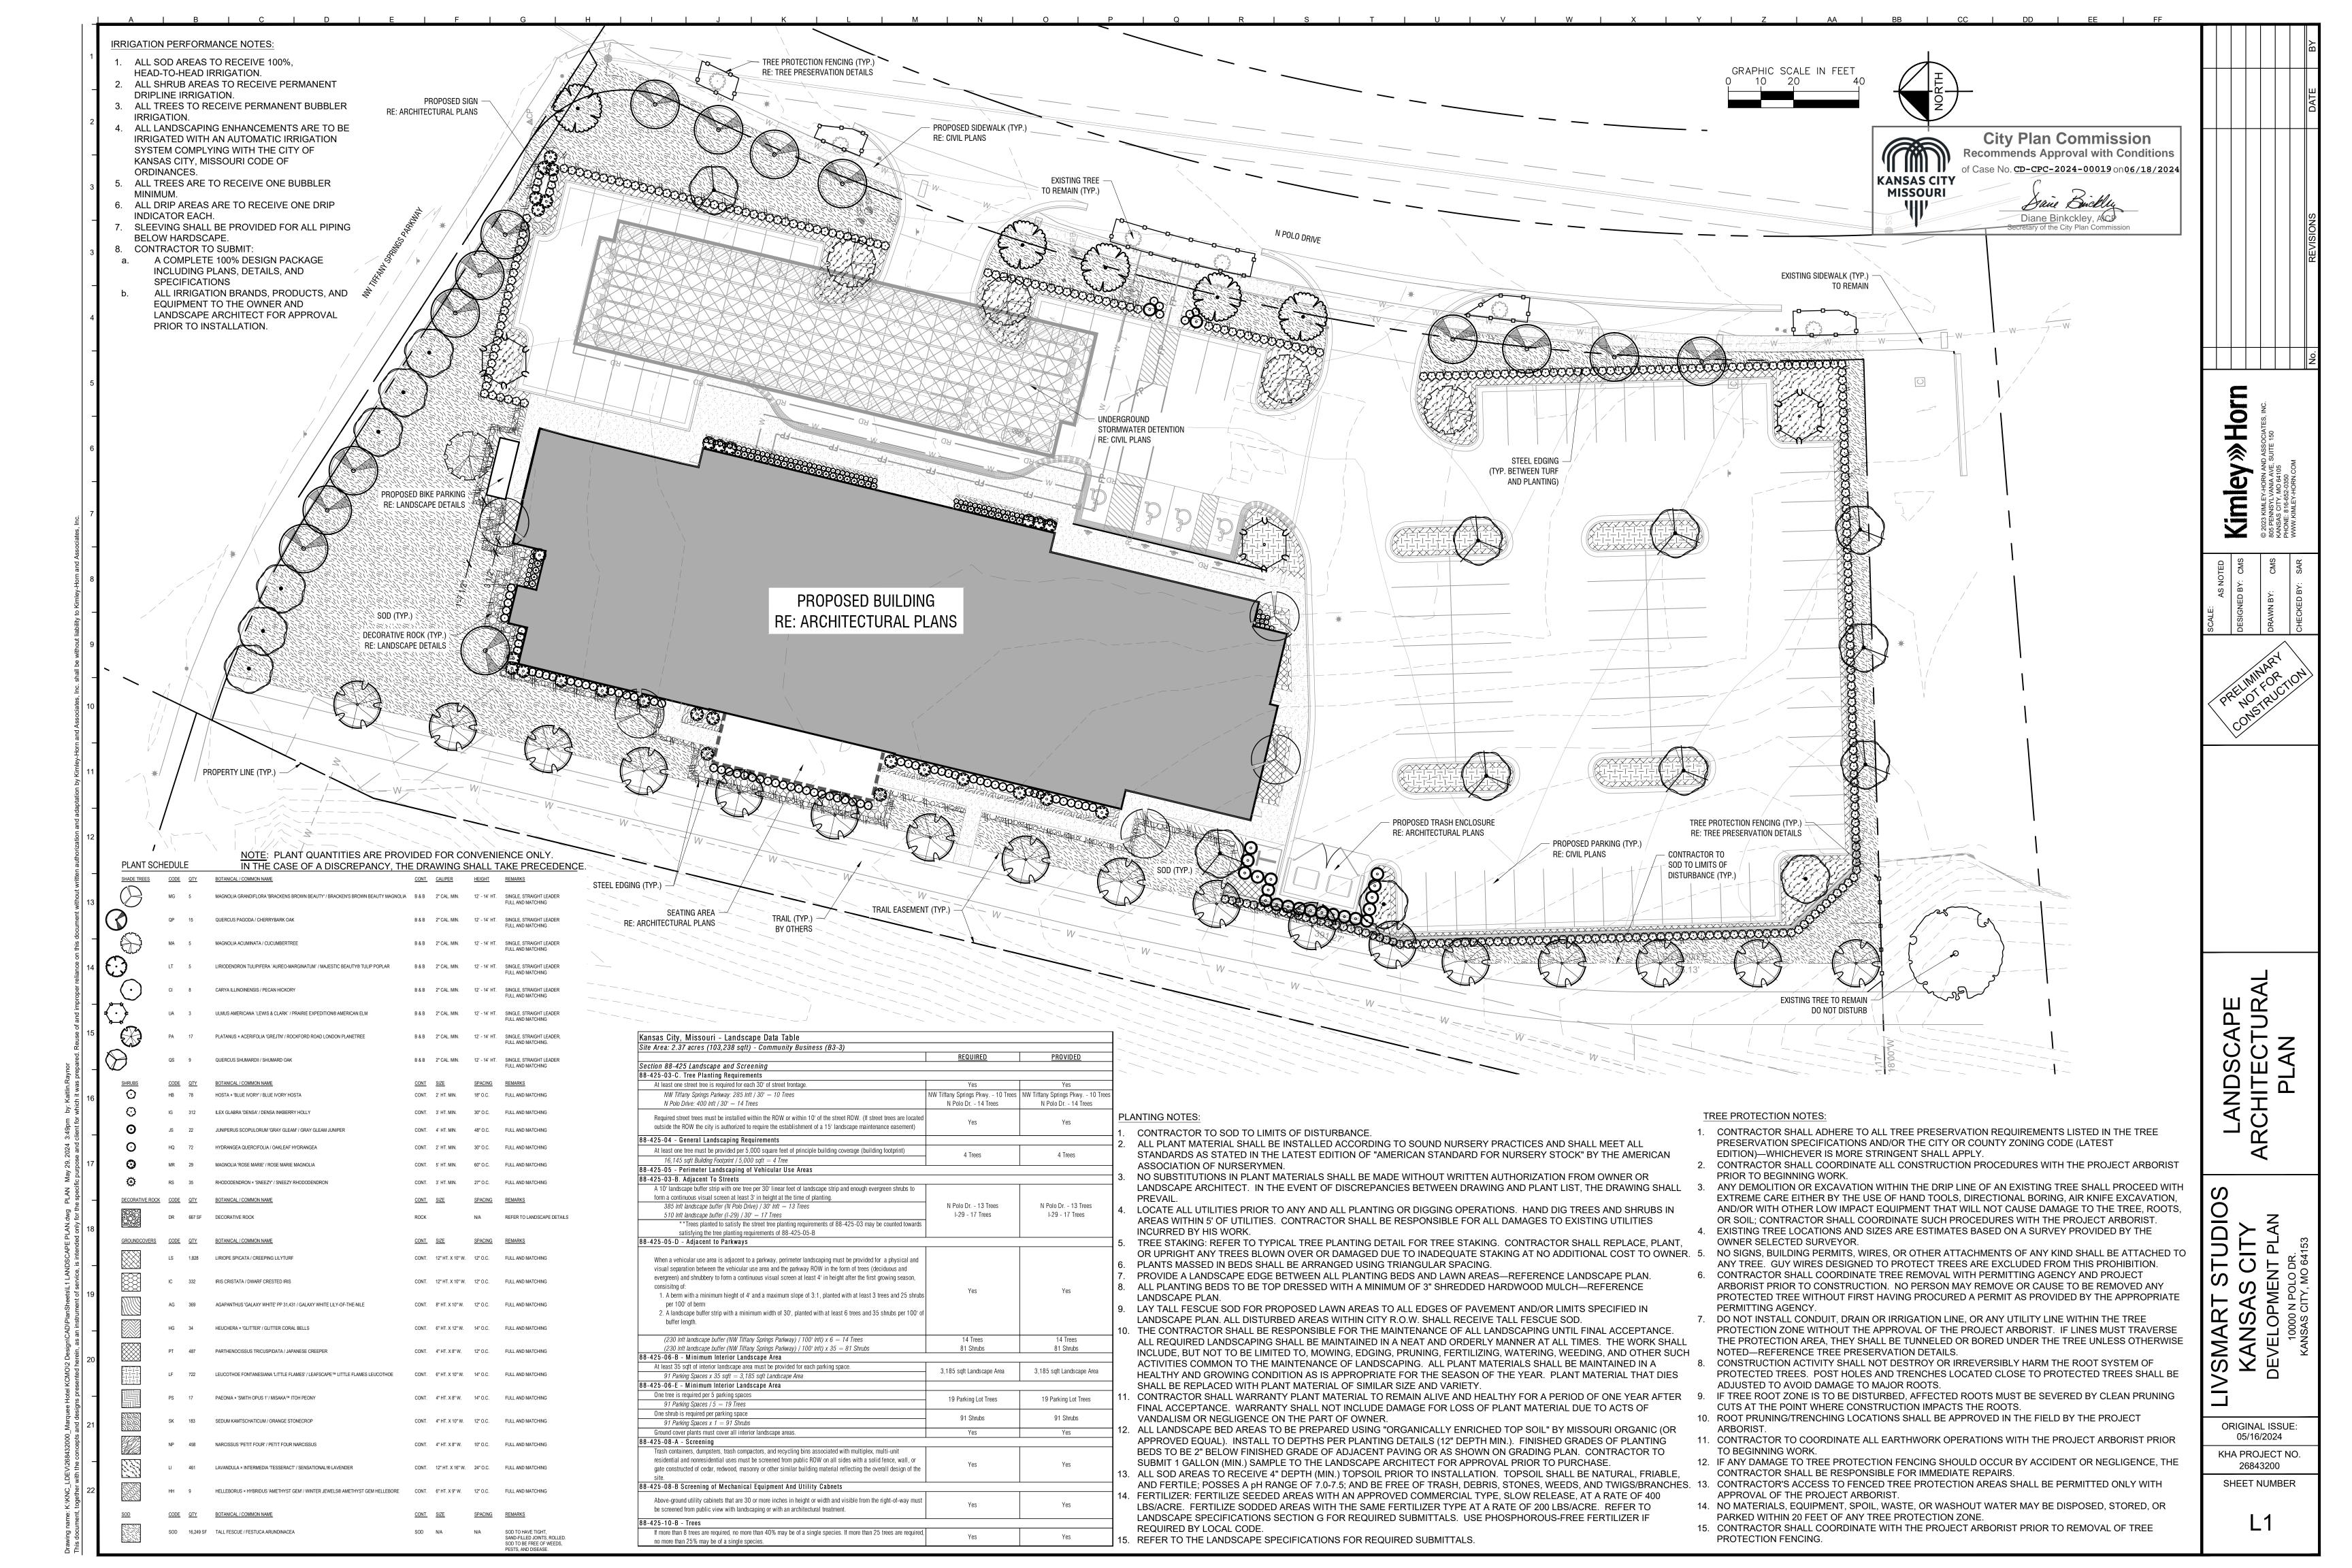



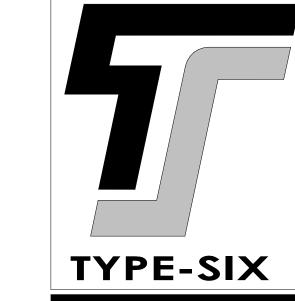

TYPE-SIX DEVELOPMENT SERVICES, LLC

910 SOUTH MAIN STREET #150 GRAPEVINE, TEXAS 76054 972.677.9075



LIVSMARI SIUDIOS MARQUEE HOSPITALITY

ARCHITECT

D. HAYES HINKLE

ISSUE DATE
17 MAY 2024

ISSUED FOR

REVIEW

Revision Date

SHEET NAME RENDER CONCER

SHEET NUMBER


A20.00






City Plan Commission Recommends Approval with Conditions of Case No. CD-CPC-2024-00019 on06/18/2024

> Diane Binkckley, ACP Secretary of the City Plan Commission

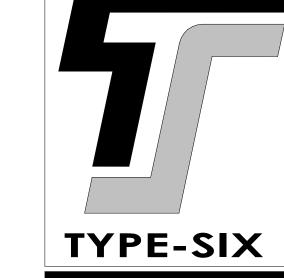

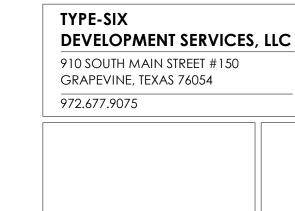

ARCHITECT

D. HAYES HINKLE **ISSUE DATE**

ISSUED FOR

29 MAY 2024


REVIEW

Revision

SHEET NAME

01 DIMENSION PLAN

SHEET NUMBER

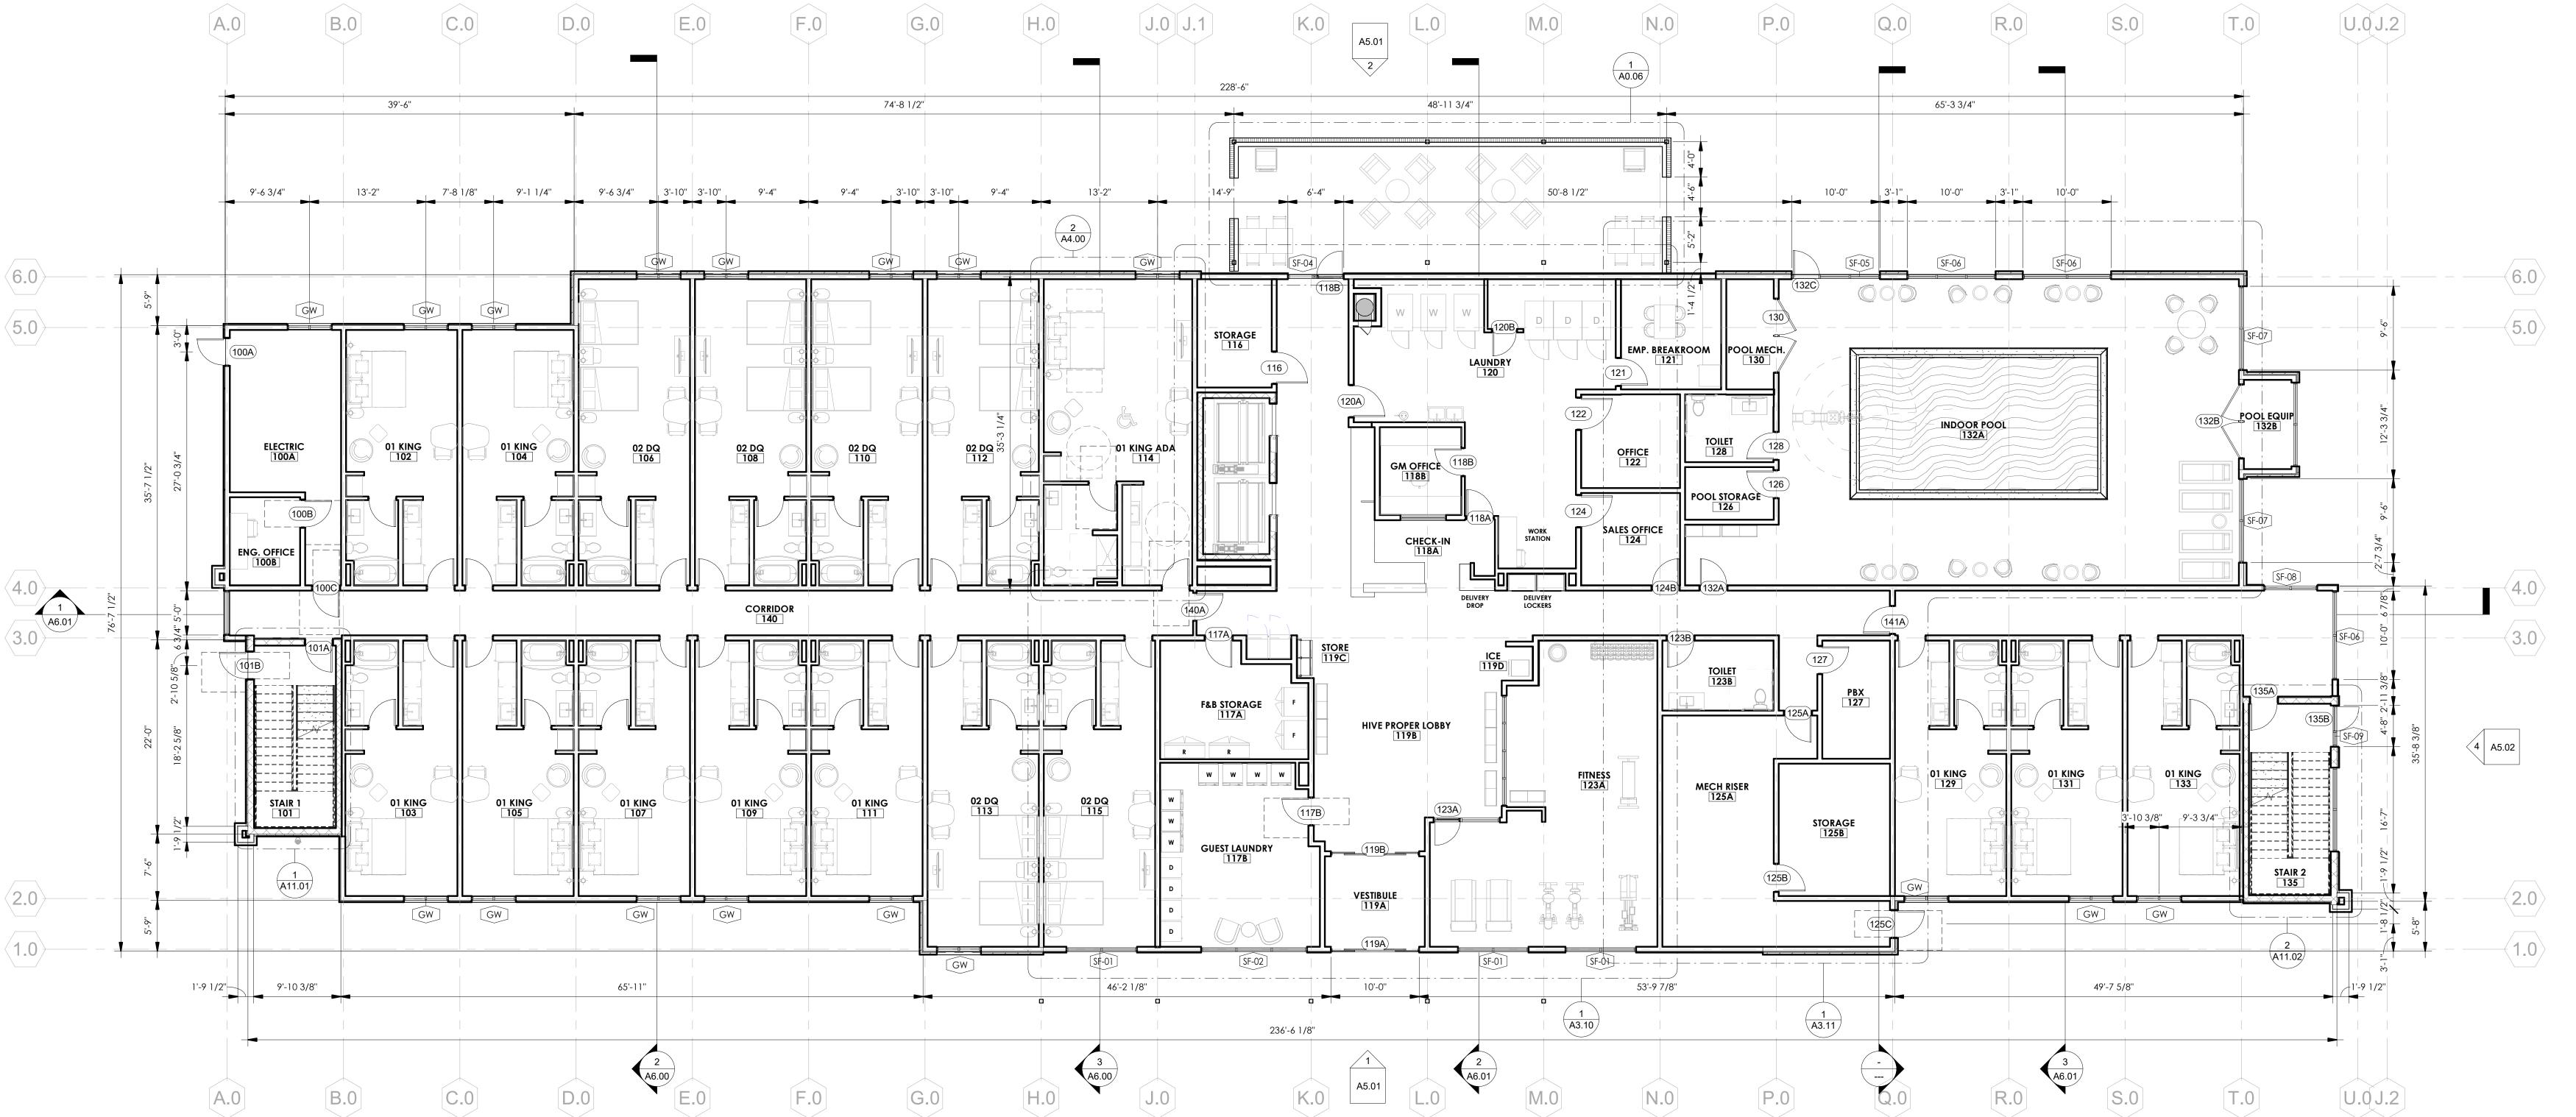

GENERAL FLOOR PLAN NOTES

- 1. THE GENERAL CONTRACTOR SHALL NOTIFY THE ARCHITECT OF ANY DISCREPANCIES BETWEEN THE DRAWINGS, THESE NOTES AND FIELD CONDITIONS BEFORE COMMENCING
- 2. REFER TO A8.00 FOR PARTITION TYPES
- REFER TO SHEET A15.00 FOR DOOR SCHEDULES, DOOR FRAMES AND DOOR TYPES

ANY WORK AND REQUEST CLARIFICATION.

- REFER TO G SERIES SHEETS FOR CODE REFERENCES, CODE COMPLIANCE PLANS, PENETRATION DETAILS AND ACCESSIBILITY INFORMATION.
- PROVIDE ACCESSIBLE GUEST ROOMS PER THE TEXAS ACCESSIBILITY STANDARDS. REFER TO G SERIES SHEETS FOR ADDITIONAL INFORMATION.
- 6. ALL DIMENSIONS ARE TO FACE OF STUD, CONCRETE, MASONRY OR TO THE GRID LINE, UNLESS NOTED OTHERWISE. REFER TO STRUCTURAL FOR SLAB DIMENSIONS.
- 7. ALL GRID LOCATIONS AND GRID DIMENSIONS ARE TO BE VERIFIED BY CONTRACTOR PRIOR TO COMMENCEMENT OF

ALL MISCELLANEOUS SUPPORT STEEL EXPOSED TO THE

- EXTERIOR SHALL BE GALVANIZED AND COATED WITH A HIGH-PERFORMANCE COATING, UNLESS NOTED OTHERWISE.
- PROVIDE AUTOMATIC FIRE SUPPRESSION SYSTEM FOR ENTIRE BUILDING PER NFPA 13. SYSTEM SHALL BE UNDER SEPARATE PERMIT. COORDINATE WITH CERTIFIED FIRE SPRINKLER CONTRACTOR.

- ALL STRUCTURAL STEEL COLUMNS AND BEAMS REQUIRED TO 18. BE PROTECTED TO MEET A FIRE RATING SHALL BE INDIVIDUALLY PROTECTED PRIOR TO INSTALLATION OF ADJACENT PARTITIONS, WALLS, CEILINGS OR ROOF
- 11. FURNITURE, FIXTURES AND EQUIPMENT (FFE) ARE TO BE COORDINATED WITH OWNER. CONTRACTOR TO PROVIDE RESPONSIBILITY MATRIX TO ENSURE ALL ELEMENTS ARE
- PROVIDE NECESSARY BLOCKING FOR SURFACE MOUNTED FIXTURES, ACCESSORIES, AND EQUIPMENT.

ACCOUNTED FOR.

SPREAD, 2015 IFC, SECTION 803.

13. FINISHES SHALL MEET PROPER FLAME SPREAD AND SMOKE

- 14. CAULK CONTINUOUSLY AT PERIMETER OF DOOR AND WINDOW FRAMES. CAULK AFTER WALL COVERING IS INSTALLED.
- BATH ACCESSORIES IN ALL BATHROOMS. SIGNAGE IS OWNER PROVIDED. SIGNAGE SHALL MEET BUILDING CODE REQUIREMENTS AND ANSI A117.1 REQUIREMENTS FOR ACCESSIBILITY.
- PROVIDE TACTILE EXIT SIGNS AT EXIT DOOR LOCATIONS. SIGNAGE SHALL COMPLY WITH ICC/ANSI A117.1. AT STOREFRONT LOCATION, PROVIDE TACTILE SIGN THAT FITS WITHIN THE STOREFRONT MULLION FRAME WIDTH. MOUNT BOTTOM OF CHARACTERS AT 48"MIN. AND 60"MAX. ABOVE FINISH FLOOR.

REFER TO MOUNTING HEIGHT SCHEDULE FOR TOILET AND 22.

- PROVIDE TACTILE SIGNAGE OUTSIDE THE TOILET ROOM PER 24. 1110.1 AND ICC/ANSI A117.1. MOUNT BOTTOM OF CHARACTERS AT 48" MIN. AND 60" MAX ABOVE FLOOR.
- PROVIDE STAINLESS STEEL CORNER GUARDS AT ALL OUTSIDE CORNERS IN KITCHEN, LAUNDRY ROOMS, STORAGE, MAINTENANCE AND BACK-OF-HOUSE CORRIDORS. PROVIDE PLASTIC CORNER GUARDS AT ALL OUTSIDE CORNERS IN BACK-OF-HOUSE WORK ROOMS AND OFFICES. REFERENCE SPECIFICATION SECTION 102600 FOR TYPES AND 26. HEIGHTS OF CORNER GUARD. ALL OUTSIDE CORNERS AT BACK-OF-HOUSE AREAS ARE TO HAVE CORNER GUARDS. REFER TO INTERIOR DESIGN DRAWING FOR CORNER
- 20. ALL WALL OUTLETS ON ELEVATIONS ARE DIMENSIONED TO CENTER LINE, UNLESS NOTED OTHERWISE.


GUARDS AT PUBLIC AREAS TO BE PROVIDED BY GC.

- 21. ALL DEVICES ADJACENT TO WET AREAS SHALL BE GFCI PER NEC REQUIREMENTS.
 - ALL WOOD BLOCKING AND PLYWOOD IN EXTERIOR WALLS, PARAPETS, AND ROOF CONSTRUCTION SHALL BE EXTERIOR (PRESSURE) AND FIRE RETARDANT-TREATED (FRTW). ALL INTERIOR PLYWOOD SHALL BE FIRE RETARDANT-TREATED (FRTW). ONLY INTERIOR MISCELLANEOUS WOOD BLOCKING SHALL BE ALLOWED TO BE NON FIRE-RETARDANT TREATED AND INTERIOR WOOD BLOCKING ADJACENT TO CONCRETE OR MASONRY SHALL BE PRESSURE TREATED.
- WHERE MECHANICAL AND ELECTRICAL DEVICES AND PARTS ARE CONCEALED AND REQUIRE ACCESS, PROVIDE ACCESS DOORS AND FRAMES PER SPECIFICATIONS. FIRE RATED ASSEMBLIES SHALL BE MAINTAINED.

- TYPICAL AT EXPOSED SIDES OF CONCRETE COLUMNS UNLESS OTHERWISE NOTED -PROVIDE 5/8" GYPSUM BOARD OVER 1 1/2" METAL STUDS AT 16" O.C. AND EXTEND ABOVE
- ALL GYPSUM BD. FINISH FACES OF DIFFERING SUBSTRA (i.e. 1 1/2" MTL. FURRING ADJACENT TO 3 5/8" METAL
- REFER TO A9 SHEETS FOR ENLARGED GUESTROOM INFORMATION.

27.	FINAL ROOM NAMES AND SIGNAGE SHALL BE CONFIRMED
	BY OWNER PRIOR TO PURCHASE AND INSTALLATION.

HOTEL	NFORMA	TION				GENER	AL FLOOR PLAN SYMBOLS
BUILDIN		OD 65.		10.01/3		6	KEYNOTE TAG - REFENCE KEYNOTE SCHEDULE
	FIRST FLO UPPER FLO TOTAL SF:	OOR SF:		18,816 S 18,816 S 75,264 S	F	101	DOOR TAG - REFENCE DOOR SCHEDULE A15.00
BUILDIN	G INFORMA NUMBER		56.	4 FLOOF	200	(SF-00)	STORFRONT TAG - REFERENCE WINDOW SCHEDULE A16.00
	NUMBER OF GUESTROOMS: 109			K3	A	WINDOW TAG - REFERENCE WINDOW SCHEDULE A16.00	
AMENITI	AMENITIES INDOOR POOL			1i 1hr	PARTITION TAG - REFERENCE PARTITION SCHEDULE A8.00		
	OUTDOOR LOUNGE FITNESS CORPORATE OFFICE					ROOM ADA SYMBOL	
GUESTRO	GUESTROOM MIX					ROOM HEARING IMPAIRED SYMBOL	
FLOOR	1	2	3	4	TOTAL		
QQ	6	20	19	20	65	CR	CARD READER
K	11	11	11	11	44	FE	FIDE EVILICITIES IED
		TOTAL	GUESTRO	OMS	109	LE	FIRE EXTINGUISHER

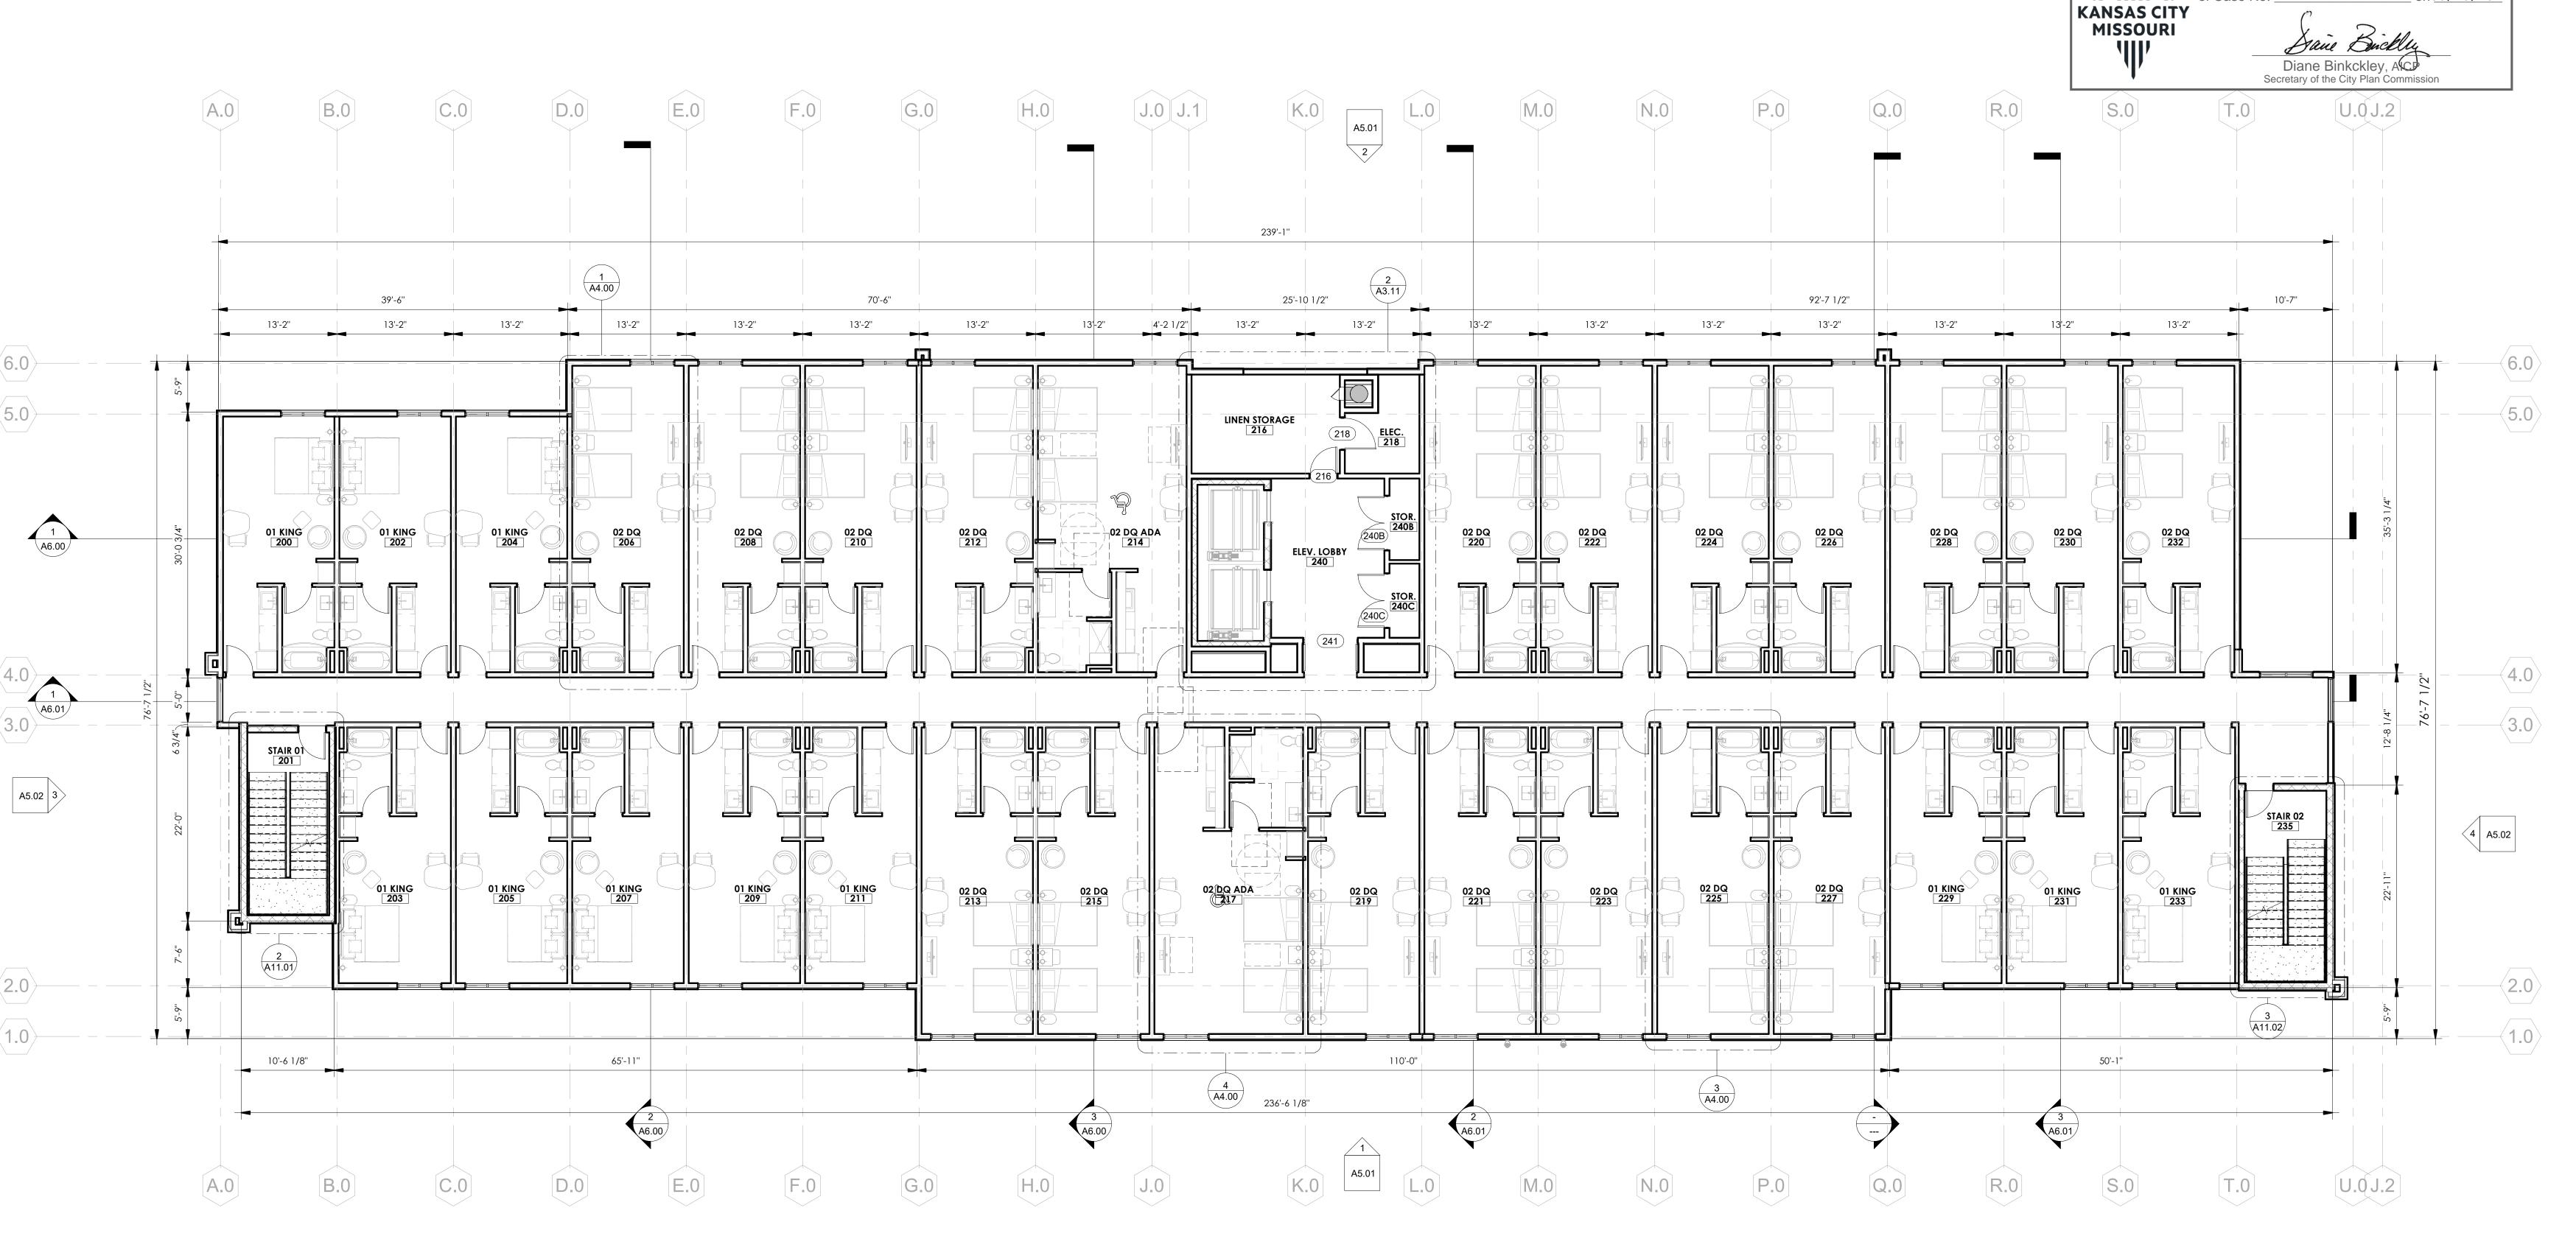

1/8" = 1'-0"

GENERAL FLOOR PLAN NOTES

PROVIDE TACTILE SIGNAGE OUTSIDE THE TOILET ROOM PER 10. ALL STRUCTURAL STEEL COLUMNS AND BEAMS REQUIRED TO 18. TYPICAL AT EXPOSED SIDES OF CONCRETE COLUMNS THE GENERAL CONTRACTOR SHALL NOTIFY THE ARCHITECT BE PROTECTED TO MEET A FIRE RATING SHALL BE 1110.1 AND ICC/ANSI A117.1. MOUNT BOTTOM OF UNLESS OTHERWISE NOTED -PROVIDE 5/8" GYPSUM BOARD OF ANY DISCREPANCIES BETWEEN THE DRAWINGS, THESE INDIVIDUALLY PROTECTED PRIOR TO INSTALLATION OF CHARACTERS AT 48" MIN. AND 60" MAX ABOVE FLOOR. OVER 1 1/2" METAL STUDS AT 16" O.C. AND EXTEND ABOVE NOTES AND FIELD CONDITIONS BEFORE COMMENCING ADJACENT PARTITIONS, WALLS, CEILINGS OR ROOF CEILING. ANY WORK AND REQUEST CLARIFICATION. PROVIDE STAINLESS STEEL CORNER GUARDS AT ALL OUTSIDE CORNERS IN KITCHEN, LAUNDRY ROOMS, STORAGE, 25. ALL GYPSUM BD. FINISH FACES OF DIFFERING SUBSTRATES REFER TO A8.00 FOR PARTITION TYPES 11. FURNITURE, FIXTURES AND EQUIPMENT (FFE) ARE TO BE MAINTENANCE AND BACK-OF-HOUSE CORRIDORS. (i.e. 1 1/2" MTL. FURRING ADJACENT TO 3 5/8" METAL STUDS) COORDINATED WITH OWNER. CONTRACTOR TO PROVIDE PROVIDE PLASTIC CORNER GUARDS AT ALL OUTSIDE REFER TO SHEET A15.00 FOR DOOR SCHEDULES, DOOR RESPONSIBILITY MATRIX TO ENSURE ALL ELEMENTS ARE CORNERS IN BACK-OF-HOUSE WORK ROOMS AND OFFICES. GENERAL FLOOR PLAN SYMBOLS HOTEL INFORMATION FRAMES AND DOOR TYPES REFERENCE SPECIFICATION SECTION 102600 FOR TYPES AND 26. ACCOUNTED FOR. REFER TO A9 SHEETS FOR ENLARGED GUESTROOM HEIGHTS OF CORNER GUARD. ALL OUTSIDE CORNERS AT REFER TO G SERIES SHEETS FOR CODE REFERENCES, CODE BUILDING SF PROVIDE NECESSARY BLOCKING FOR SURFACE MOUNTED (6) KEYNOTE TAG - REFENCE KEYNOTE SCHEDULE BACK-OF-HOUSE AREAS ARE TO HAVE CORNER GUARDS. COMPLIANCE PLANS, PENETRATION DETAILS AND FIXTURES, ACCESSORIES, AND EQUIPMENT. ACCESSIBILITY INFORMATION. FINAL ROOM NAMES AND SIGNAGE SHALL BE CONFIRMED FIRST FLOOR SF: 18,816 SF GUARDS AT PUBLIC AREAS TO BE PROVIDED BY GC. BY OWNER PRIOR TO PURCHASE AND INSTALLATION. UPPER FLOOR SF: 18,816 SF (101) DOOR TAG - REFENCE DOOR SCHEDULE A15.00 13. FINISHES SHALL MEET PROPER FLAME SPREAD AND SMOKE TOTAL SF: 75,264 SF PROVIDE ACCESSIBLE GUEST ROOMS PER THE TEXAS SPREAD, 2015 IFC, SECTION 803. 20. ALL WALL OUTLETS ON ELEVATIONS ARE DIMENSIONED TO ACCESSIBILITY STANDARDS. REFER TO G SERIES SHEETS FOR CENTER LINE, UNLESS NOTED OTHERWISE. ADDITIONAL INFORMATION. BUILDING INFORMATION SF-00 STORFRONT TAG - REFERENCE WINDOW SCHEDULE A16.00 14. CAULK CONTINUOUSLY AT PERIMETER OF DOOR AND NUMBER OF FLOORS: 4 FLOORS 21. ALL DEVICES ADJACENT TO WET AREAS SHALL BE GFCI PER WINDOW FRAMES. CAULK AFTER WALL COVERING IS ALL DIMENSIONS ARE TO FACE OF STUD, CONCRETE, NUMBER OF GUESTROOMS: 109 INSTALLED. NEC REQUIREMENTS. A WINDOW TAG - REFERENCE WINDOW SCHEDULE A16.00 MASONRY OR TO THE GRID LINE, UNLESS NOTED OTHERWISE. REFER TO STRUCTURAL FOR SLAB DIMENSIONS. ALL WOOD BLOCKING AND PLYWOOD IN EXTERIOR WALLS, REFER TO MOUNTING HEIGHT SCHEDULE FOR TOILET AND BATH ACCESSORIES IN ALL BATHROOMS. PARAPETS, AND ROOF CONSTRUCTION SHALL BE EXTERIOR **AMENITIES** ALL GRID LOCATIONS AND GRID DIMENSIONS ARE TO BE PARTITION TAG - REFERENCE PARTITION SCHEDULE A8.00 (PRESSURE) AND FIRE RETARDANT-TREATED (FRTW). ALL INDOOR POOL VERIFIED BY CONTRACTOR PRIOR TO COMMENCEMENT OF SIGNAGE IS OWNER PROVIDED. SIGNAGE SHALL MEET INTERIOR PLYWOOD SHALL BE FIRE RETARDANT-TREATED OUTDOOR LOUNGE BUILDING CODE REQUIREMENTS AND ANSI A117.1 (FRTW). ONLY INTERIOR MISCELLANEOUS WOOD BLOCKING ROOM ADA SYMBOL REQUIREMENTS FOR ACCESSIBILITY. SHALL BE ALLOWED TO BE NON FIRE-RETARDANT TREATED ALL MISCELLANEOUS SUPPORT STEEL EXPOSED TO THE CORPORATE OFFICE AND INTERIOR WOOD BLOCKING ADJACENT TO CONCRETE EXTERIOR SHALL BE GALVANIZED AND COATED WITH A 17. PROVIDE TACTILE EXIT SIGNS AT EXIT DOOR LOCATIONS. OR MASONRY SHALL BE PRESSURE TREATED. **GUESTROOM MIX** HIGH-PERFORMANCE COATING, UNLESS NOTED ROOM HEARING IMPAIRED SYMBOL SIGNAGE SHALL COMPLY WITH ICC/ANSI A117.1. AT OTHERWISE. STOREFRONT LOCATION, PROVIDE TACTILE SIGN THAT FITS WHERE MECHANICAL AND ELECTRICAL DEVICES AND FLOOR 1 2 3 4 TOTAL WITHIN THE STOREFRONT MULLION FRAME WIDTH. MOUNT PARTS ARE CONCEALED AND REQUIRE ACCESS, PROVIDE CR CARD READER PROVIDE AUTOMATIC FIRE SUPPRESSION SYSTEM FOR QQ 6 20 19 20 BOTTOM OF CHARACTERS AT 48"MIN. AND 60"MAX. ABOVE ACCESS DOORS AND FRAMES PER SPECIFICATIONS. FIRE ENTIRE BUILDING PER NFPA 13. SYSTEM SHALL BE UNDER FINISH FLOOR. RATED ASSEMBLIES SHALL BE MAINTAINED. K 11 11 11 11 SEPARATE PERMIT. COORDINATE WITH CERTIFIED FIRE **FE** FIRE EXTINGUISHER SPRINKLER CONTRACTOR. TOTAL GUESTROOMS 109

City Plan Commission

Recommends Approval with Conditions

of Case No. CD-CPC-2024-00019 on06/18/2024

TYPE-SIX TYPE-SIX

DEVELOPMENT SERVICES, LLC 910 SOUTH MAIN STREET #150 Grapevine, texas 76054 972.677.9075

ARCHITECT

D. HAYES HINKLE

ISSUE DATE


29 MAY 2024 ISSUED FOR


REVIEW

#	Revision	Date
1		
		_
	SHEET NA	ME

02 DIMENSION PLAN

SHEET NUMBER

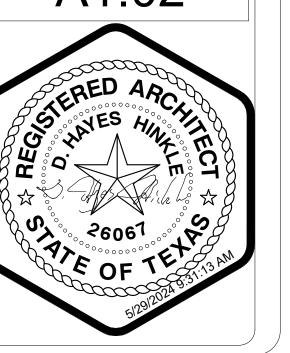

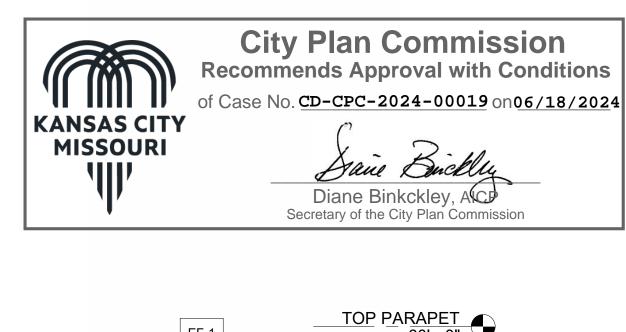

WEST ELEVATION1/8" = 1'-0"



MATERIAL CALLOUTS

EF-2 GREY COLOR EIFS

EF-4 TAUPE COLOR EIFS

WHITE EIFS

SPANDREL

DARK COLOR EIFS

NH-1 NICHIHA VINTAGE WOOD CEDAR OR SIMILAR

LF-1 LOUVER FINISH - DARK BRONZE TO MATCH STOREFRONT

AF-1 ALUMINUM PARAPET FLASHING TO MATCH STOREFRONT

STOREFRONT - KAWNEER - "DARK BRONZE #40"

GL EXTERIOR WINDOWS: STOREFRONT WINDOW SYSTEM

EF-1

EF-3

B-1 DARK BRICK - KING SIZE ACME MANGANESE IRONSPOT OR SIMILAR

ADDITIONAL NOTES:

BUILDING COLOR

MORTAR TO BE MATCHED TO GROUT

SURROUNDING BUILDING FACADE.

ALL SIGNAGE SUBJECT TO BUILDING INSPECTION DEPARTMENT

MECHANICAL UNITS SHALL BE SCREENED IN ACCORDANCE WITH LOCAL CITY AND ZONING ORDINANCES.

UTILITY BOXES AND CONDUIT SHALL BE PAINTED TO MATCH

KING SIZE, FACE BRICK, WITH 3/8" CONCAVE GROUT JOINT-

CONTRACTOR TO ENSURE METAL PANELS ARE INSTALLED IN ACCORDANCE WITH MANUFACTURERS RECOMMENDATION.

MEET BRAND STANDARDS, FOR LOCATION ONLY

38% TRANSPARENCY ON 1ST FLOOR > 33% PARKWAY REQUIREMENTS

SIGN DESIGNED AND FABRICRATED BY APPROVED VENDOR TO

FINAL SIGN DESIGN TO BE DRAFTER BY THIRD PARTY CONTRACTOR


TO ENSURE FINAL SIGN PACKAGE IS SUBMITTED APPROVED BY THE

ALL UTILITY BOXES AND METERS SHALL BE PAINTED TO MATCH

ELEVATION KEYNOTES

1 EAST ELEVATION 1/8" = 1'-0"



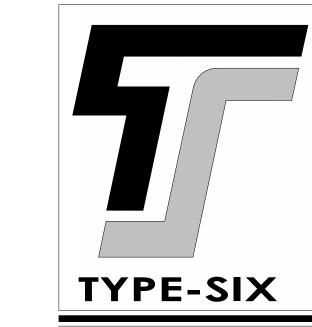

DEVELOPMENT SERVICES, LLC

910 SOUTH MAIN STREET #150 GRAPEVINE, TEXAS 76054

TYPE-SIX

972.677.9075

ARCHITECT D. HAYES HINKLE **ISSUE DATE** 29 MAY 2024

ISSUED FOR

REVIEW

Revision

SHEET NAME

BUILDING ELEVATIONS

SHEET NUMBER



City Plan Commission
Recommends Approval with Conditions of Case No. CD-CPC-2024-00019 on 06/18/2024

Diane Binkckley, ACA Secretary of the City Plan Commission

_T<u>OP PARAPET</u> 60' - 0"

HIGH PARAPET 56' - 0"

LOW PARAPET 52' - 0"

04 LEVEL 36' - 3 3/4"

03 LEVEL 25' - 1 7/8"

02 LEVEL 14' - 0"


01 LEVEL 0' - 0"

TYPE-SIX

TYPE-SIX

DEVELOPMENT SERVICES, LLC

910 SOUTH MAIN STREET #150 GRAPEVINE, TEXAS 76054 972.677.9075

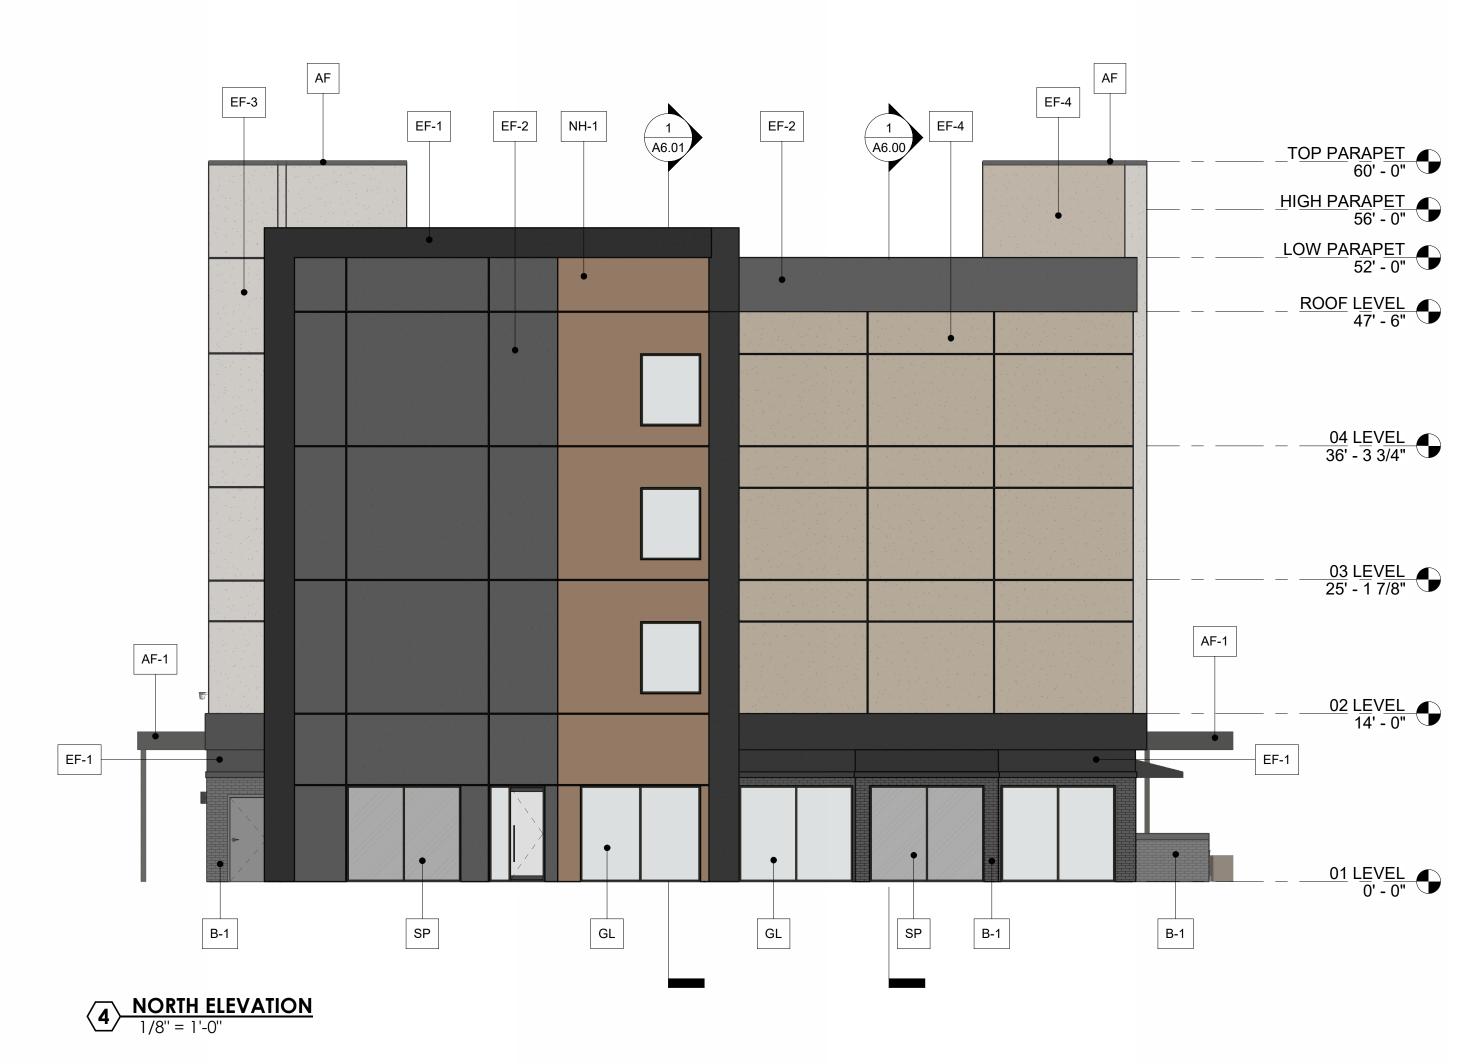



MATER	IAL CALLOUTS	ADDITIONAL NOTES:	ELEVATION KEYNOTES
B-1	DARK BRICK - KING SIZE ACME MANGANESE IRONSPOT OR SIMILAR	ALL SIGNAGE SUBJECT TO BUILDING INSPECTION DEPARTMENT	
EF-1	DARK COLOR EIFS	 APPROVAL. MECHANICAL UNITS SHALL BE SCREENED IN ACCORDANCE WITH 	
EF-2	GREY COLOR EIFS	 LOCAL CITY AND ZONING ORDINANCES. UTILITY BOXES AND CONDUIT SHALL BE PAINTED TO MATCH 	
EF-3	WHITE EIFS	BUILDING COLOR KING SIZE, FACE BRICK, WITH 3/8" CONCAVE GROUT JOINT-	
EF-4	TAUPE COLOR EIFS	MORTAR TO BE MATCHED TO GROUT CONTRACTOR TO ENSURE METAL PANELS ARE INSTALLED IN	
NH-1	NICHIHA VINTAGE WOOD CEDAR OR SIMILAR	 ACCORDANCE WITH MANUFACTURERS RECOMMENDATION. SIGN DESIGNED AND FABRICRATED BY APPROVED VENDOR TO MEET BRAND STANDARDS, FOR LOCATION ONLY 	
LF-1	LOUVER FINISH - DARK BRONZE TO MATCH STOREFRONT	 ALL UTILITY BOXES AND METERS SHALL BE PAINTED TO MATCH SURROUNDING BUILDING FACADE. 	
AF-1	ALUMINUM PARAPET FLASHING TO MATCH STOREFRONT	 FINAL SIGN DESIGN TO BE DRAFTER BY THIRD PARTY CONTRACTOR TO ENSURE FINAL SIGN PACKAGE IS SUBMITTED APPROVED BY THE 	
GL	EXTERIOR WINDOWS: STOREFRONT WINDOW SYSTEM	BRAND	
SF	STOREFRONT - KAWNEER - "DARK BRONZE #40"	38% transparency on 1st floor > 33% parkway requirements	
SP	SPANDREL		

SPITALIT MARQUEE H
10000 N POLO DR
KANSAS CITY, MO 64153
PROJECT # 00000

ARCHITECT D. HAYES HINKLE

> 29 MAY 2024 ISSUED FOR

ISSUE DATE

REVIEW

Date Revision


SHEET NAME

BUILDING ELEVATIONS

SHEET NUMBER


A5.02




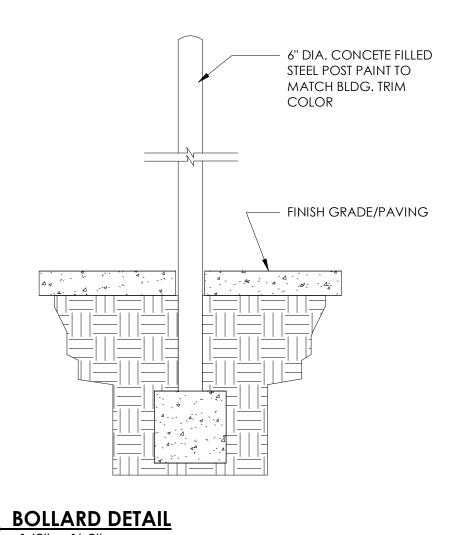

- ARCH FINISH OVER CMU MASONRY WALL – 3/4" DIA. HINGE PIN - 3/4" I.D. PIPE 1"X1" 11 GAUGE TUBE STEEL GATE FRAMING WITH 16 GAUGE F-6" DIA. STEEL POST CONCRETE FILLED —— 3/4" DIA. STEEL ROD WELD — TO HINGE PIPE AND GATE POST 1/2" TH. STEEL HINGE PLATE PLAN VIEW (SIM)


— 1"X1" 11 GAUGE TUBE STEEL METAL COPING ----GATE FRMING WITH 16 GAUGE F-DECKING 6 " DIA. STEEL POST – 3/4" DIA. HINGE PIN CONCRETE FILLED - 3/4" I.D. PIPE ARCH FINISH OVER CMU _ MASONRY WALL 1/2" TH. STEEL HINGE PLATE 3/4" DIA. STEEL ROD -WELD TO HINGE PIPE AND GATE POST ELEVATION (SIM)

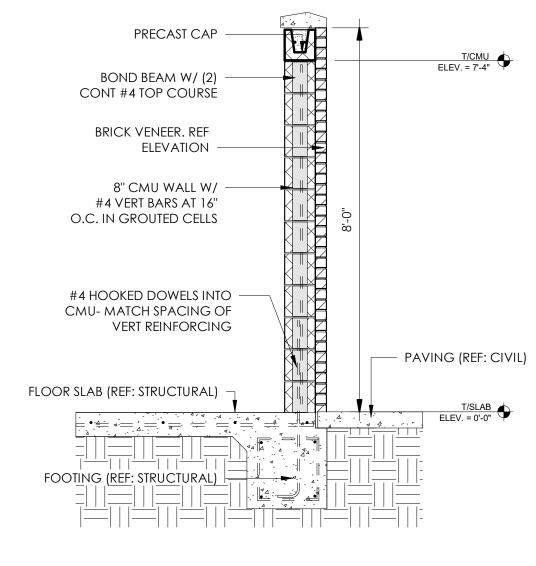

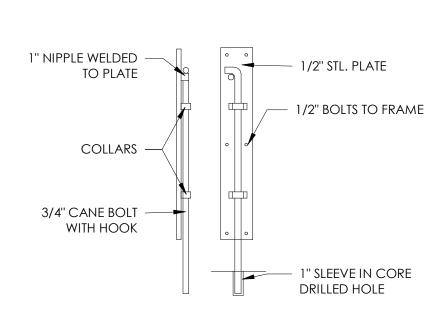



2 CANE BOLT | " = 1'-0"

9 DUMPSTER ENCLOSURE SECTION 1/2" = 1'-0"

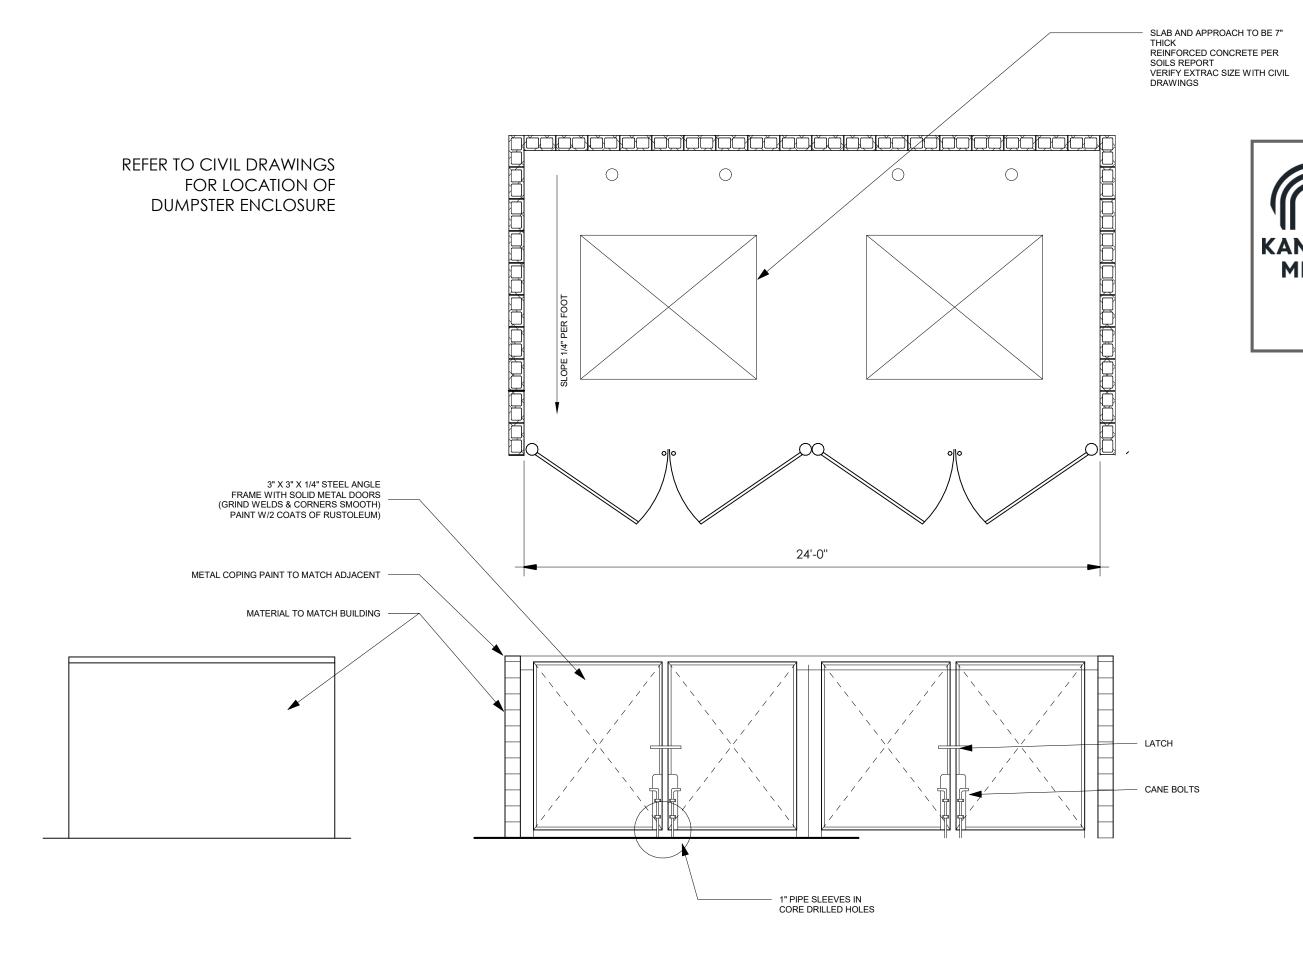

3 DUMPSTER ENCLOSURE

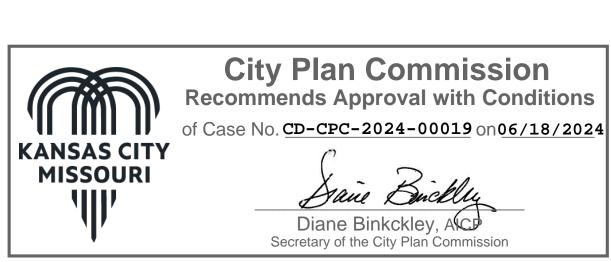

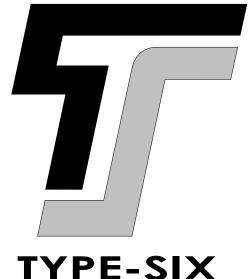

TYPE-SIX

TYPE-SIX DEVELOPMENT SERVICES, LLC

910 SOUTH MAIN STREET #150 GRAPEVINE, TEXAS 76054 972.677.9075

ARCHITECT

D. HAYES HINKLE **ISSUE DATE**

> 29 MAY 2024 ISSUED FOR

REVIEW

Revision SHEET NAME

SHEET NUMBER


SITE ELEMENTS

A0.03



City Plan Commission
Recommends Approval with Conditions
of Case No. CD-CPC-2024-00019 on06/18/2024

Diane Binkckley, AICP Secretary of the City Plan Commission

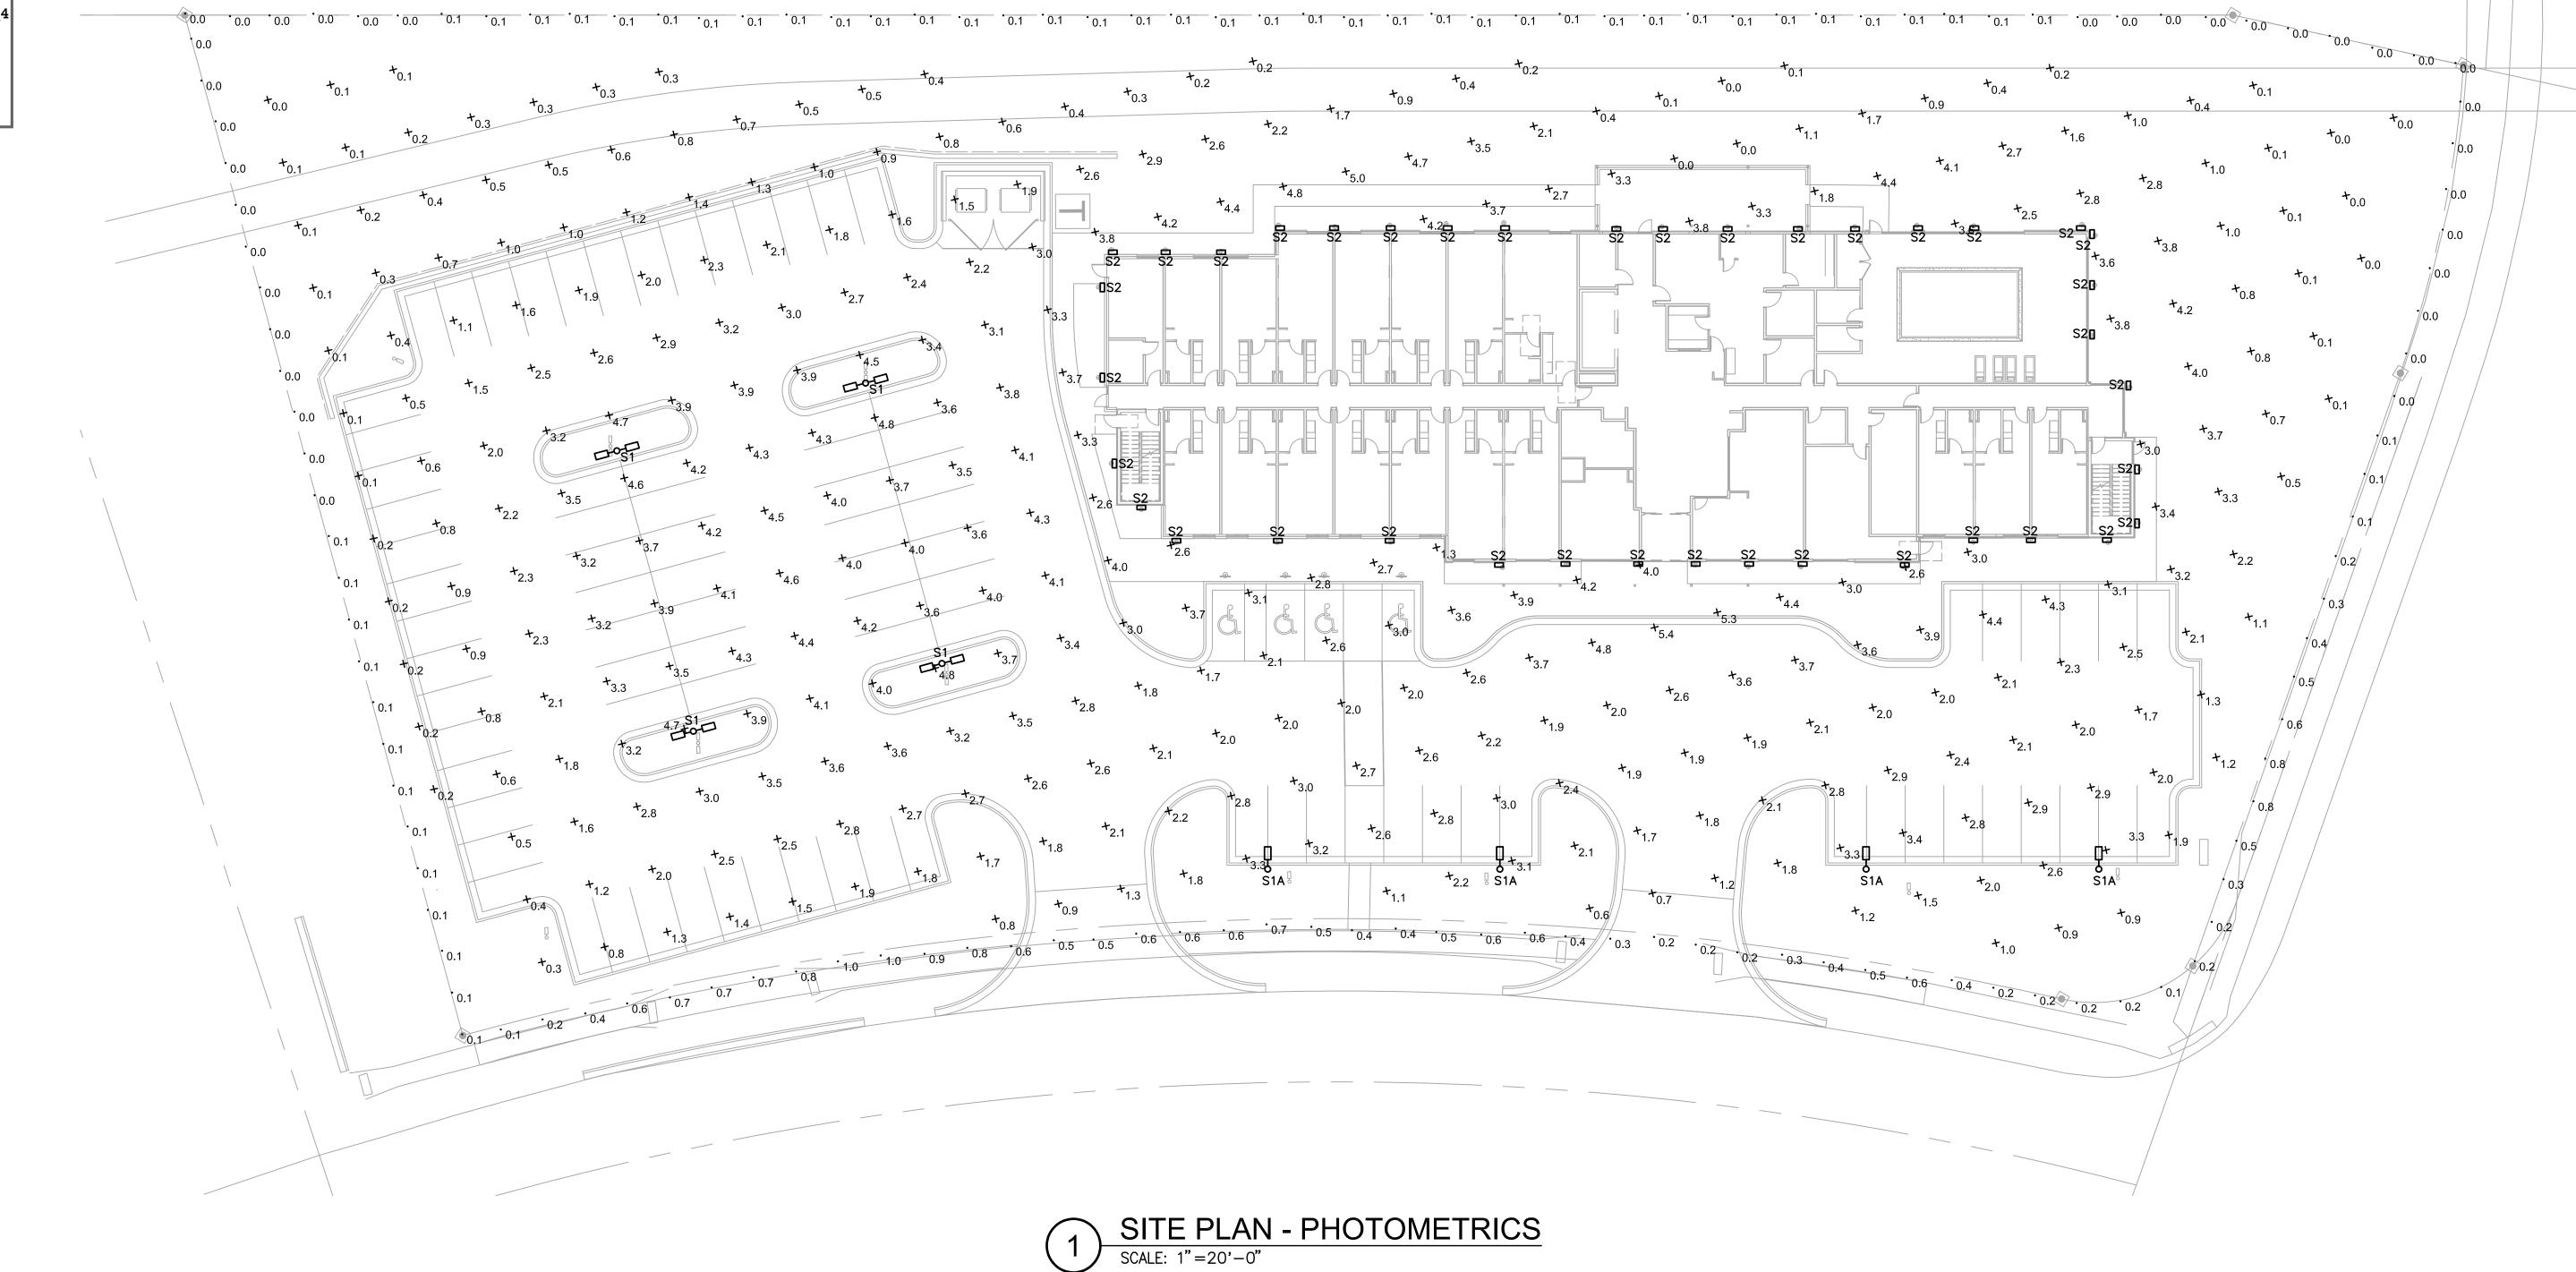

			ı	LIGHTING SCI	HEDULE	
				LAMP		FIXTURE
TYPE	DESCRIPTION	VOLTAGE	NO.	TYPE	MOUNTING	MANUFACTURER/ CAT. #
S1	LED POLE MOUNTED SITE LIGHT	120	1	104W	POLE	LITHONIA
				LED	20'	DSX1-LED-P3-40K-80CRI-T2M-XX-XX-HS-XX
S1A	LED POLE MOUNTED SITE LIGHT	120	1	104W	POLE	LITHONIA
				LED	20'	DSX1-LED-P3-40K-80CRI-T4M-MVOLT-XX-XX-HS-XX
S2	LED BUILDING MOUNTED SITE LIGHT	120	1		SURFACE	LITHONIA
				LED	13'	DSXW1-LED-10C-700-40K-TFTM-MVOLT-XX-HS-XX

ALL REQUESTS FOR SUBSITUTIONS/ALTERNATES MUST BE SUBMITTED TO ENGINEER 7 DAYS PRIOR TO BID FOR APPROVAL.
 ALL SUBMISSION SHALL INCLUDE DETAILED CUT SHEETS AND PERFORMANCE DATA FOR CONSIDERATION.
 CONTRACTOR MUST SUBMIT LAMPS AND BALLAST WITH FIXTURE SUBMITTALS.

3.) LIGHTING PACKAGE MUST BE ENERGY STAR LISTED FIXTURES AND/OR LAMPS

TYPE-SIX

TYPE-SIX
DEVELOPMENT SERVICES, LLC
910 SOUTH MAIN STREET #150
GRAPEVINE, TEXAS 76054

910 SOUTH MAIN STREET #150 GRAPEVINE, TEXAS 76054 972.677.9075

IVSMART STUDIOS ARQUEE HOSPITALITY

ISSUED FOR REVIEW

ARCHITECT

D. HAYES HINKLE

ISSUE DATE

17 MAY 2024

Revision Date

SHEET NAME
SITE PLAN
PHOTOMETRICS


SHEET NUMBER
PH1.01



3 CONSULTING ENGINEERS

VIGILANT - VIABLE - VIRTUOUS V3 PROJECT #: 24010



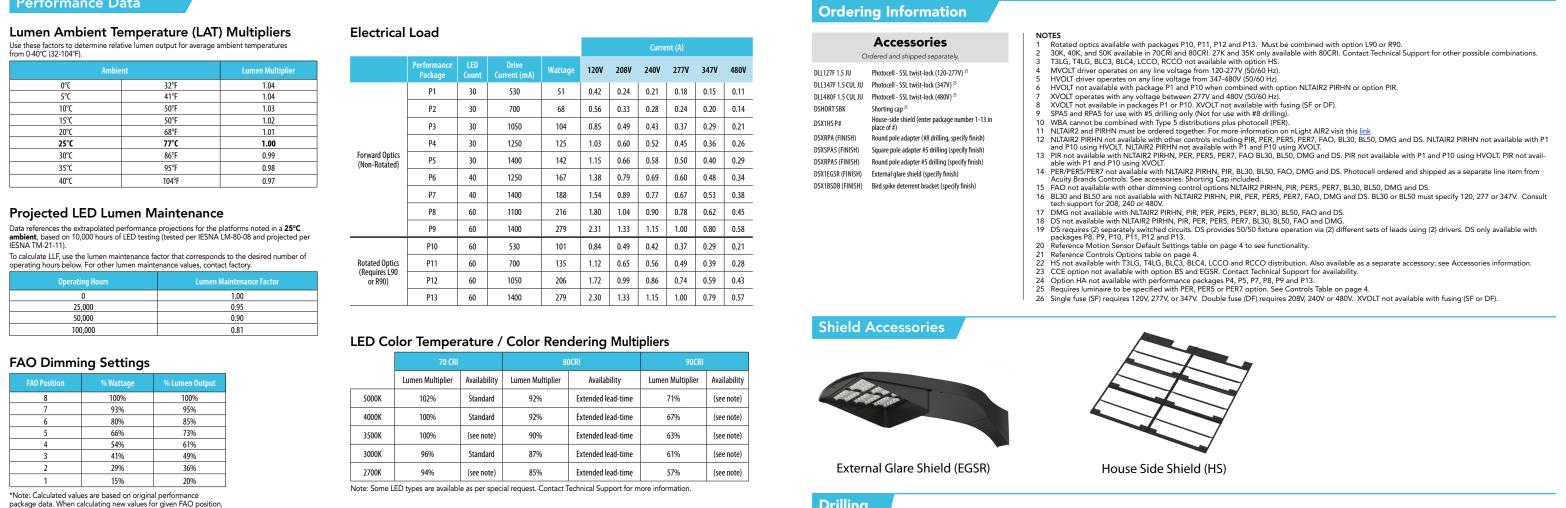



otion Senso	r Default Settings					
Option	Unoccupied Dimmed Level	High Level (when occupied)	Phototcell Operation	Dwell Time	Ramp-up Time	Dimming Fade Rate
PIR	30%	100%	Enabled @ 2FC	7.5 min	3 sec	5 min
NLTAIR2 PIRHN	30%	100%	Enabled @ 2FC	7.5 min	3 sec	5 min
ntrols Opti	ons					


Nomenclature	Description	Functionality	Primary control device	Notes
FAO	Field adjustable output device installed inside the luminaire; wired to the driver dimming leads.	Allows the luminaire to be manually dimmed, effectively trimming the light output.	FAO device	Cannot be used with other controls options that need the 0-10V leads
DS (not available on DSX0)	Drivers wired independently for 50/50 luminaire operation	The luminaire is wired to two separate circuits, allowing for 50/50 operation.	Independently wired drivers	Requires two separately switched circuits. Consider nLight AIR as a more cost effective alternative.
PER5 or PER7	Twist-lock photocell receptacle	Compatible with standard twist-lock photocells for dusk to dawn operation, or advanced control nodes that provide 0-10V dimming signals.	Twist-lock photocells such as DLL Elite or advanced control nodes such as ROAM.	Pins 4 & 5 to dimming leads on driver, Pins 6 & 7 are capped inside luminaire. Cannot be used with other controls options that need the 0-10V leads.
PIR	Motion sensor with integral photocell. Sensor suitable for 8' to 40' mounting height.	Luminaires dim when no occupancy is detected.	Acuity Controls rSBG	Cannot be used with other controls options that need the 0-10V leads.
NLTAIR2 PIRHN	nLight AIR enabled luminaire for motion sensing, photocell and wireless communication.	Motion and ambient light sensing with group response. Scheduled dimming with motion sensor over-ride when wirelessly connected to the nLight Eclypse.	nLight Air rSBG	nLight AIR sensors can be programmed and commissioned from the ground using the CIAIRity Pro app. Cannot be use with other controls options that need the 0-10V leads.
BL30 or BL50	Integrated bi-level device that allows a second control circuit to switch all light engines to either 30% or 50% light output	BLC device provides input to 0-10V dimming leads on all drivers providing either 100% or dimmed (30% or 50%) control by a secondary circuit	BLC UVOLT1	BLC device is powered off the 0-10V dimming leads, thus can be used with any input voltage from 120 to 480V

COMMERCIAL OUTDOOR

COMMERCIAL OUTDOOR

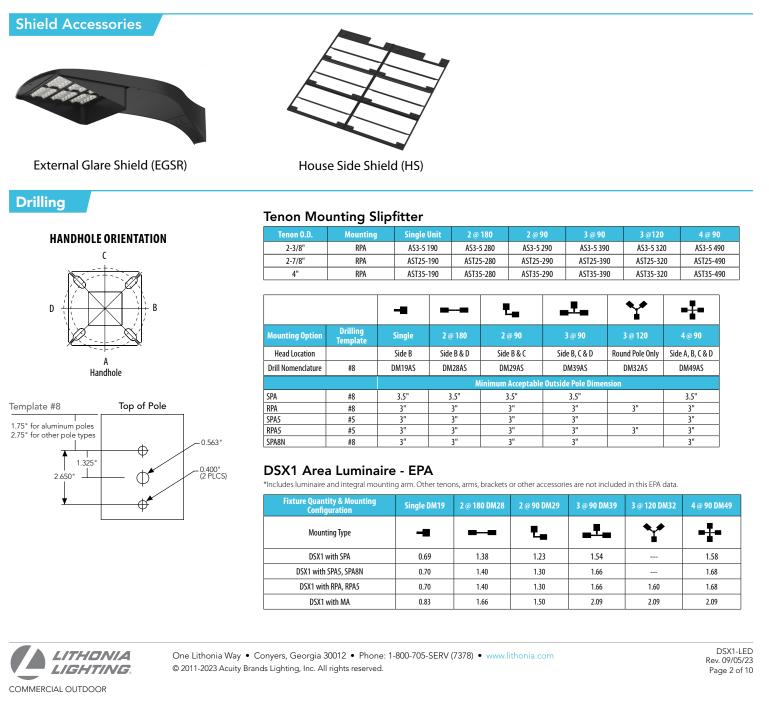


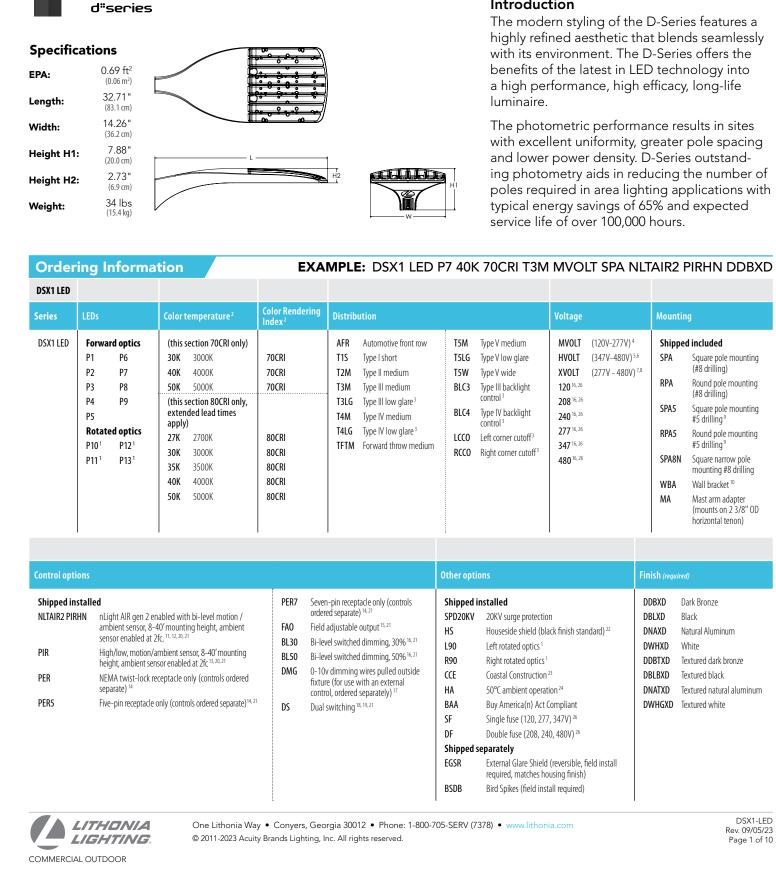

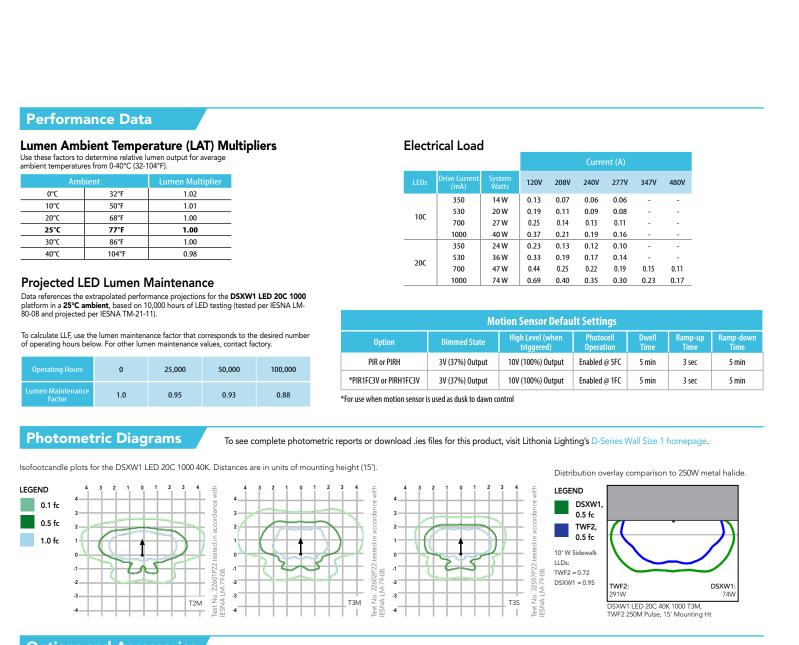

T3M (left)	HS - House-side shields	BSW - Bird-d	eterrent spikes	VG - Vandal guard	DDL - Diffused drop lens
	NS:	the smart		allation. Luminaire has a slotted ga	y to any 4" round or square outlet box for sket wireway and attaches to the mounting
NSTRUCTION			LISTINGS CSA certified to U.S	S. and Canadian standards. Rated f	for -40°C minimum ambient.
ough conductive and convective cool er is mounted to the door to therma	as integral heat sink fins to optimize thermal manag ing. Modular design allows for ease of maintenance lly isolate it from the light engines for low operating led against moisture and environmental contaminar	e. The LED temperature	requirements under	embled in the USA and meets the B	Buy America(n) government procurement s. Please refer to www.acuitybrands.com/
t provides superior resistance to co	infused Super Durable TGIC thermoset powder prosion and weathering. A tightly controlled mu	lti-stage	WARRANTY Five-year limited wa	arranty. This is the only warranty pr	ovided and no other statements in this
	ckness for a finish that can withstand extreme cli Available in textured and non-textured finishes.	mate			I other express and implied warranties are v.acuitybrands.com/support/warranty/terms-
	enses provide multiple photometric distributions ications. Light engines are available in 3000 K (70 . CRI) configurations.		Note: Actual perfor All values are design	rmance may differ as a result of en In or typical values, measured unde ect to change without notice.	d-user environment and application. er laboratory conditions at 25 °C.




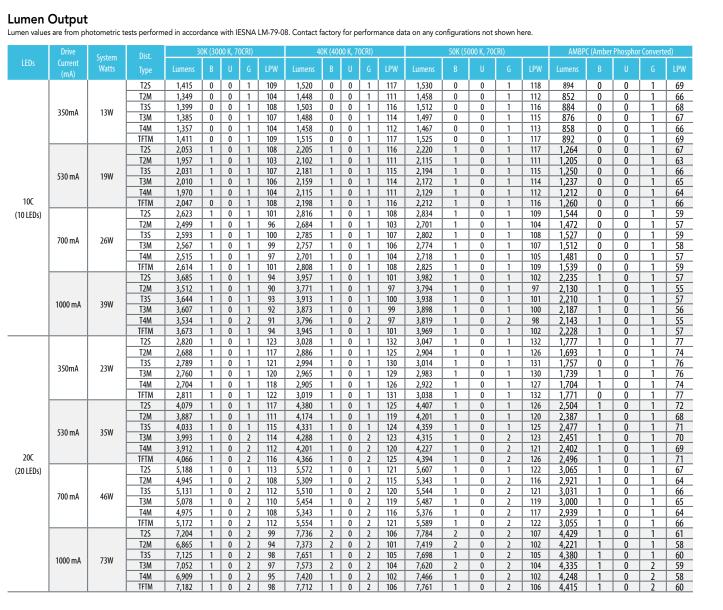

Performance Data

LITHONIA LIGHTING

COMMERCIAL OUTDOOR

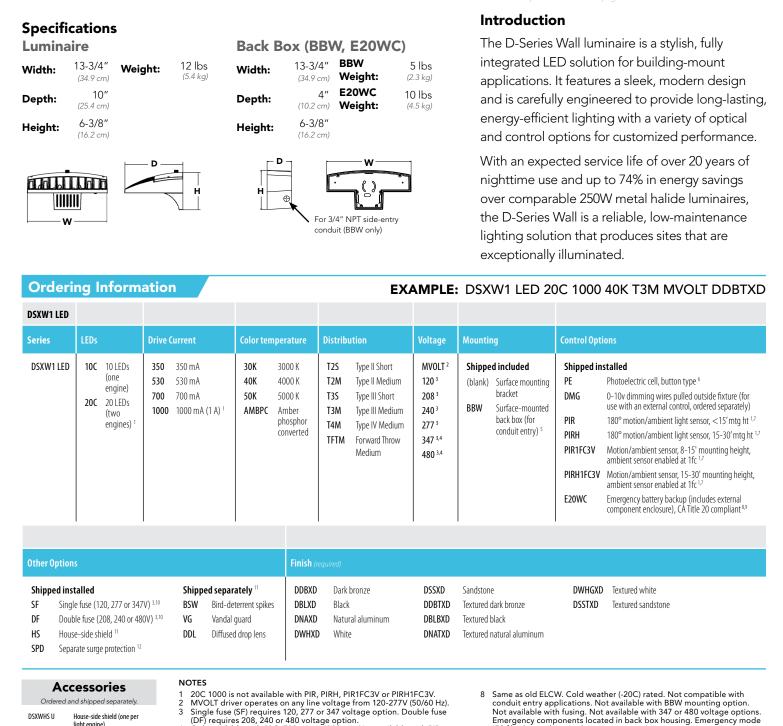

D-Series Size 1

LED Wall Luminaire

				D. HAYES HINKLE
		Other Options	Finish (required)	ISSUE DATE
		Shipped installed SF Single fuse (120, 277 or 347V) 3.10 DF Double fuse (208, 240 or 480V) 3.10 HS House-side shield 11	Shipped separately 11 DDBXD Dark bronze DSSXD Sandstone DWHGXD Textured white BSW Bird-deterrent spikes DBLXD Black DDBTXD Textured dark bronze DSSTXD Textured sandstone VG Vandal guard DNAXD Natural aluminum DBLBXD Textured black DDL Diffused drop lens DWHXD White DNATXD Textured natural aluminum	17 MAY 2024
		SPD Separate surge protection 12 Accessories	NOTES	ISSUED FOR
		Ordered and shipped separately. DSXWHS U House-side shield (one per light engine) DSXWBSW U Bird-deterrent spikes DSXW1VG U Vandal quard accessory	 20C 1000 is not available with PIR, PIRH, PIR1FC3V or PIRH1FC3V. MVOLT driver operates on any line voltage from 120-277V (50/60 Hz). Single fuse (SF) requires 120, 277 or 347 voltage option. Double fuse (DF) requires 208, 240 or 480 voltage option. Only available with 20C, 700mA or 1000mA. Not available with PIR or PIRH. Back box ships installed on fixture. Cannot be field installed. Cannot be 	REVIEW
			ordered as an accessory. 6 Photocontrol (PE) requires 120, 208, 240, 277 or 347 voltage option. Not available with motion/ambient light sensors (PIR or PIRH). 7 Reference Motion Sensor table on page 3.	# Revision Date
ithonia Way • Conyers, Georgia 30012 • Phone: 1-800-705-SERV (7378) • www.lithonia.com 3-2023 Acuity Brands Lighting, Inc. All rights reserved.	DSXW1-LED Rev. 1/18/23	LITHONIA LIGHTING. COMMERCIAL OUTDOOR	One Lithonia Way • Conyers, Georgia 30012 • Phone: 1-800-705-SERV (7378) • www.lithonia.com © 2013-2023 Acuity Brands Lighting, Inc. All rights reserved. DSXW1-LED Rev. 1/18/23	
				SHEET NAME LIGHT FIXTURE DETAILS
				SHEET NUMBER

City Plan Commission Recommends Approval with Condition f Case No. <u>CD-CPC-2024-00019</u> on <u>06/18/20</u>2 KANSAS CITY MISSOURI Diane Binkckley, AC Secretary of the City Plan Commission

Performance Data

LITHONIA LIGHTING

COMMERCIAL OUTDOOR

 13,055
 2
 0
 3
 128
 13,605
 2
 0
 3
 133
 13,871
 2
 0
 3
 136

 13,206
 2
 0
 4
 129
 13,763
 2
 0
 4
 135
 14,031
 2
 0
 4
 137

 11,797
 2
 0
 2
 115
 12,294
 2
 0
 2
 120
 12,534
 2
 0
 2
 123

 13,403
 2
 0
 4
 131
 13,968
 2
 0
 4
 137
 14,241
 2
 0
 4
 139

 12,190
 2
 0
 2
 119
 12,704
 2
 0
 2
 124
 12,952
 2
 0
 2
 127

 13,496
 2
 0
 4
 132
 14,065
 2
 0
 4
 138
 14,339
 2
 0
 4
 140

 13,790
 4
 0
 2

One Lithonia Way • Conyers, Georgia 30012 • Phone: 1-800-705-SERV (7378) • www.lithonia.com

© 2011-2023 Acuity Brands Lighting, Inc. All rights reserved.

Lumen Output





S1&S1A

Introduction

ARCHITECT

30

7

PH1.02

