

PRELIMINARY DEVELOPMENT PLAN & PRELIMINARY PLAT FOR COOKINGHAM DEVELOPMENT

Part of the NW & NE 1/4 Section 21-Township 52S-Range 33E in the City of Kansas City Platte County, Missouri

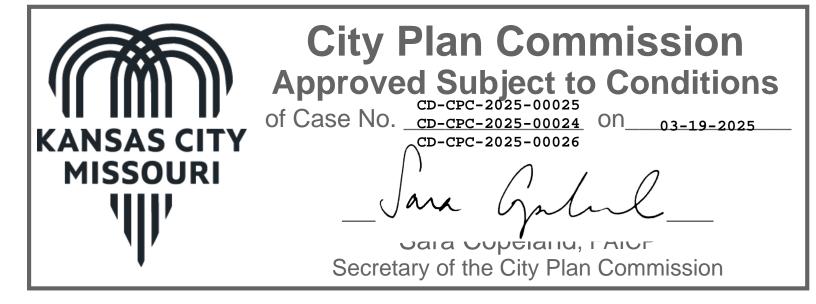

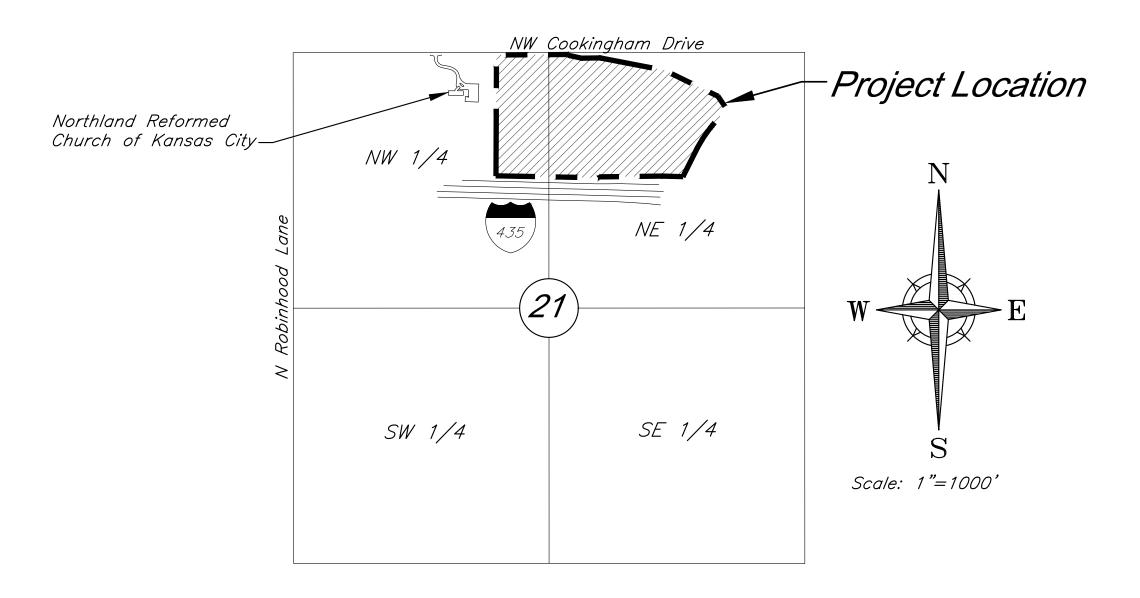

VICINITY MAP Part of the NW & NE 1/4 Section 21-Township 52-Range 33

INDEX OF SHEETS

Sht. No.	Description
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<i>4-5</i>	Site Plan
6	Landscape Plan
7	Street Tree Plan
8	Planting Details
9-10	Grading Plan
<i>11-12</i>	Utility Plan
<i>13</i>	Tree Removal & Tree Preservation Plan
<i>14</i>	Preliminary Plat
<i>15</i>	Section Exhibit
<i>16</i>	Stream Buffer Plan
E1.1	Lighting Plan
<i>E1.2</i>	Lighting Plan
A4.1 - Color	Partial Building Elevations
A4.2 - Color	Partial Building Elevations
A4.3 - Color	Partial Building Elevations

PREPARED FOR: GBA REALTY LLC 9801 RENNER BOULEVARD LENEXA, KANSAS 66219 PHONE: 816-876-3893 CONTACT: GRAHAM JONES LEED AP EMAIL: gjones@gbabuilders.com


PREPARED BY: GEORGE BUTLER ASSOCIATES, INC. 9801 RENNER BOULEVARD LENEXA, KANSAS 66219 PHONE: 913-492-0400 CONTACT: BRIAN BOYD EMAIL: bboyd@gbateam.com

FLOODPLAIN:

According to the Flood Insurance Rate Maps (FIRMs) for the city of Kansas City, Missouri (29095C0061G, dated January 20th, 2017), the site is situated mainly within Zone X, areas determined to be outside the 0.2% annual chance floodplain. A channel on the site contains Zone AE, special flood hazard areas.

DEVIATIONS REQUESTED:

1. A deviation is requested to allow facilities up to 70 feet in height on each of the proposed

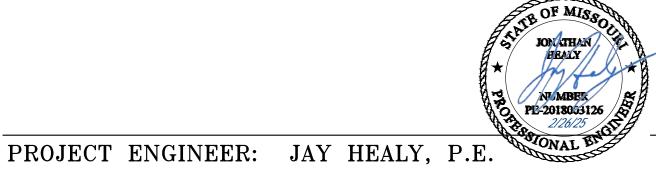

APPROVED BY:


MANAGER, ENGINEERING SERVICES DIVISION:


DATE:

DATE:



9801 Renner Boulevard Lenexa, Kansas 66219 9 1 3 . 4 9 2 . 0 4 0 0 www.gbateam.com

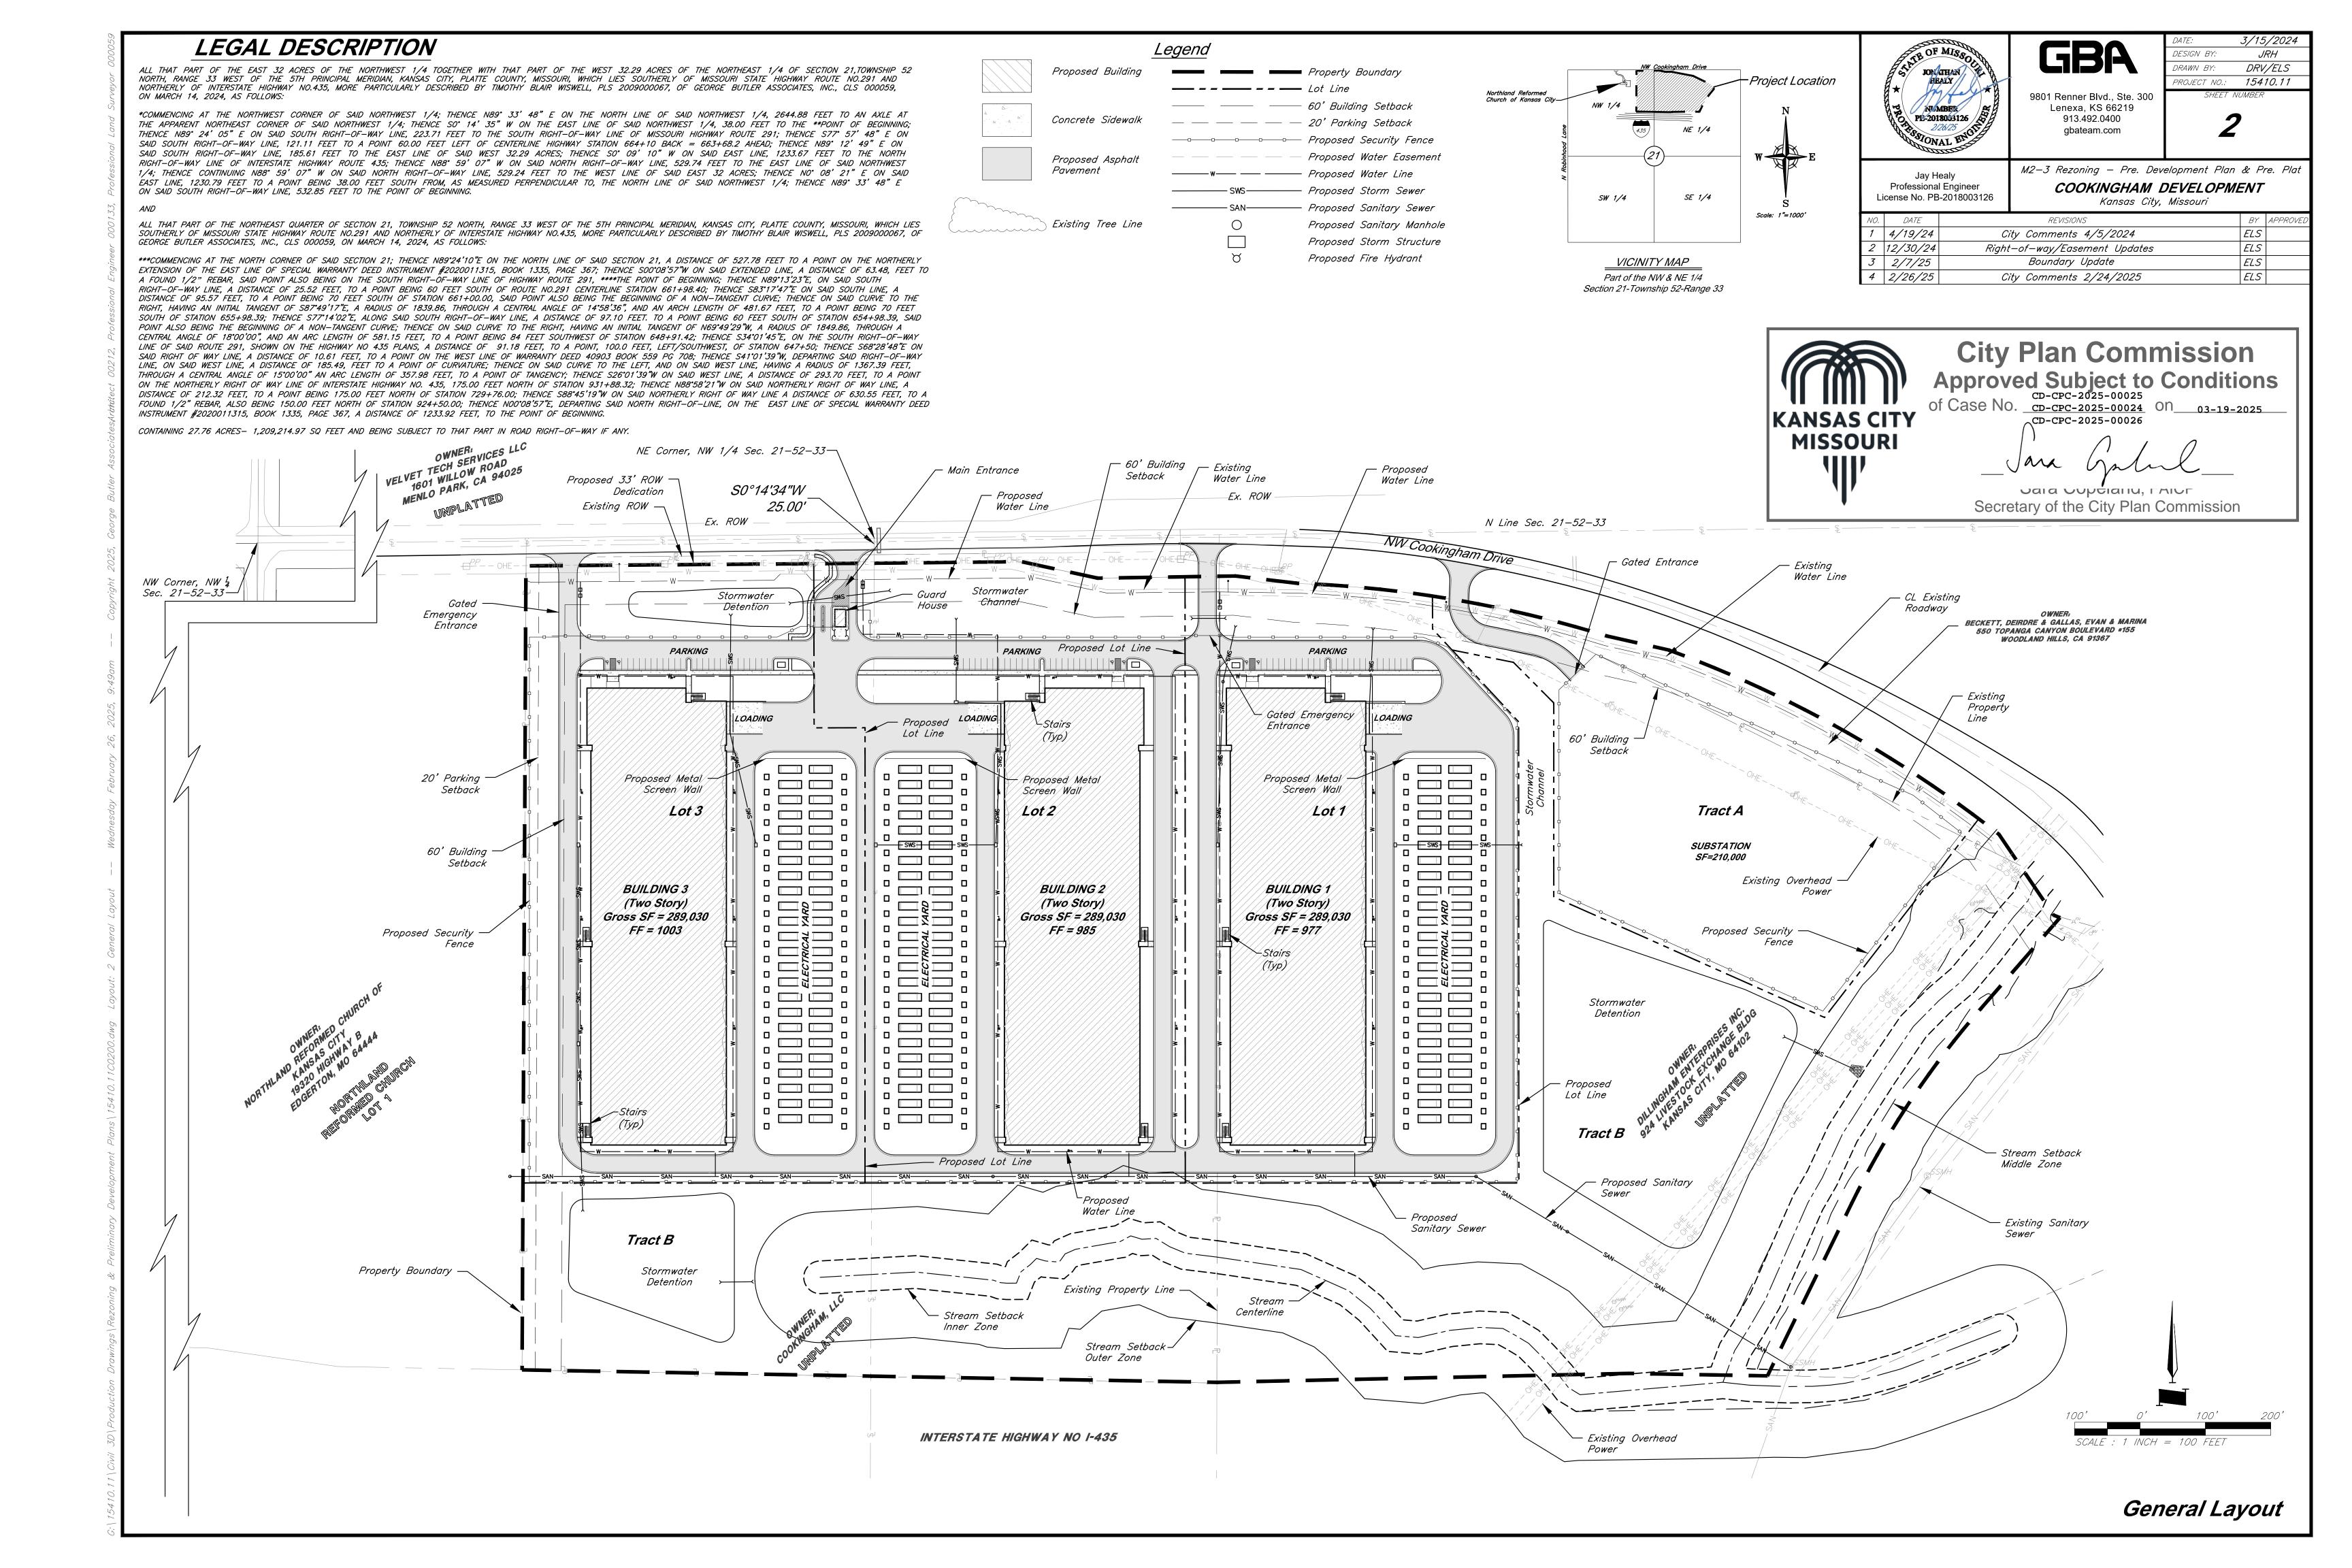

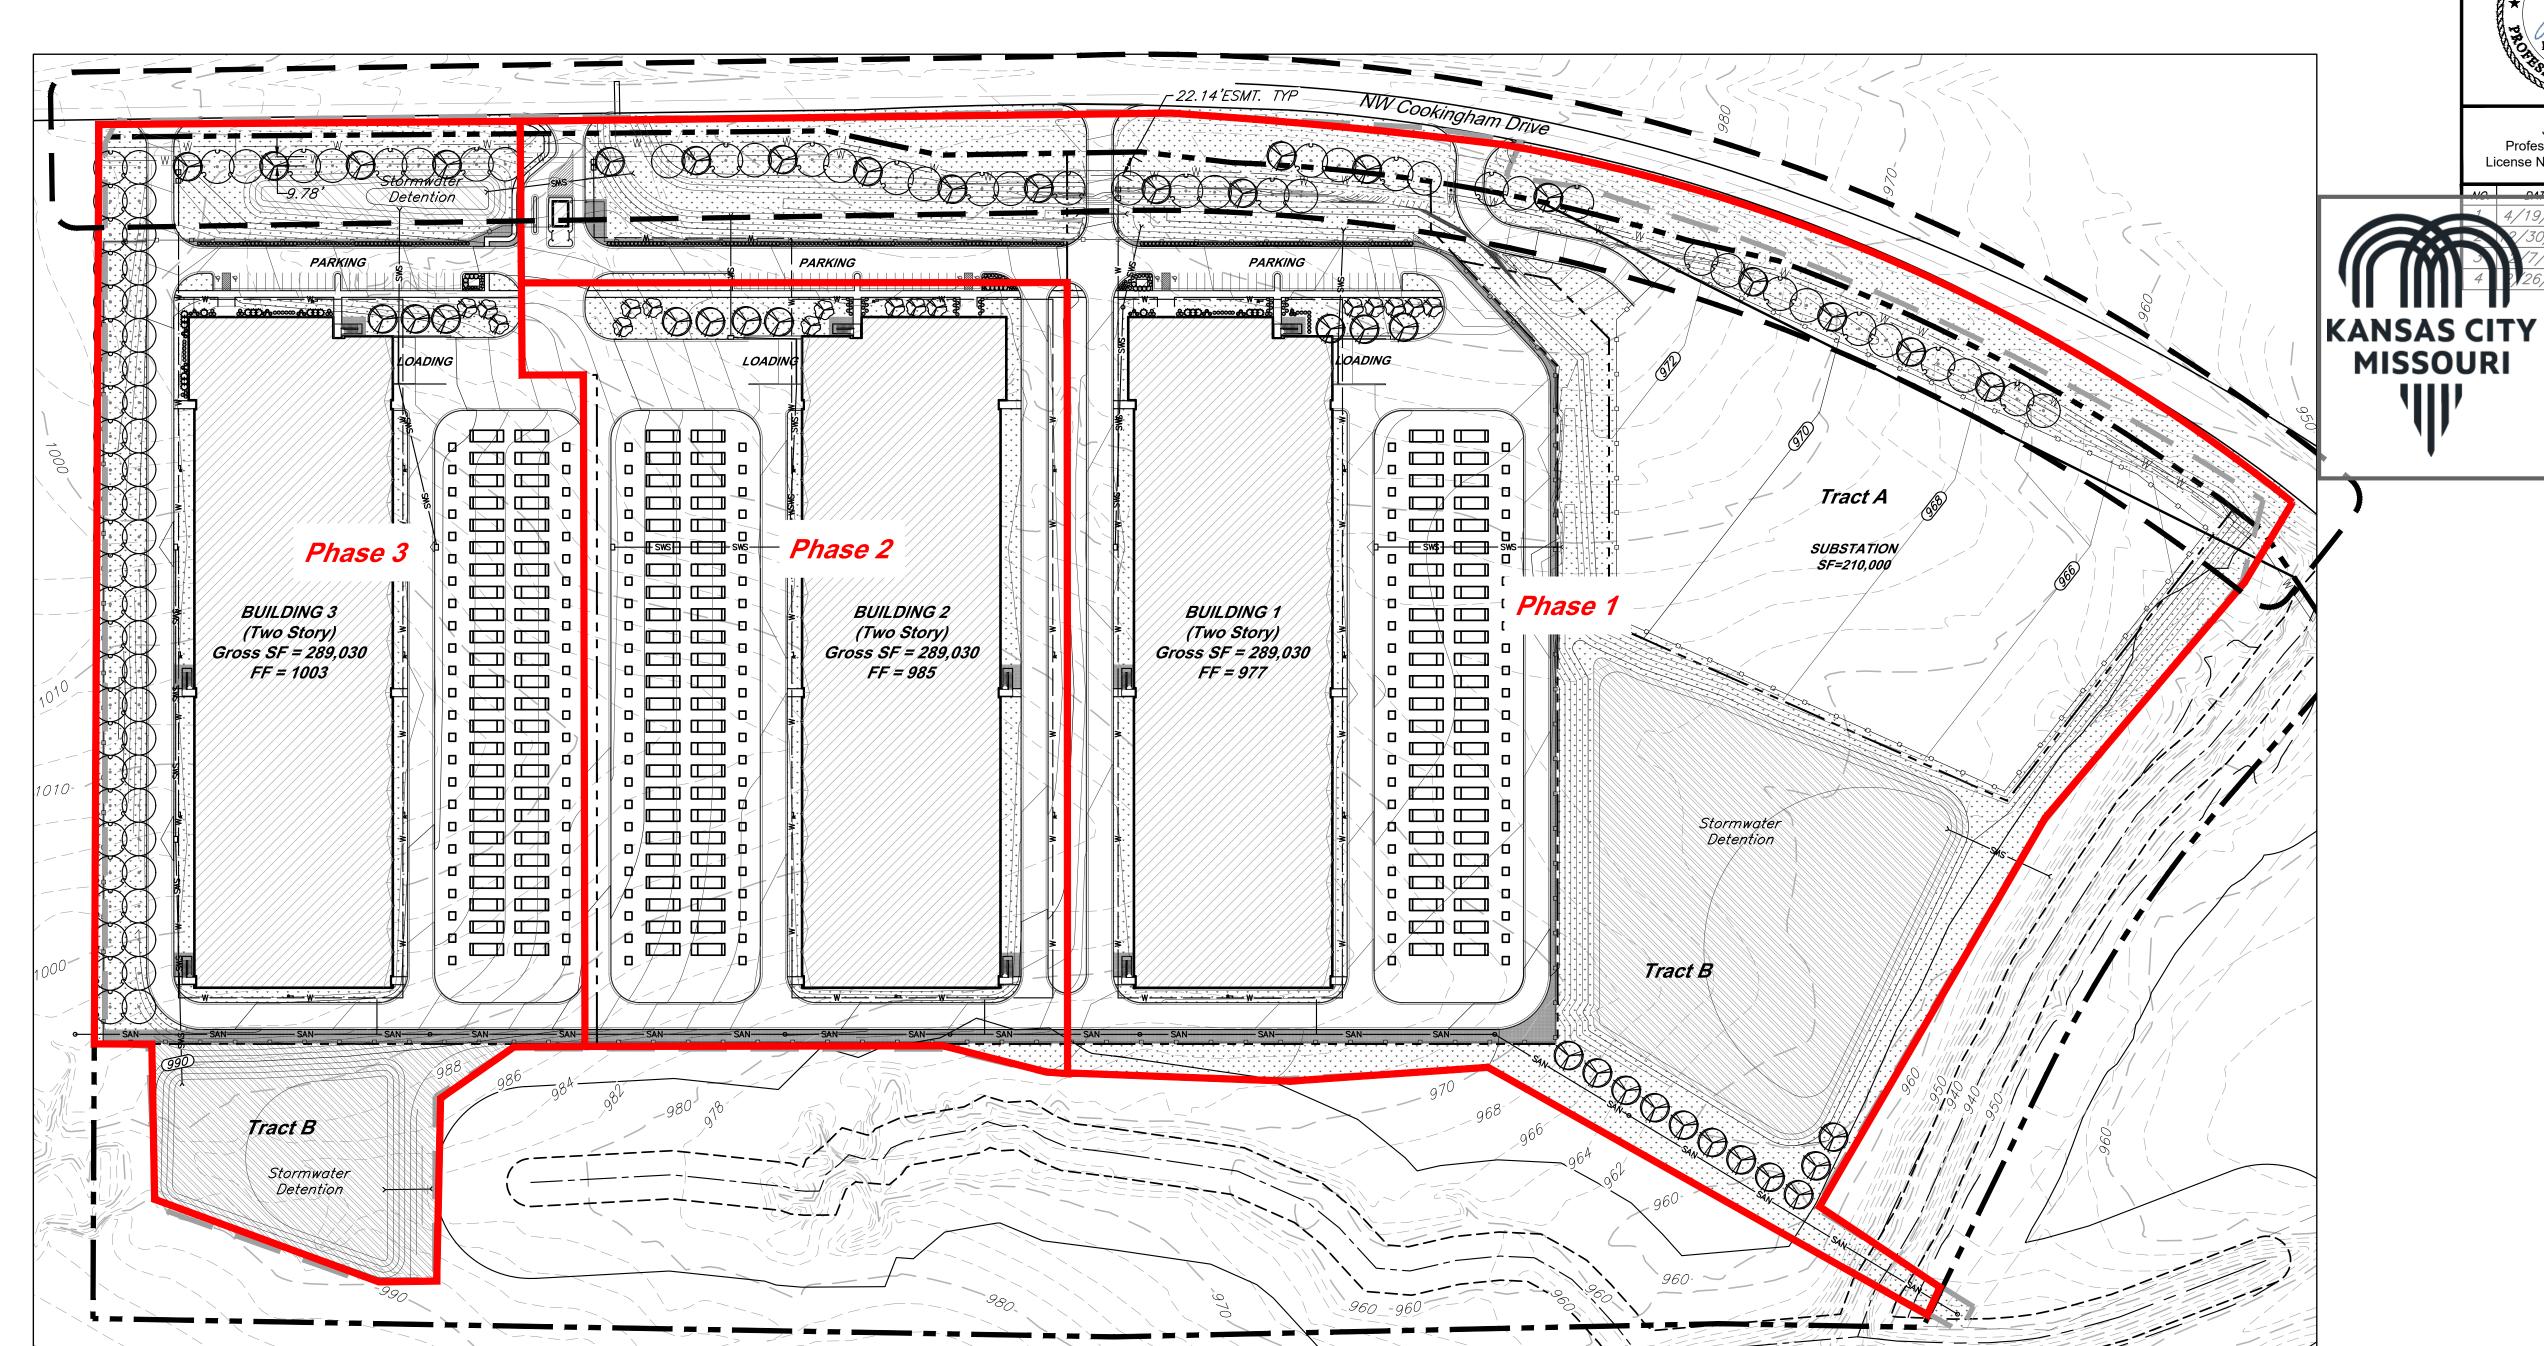

NVMBEK PE-2018053126 2/26/25

GBA

9801 Renner Blvd., Ste. 300 Lenexa, KS 66219 913.492.0400 gbateam.com

Jay Healy Professional Engineer License No. PB-2018003126 M2-3 Rezoning - Pre. Development Plan & Pre. Plat COOKINGHAM DEVELOPMENT Kansas City, Missouri

DESIGN BY: DRAWN BY:

DRV/ELS

PROJECT NO.: 15410.11

o/24 City Comments 1/5/2024

O/24 Cityht-pi-latase of Onathission 7/5

Boundary Update

CD-CPC-2025-00025

CD-CPC-2025-00024


CD-CPC-2025-00026


CD-CPC-2025-00026

MISSOURI

Jaia Cuptialiu, Faice Secretary of the City Plan Commission

Phasing Plan

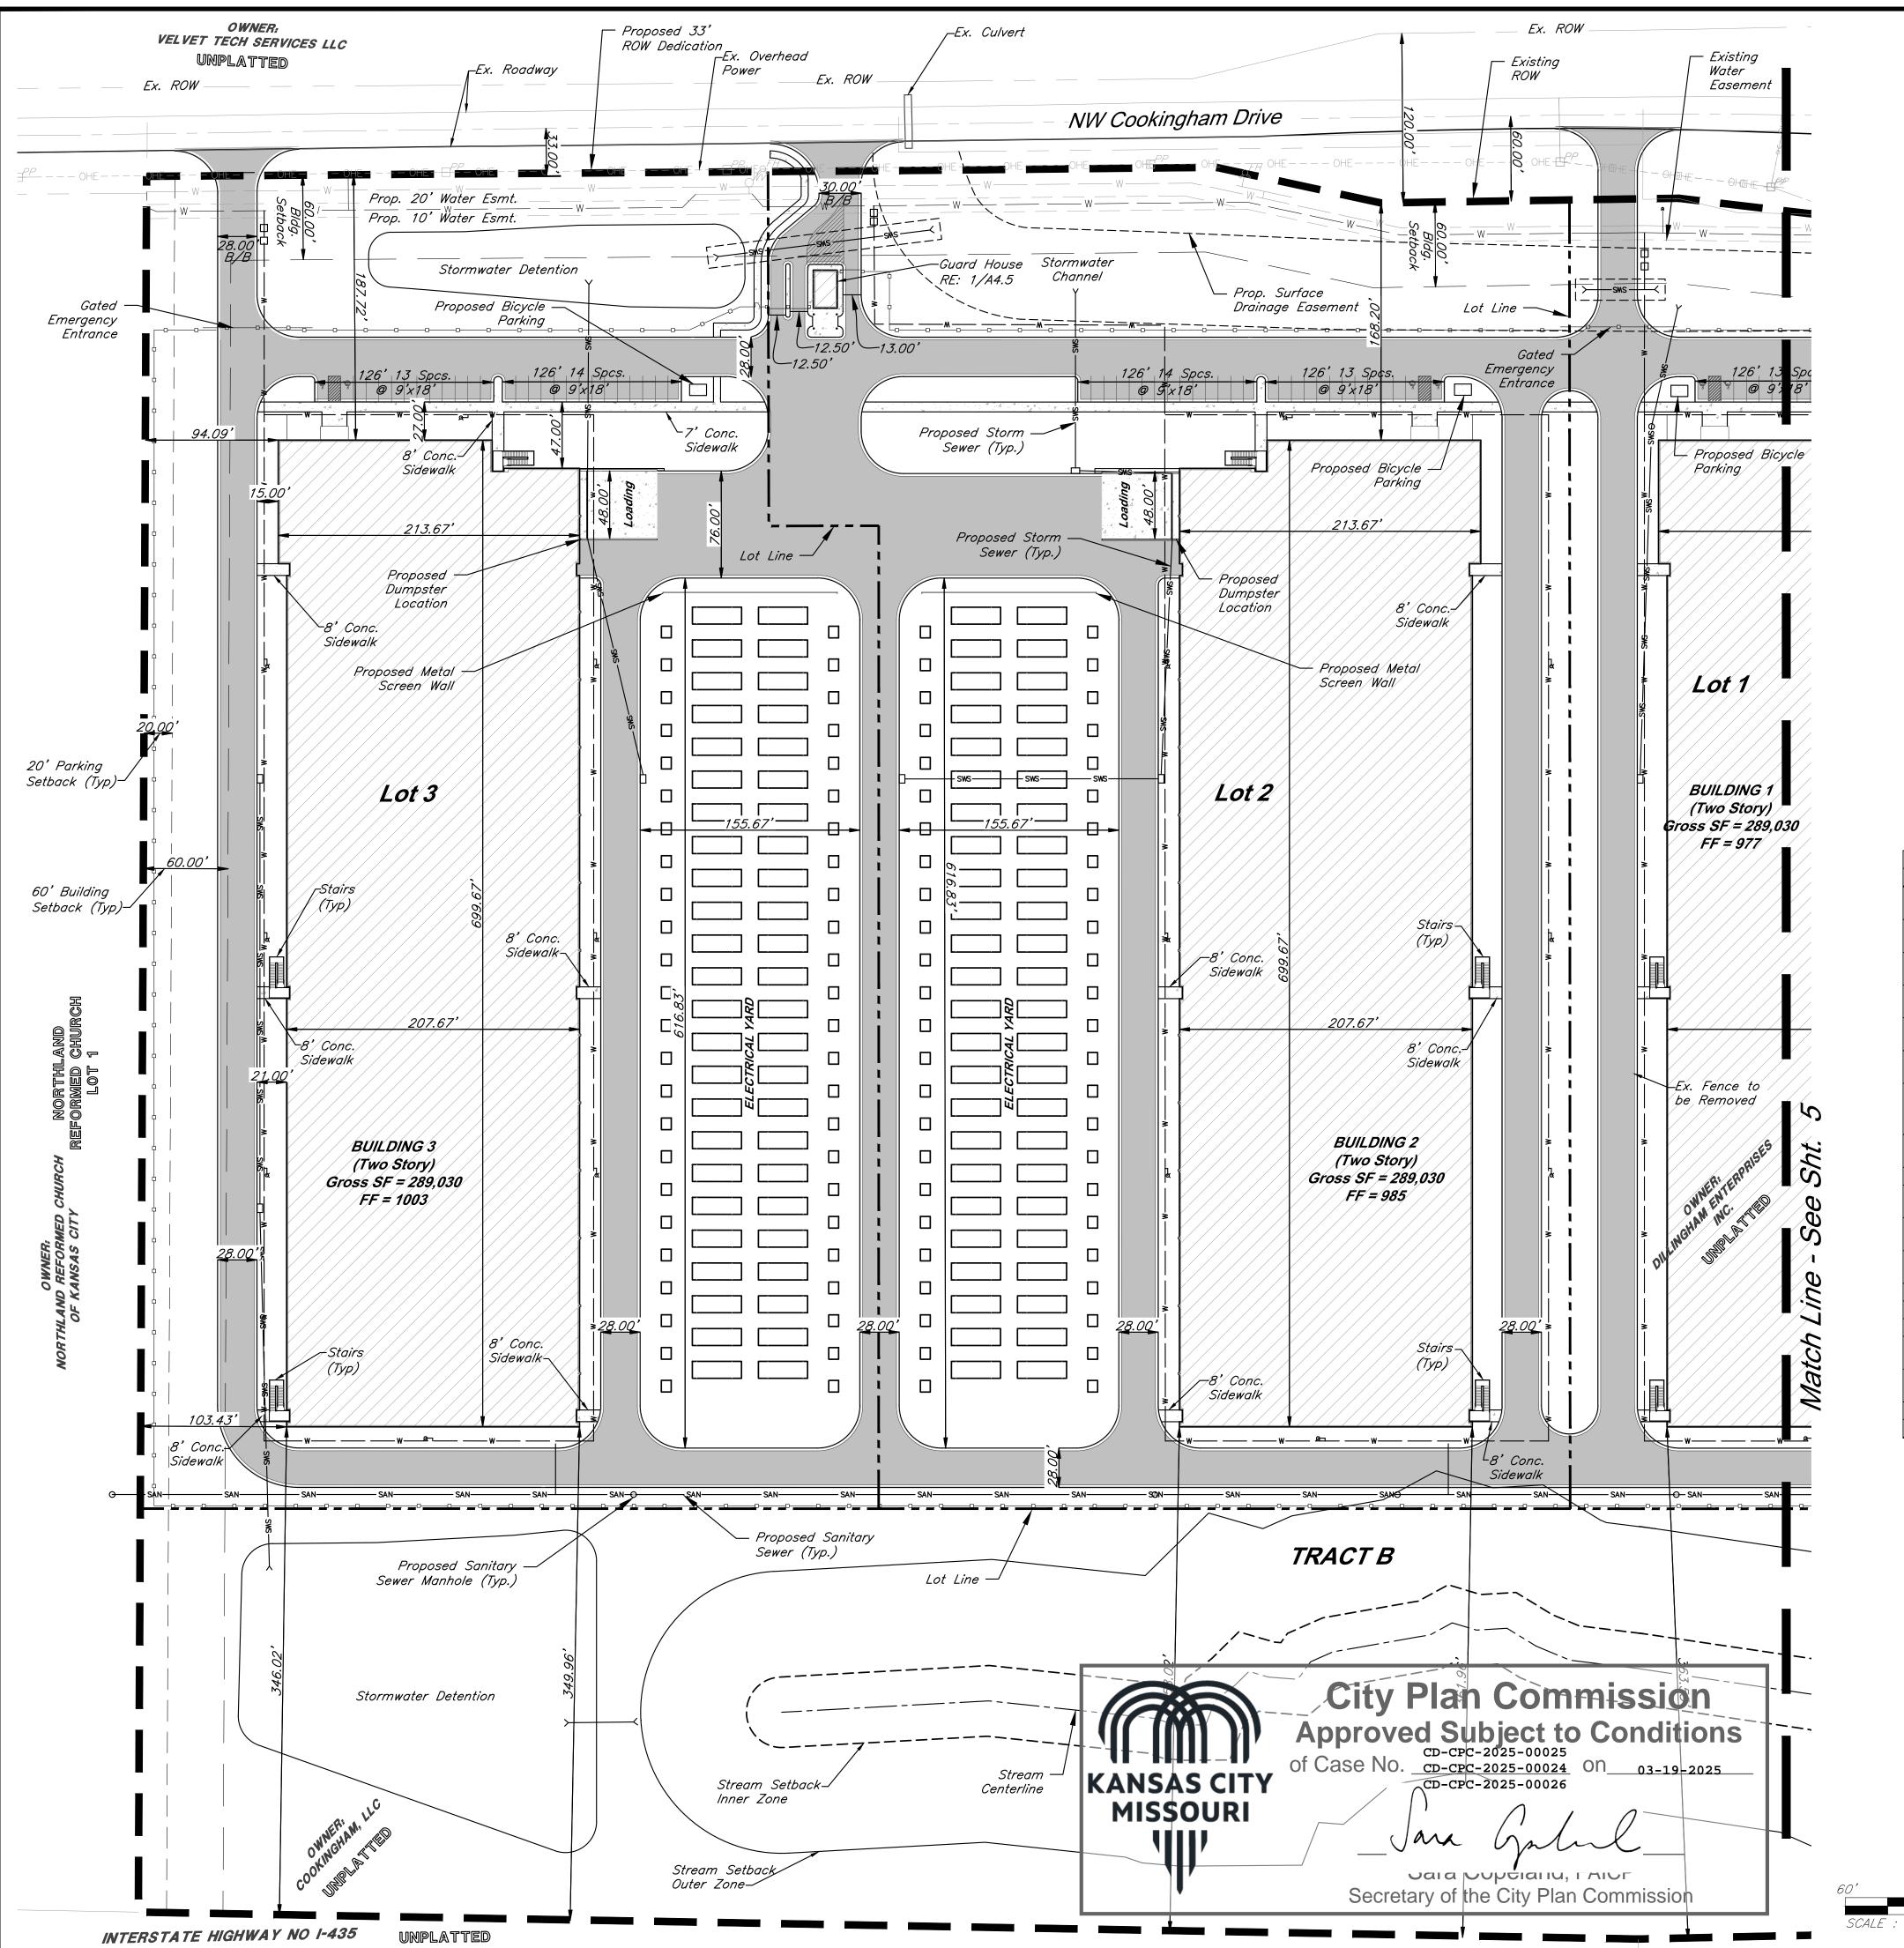

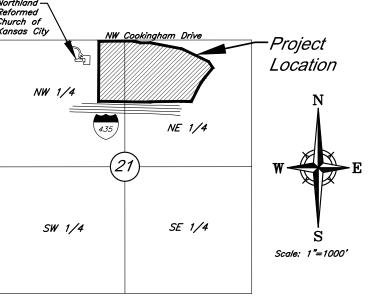

VICINITY MAP
Part of the NW & NE 1/4
Section 21-Township 52-Range 33

OF MISSOLUTION ATHAN HEALY ** NUMBER PE-2018053126 2/26/25

9801 Renner Blvd., Ste. 300

Lenexa, KS 66219 913.492.0400 gbateam.com



JRH

Professional Engineer License No. PB-2018003126

Jay Healy

M2-3 Rezoning - Pre. Development Plan & Pre. Plat

COOKINGHAM DEVELOPMENT

Kansas City, Missouri

DESIGN BY:

DATE	REVISIONS	BY	APPROVED
4/19/24	City Comments 4/5/2024	ELS	
12/30/24	Right-of-way/Easement Updates	ELS	
2/7/25	Boundary Update	ELS	
2/26/25	City Comments 2/24/2025	ELS	

Allowable Uses:

The Uses allowed as of right under zoning district M-2 shall be permitted within this Preliminary Development Plan including, but not limited to: Utilities and Services, Building Maintenance Services, Business Equipment Sales and Service, Business Support Service, Parking (Accessory), Parking (Non-Accessory), Manufacturing, Production, and Industrial Service including: Artisan, Limited, General, Warehousing, Wholesaling, Storage, and Freight Movement Including: Indoor, Outdoor, Wireless Communication Facility (Freestanding, Co-Located Antenna), Communication Service Establishments, Office, Administrative, Professional, or General, and any and all related accessory uses thereto.

General Notes:


- 1. All buildings and other structures shall be constructed of high quality materials including masonry, concrete, glass, and metal (when used in an incidental role). Specific materials which will be excluded include exposed (i) galvanized metal facades, (ii) nondecorative cinder or concrete block, and (iii) double T concrete panels. Accessory buildings, Compactors, appurtenant structures to, or extrusions from, any building or structure shall be of similar or compatible materials, design and construction.
- 2. All signage will comply with Section 88–445 of the zoning and development code and will be reviewed at time of sign permit.
- 3. All rooftop mechanical equipment will be screened as required by 88–425–08 of the zoning and development code.
 4. Each security gate shall be provided with a siren sensor (Yelp Gate) for Fire Department access.
- 5. Two way emergency radio communication system provided in accordance with NFPA 1221 and IFC Section 5. A minimum inbound/outbound -95db signal strength or as required by the authority having jurisdiction will be provided.
- 6. Proposed address for each facility is to be located in a highly visible and prominent location.
 7. Facility will be secured by guards in two shifts, with overnight internal monitoring and CCTV cameras. Access gates
- to facility will be locked at night.
- 8. A waiver of the right-of-way dedication requirement, in the amount of 17 feet, is requested pursuant to 88.405-02-D.

SITE DATA per APPLICATION SUBMITTAL REQUIREMENTS


a) Existing Zoning: AG-R & M2-3 Proposed Zoning: M2-3


			Lot 1		Lot 2		Lot 3	Tra	ct A	Tra	ct B	Total
	Item	Existing	Proposed	Existing	Proposed	Existing	Proposed	Existing	Proposed	Existing	Proposed	IOLAI
la V	Total Land Area											
b)	(SFT)	449,865	449,865	484,620	484,620	479,403	479,403	256,910	256,910	863,310	863,310	2,534,108
	Total Land Area											
	(AC)	10.33	10.33	11.13	11.13	11.01	11.01	5.90	5.90	19.82	19.82	58.18
	Land Area for											
c)	Street ROW (SFT)	0	0	0	3,894	0	5,724	0	0	0	0	9,618
	Land Area for											
	Street ROW (AC)	0.00	0.00	0.00	0.09	0.00	0.13	0.00	0.00	0.00	0.00	0.22
	Net Land Area											
d)	(SFT)		449,865		480,726		473,679		256,910		863,310	2,524,490
	Net Land Area											
	(AC)		10.33		11.04		10.87		5.90		19.82	57.95
			Communication		Communication		Communication					
	Building Use	AG-R	Service	AG-R	Service	AG-R	Service					
e)			Establishment		Establishment		Establishment					
f)	Building Height							-				
	Above Grade (FT)		44*		44*		44*					
	# of Floors		2		2		2					
	Gross Floor Area											
	per Floor (SFT)		144,515		144,515		144,515					
	Gross Floor Area							-				
	per Lot (SFT)		289,030		289,030		289,030					867,090
	Building											
_	Coverage (SFT)		144,515		144,515		144,515	•				433,545
	Floor Area Ratio		0.642		0.601		0.610					0.343
i)	NA											
		Required	Proposed	Required	Proposed	Required	Proposed					
	Vehicle Parking											
	Spaces	18	27	18	27	18	27					81
	Bicycle Parking											
k)	Spaces	7	7	7	7	7	7					21
	NA											
m)	NA											

* A deviation is requested to allow building heights up to 70 feet on each of the proposed lots.

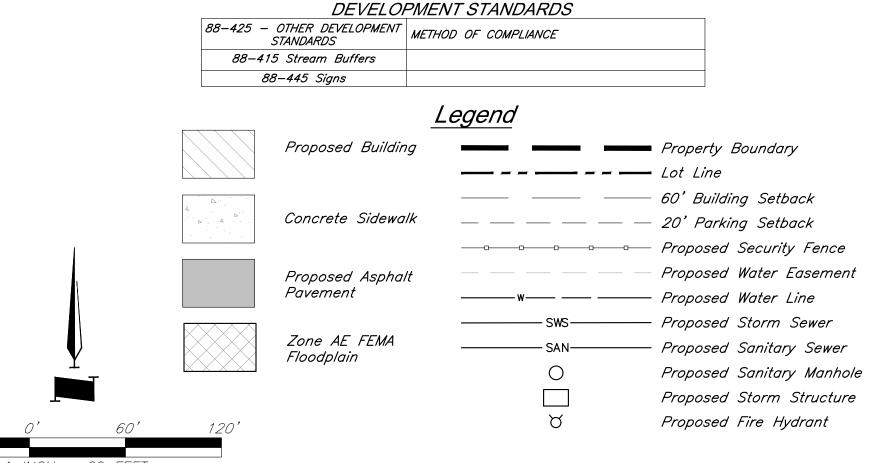

Site Plan

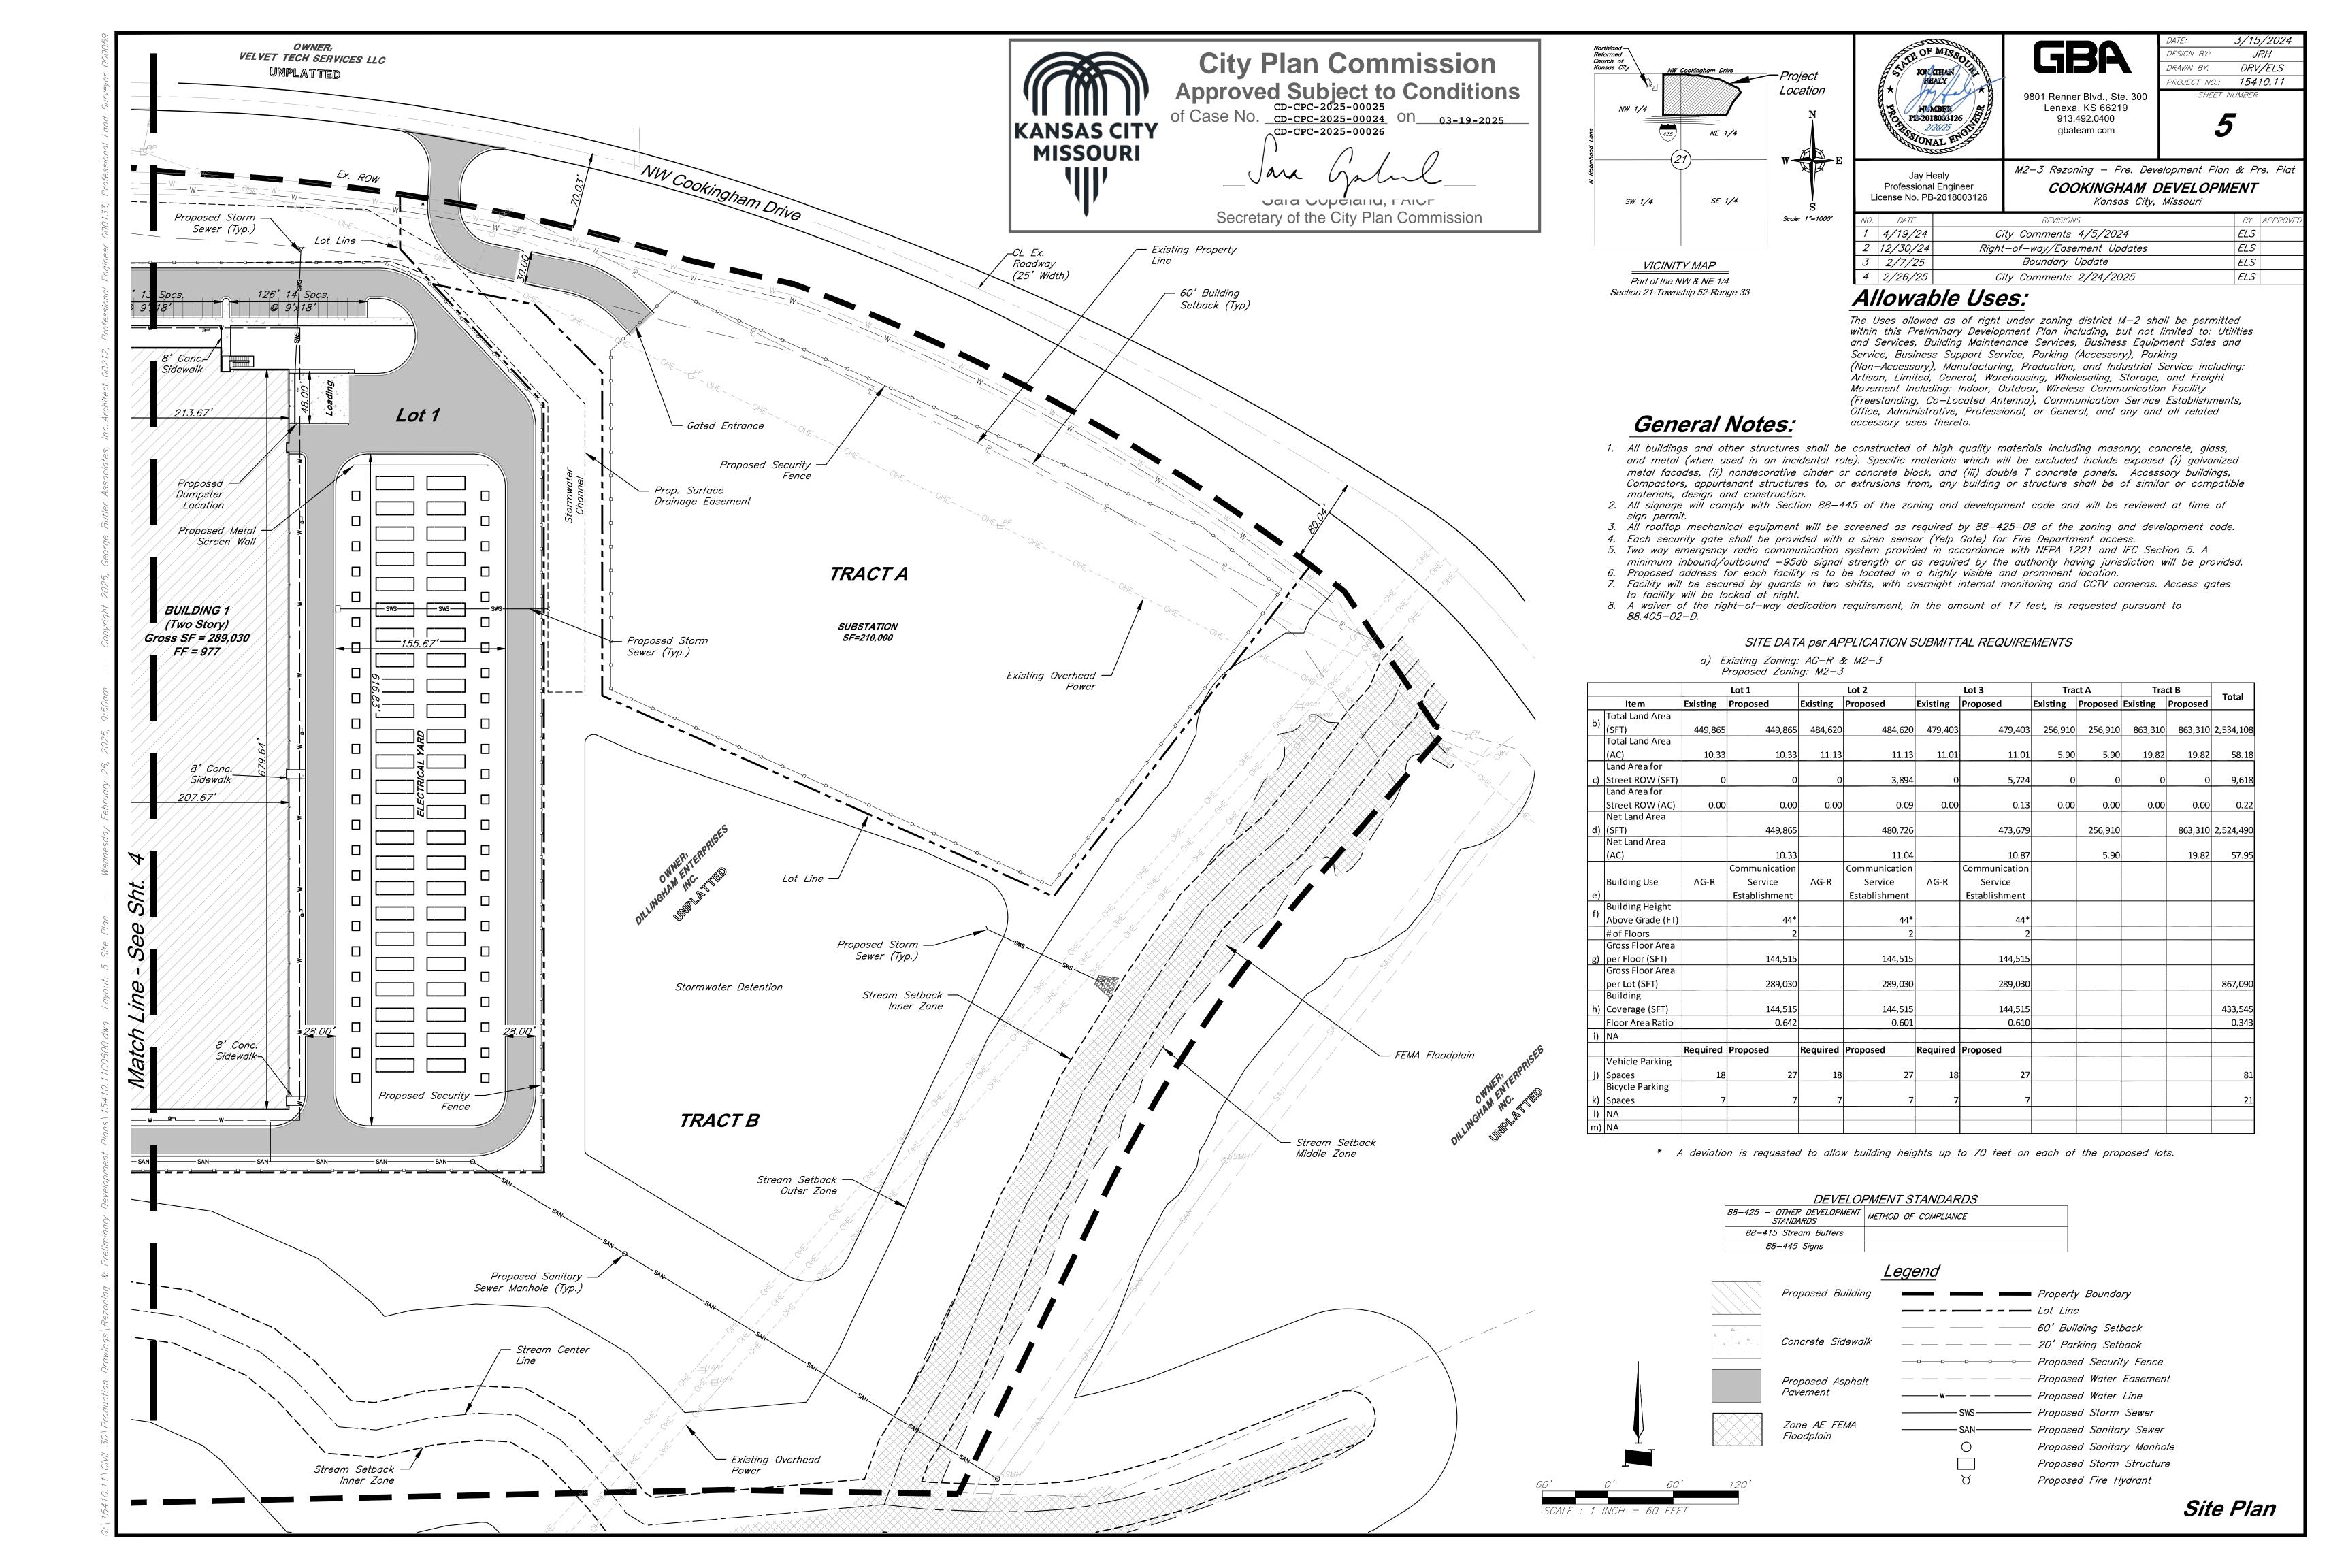

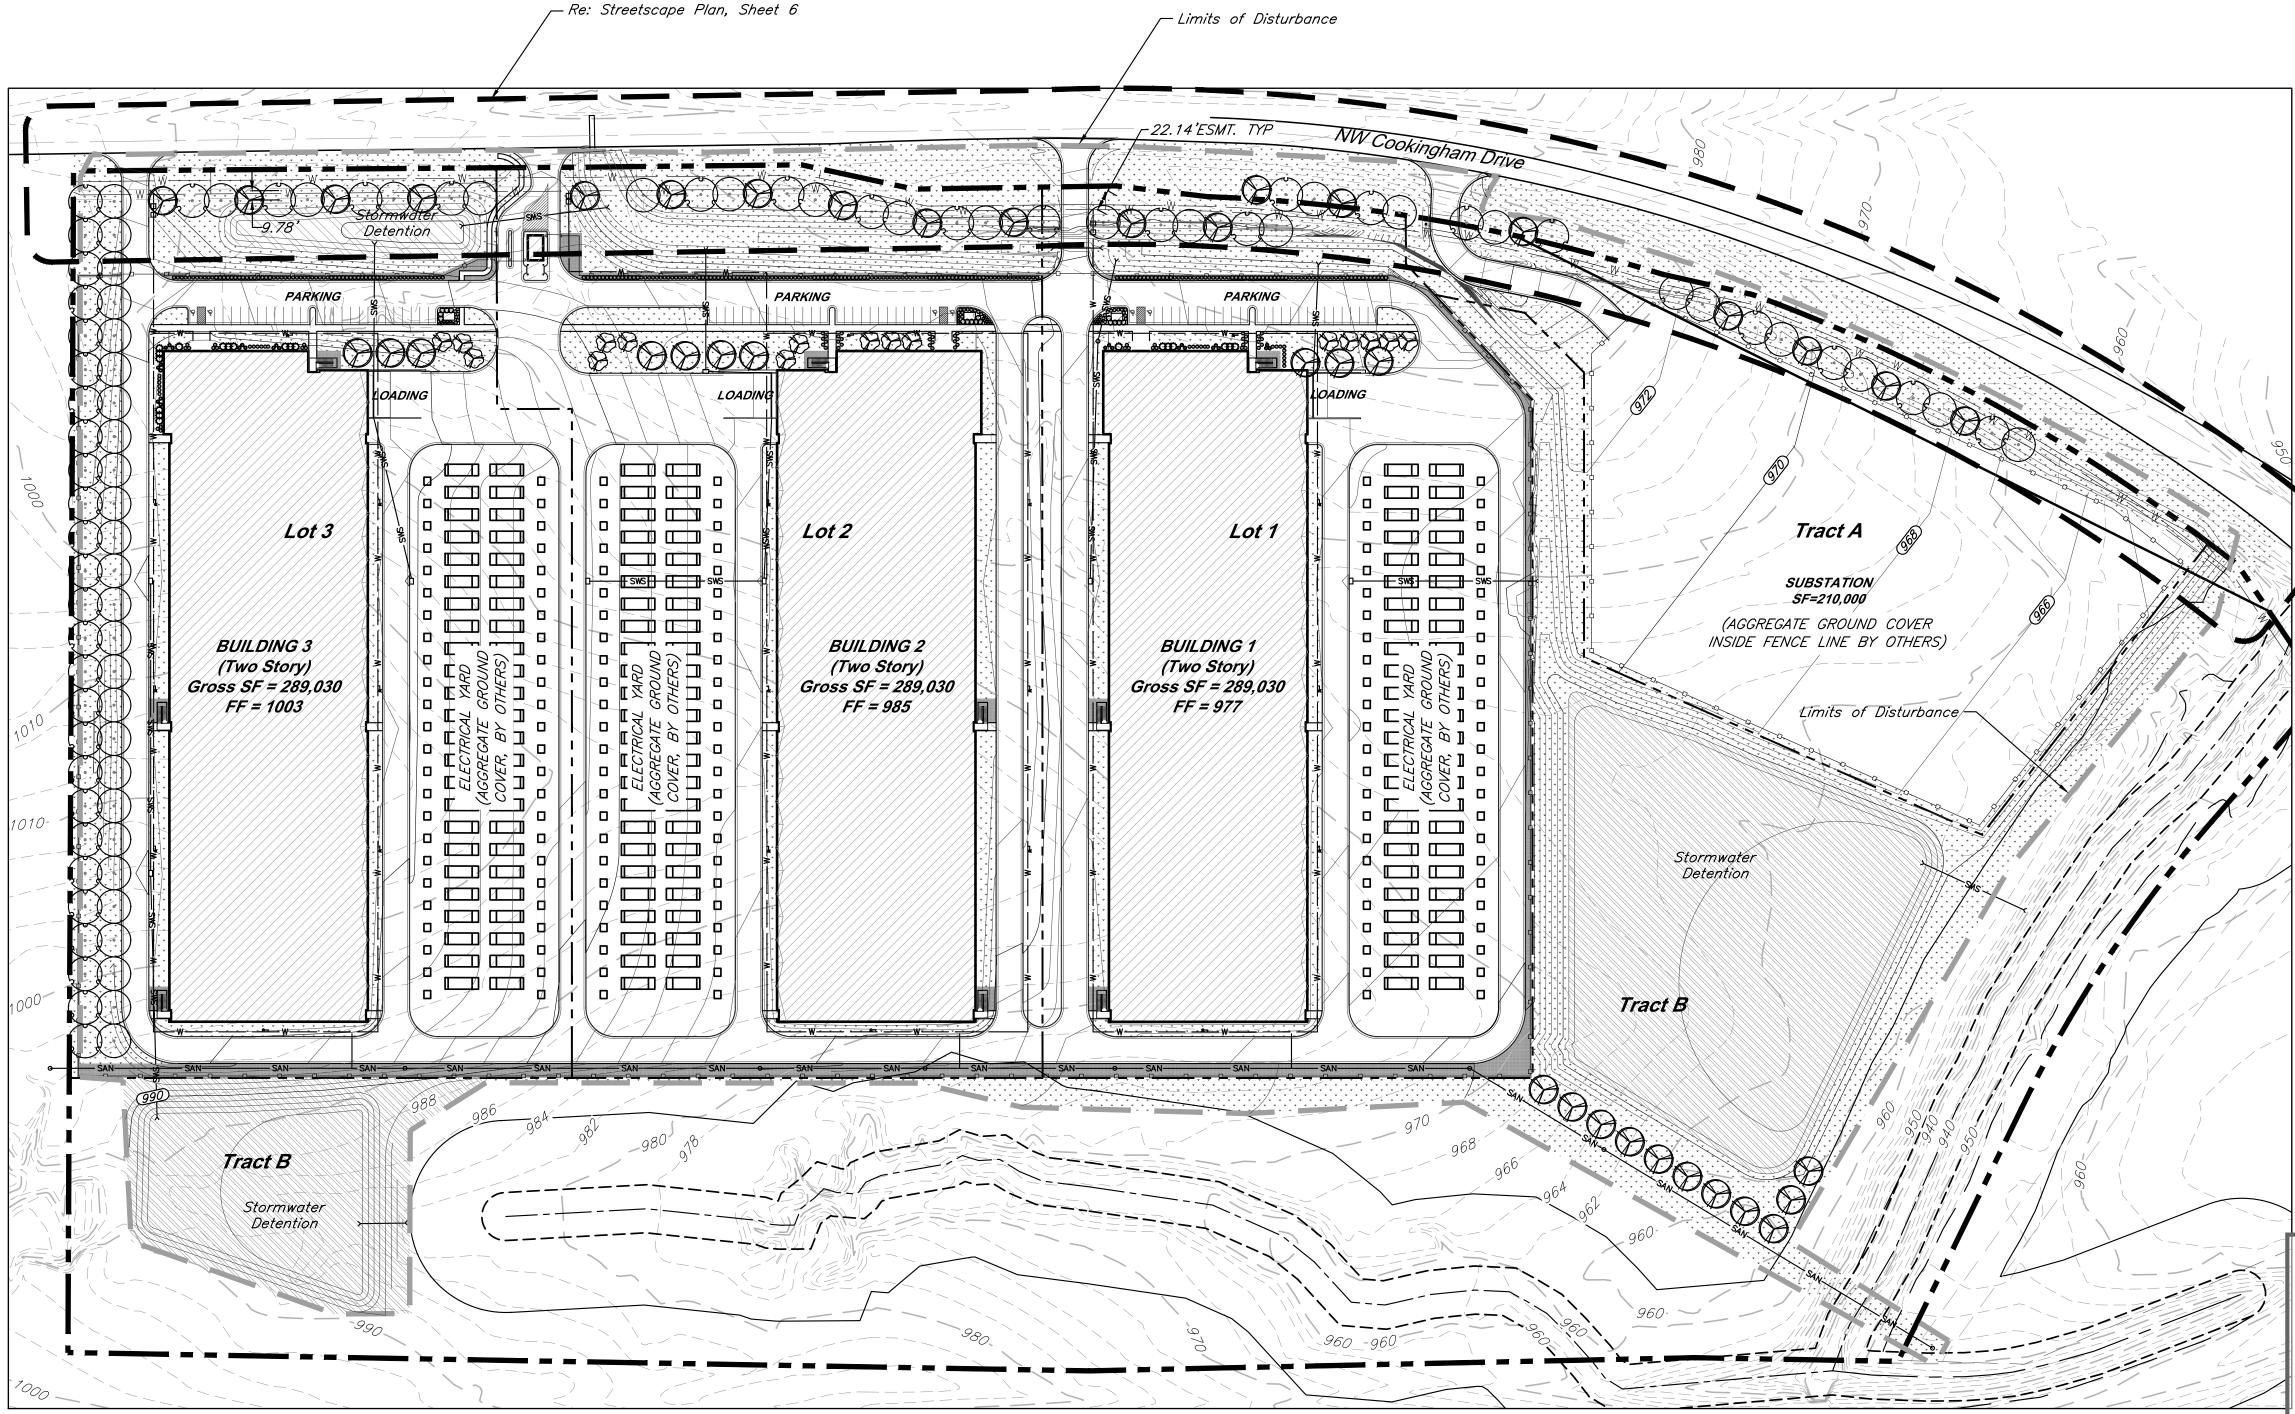

GBA

9801 Renner Blvd., Ste. 300 Lenexa, KS 66219 913.492.0400 gbateam.com

DRV/ELS DRAWN BY: PROJECT NO.: 15410.11

DESIGN BY:

Jay Healy Professional Engineer License No. PB-2018003126 M2-3 Rezoning - Pre. Development Plan & Pre. Plat COOKINGHAM DEVELOPMENT Kansas City, Missouri

NO.	DATE	REVISIONS	BY	<i>APPROV</i>
1	4/19/24	City Comments 4/5/2024	ELS	7 7.1.07
2	12/30/24		ELS	
3	2/7/25	Boundary Update	ELS	
4	2/26/25	City Comments 2/24/2025	ELS	

OVERAL	L PLA	NT SCHEE	DULE
SYMBOL	CODE	QTY	BOTANICAL / COMMON NAME
TREES			
	AS	43	Acer saccharum 'John Pair' / Fall Fiesta Maple
	СО	16	Cercis canadensis texensis 'Oklahoma' / Oklahoma Texas Redbud
\(\cdot \cdot \cdo	PM	48	Platanus x acerifolia 'Morton Circle' / Exclamation Plane Tree
\bigcup	QS	48	Quercus shumardii / Shumard Oak
SHRUBS			
	НК	27	Hypericum kalmianum 'Deppe' / Sunny Boulevard® St. Johnswort
	IS	130	Ilex glabra 'Shamrock' / Shamrock Holly
	JK	16	Juniperus chinensis 'Kallays Compact' / Kallay Juniper
) `` `{	JF	20	Juniperus chinensis 'Sea Green' / Sea Green Juniper
	JA	131	Juniperus x pfitzeriana 'Armstrongii' / Armstrong Pfitzer Juniper
	PV	110	Panicum virgatum 'Shenandoah' / Shenandoah Switch Grass
\bigwedge	VN	32	Viburnum opulus 'Nanum' / Dwarf European Cranberrybush
GROUND CO	OVERS		
	DR	45,320 sf	Decorative Landscape Rock
* * * * * * * * * * * * * * * * * * *	FG	544,345 sf	Festuca var.
	NM	211,375 sf	Native Mix Oval Sedge - Carex brevior Canada Wild Rye - Elymus canadensis Bottlebrush Sedge - Elymus hystx Tussock Sedge



City Plan Commission
Approved Subject to Conditions
of Case No. CD-CPC-2025-00024
CD-CPC-2025-00024
CD-CPC-2025-00026
On 03-19-2025

Tussock Sedge Common Rush

American Sweet Flag

Fox Sedge

Secretary of the City Plan Commission

LANDSCAPE REQUIREMENTS (Kansas City, Missouri)

PUBLIC VIEW

ITEM(S)	REQUIRED	PROVIDED
STREET TREES (88-425-03-C)		
1 TREE PER 30' OF FRONTAGE		
COOKINGHAM DRIVE (2,561 L.F.)	2,561 L.F. / 30 = 85 TREES	67 TREES
PARKING LOT SCREENING (88-425-05-B)		
3' HT. CONT. EVERGREEN HEDGE	3' HT. CONT. EVERGREEN HEDGE AT PARKING	PROVIDED PER PLANS
INTERIOR PARKING LOT LANDSCAPE (88-425-06)		
TOTAL PROPOSED PARKING = 81 SPACES		
35 S.F. LANDSCAPE AREA PER 1 PARKING SPACE	LANDSCAPE AREA REQUIRED = 2,835 S.F.	5,332 S.F.
1 TREE PER 5 PARKING SPACES	TREES REQUIRED = 16	26 TREES
1 SHRUB PER PARKING SPACE	SHRUBS REQUIRED = 81	205 SHRUBS
GENERAL LANDSCAPE (88-425-04)		
1 TREE PER 5,000 S.F. OF BLDG. COVERAGE		
BUILDING COVERAGE = 433,386 S.F.	433,386 S.F. / 5,000 = 86.6 TREES	87 TREES PROVIDED
SCREENING OF MECH, UTIL, TRASH (88-425-08-A)		
DUMPSTERS, CONTAINERS, UTILITIES SCREENED FROM		DUMPSTERS AND TRASH WILL BE CONTAINED


WITHIN BUILDING

INTERIOR PARKING LOT LANDSCAPE SCHEDULE (88-425-06)


130 Ilex glabra 'Shamrock' / Shamrock Holly

131 Juniperus x pfitzeriana 'Armstrongii' / Armstrong Pfitzer Juniper

	. •				
SYMBOL	CODE	QTY	BOTANICAL / COMMON NAME	SIZE	CONTAINER
TREES					
	AS	10	Acer saccharum 'John Pair' / Fall Fiesta Maple	2.5" Cal.	в&в
	СО	16	Cercis canadensis texensis 'Oklahoma' / Oklahoma Texas Redbud	2" Cal.	
SYMBOL	CODE	QTY	BOTANICAL / COMMON NAME		
SHRUBS					
	НК	27	Hypericum kalmianum 'Deppe' / Sunny Boulevard® St. Johnswort		
	JK	16	Juniperus chinensis 'Kallays Compact' / Kallay Juniper		
₹. }	JF	20	Juniperus chinensis 'Sea Green' / Sea Green Juniper		
	PV	110	Panicum virgatum 'Shenandoah' / Shenandoah Switch Grass		
$\overline{\lambda}$	VN	32	Viburnum opulus 'Nanum' / Dwarf European Cranberrybush		
	NC LC	אד כרו	DEENING SCHEDITIE (99 42E OE D)		
PARKI	NG LC) I SCI	REENING SCHEDULE (88-425-05-B)		
SYMBOL	CODE	QTY	BOTANICAL / COMMON NAME		
SHRUBS					

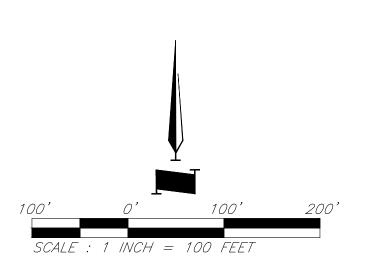

Landscape Plan

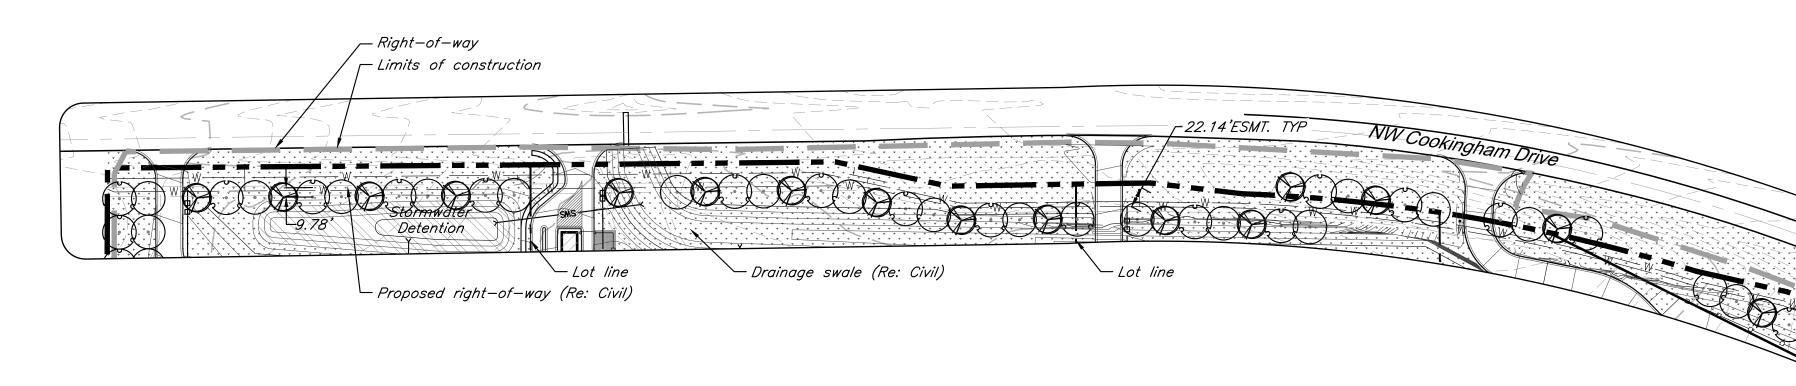

9801 Renner Blvd., Ste. 300 Lenexa, KS 66219 913.492.0400 gbateam.com

DRAWN BY: DRV/ELS PROJECT NO.: 15410.11

Jay Healy Professional Engineer License No. PB-2018003126

M2-3 Rezoning - Pre. Development Plan & Pre. Plat COOKINGHAM DEVELOPMENT Kansas City, Missouri

DESIGN BY:

NO.	DATE	REVISIONS	BY	APPROVE
1	4/19/24	City Comments 4/5/2024	ELS	
2	12/30/24	Right-of-way/Easement Updates	ELS	
3	2/7/25	Boundary Update	ELS	
4	2/26/25	City Comments 2/24/2025	ELS	

LANDSCAPE REQUIREMENTS (KCMO)

ITEM(S)	REQUIRED	PROVIDED	
STREET TREES (88-425-03-C)			
1 TREE PER 30' OF FRONTAGE			
COOKINGHAM DRIVE (2,561 L.F.)	2,561 L.F. / 30 = 85 TREES	67 TREES	

PLANT SCHEDULE STREETSCAPE


YMBOL	CODE	<u>QTY</u>	BOTANICAL / COMMON NAME	SIZE	CONTAINER
REES	AS	22	Acer saccharum 'John Pair' / Fall Fiesta Maple	2.5" Cal.	B&B
	PM	24	Platanus x acerifolia 'Morton Circle' / Exclamation Plane Tree	2.5" Cal.	B&B
$\overline{\bigcirc}$	QS	24	Quercus shumardii / Shumard Oak	2.5" Cal.	B&B



Fence (Re: Civil)

City Plan Commission
Approved Subject to Conditions
of Case No. CD-CPC-2025-00024
CD-CPC-2025-00024
CD-CPC-2025-00026
On 03-19-2025

Jaia Juptianu, FAICE Secretary of the City Plan Commission

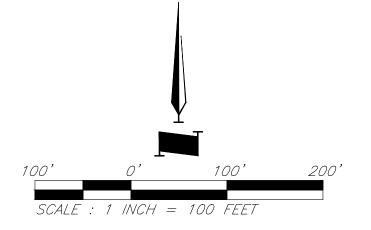

LANDSCAPE NOTES:

PLANTING BED INSTALLATION NOTES:

SUBSTANCE 2" OR MORE IN DIAMETER.

TABLETS PER 5-GALLON CONTAINER.

ROCK APPLICATION.

- 1. FIELD VERIFY UTILITIES SHOWN ON PLANS PRIOR TO WORK COMMENCEMENT. INFORMATION SHOWN ON PLAN IS FROM AVAILABLE INFORMATION AND ALL LOCATIONS SHOWN SHOULD BE CONSIDERED APPROXIMATE. THE CONTRACTOR AGREES TO BE FULLY RESPONSIBLE FOR ANY AND ALL DAMAGE TO UTILITIES MADE FROM CONSTRUCTION ACTIVITY. IMMEDIATELY NOTIFY PROJECT LANDSCAPE ARCHITECT AND ENGINEER IF DISCREPANCIES ARISE.
- 2. COMPLETE REQUIRED LANDSCAPING FOR THE ENTIRE SITE IN CONFORMANCE TO THE PLANS AND SPECIFICATIONS, INCLUDING BUT NOT LIMITED TO: SEEDED AREAS, SODDED AREAS, SHRUB BEDS, AND SITE CLEAN-UP.
- 3. VERIFY QUANTITIES PRIOR TO COMMENCING WORK. REPORT DISCREPANCIES TO THE LANDSCAPE ARCHITECT. PLANT MATERIAL TO BE SPACED AS SHOWN, UNLESS OTHERWISE NOTED.
- 4. PLANT MATERIAL SHALL COMPLY WITH ALL SIZING AND GRADING STANDARDS OF LATEST EDITION OF AMERICAN STANDARD FOR NUSERY STOCK (A.S.N.S.) LATEST EDITION PUBLISHED BY (ANLA) ANSI 260.1. THIS IS A REPRESENTATIVE GUIDELINE SPECIFICATION ONLY AND WILL CONSTITUTE MINIMUM QUALITY REQUIREMENTS FOR THE PLANT MATERIAL.
- 5. THE OWNER RESERVES THE RIGHT TO SUBSTITUTE PLANT MATERIAL, TYPE, SIZE AND/OR QUANTITY. LARGER SIZED PLANT MATERIALS OF THE SPECIES LISTED MAY BE USED IF THE STOCK CONFORMS TO A.S.N.S. VEGETATION SUBSTITUTIONS SHALL BE APPROVED BY PROJECT LANDSCAPE ARCHITECT. SUBSTITUTIONS MADE WITHOUT WRITTEN APPROVAL WILL BE REPLACED WITH APPROVED SELECTIONS AT CONTRACTOR'S COST.
- 6. DISTURBED AREAS DUE TO CONSTRUCTION ACTIVITIES NOT IDENTIFIED ON THESE PLANS SHALL BE REPAIRED AND RESTORED TO ORIGINAL OR BETTER CONDITIONS AT CONTRACTOR'S COST. SOD WITH A TURF-TYPE TALL FESCUE BLEND SHALL BE PROVIDED FOR AREAS NOT DESIGNATED AS BEDS & PAVEMENT.
- 7. CONTRACTOR SHALL COMPLY WITH APPLICABLE CODES AND ORDINANCES REGARDING LANDSCAPING. REFER TO SPECIFICATIONS FOR PLANT MATERIAL, SOILS, AND INSTALLATION METHODS.
- 8. INSTALL PLANT MATERIAL IN ACCORDANCE WITH A.S.N.S. STANDARDS.

1. ALL PLANTATION BEDS SHALL BE AMENDED WITH 1 CUBIC YARD OF COTTON

6" DEPTH. A 10-10-10 FERTILIZER SHALL BE SPREAD OVER ALL PLANTING AREAS PRIOR TO PLANTING, AT A RATE OF 50 POUNDS PER 2000 SQ. FT.

2. AFTER PLANTING HAVE BEEN INSTALLED, ALL PLANTING BEDS SHALL BE

3. PLANT PIT BACKFILL FOR SHRUBS SHALL BE 25% COTTON BOLL COMPOST

GROWTH. ALSO, FREE OF CLAY LUMPS, STONES, STUMPS, ROOTS OR

4. PLANTING TABLETS: INSTALL MANUFACTURER GRO-POWER, INC, PRODUCT:

GROWPOWER TABLETS, SIZE: 7-GRAM TABLETS, RATE: 1 TABLETS PER

1-GALLON CONTAINER AND 4 TABLETS PER 3-GALLON CONTAINER AND 7

5. PLANTED BED EDGES SHALL BE IN STRAIGHT LINES OR GENTLE FOLLOWING

ROOT BALL (CONTAINER

INSTALLATION

GROWN) REMOVE ENTIRE **CONTAINER BEFORE**

- DECIDUOUS SHRUB, PRUNE

BRANCHES AS NECESSARY

- BALL AND BURLAP, CUT ALL

DEAD OR DAMAGED

- PLANT ROOT COLLAR 1"

CORDS AND REMOVE

- 3" DEPTH HARDWOOD MULCH, AS SPECIFIED

- PLANTING SOIL MIX, AS

OF PLANTING PIT

UNDISTURBED SOIL

SPECIFIED

SCARIFY SIDES AND BOTTOM

COVERING FROM PLANT BEFORE INSTALLING

ABOVE GRADE

CURVES. SUDDEN CURVES OR SHARP ANGLE SHOULD BE AVOIDED.

FERTILE, FRIABLE SOIL POSSESSING CHARACTERISTICS OF

BOLL COMPOST PER 1000 SQUARE FEET. FILL COTTON BOLL INTO SOIL TO A

TREATED WITH DACTHAL PRE-EMERGENT HERBICIDE PRIOR TO MULCH OR

AND 25% TOP SOIL AND 50% EXISTING SOIL. TOP SOIL SHALL BE NATURAL

REPRESENTATIVE PRODUCTIVE SOILS IN THE AREAS. SOIL SHALL NOT BE

EXCESSIVELY ACID, ALKALINE OR TOXIC THAT MAY BE HARMFUL TO PLANT

- 9. INSTALL FINISHED GRADES OF SOD, LANDSCAPE BEDS, AND MULCH 1" BELOW ABUTTING PAVEMENT SURFACES TO ALLOW UNINHIBITED DRAINAGE TO NON-PAVEMENT SURFACES.
- 10. REMOVE ALL TWINE, WIRE, AND BURLAP FROM TREE AND SHRUB ROOT BALLS. REMOVE ALL PLASTIC WRAP, FABRIC ROPE, ROT PROOF WRAP, AND PLANT IDENTIFICATION TAGS.
- 11. TREES SHALL NOT BE PLANTED CLOSER THAN EIGHT HORIZONTAL FEET OF UNDERGROUND UTILITIES UNLESS OTHERWISE NOTED OR PER PLANS. MODIFICATIONS TO TREE PLACEMENT SHALL BE COORDINATED WITH THE LANDSCAPE ARCHITECT AND CAN BE SUBJECT TO CITY REVIEW AND APPROVAL. CONTRACTOR IS RESPONSIBLE FOR UNAPPROVED RELOCATION(S) OR MODIFICATION(S) TO TREE LOCATIONS.
- 12. PROVIDE NATURAL TOPSOIL THAT IS FERTILE, FRIABLE, WITHOUT MIXTURE OF SUBSOIL MATERIALS, AND OBTAINED FROM A WELL DRAINED, AVAILABLE SITE. IT SHALL NOT CONTAIN SUBSTANCES WHICH MAY BE HARMFUL TO PLANT GROWTH. TOPSOIL SHALL BE SCREENED AND FREE FROM CLAY, LUMPS, STONES, ROOTS, PLANTS, OR SIMILAR SUBSTANCES 1" OR MORE IN DIAMETER, DEBRIS, OR OTHER OBJECTS WHICH MIGHT BE A HINDRANCE TO PLANTING OPERATIONS. TOPSOIL SHALL CONTAIN AT LEAST 4-6% ORGANIC MATTER BY WEIGHT AND HAVE A PH RANGE OF 5.5 TO 7.0.

- 13. PLANT MATERIAL TO BE GUARANTEED FOR ONE (1) YEAR FROM THE DATE OF SUBSTANTIAL COMPLETION AND ACCEPTANCE. PLANT MATERIALS SHALL BE A ONE-TIME-REPLACEMENT AND RECORDS KEPT BY THE LANDSCAPE CONTRACTOR FOR ALL REPLACEMENTS.
- 14. PLANT MATERIAL SHALL BE OF EXCELLENT QUALITY, FREE OF DISEASE & INFESTATION-TRUE TO TYPE, VARIETY, SIZE SPECIFIED, & FORM PER ANSI STANDARDS.
- 15. WATER-IN EACH PLANT IMMEDIATELY FOLLOWING INSTALLATION AND CONTINUE WATERING ROUTINE UNTIL SUBSTANTIAL PROJECT COMPLETION. CONTRACTOR IS REQUIRED TO COORDINATE WATERING REQUIREMENTS TO THE OWNER THEREAFTER.
- 16. ALL WORK SHALL BE COORDINATED WITH THE WORK OF OTHER TRADES.
- 17. THE OWNER'S REPRESENTATIVE RESERVES THE RIGHT TO REJECT ANY PLANT MATERIAL NOT CONFORMING TO THE SPECIFICATIONS.
- 18. THE LANDSCAPE CONTRACTOR SHALL TEST PROPOSED PLANTING AREAS FOR SOIL NUTRIENT DEFICIENCIES AND UNDESIRABLE SOIL TEXTURE AND STRUCTURE. BASED ON THE RESULTS OF THIS TESTING, THE LANDSCAPE CONTRACTOR SHALL PROVIDE AND INCORPORATE SOIL CONDITIONING MATERIALS (IE: FERTILIZER, SAND, COMPOST, ETC.) AS NECESSARY TO DEVELOP A PLANT GROWTH MEDIUM OF ADEQUATE FERTILITY, STRUCTURE, AND TEXTURE FOR THE ESTABLISHMENT OF LANDSCAPE MATERIALS. PEAT IS NOT ACCEPTABLE.
- 19. THE LANDSCAPE CONTRACTOR SHALL REMOVE FROM THE SITE ALL ROCK GREATER THAN 1-INCH AND ALL DEBRIS IN THE AREAS OF PROPOSED NEW PLANTINGS.
- 15.DAMAGED TURF AREAS ADJACENT TO PLANTING AREAS SHALL BE RESTORED AND SODDED TO MATCH EXISTING ADJACENT TOPOGRAPHY AND TURF TYPE.

TREE PLANTING:	MARCH 15 - JUNE 15	OR	SEPTEMBER 15 - DECEMBER 31
SHRUB PLANTING:	APRIL 15 - JUNE 15	OR	AUGUST 15 - OCTOBER 15
SOD/SEED PLANTING:	MARCH 15 - JUNE 15	OR	SEPTEMBER 15 - DECEMBER 1

17. ALL PLANTING METHODS SHALL COMPLY WITH CITY OF KANSAS CITY, MO STANDARDS.

BALLS SHALL BE REJECTED

1) EXCAVATE A PIT WHICH IS AT LEAST TWICE THE DIAMETER OF THE ROOTBALL AND THE SAME DEPTH-NO DEEPER. HANDLE THE TREE BY THE ROOT BALL. NOT THE TRUCK, BE SURE THE ROOT BALL RESTS ON SOLID 2) BACKFILL WITH PLANTING SOIL

3) SATURATE THE ENTIRE BACKFILL SOIL WITH WATER. ADD MORE SOIL IF NEEDED TO COMPENSATE FOR

4) MULCH: COVER SMOOTHED SOIL WITH 2 INCHES OF MULCH. LEAVE GAP NEAR THE TRUCK. KEEP MULCH WEEDED. REPLACE AS NEEDED. 5) PRUNE ONLY BROKEN OR BADLY DEFORMED BRANCHES TO RETAIN SHAPE OF THE SPECIES. PRUNE OUT


SECONDARY AND COMPETING GROWTH. DO NOT SHEAR. DO NOT CUT LEADER. BEGIN A REGULAR PRUNING PROGRAM THE SECOND YEAR AFTER PLANTING. 6) CHAFING GUARDS: REMOVE GUARDS AS SOON AS THE TREE CAN STAND ALONE ABOUT 3 MONTHS OR


LONGER IF NEEDED. 7) DO NOT ALLOW AIR POCKETS TO FORM WHEN BACKFILLING. 8) DO NOT DISTURB ROOT BALL WHEN PLANTING OR STAKING. CRACKED OR OTHERWISE DAMAGED ROOT

9) WATER THOROUGHLY FOLLOWING PLANTING. 10) REMOVE EXCESS DEBRIS FORM AROUND ROOT COLLAR/FLARE IS LEVEL OR SLIGHTLY ABOVE (1" MAX) ADJACENT UPHILL GRADE.


11) SCARIFY EDGES OF EXCAVATION WHERE SMOOTHED DURING EXCAVATION.

12) ALL PLANTING METHODS SHALL COMPLY WITH CITY OF BRANSON STANDARDS.

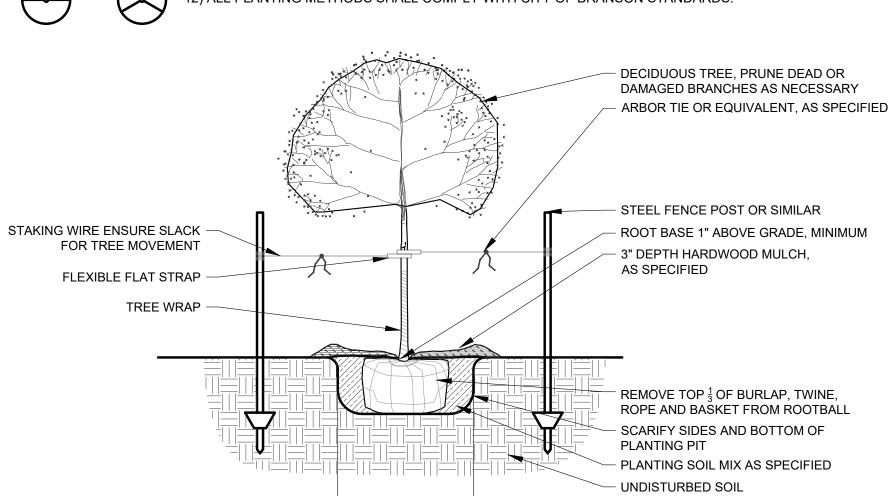

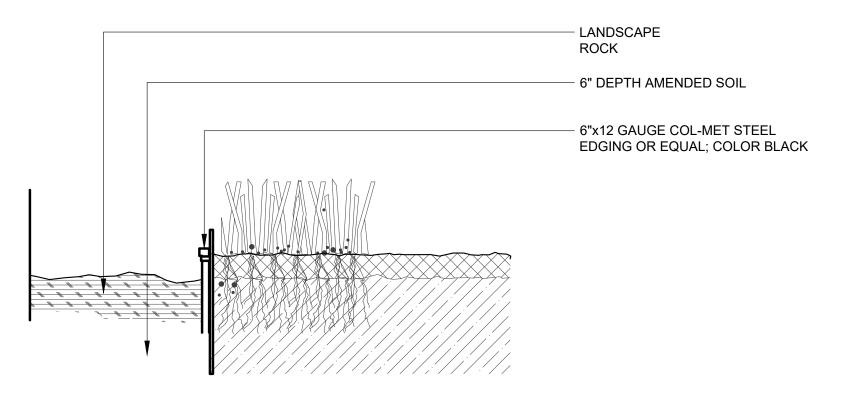

9801 Renner Blvd., Ste. 300 Lenexa, KS 66219 913.492.0400 gbateam.com

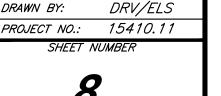

3/15/2024

Jay Healy Professional Engineer License No. PB-2018003126 M2-3 Rezoning - Pre. Development Plan & Pre. Plat COOKINGHAM DEVELOPMENT Kansas City, Missouri

DESIGN BY:

0.	DATE	REVISIONS	BY	APPROVED
,	4/19/24	City Comments 4/5/2024	ELS	
?	12/30/24	Right-of-way/Easement Updates	ELS	
3	2/7/25	Boundary Update	ELS	
1	2/26/25	City Comments 2/24/2025	ELS	



City Plan Commission Approved Subject to Conditions

CD-CPC-2025-00025

of Case No. <u>CD-CPC-2025-00024</u> On <u>03-19-2025</u> CD-CPC-2025-00026

> Jaia Cuptialiu, FAICF Secretary of the City Plan Commission

SHRUB AND PERENNIAL PLANTING


329333.01-04


1/2" = 1'-0"


DECIDUOUS TREE PLANTING


329343.01-03


Planting Details

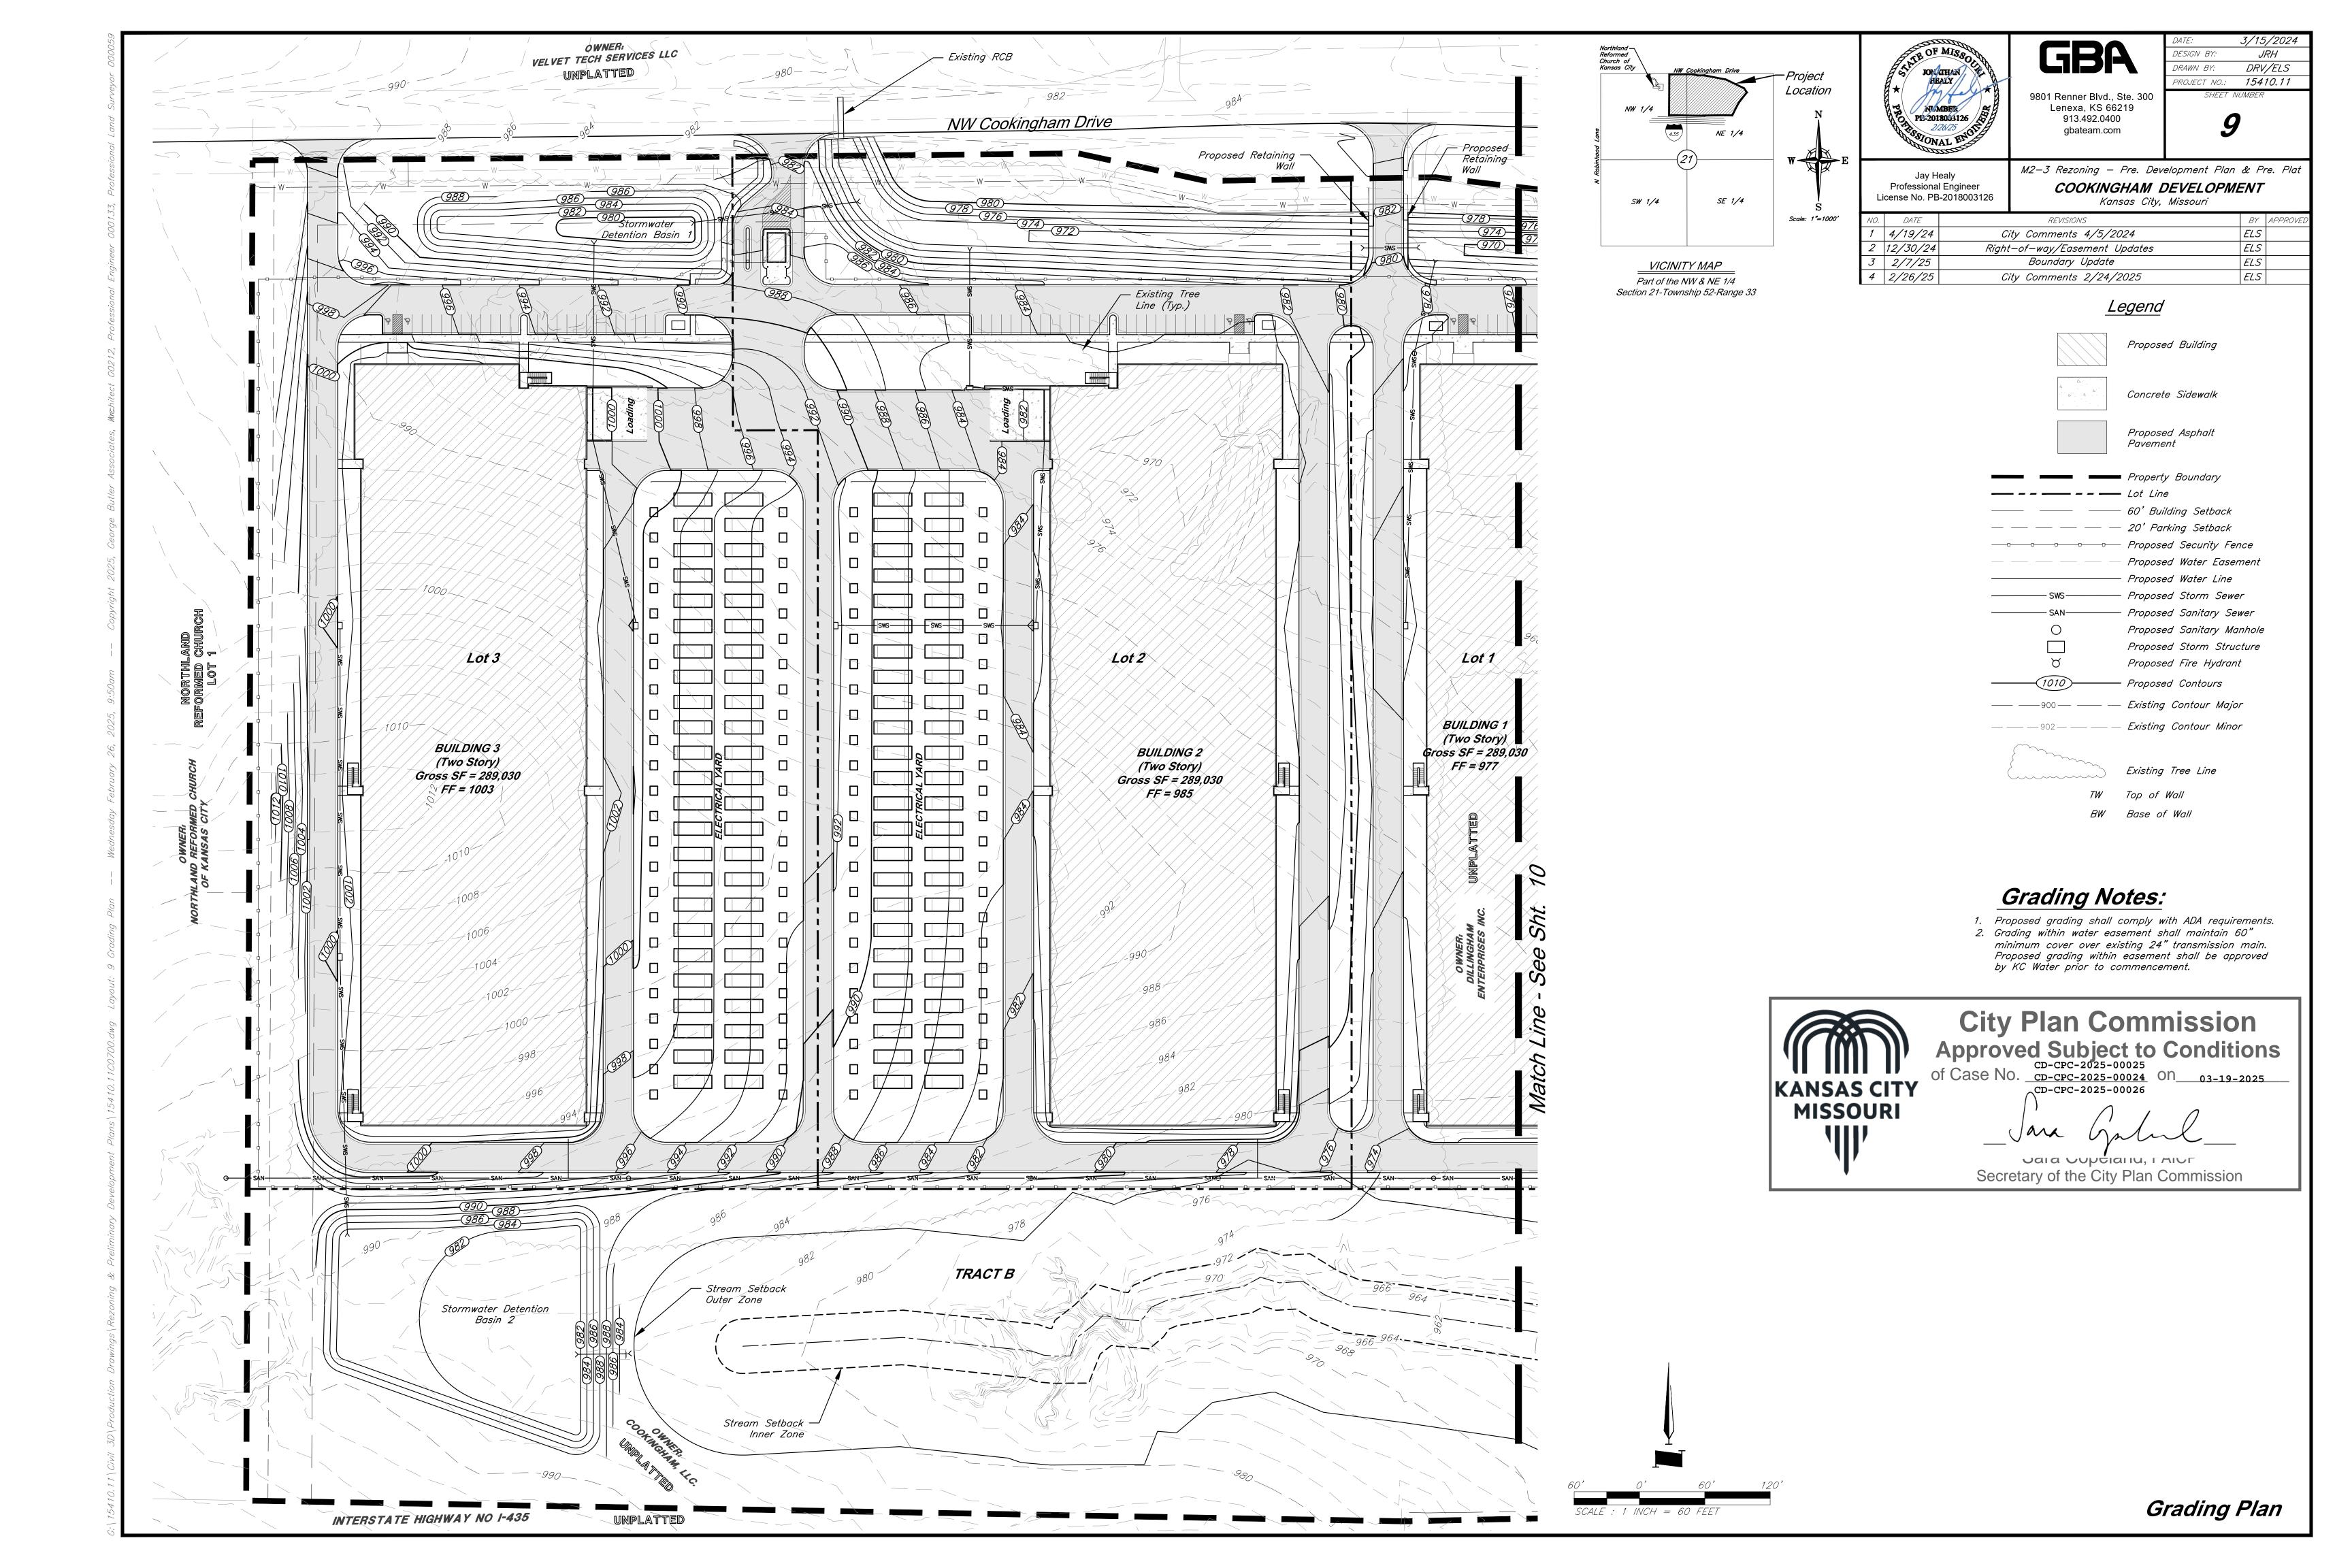


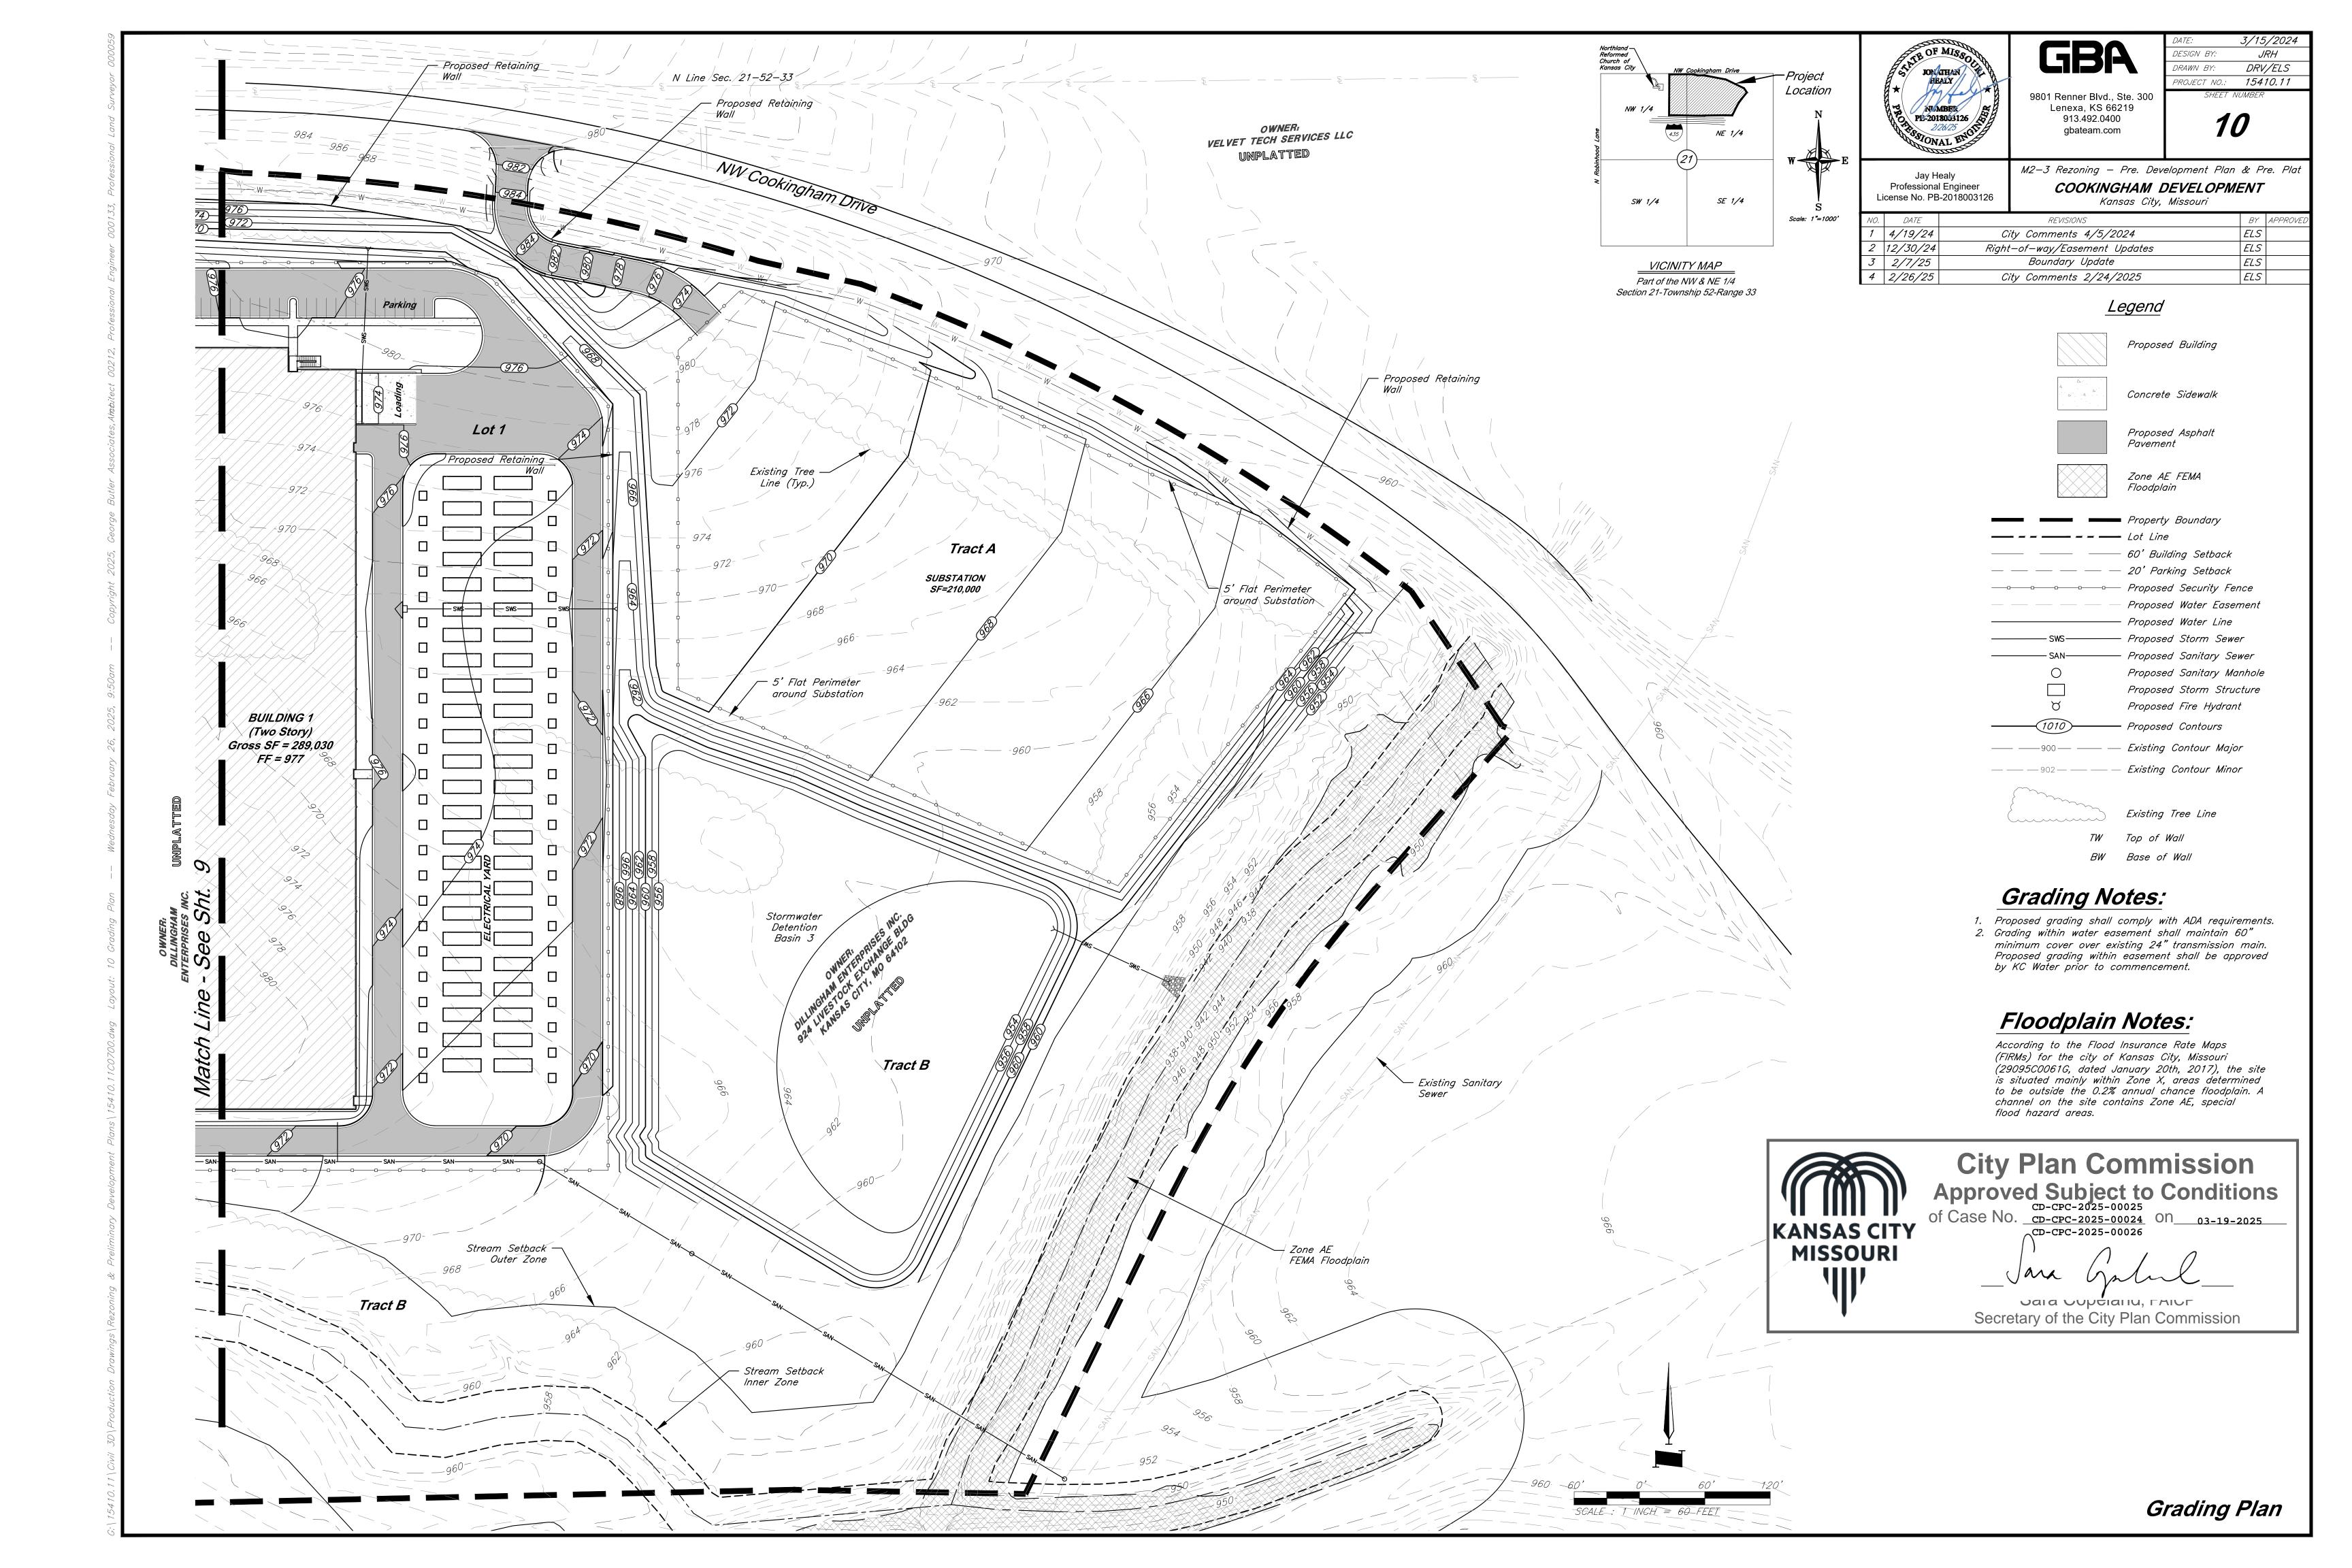

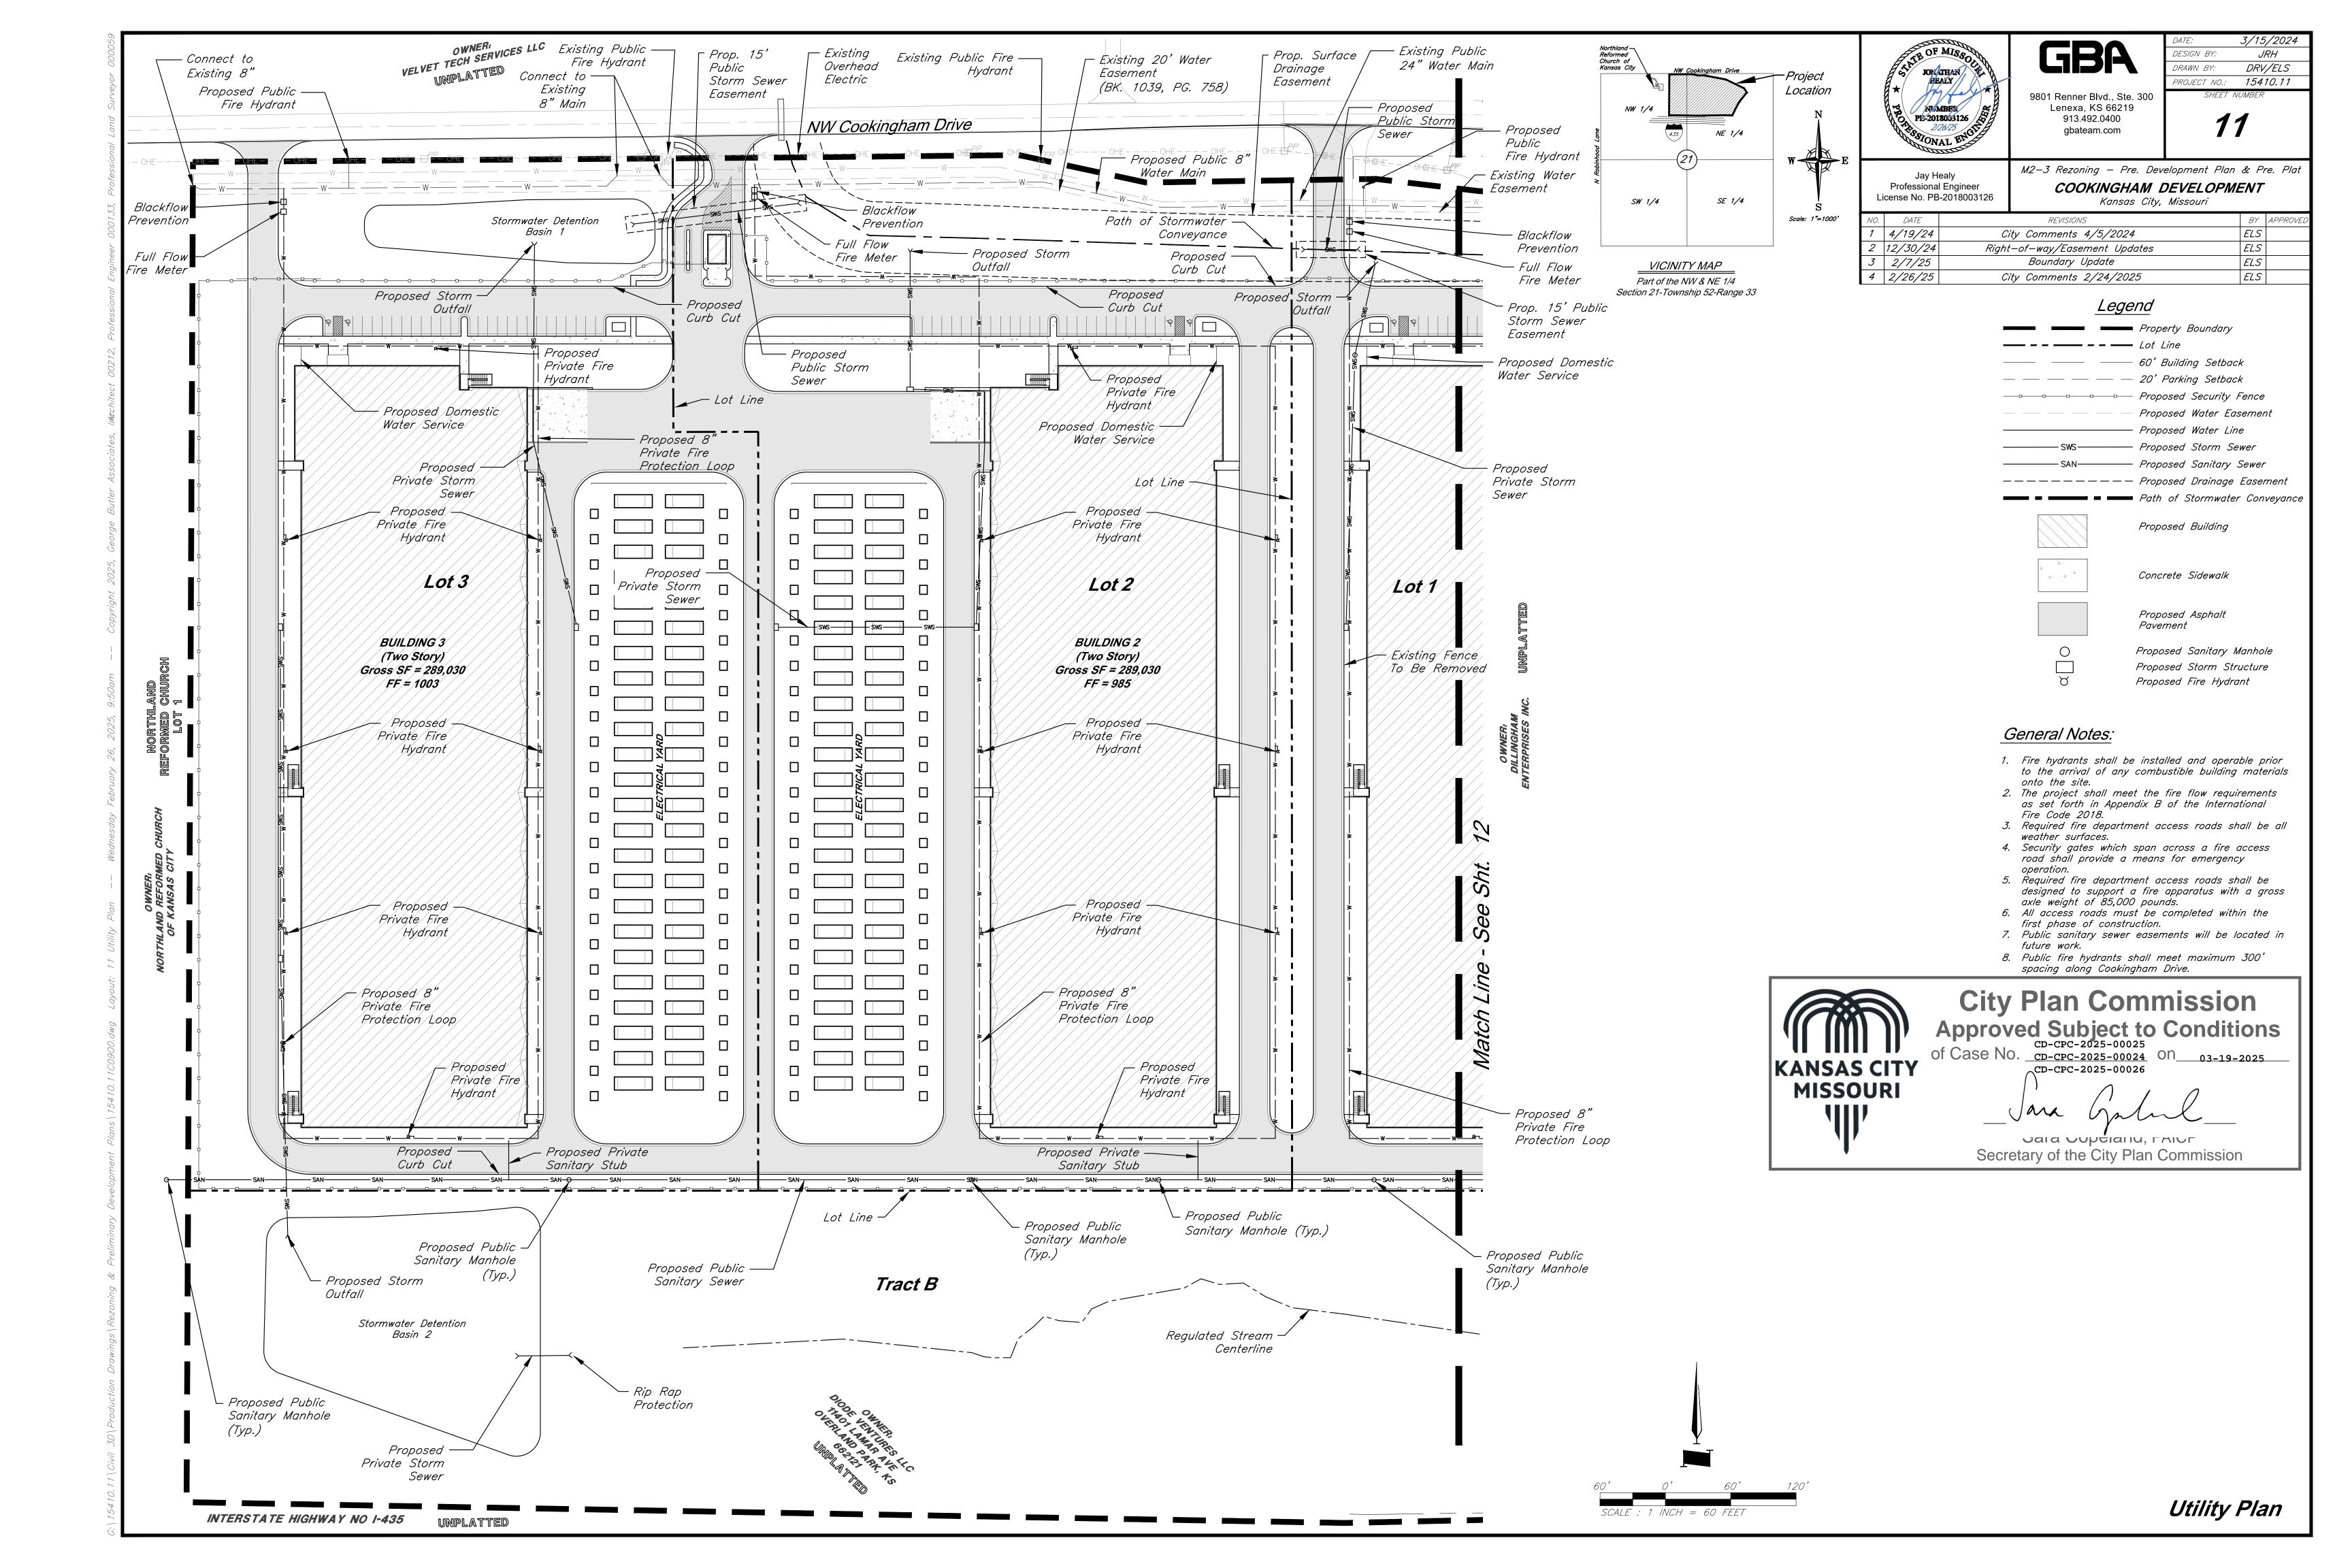

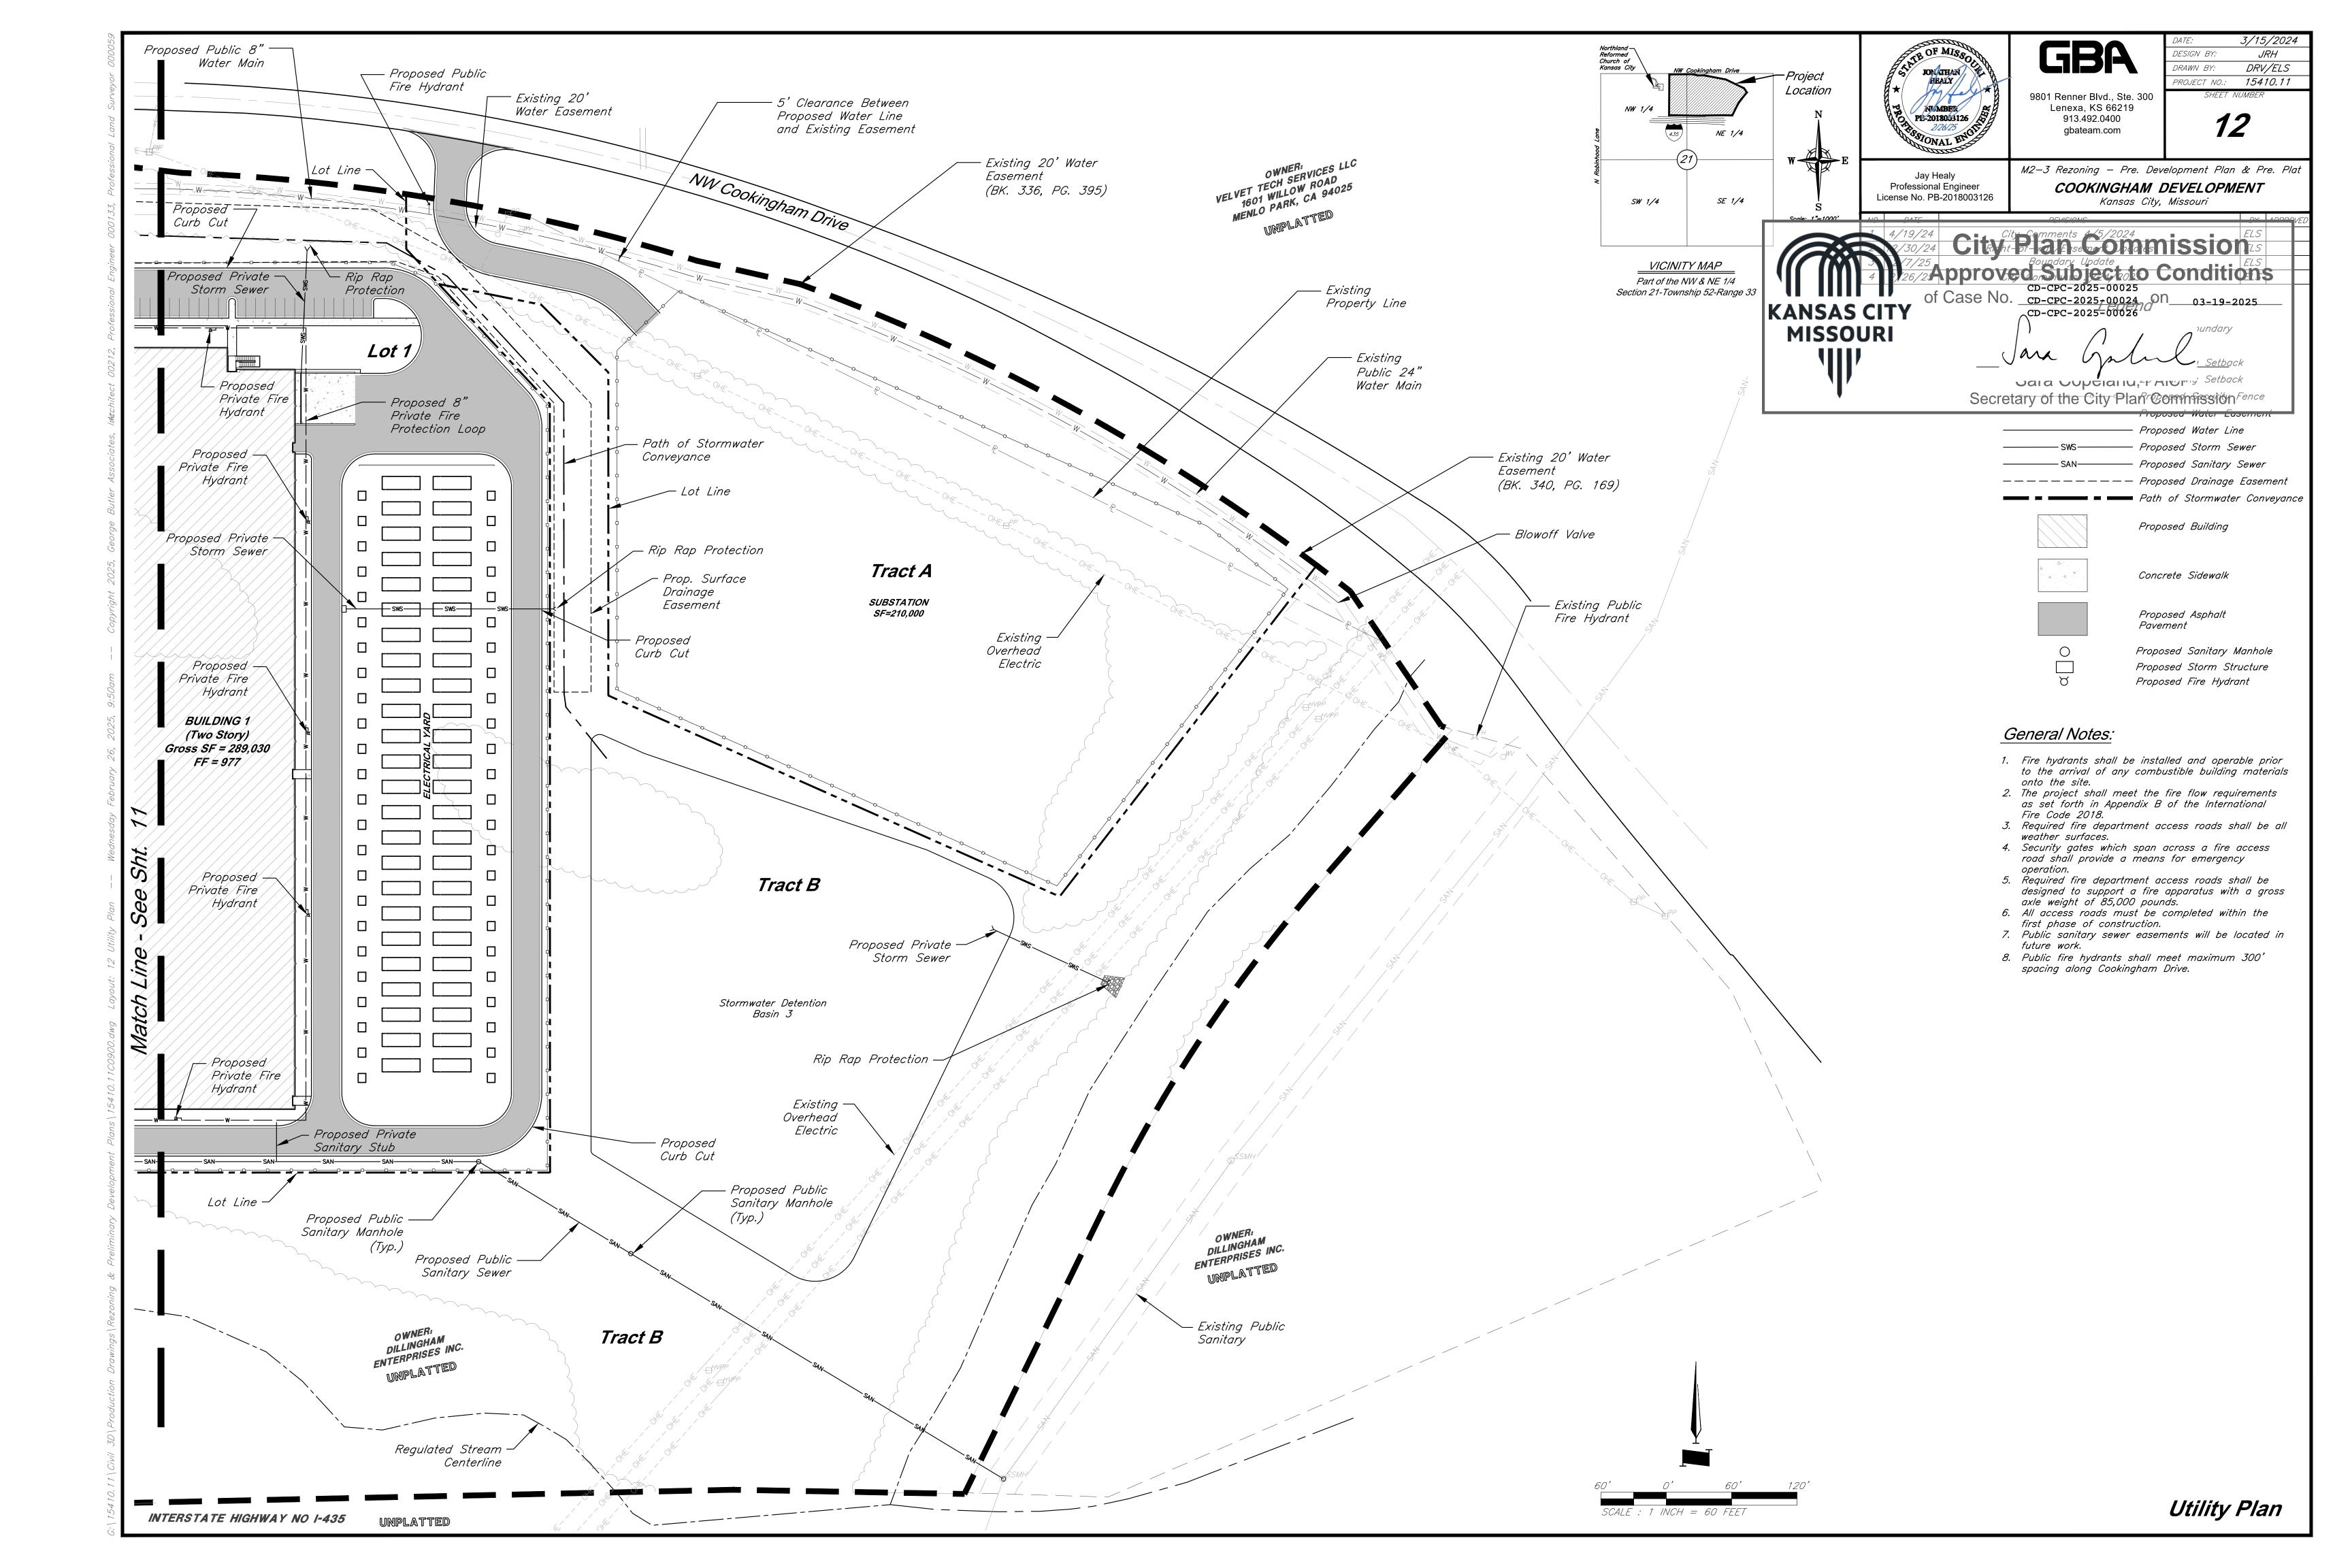

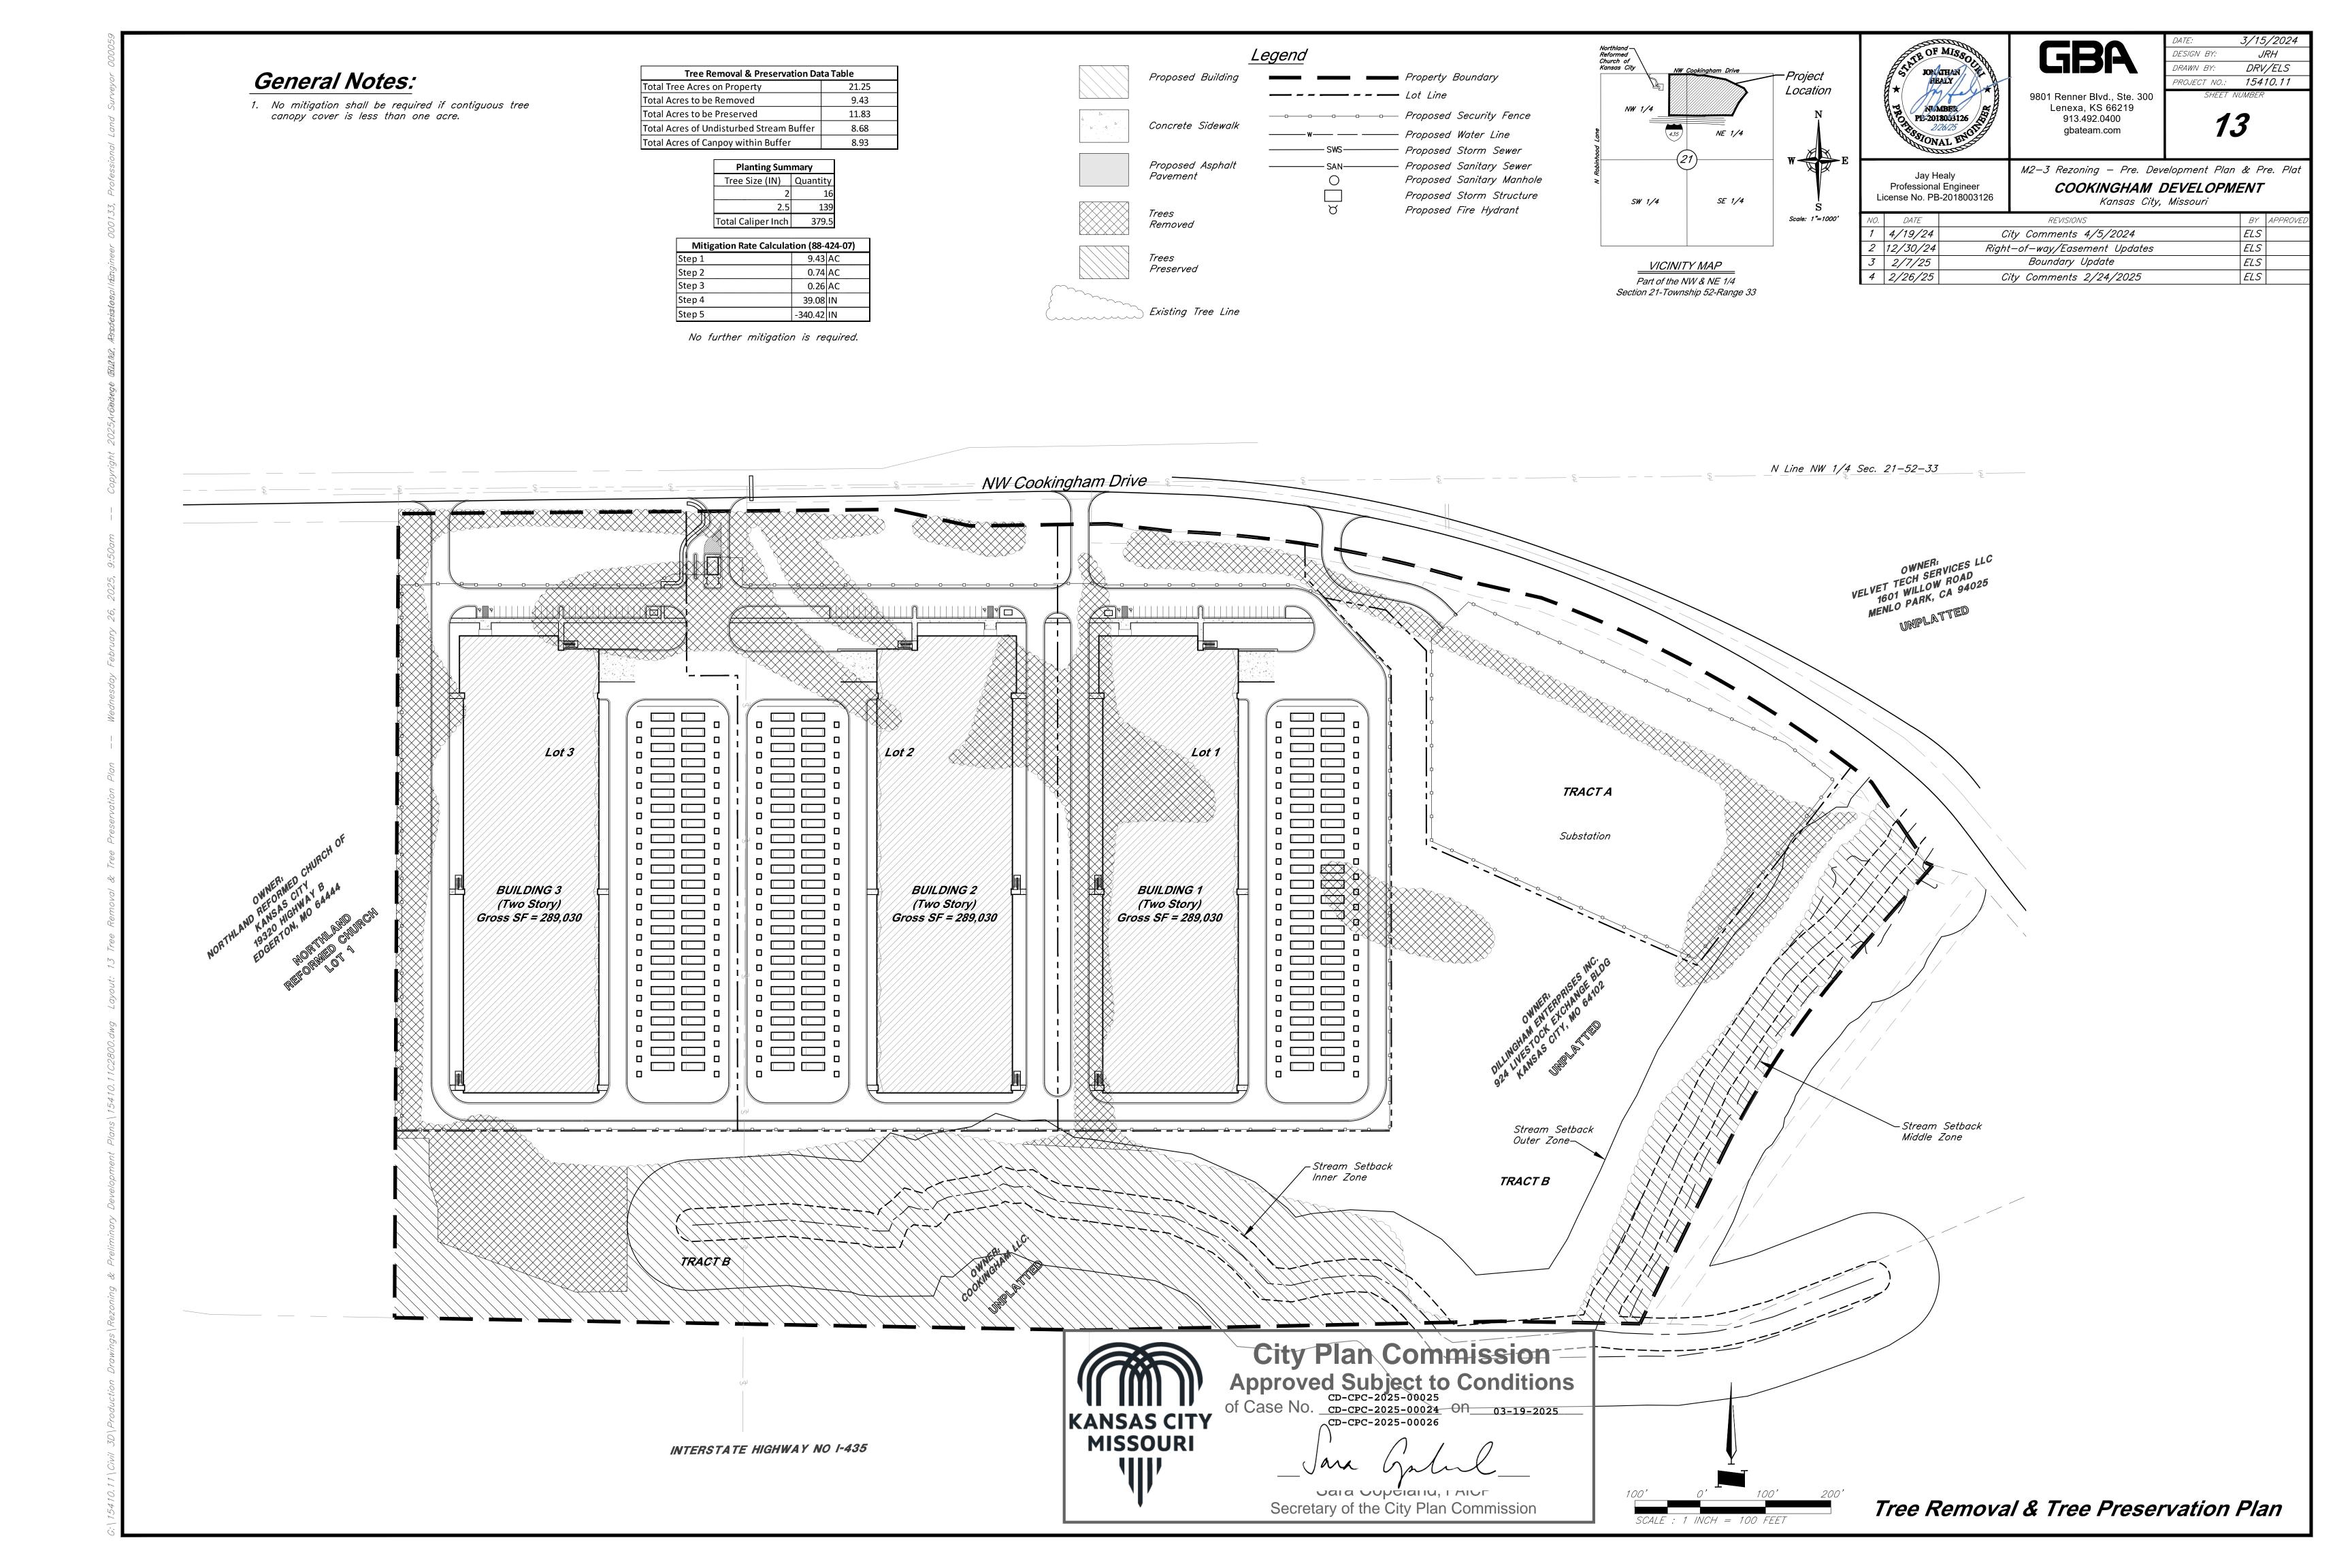

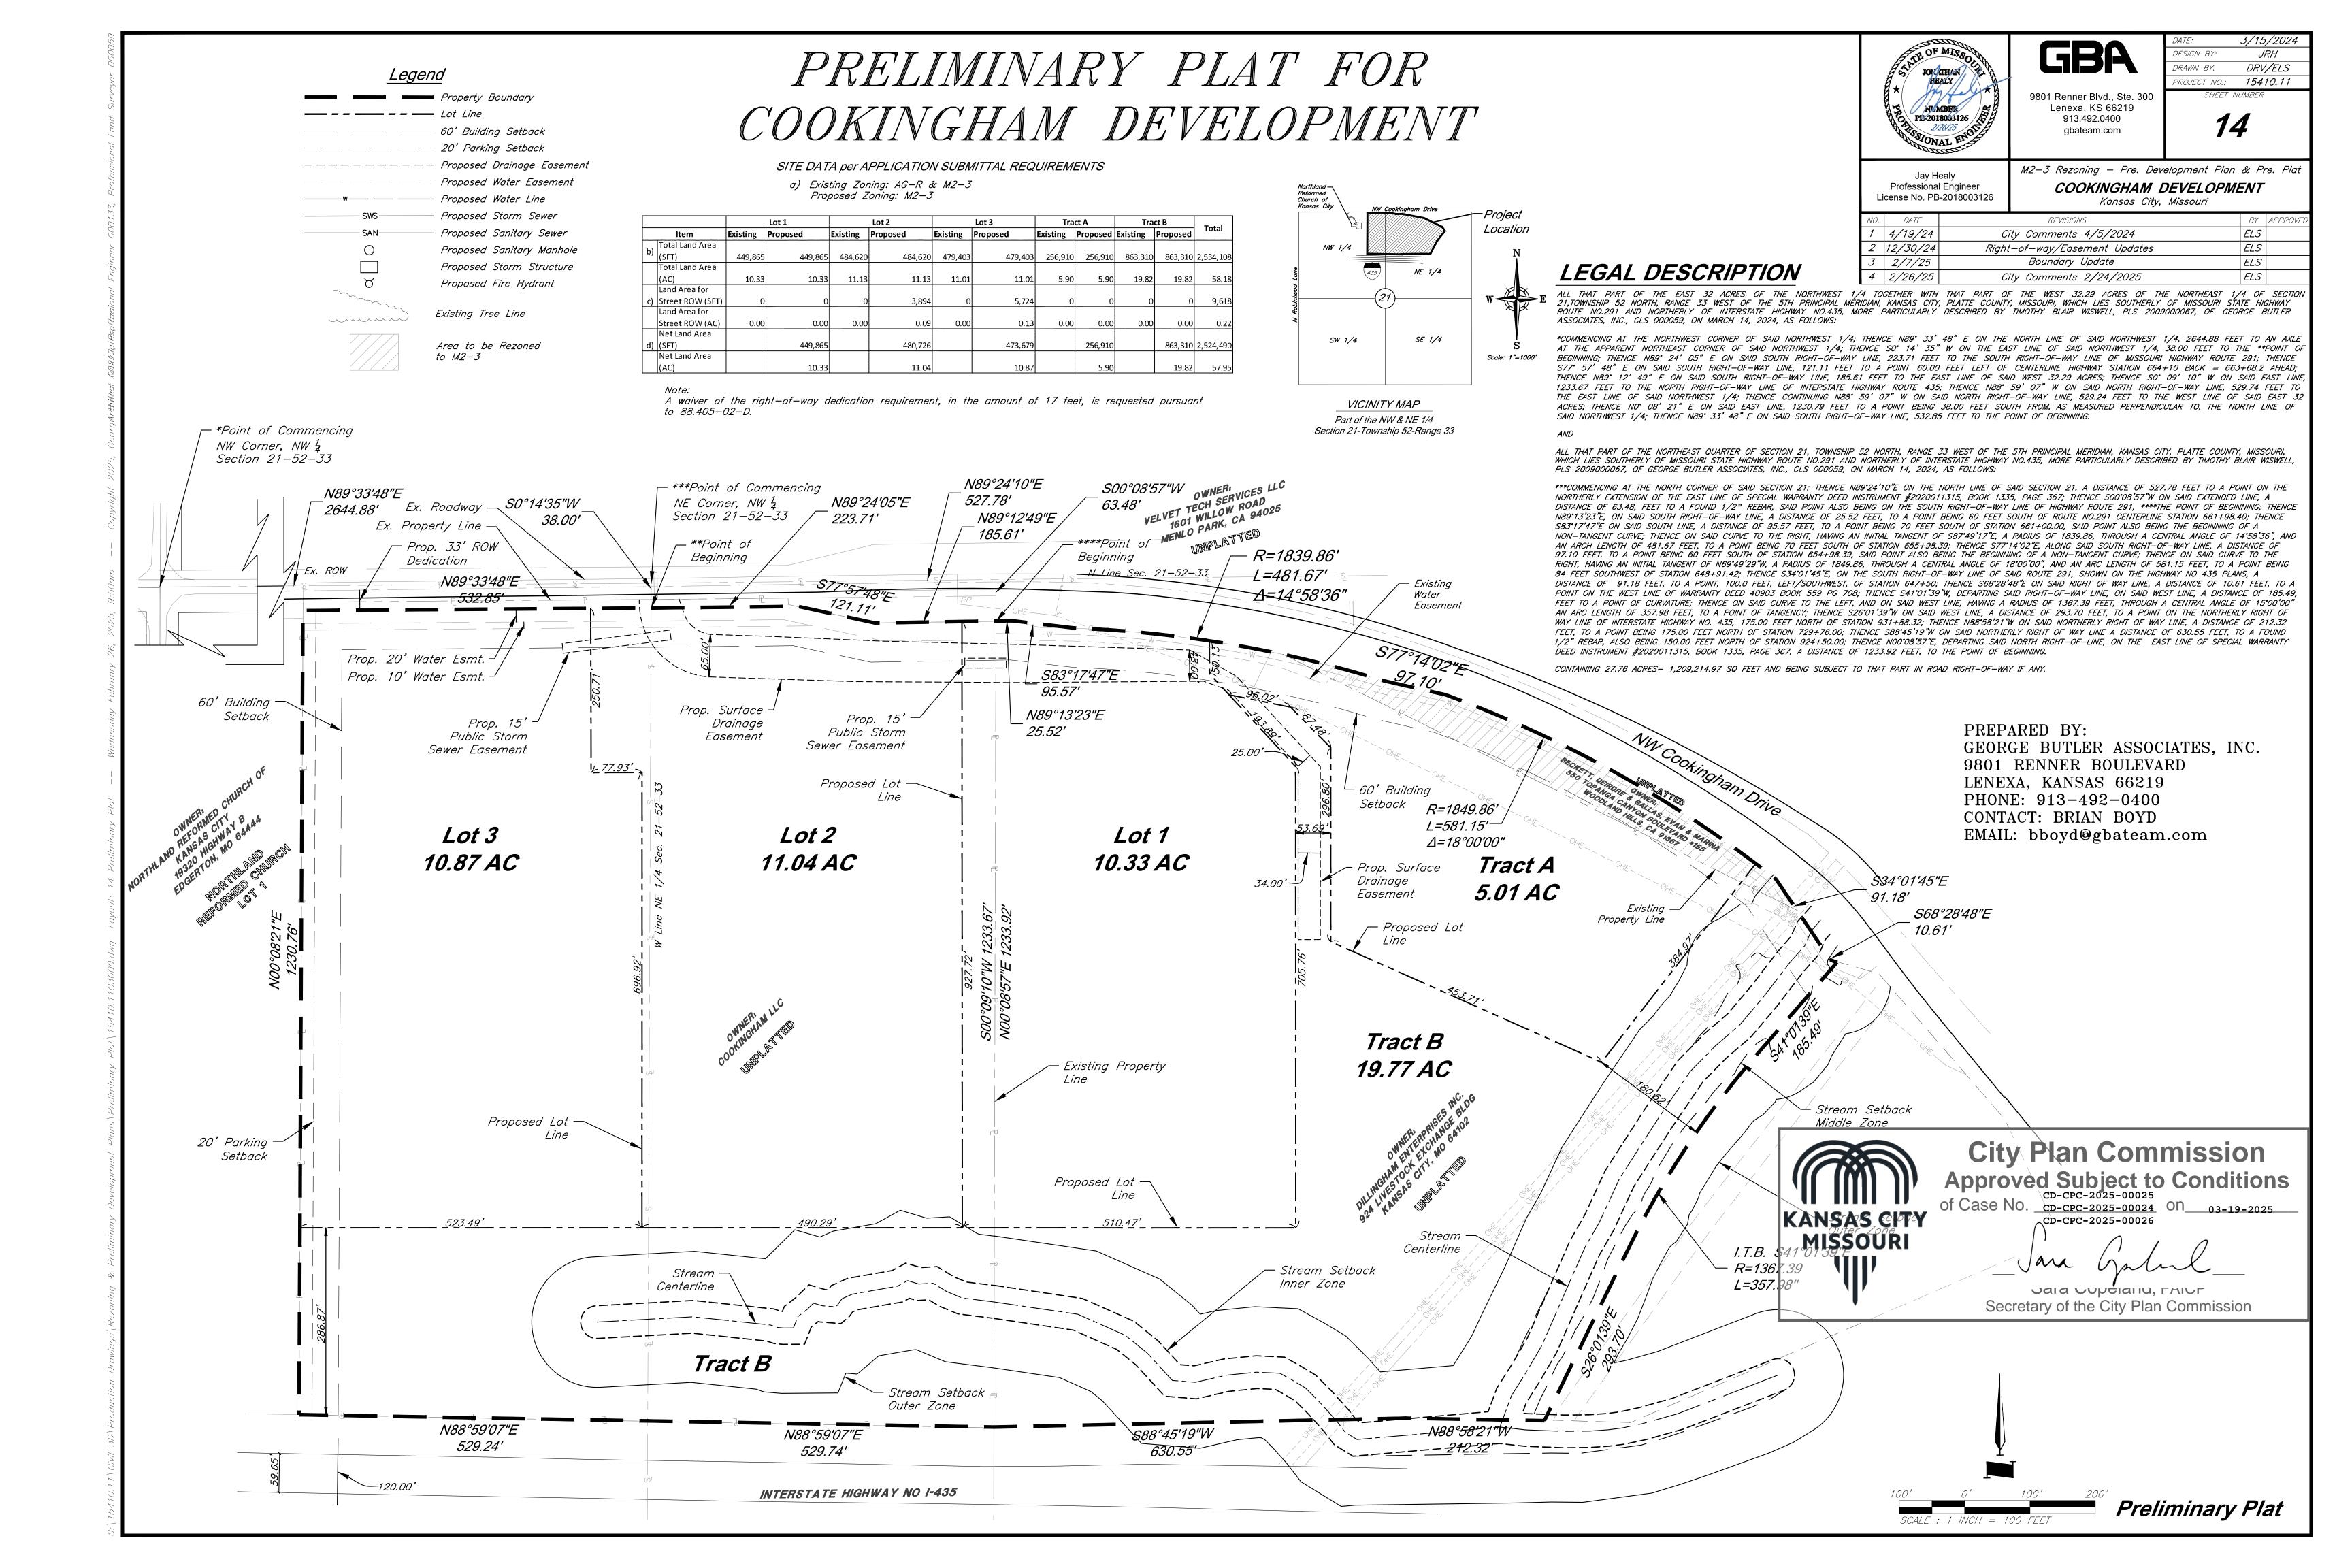





SCALE: 1" = 50'-0"

City Plan Commission Approved Subject to Conditions of Case No. CD-CPC-2025-00024 CD-CPC-2025-00026 CD-CPC-2025-00026

Jaia Juptianu, Faior Secretary of the City Plan Commission

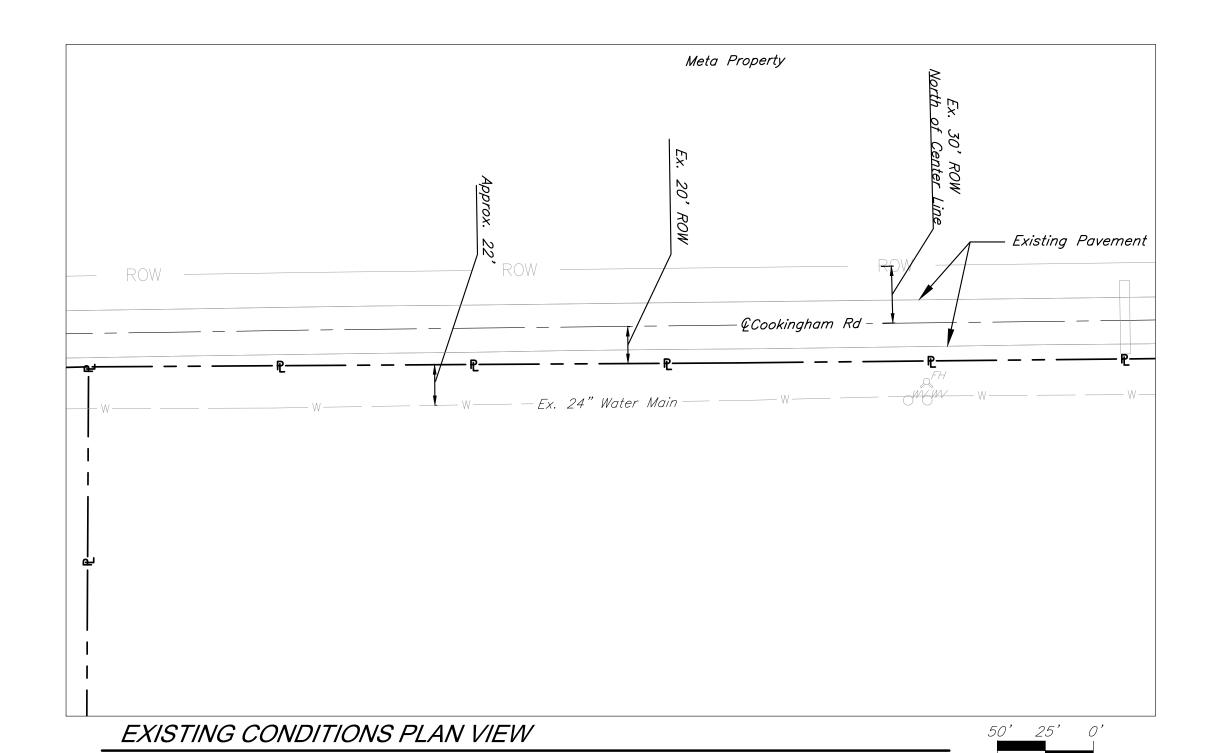

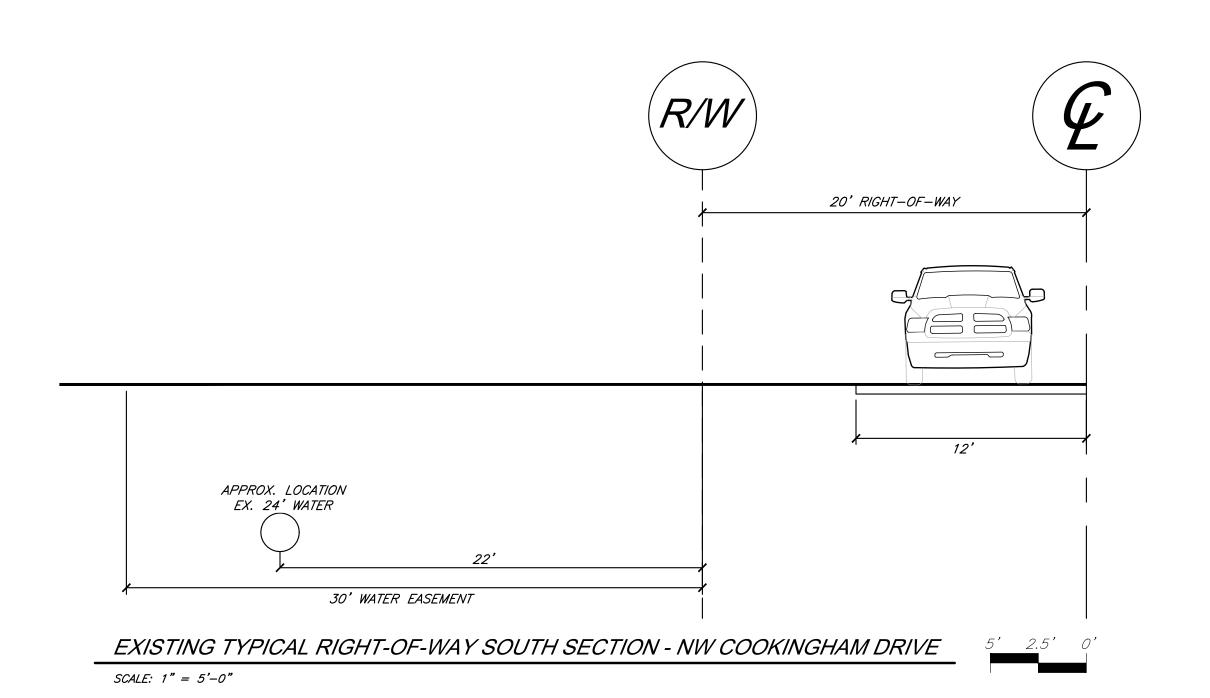



GBA 9801 Renner Blvd., Ste. 300


gbateam.com


DRAWN BY: DRV/ELS PROJECT NO.: 15410.11 Lenexa, KS 66219 913.492.0400

DESIGN BY:


Jay Healy Professional Engineer License No. PB-2018003126 M2-3 Rezoning - Pre. Development Plan & Pre. Plat COOKINGHAM DEVELOPMENT Kansas City, Missouri

NO.	DATE	REVISIONS	BY	APPROVEL
1	4/19/24	City Comments 4/5/2024	ELS	
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4	2/26/25	City Comments 2/24/2025	ELS	

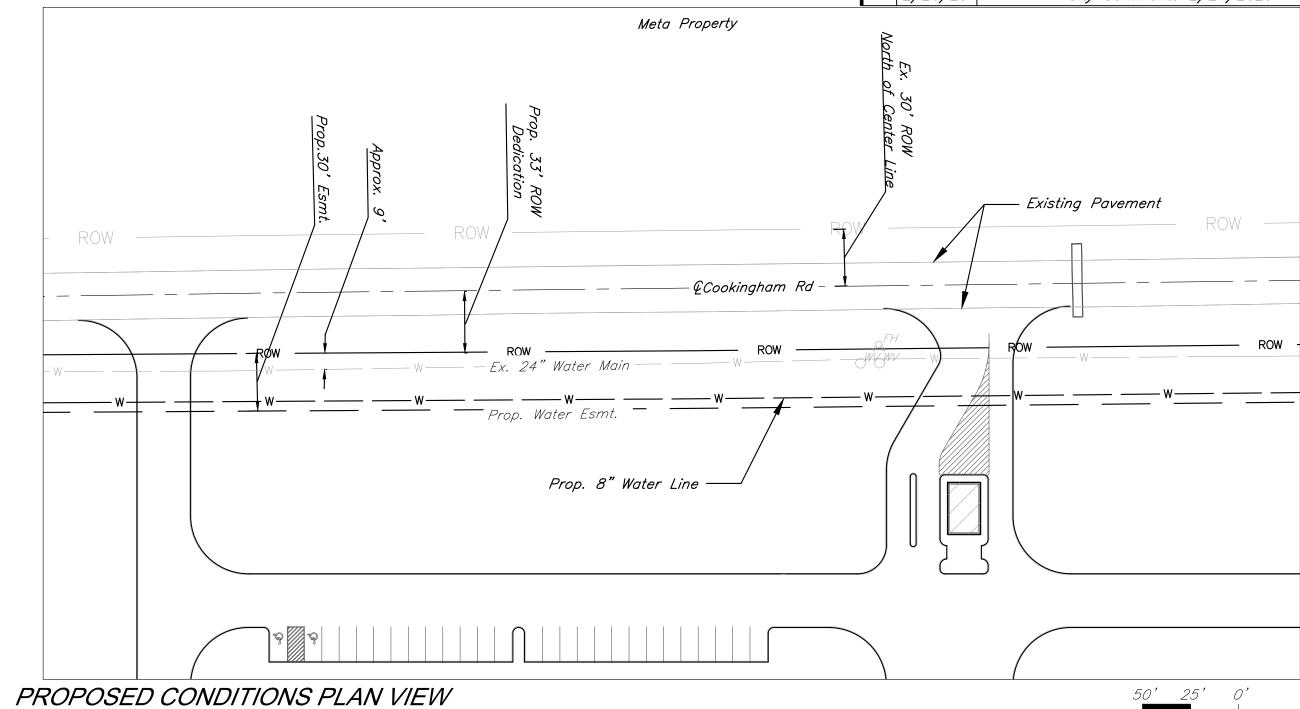

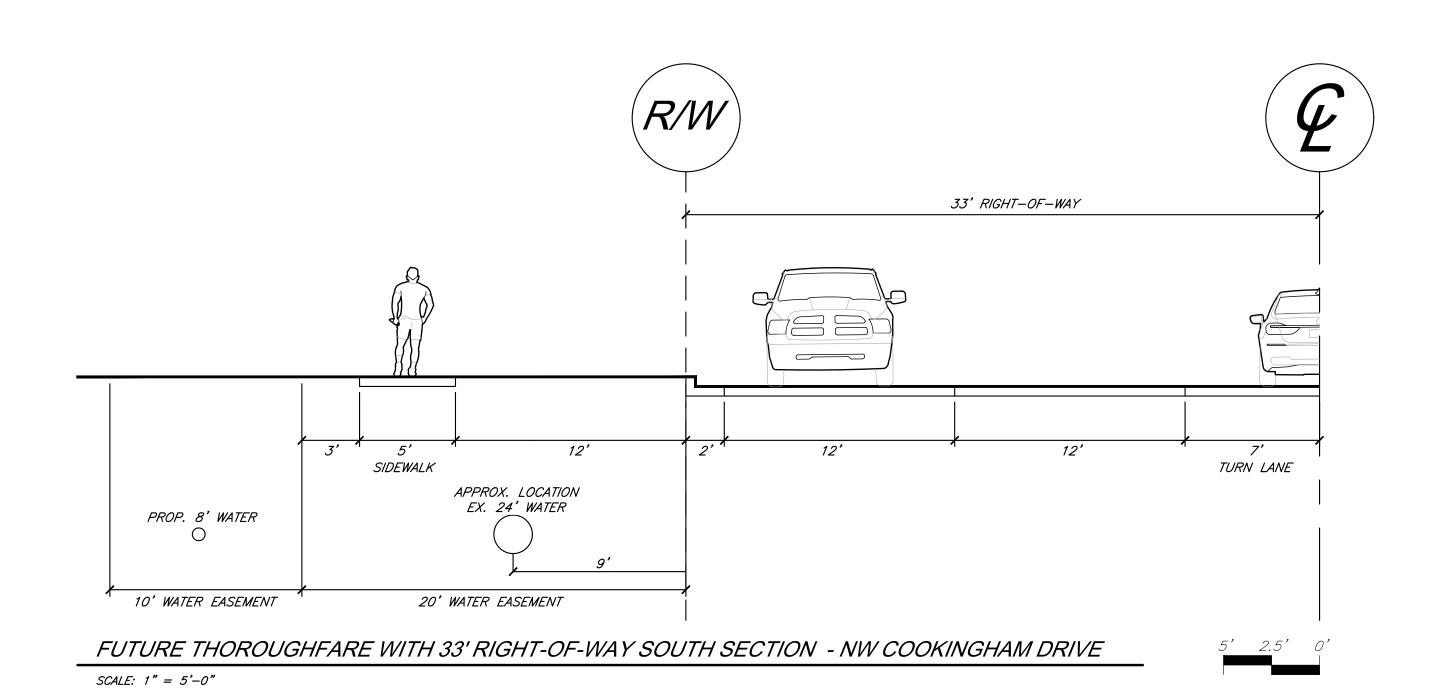

SCALE: 1" = 50'-0"

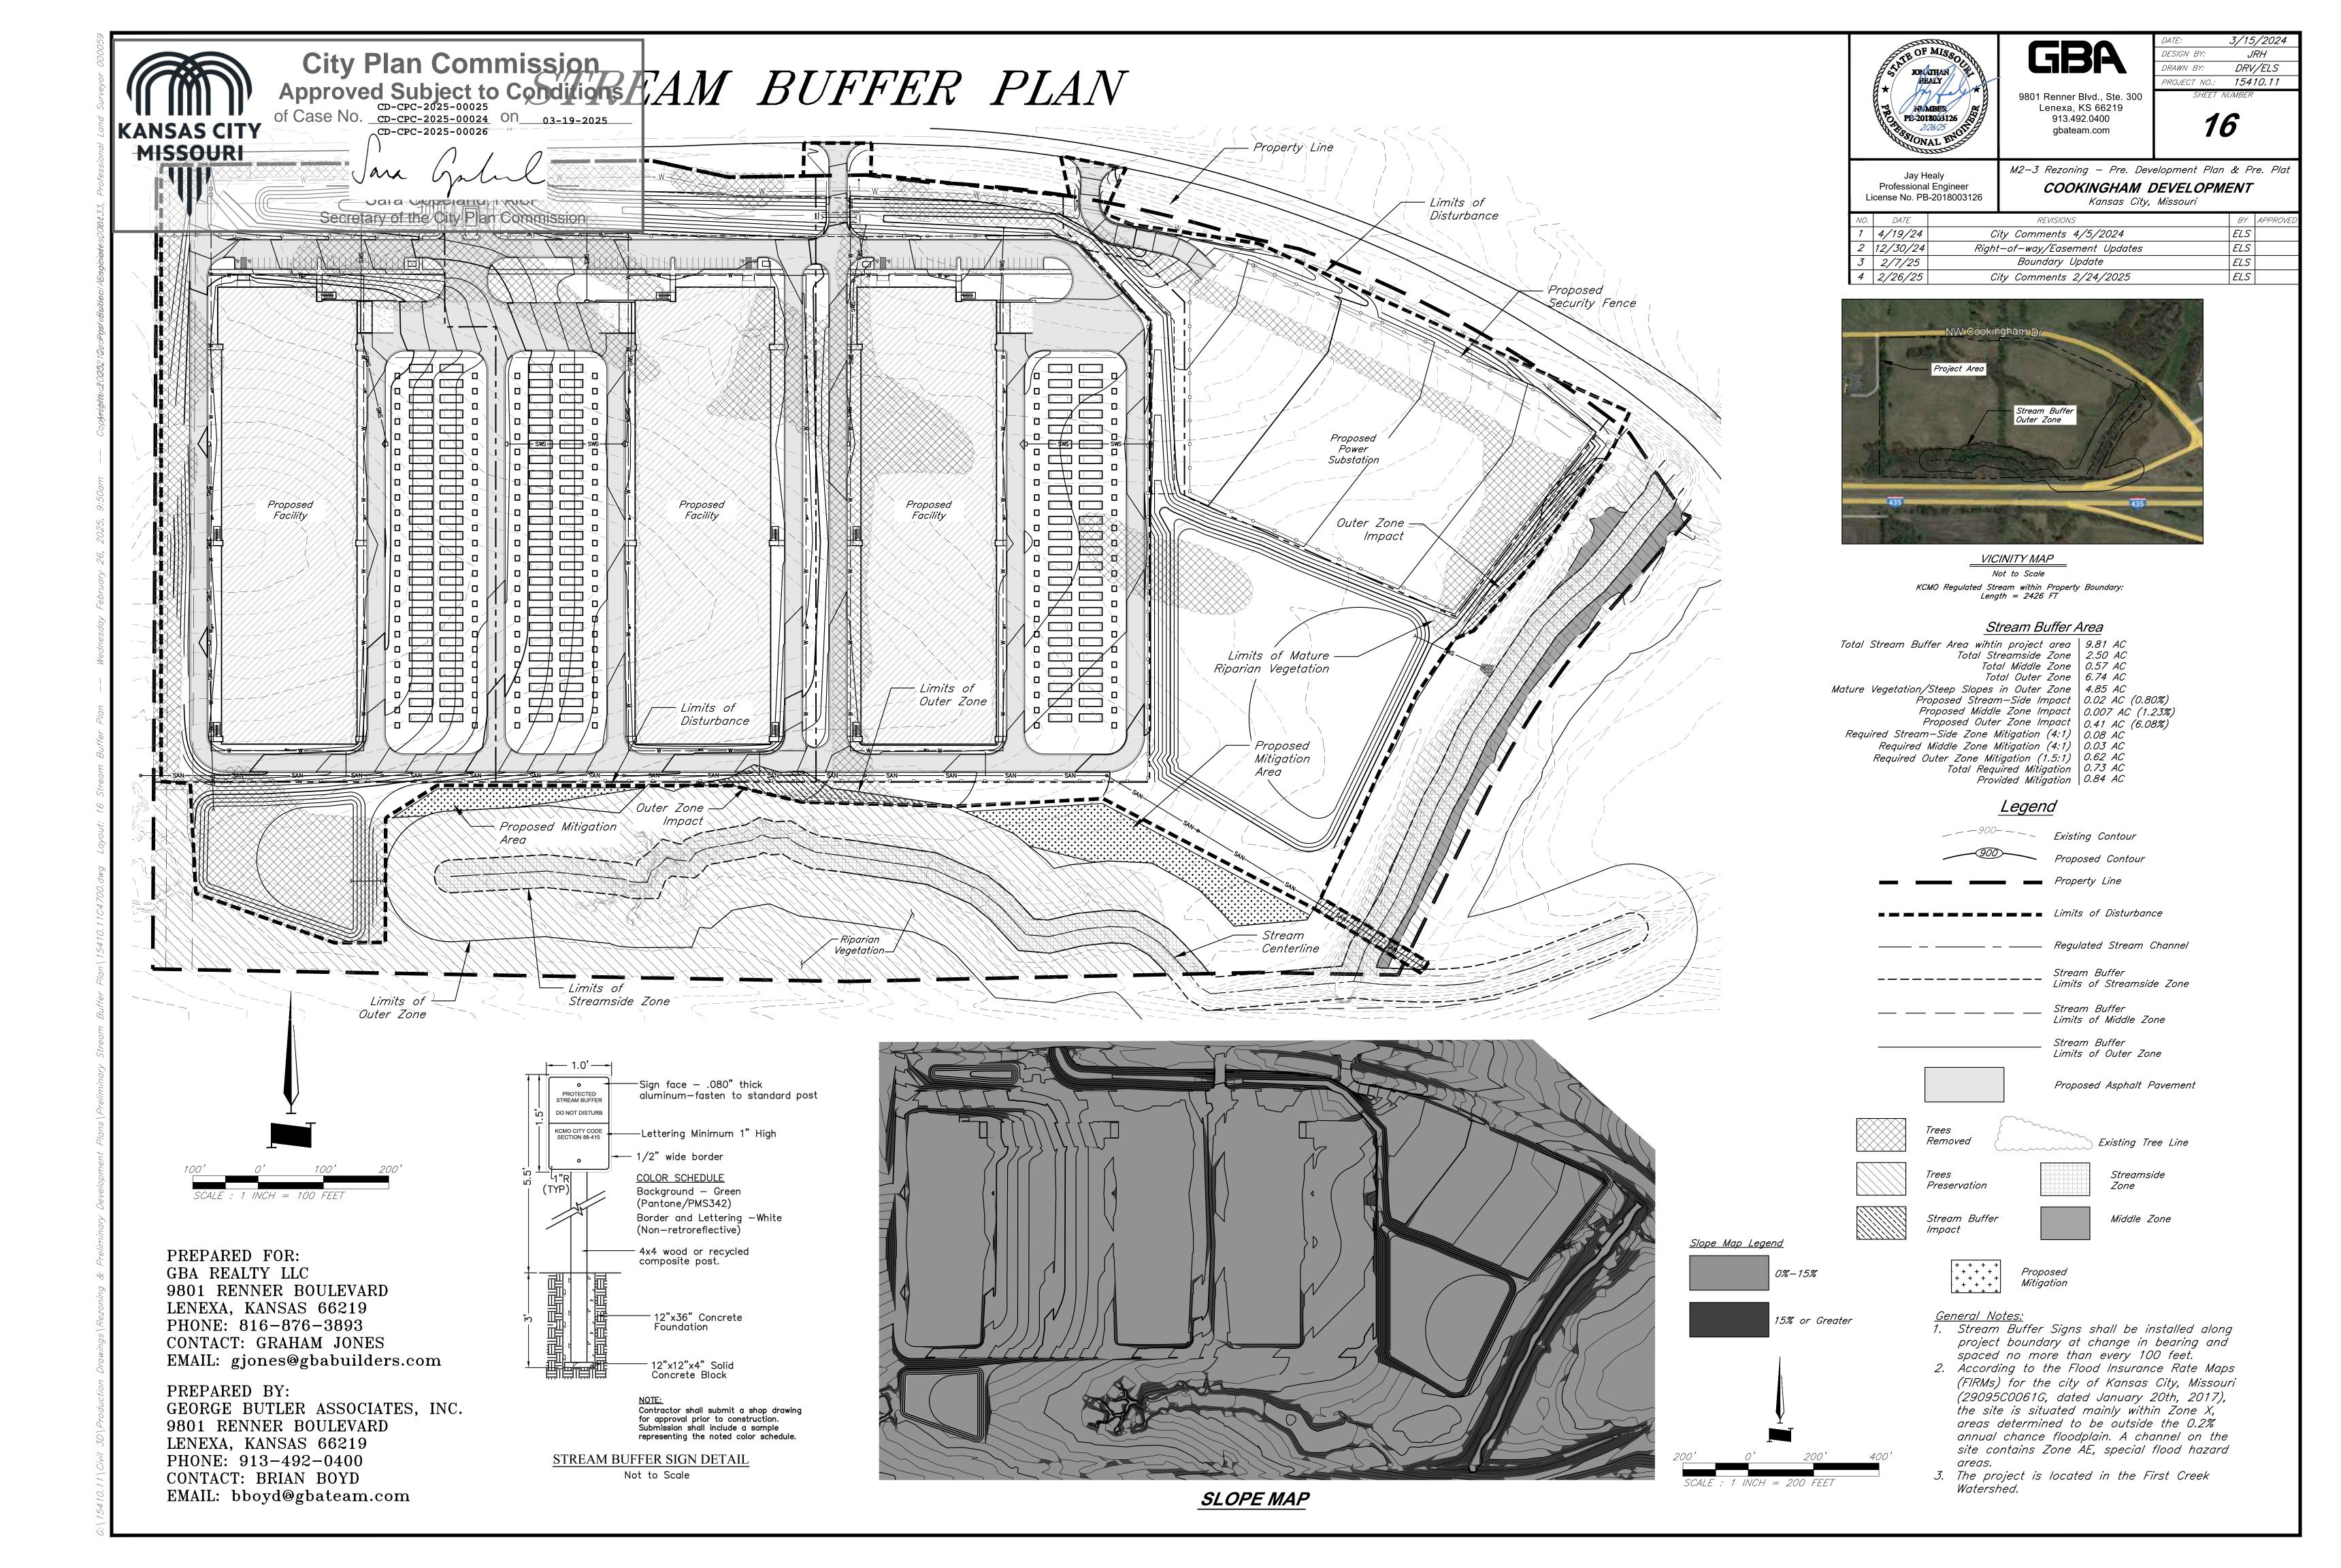

Light Fixture Schedule City Plan Commission
Approved Subject to Conditions
of Case No. CD-CPC-2025-00024 CD-CPC-2025-00026 On 03-19-2025 KANSAS CITY MISSOURI ELECTRICAL POINT BY POINT PHOTOMETRIC PLAN - WEST

GBA Realty

9801 Renner Blvd. Lenexa, Kansas 66219

CATALOG NUMBER

ESX1 LED P2

ESX1 LED P2

WDGE2 P3 LED 40K 80CRI T3M MVOLT

KBR8 LED 12C 350 40K ASY MVOLT

VCPG V4 P1 40K 80CRI T5W MVOLT

TWO

COAKS DESIGN &
CONSULTING

4826 ACADEMY DRIVE MADISON, WI 53716

COOKINGHAM
DEVELOPMENT
KANSAS CITY, MISSOUF

CHECKED BY ISSUE DATE 03/12/24 REVISIONS NO. DATE DESCRIPTION				
REVISIONS	CHECKED BY		JP	
	ISSUE	DATE _	03/12/24	
NO. DATE DESCRIPTION	REVISI	ONS		
	NO.	DATE	DESCRIPTION	
SHEET TITLE:				

ELECTRICAL
POINT BY POINT
PHOTOMETRIC SITE PLAN
WEST

ESL1.1

SHEET NO



City Plan Commission
Approved Subject to Conditions
of Case No. CD-CPC-2025-00024
CD-CPC-2025-00024
CD-CPC-2025-00026
On 03-19-2025

Secretary of the City Plan Commission

GBA Realty

9801 Renner Blvd. Lenexa, Kansas 66219

4826 ACADEMY DRIVE MADISON, WI 53716

CHECKED BY		JP	
ISSUE DATE		03/12/24	
REVISI	ONS		
NO.	DATE	DESCRIPTION	

SHEET TITLE: ELECTRICAL POINT BY POINT PHOTOMETRIC SITE PLAN

ESL1.2

ELECTRICAL POINT BY POINT PHOTOMETRIC PLAN - EAST

