


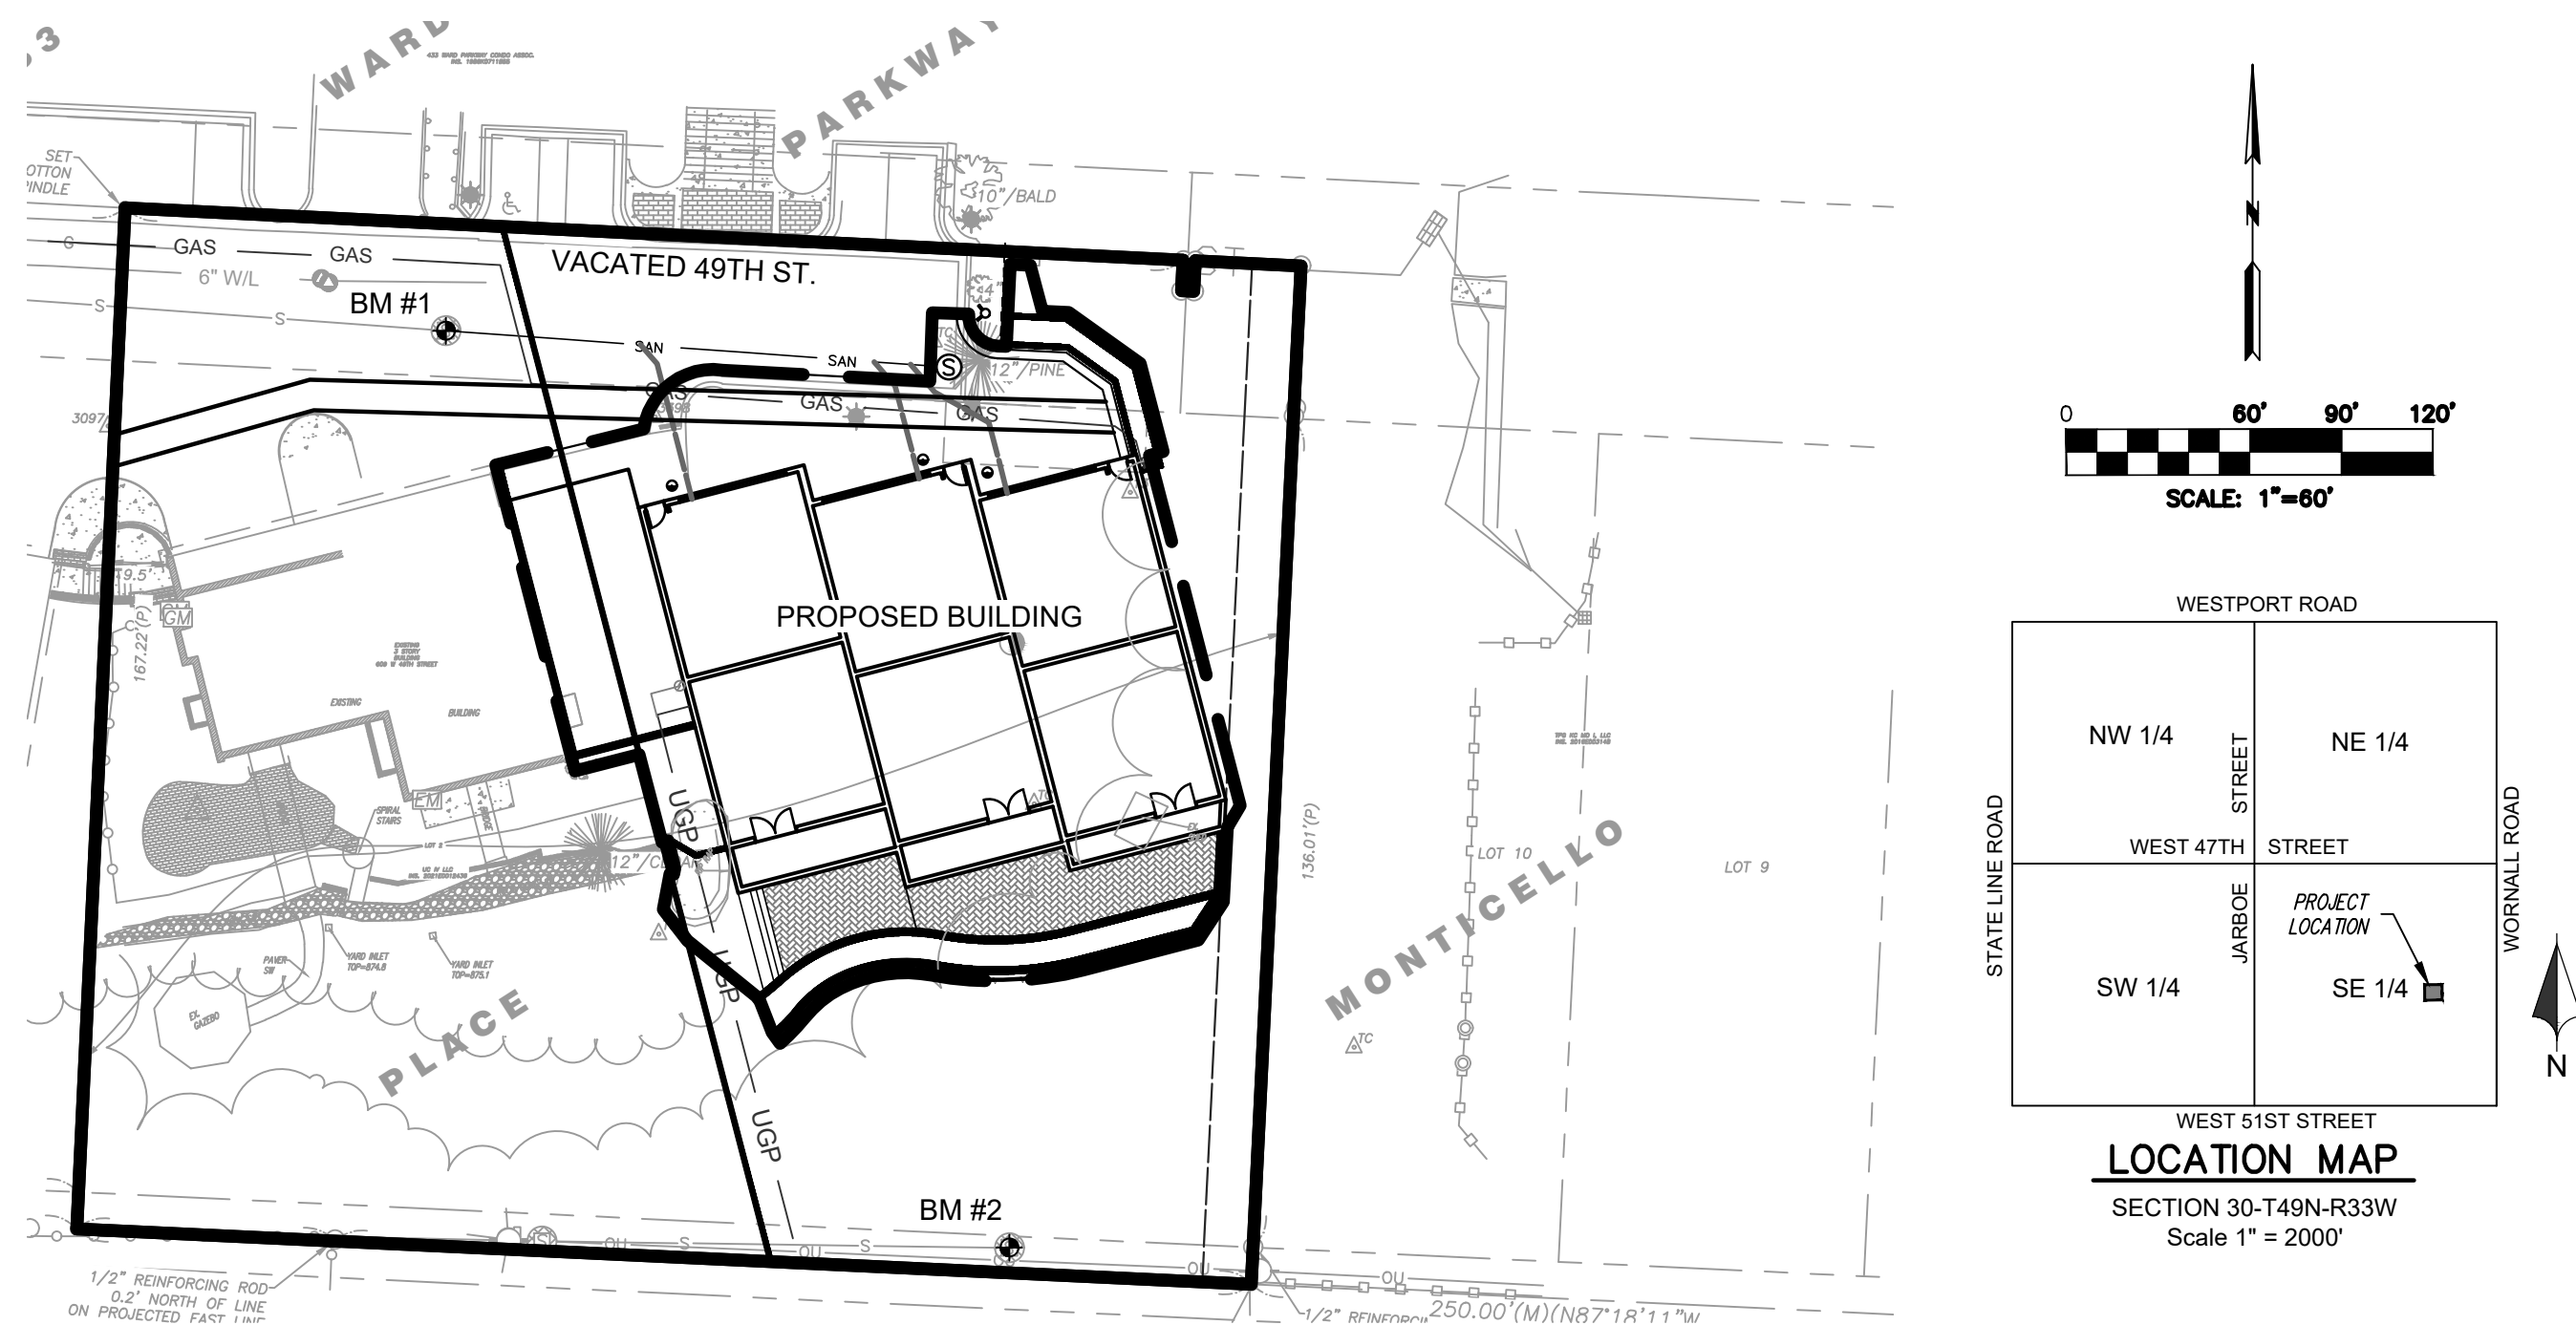

A REPLAT OF LOT TWO, ARNOLD PLACE AND UNPLATTED / VACATED  
PORTIONS OF 49TH STREET RIGHT-OF-WAY  
KANSAS CITY, JACKSON COUNTY, MISSOURI  
FINAL DEVELOPMENT PLANS

FILE NUMBER 2023-234 / PROJECT NUMBER CRBG-2023-30984

3. ALL WORK SHALL BE DONE IN ACCORDANCE WITH THE MOST RECENT VERSION OF THE KCMO PUBLIC WORKS DEPARTMENTS STANDARDS AND SPECIFICATIONS AND DESIGN CRITERIA AND APWA KC FOR CONSTRUCTION OF THE KANSAS CITY, MISSOURI PUBLIC WORKS DEPARTMENT (KCPWD).
2. THE LOCATIONS OF EXISTING UTILITIES, AS SHOWN, ARE APPROXIMATE. IT SHALL BE THE RESPONSIBILITY OF THE CONTRACTOR TO VERIFY THE LOCATIONS AND ELEVATIONS OF ALL EXISTING UTILITIES. CONTRACTORS SHALL POTHOLE AND EXPOSE ALL UTILITIES (INDICATED ON THE DRAWINGS, LOCATED AT GRADE BY A UTILITY LOCATING SERVICE, OR EVIDENT FROM UTILITY COMPANY INFORMATION) AT LEAST 500 FEET IN ADVANCE OF WATER MAIN CONSTRUCTION, DETERMINING THE DEPTH, SIZE, AND MATERIAL OF THE UTILITIES IN PROXIMITY TO THE PROPOSED WATER MAIN ALIGNMENT. CONTRACTOR SHALL PROVIDE THIS INFORMATION TO THE ENGINEER & ADVISE OF ANY POTENTIAL CONFLICTS WITH THE PROPOSED PIPELINE ALIGNMENT. DEFLECT PIPE TO MAINTAIN MINIMUM 5 FEET HORIZONTAL AND 18 INCH VERTICAL CLEARANCES BETWEEN PROPOSED WATER MAIN AND ALL EXISTING UTILITIES.
3. THE CONTRACTOR SHALL COMPLY WITH STATE LAW REQUIRING ANY PERSON OR FIRM DOING EXCAVATION ON THE PUBLIC RIGHT-OF-WAY DO SO ONLY AFTER GIVING NOTICE TO AND OBTAINING INFORMATION FROM UTILITY COMPANIES.
4. AN EXCAVATION PERMIT MUST BE OBTAINED FROM THE PUBLIC WORKS DEPARTMENT PRIOR TO COMMENCING CONSTRUCTION WITHIN THE PUBLIC RIGHT-OF-WAY. CONTACT THE PUBLIC WORKS DEPARTMENT PERMIT COUNTER AT CITY HALL.
5. A STREET CLOSURE PERMIT MAY BE REQUIRED FOR THIS WORK. CONTACT THE PUBLIC WORKS DEPARTMENT PERMIT COUNTER AT CITY HALL.
6. ALL WORK SHALL CONFORM TO THE LATEST REVISION OF THE KANSAS CITY, MISSOURI EROSION AND SEDIMENT CONTROL SPECIFICATIONS, WHICH ARE MADE A PART HEREOF BY REFERENCE. EROSION CONTROL PLANS SHALL BE SUBMITTED FOR REVIEW AND APPROVAL PRIOR TO THE START OF THIS PROJECT.
7. CONTRACTORS SHALL PROTECT EXISTING POWER POLES AND LIGHT POLES FROM DAMAGE AND SHALL PROVIDE BRACING, SHORING, OR OTHER WORK NECESSARY FOR SUCH PROTECTION. ANY STRUCTURES REMOVED DURING CONSTRUCTION OPERATIONS SHALL BE REPLACED.
8. ANY EXISTING STRUCTURE, YARD FEATURE, FENCE OR OTHER ITEM DAMAGED BY THE CONTRACTOR SHALL BE REPLACED OR REPAIRED TO LIKE OR BETTER CONDITION. THERE WILL BE NO SEPARATE PAYMENT FOR THIS WORK.
9. ANY EXISTING YARD STRUCTURE WITHIN THE STREET RIGHT-OF-WAY SHALL BE REMOVED AS NECESSARY DURING CONSTRUCTION, UNLESS OTHERWISE NOTED. OTHER STRUCTURES MAY BE RELOCATED TO A DIFFERENT LOCATION IF AGREED UPON BY THE PROPERTY OWNER AND THE ENGINEER.
10. EROSION CONTROL PLANS AND PROCEDURES SHALL BE IN PLACE PRIOR TO ANY EXCAVATION. CONTRACTOR TO REFER TO THE STORMWATER POLLUTION PREVENTION PLAN (SWPPP) DEVELOPED BY DESIGN ENGINEER FOR THIS PROJECT. A COPY OF THE SWPPP CAN BE FOUND IN THE PROJECT DOCUMENTS.
11. SURFACE RESTORATION FOR THE AREAS NOT PAVED OR LANDSCAPED SHALL BE WITH SOD OR SEED. AREAS WITH ESTABLISHED MOWED LAWNS SHALL BE SODDED. ALL OTHER AREAS THAT ARE NOT PAVED OR LANDSCAPED SHALL BE SEEDED. SODDING SHALL BE IN ACCORDANCE WITH SECTION 02931 - SODDING AND SEEDING SHALL BE IN ACCORDANCE WITH SECTION 02930 - SEEDING OF THE PROJECT MANUAL.
12. ALL RIGHT-OF-WAY MONUMENTS SHALL NOT BE DISTURBED OR DESTROYED. THE CONTRACTOR SHALL BE RESPONSIBLE FOR REMOVING AND RESETTling ALL DISTURBED PROPERTY CORNER MARKERS. THERE WILL BE NO SEPARATE PAYMENT FOR THIS WORK.
13. CONTRACTOR SHALL MAKE EVERY REASONABLE EFFORT TO SAVE ANY BUSHES, TREES, EXISTING STRUCTURE, YARD FEATURE OR OTHER ITEM. ANY ITEM DAMAGED BY THE CONTRACTOR SHALL BE REPLACED OR REPAIRED TO LIKE NEW OR BETTER CONDITION. THERE WILL BE NO SEPARATE PAYMENT FOR THIS WORK.
14. THE CONTRACTOR SHALL PROVIDE & MAINTAIN TEMPORARY SURFACING CAPABLE TO SUPPORTING HEAVY WHEELED TRAFFIC (E.G., UNTREATED COMPACT AGGREGATE, STEEL PLATES) IN ANY PAVED AREAS CUT OR DISTURBED UNTIL CONCRETE OR ASPHALT CAN BE PLACED.
15. ALL PAVED SURFACES THAT ARE EITHER COMPRISED OF CONCRETE OR ASPHALT (E.G., STREETS, DRIVEWAYS, PARKING LOTS, ETC.) THAT ARE REMOVED BY THIS CONSTRUCTION SHALL BE REPLACED IN ACCORDANCE WITH SECTION 0275 - SURFACE RESTORATION OF THE PROJECT MANUAL AND THE CURRENT "STREET CUT RESTORATION" STANDARD DRAWING SR-1.


































OVERALL BOUNDARY:

ALL OF LOT TWO, ARNOLD PLACE, A RESURVEY AND RESUBDIVISION OF ALL OF LOT 1, ARNOLD PLACE CONDOMINIUM, A SUBDIVISION OF LAND IN KANSAS CITY, JACKSON COUNTY, MISSOURI LOCATED IN SECTION 30, TOWNSHIP 49 NORTH, RANGE 33 WEST.

AT&T.....	1-800-246-8464
LUMEN.....	1-800-283-4237
CONSOLIDATED.....	844-968-7224
COMCAST.....	800-391-3000
FIDELITY COMMUNICATIONS.....	800-392-8070
GOOGLE FIBER NOC.....	1-866-954-1572
KCMO PARKS & RECREATION.....	816-513-7500
KCMO STREET AND TRAFFIC DIVISION.....	816-513-0421
KCMO STREET LIGHTING/ BLACK & MCDONALD.....	816-483-0257
KCMO WATER SERVICES DEPT DISPATCHER.....	816-513-1313
KCMO WATER SERVICES POLLUTION CONTROL.....	816-513-1313
EVERGY.....	888-544-4852
LEVEL 3.....	877-LEVEL13
MAGELLAN MIDSTREAM PARTNERSHIP LP.....	800-720-2471
SPIRE.....	800-582-0000
MISSOURI DEPARTMENT OF TRANSPORTATION.....	888-275-6636
MISSOURI ONE-CALL.....	800-344-7483
SOUTHERN STAR CGP.....	800-324-9696
SINCLAIR TRANSPORTATION.....	800-321-3994
T-MOBILE.....	800-521-0579
SUREWEST.....	913-825-3000
SPECTRUM.....	833-493-4939
TRI COUNTY WATER.....	816-796-4100
TW TELECOM.....	800-829-0420
UNITE PRIVATE NETWORKS.....	866-963-4237
VERIZON/ MCI COMMUNICATIONS INC.....	800-624-9675
ZAYO.....	866-236-2824

### LEGEND

	Existing Section Line		Proposed Right-of-Way
	Existing Right-of-Way Line		Proposed Property Line
	Existing Lot Line		Proposed Lot Line
	Existing Easement Line		Proposed Easement
	Existing Curb & Gutter		Proposed Curb & Gutter
	Existing Sidewalk		Proposed Sidewalk
	Existing Storm Sewer		Proposed Storm Sewer
	Existing Storm Structure		Proposed Storm Structure
	Existing Waterline		Proposed Fire Hydrant
	Existing Gas Main		Proposed Waterline
	Existing Sanitary Sewer		Proposed Sanitary Sewer
	Existing Sanitary Manhole		Proposed Sanitary Manhole
	Existing Light Pole		Proposed Light Pole
	Existing Contour Major		Proposed Contour Major
	Existing Contour Minor		Proposed Contour Minor
			Future Curb & Gutter

1. According to the F.E.M.A. Flood Insurance Rate Map Number 290905C0261G, Revised January 20, 2017, this tract graphically lies in OTHER AREAS, ZONE X<sub>1</sub>, defined as areas determined to be outside of 0.2% annual chance floodplain. Base flood elevations have been determined.
2. There are no oil or gas wells located on the subject property as of January 30, 2024 as shown by the Missouri Geological Survey GEOSTRAT (Geosciences Technical Resource Assessment Tool).

#1 CENTER OF EXISTING SANITARY SEWER MANHOLE APPROX. 53 FEET EAST AND APPROX. 17 FEET SOUTH OF THE NORTHWEST CORNER OF LOT TWO, ARNOLD PLACE.  
N: 1045774.72 E: 2761912.48  
TOP ELEV. 854.98

#2 CENTER OF EXISTING SANITARY SEWER MANHOLE APPROX. 40 FEET WEST AND APPROX. 5 FEET NORTH OF THE SOUTHEAST CORNER OF LOT TWO, ARNOLD PLACE.  
N: 1045624.74 E: 2762004.60  
TOP ELEV. 899.18

DEVELOPER

**UC IV, LLC**  
3930 WASHINGTON STREET  
KANSAS CITY, MO. 64111  
(913) 526-6833  
CONTACT - AHMED AWAD  
DRAWAD@KCKIDNEY.COM

ENGINEER

**Hg CONSULT, INC.**  
1411 NE TODD GEORGE RD.  
LEE'S SUMMIT, MISSOURI 64086  
(816) 703-7098  
CONTACT - KEVIN STERRETT  
EMAIL: KSTERRETT@HGCONS.COM

## GENERAL PLANS

C0.01 CIVIL GENERAL NOTES  
C0.02 EXISTING CONDITIONS

C1.01	SITE DIMENSION PLAN
C1.02	SITE GRADING PLAN
C1.03	SITE UTILITY PLAN
C1.04	FIRE TRUCK TURNING


## LANDSCAPE PLAN

*C2.01 LANDSCAPE PLAN*

## MISCELLANEOUS DETAILS

### C3.01 MISCELLANEOUS DETAILS

DATE	REVISION	NO.	BY	CHANGE
10/24/24	PER CITY COMMENTS - DATED 08/02/24			
06/15/24		3	MMH	PSS
05/27/24	PER CITY COMMENTS	2	SPW	PSS
03/25/24	PER CITY COMMENTS	1	SPW	PSS
11/08/21	SUBMITTED TO CITY OF KANSAS CITY			

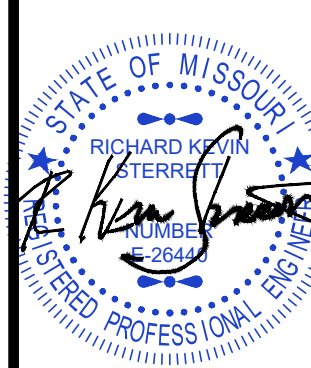

R. KEVIN STERRETT, MO E-26440  
October 01, 2024




1533 Locust Street, Kansas City, Missouri 64108  
CORPORATE LICENSE NO. E201000573 (MO.) / E-1736 (KS.) / LS 2019005467

PRELIMINARY DEVELOPMENT PLANS / PLAT  
CIVIL GENERAL NOTES

**SHIRAZ CONDOMINIUMS**  
509, 511 & 513 WEST 49TH STREET  
CITY OF KANSAS CITY, JACKSON COUNTY, MISSOURI

	<i>X-REF NO.</i> 21-032 Base
	<i>DRAWING NO.</i> 21-032 PDPs
	<i>DATE</i> October 01, 2024
	<i>JOB NO.</i> 21-032

C0.01

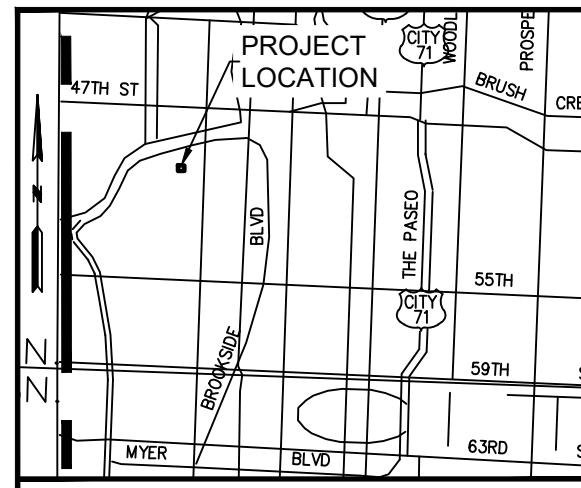

NOT TO SCALE



1 - 800 - 344 - 7483  
1 - 800 - (DIG-RITE)  
(811)








C1.01



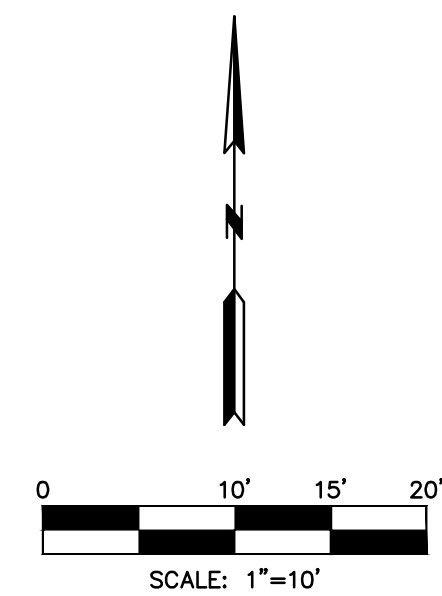

TC = Top of Curb  
SW = Edge of Sidewalk  
TW = Top of Wall  
BW = Bottom of Wall  
PT = Patio  
H.P. = High Point  
L.P. = Low Point

1. *SITE GRADING SHALL NOT PROCEED UNTIL EROSION CONTROL MEASURES HAVE BEEN INSTALLED & INSPECTED AND APPROVED BY LOCAL AUTHORITIES.*
2. *ALL CUT OR FILL SLOPES SHALL BE 3:1 OR FLATTER UNLESS OTHERWISE NOTED.*
3. *CONTRACTOR SHALL ASSURE POSITIVE DRAINAGE AWAY FROM BUILDINGS AND STRUCTURES FOR ALL GRASSED AND PAVED AREAS.*
4. *CONSTRUCTION SHALL COMPLY WITH ALL APPLICABLE GOVERNING CODES AND BE CONSTRUCTED TO THE SAME.*
5. *CONTRACTOR IS RESPONSIBLE FOR TEMPORARY ACCESS ROADS AND SHALL MAINTAIN POSITIVE DRAINAGE OF ENTIRE SITE THROUGHOUT CONSTRUCTION AND AVOID PONDING OR RUTTING. TEMPORARY DEWATERING, INCLUDING PUMPING, MAY BE REQUIRED AND SHALL BE INCLUDED IN THE SCOPE OF WORK.*
6. *ALL SIDEWALKS, RAMPS, AND ACCESSIBLE ROUTES TO MEET ADA REQUIREMENTS.*
  - 6.1 *SIDEWALKS TO HAVE MAXIMUM LONGITUDINAL SLOPE OF 5% AND MAXIMUM CROSS SLOPE OF 2%.*
  - 6.2 *RAMPS TO HAVE A MAXIMUM LONGITUDINAL SLOPE OF 8.3% AND MAXIMUM CROSS SLOPE OF 2%.*
7. *EXISTING DRAINAGE STRUCTURES TO BE INSPECTED AND REPAIRED AS NEEDED, AND EXISTING PIPES ARE TO BE CLEANED OUT TO REMOVE ALL SILT AND DEBRIS.*
8. *IF ANY EXISTING STRUCTURES TO REMAIN ARE DAMAGED DURING CONSTRUCTION IT SHALL BE THE CONTRACTORS RESPONSIBILITY TO REPAIR OR REPLACE THE EXISTING STRUCTURE AS NECESSARY.*


\*\*\*\*\*CAUTION\*\*\*\*\*

**NOTICE TO CONTRACTOR**

THE CONTRACTOR IS SPECIFICALLY CAUTIONED THE LOCATION AND ELEVATION OF EXISTING UTILITIES AS SHOWN ON THESE PLANS ARE BASED ON RECORDS OF THE VARIOUS UTILITY COMPANIES AND MEASUREMENTS TAKEN IN THE FIELD. THE INFORMATION IS NOT TO BE RELIED ON AS BEING EXACT OR COMPLETE. THE CONTRACTOR MUST CALL THE LOCAL UTILITY LOCATION CENTER AT LEAST 72 HOURS BEFORE ANY EXCAVATION TO REQUEST EXACT FIELD LOCATIONS OF THE UTILITIES.

DATE	REVISION	NO.	BY	CC/APP
10/01/24	PER CITY'S COMMENTS – DATED 06/07/24	3	MWH	RCS
06/19/24	PER CITY'S COMMENTS	2	SPW	RCS
03/29/24	PER CITY'S COMMENTS	1	SPW	RCS
11/09/23	SUBMITTED TO CITY OF KANSAS CITY		SPW	RCS

IF THIS IS NOT A BLUE INK SEAL AND THE SIGNATURE IN BLUE INK, THE PLAN IS A COPY AND ANY CONTAINED ALTERNATIONS. THE CERTIFICATION CONTAINED ON THIS DOCUMENT SHALL NOT APPLY TO ANY COPIES UNAUTHORIZED ALTERNATIONS.

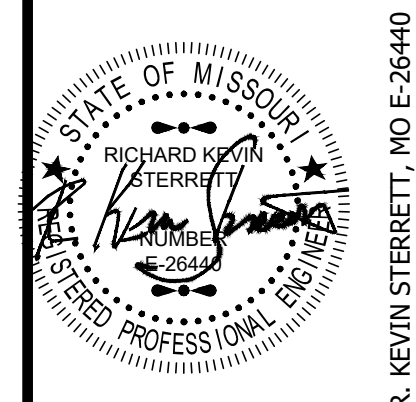

R. KEVIN STERRETT, MO E-26440  
October 01, 2024

**g** **Consult**  
**Inc** **engineers**  
**planners**  
1533 Locust Street, Kansas City, Missouri 64108

1533 Locust Street, Kansas City, Missouri 64108  
CORPORATE LICENSE No. E201000573 (MO.) / E-1736 (KS.) / LS 20190005467

# PRELIMINARY DEVELOPMENT PLANS / PLAT SITE GRADING PLAN

**SHIRAZ CONDOMINIUMS**  
509, 511 & 513 WEST 49TH STREET  
CITY OF KANSAS CITY, JACKSON COUNTY, MISSOURI

<i>X-REF NO.</i> 21-032 Base	
<i>DRAWING NO.</i> 21-032 PDPs	

DATE  
October 01, 2024



JOB NO.  
21-032

C1.02







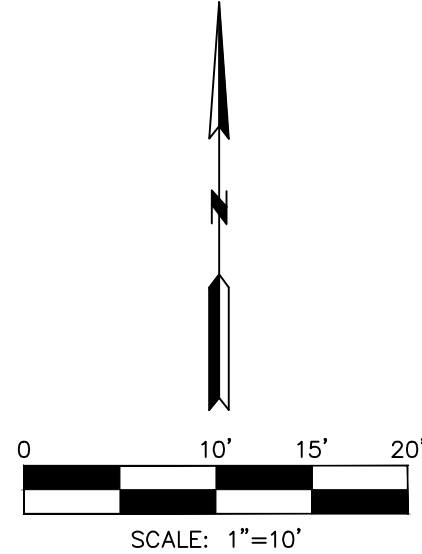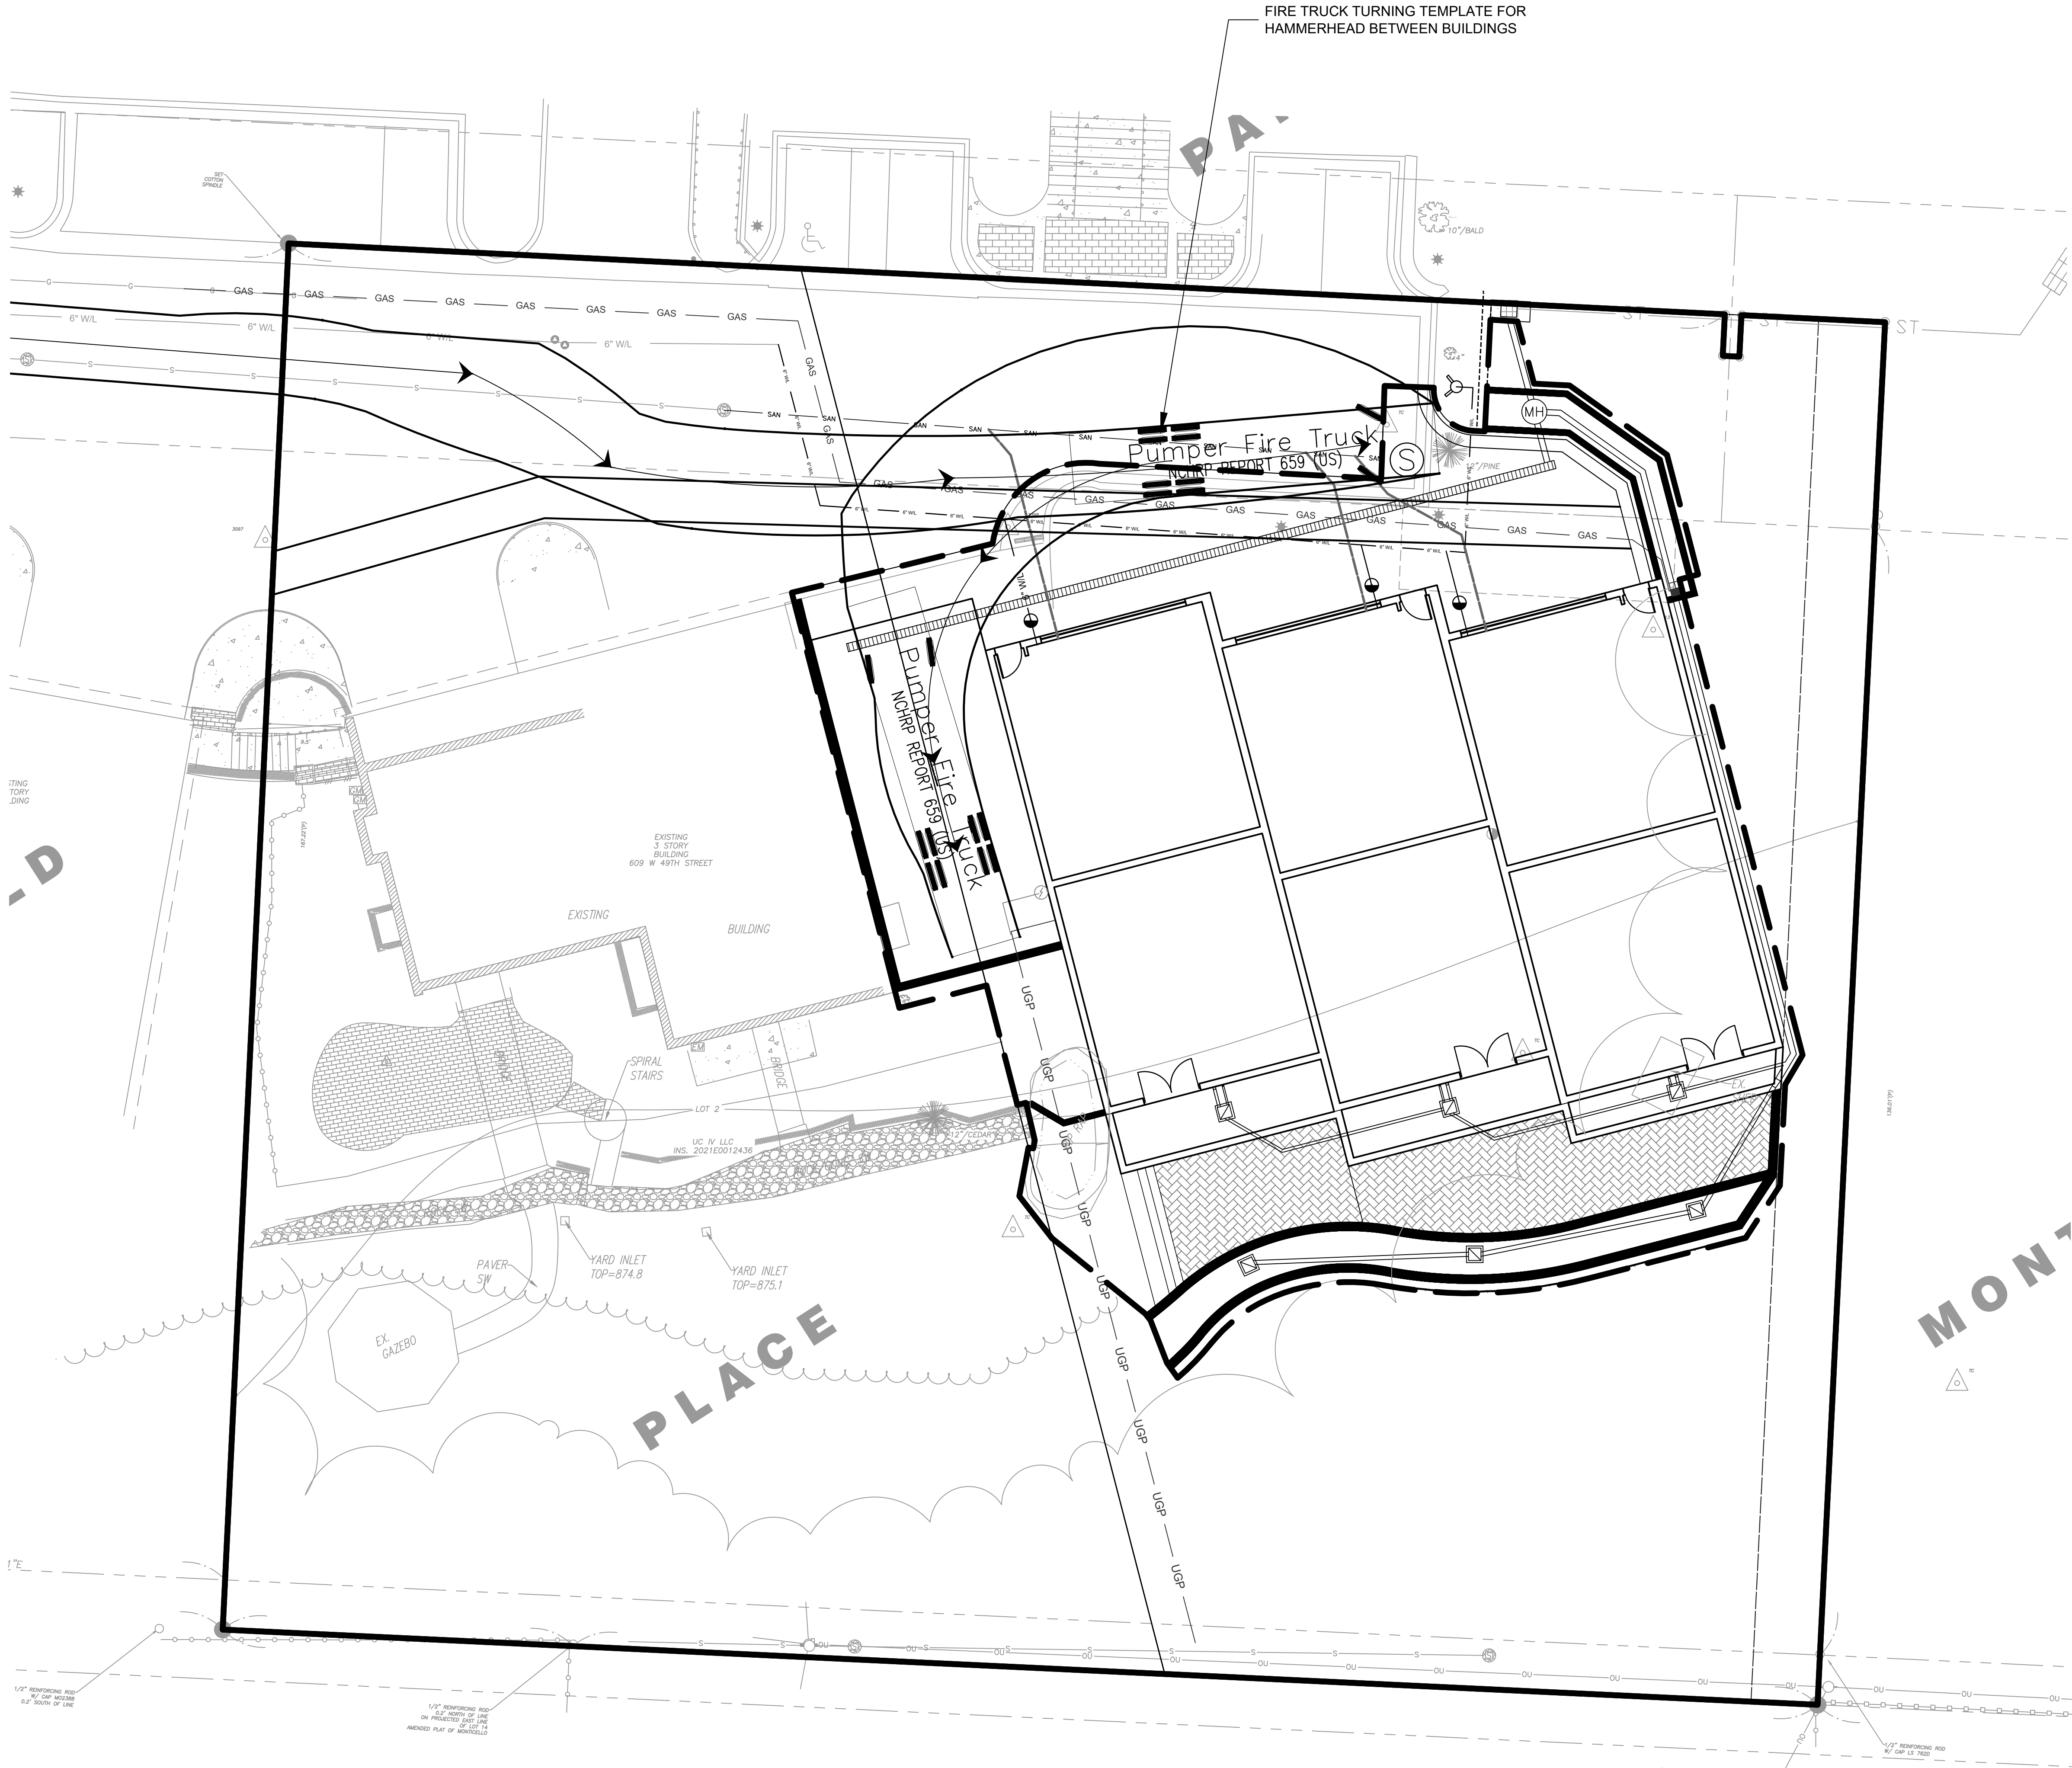

PRELINARY DEVELOPMENT PLANS / PLAT  
FIRE TRUCK TURNING TEMPLATE

SHIRAZ CONDOMINIUMS  
509, 511 & 513 WEST 49TH STREET  
CITY OF KANSAS CITY, JACKSON COUNTY, MISSOURI

X-REF NO.  
21-032 Base  
DRAWING NO.  
21-032 PDPs  
DATE  
October 01, 2024  
JOB NO.  
21-032

C1.04

**ig**consult  
Inc engineers  
planners  
1533 Locust Street, Kansas City, Missouri 64108  
CORPORATE LICENSE No. E201000573 (MO.) / E-1736 (KS.) / LS 2019005467



R. KEVIN STERRETT, NO E-26440  
October 01, 2024

DATE	REVISION	NO.	BY	EX/APP
10/01/24	PER CITY'S COMMENTS - DATED 08/07/24	3	MH	RAS
08/19/24	PER CITY'S COMMENTS	2	SPW	RAS
03/29/24	PER CITY'S COMMENTS	1	SPW	RAS
11/09/23	SUBMITTED TO CITY OF KANSAS CITY			RAS

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VIEW SOUTH FROM  
VACATED 49TH STREET



VIEW SOUTH FROM  
VACATED 49TH STREET



VIEW EAST FROM  
REAR EXISTING CONDO

### EXISTING ROCK SHELF



### RETAINING WALL (TWIN ALIGNMENT)



### RETAINING WALL (SHORT SECTION)

DATE	REVISION	NO.	BY	CHKAPP
06/10/24	PER CITY'S COMMENTS - DATED 08/07/24	3	MMH	BKS
06/19/24	PER CITY'S COMMENTS	2	SPW	BKS
02/28/24	PER CITY'S COMMENTS	1	SPW	BKS
11/02/23	SUBMITTED TO CITY OF KANSAS CITY			

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R. KEVIN STERRETT, MO E-26440  
October 01, 2024

**g** **consult**  
**Inc** **engineers**  
**planners**

1533 Locust Street, Kansas City, Missouri 64108  
CORPORATE LICENSE No. E20100973 (MO.) / E-1736 (KS.) / LS 2019005467

PRELIMINARY DEVELOPMENT PLANS / PLAT  
MISCELLANEOUS DETAILS

**SHIRAZ CONDOMINIUMS**  
509, 511 & 513 WEST 49TH STREET  
CITY OF KANSAS CITY, JACKSON COUNTY, MISSOURI

	X-REF NO.
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**DRAWING NO.**

DATE \_\_\_\_\_

JOB NO.

C3.01




# SHIRAZ TOWNHOMES


603, 605, & 607 W. 49th ST. KANSAS CITY, MO 64112  
20.32



VICINITY MAP

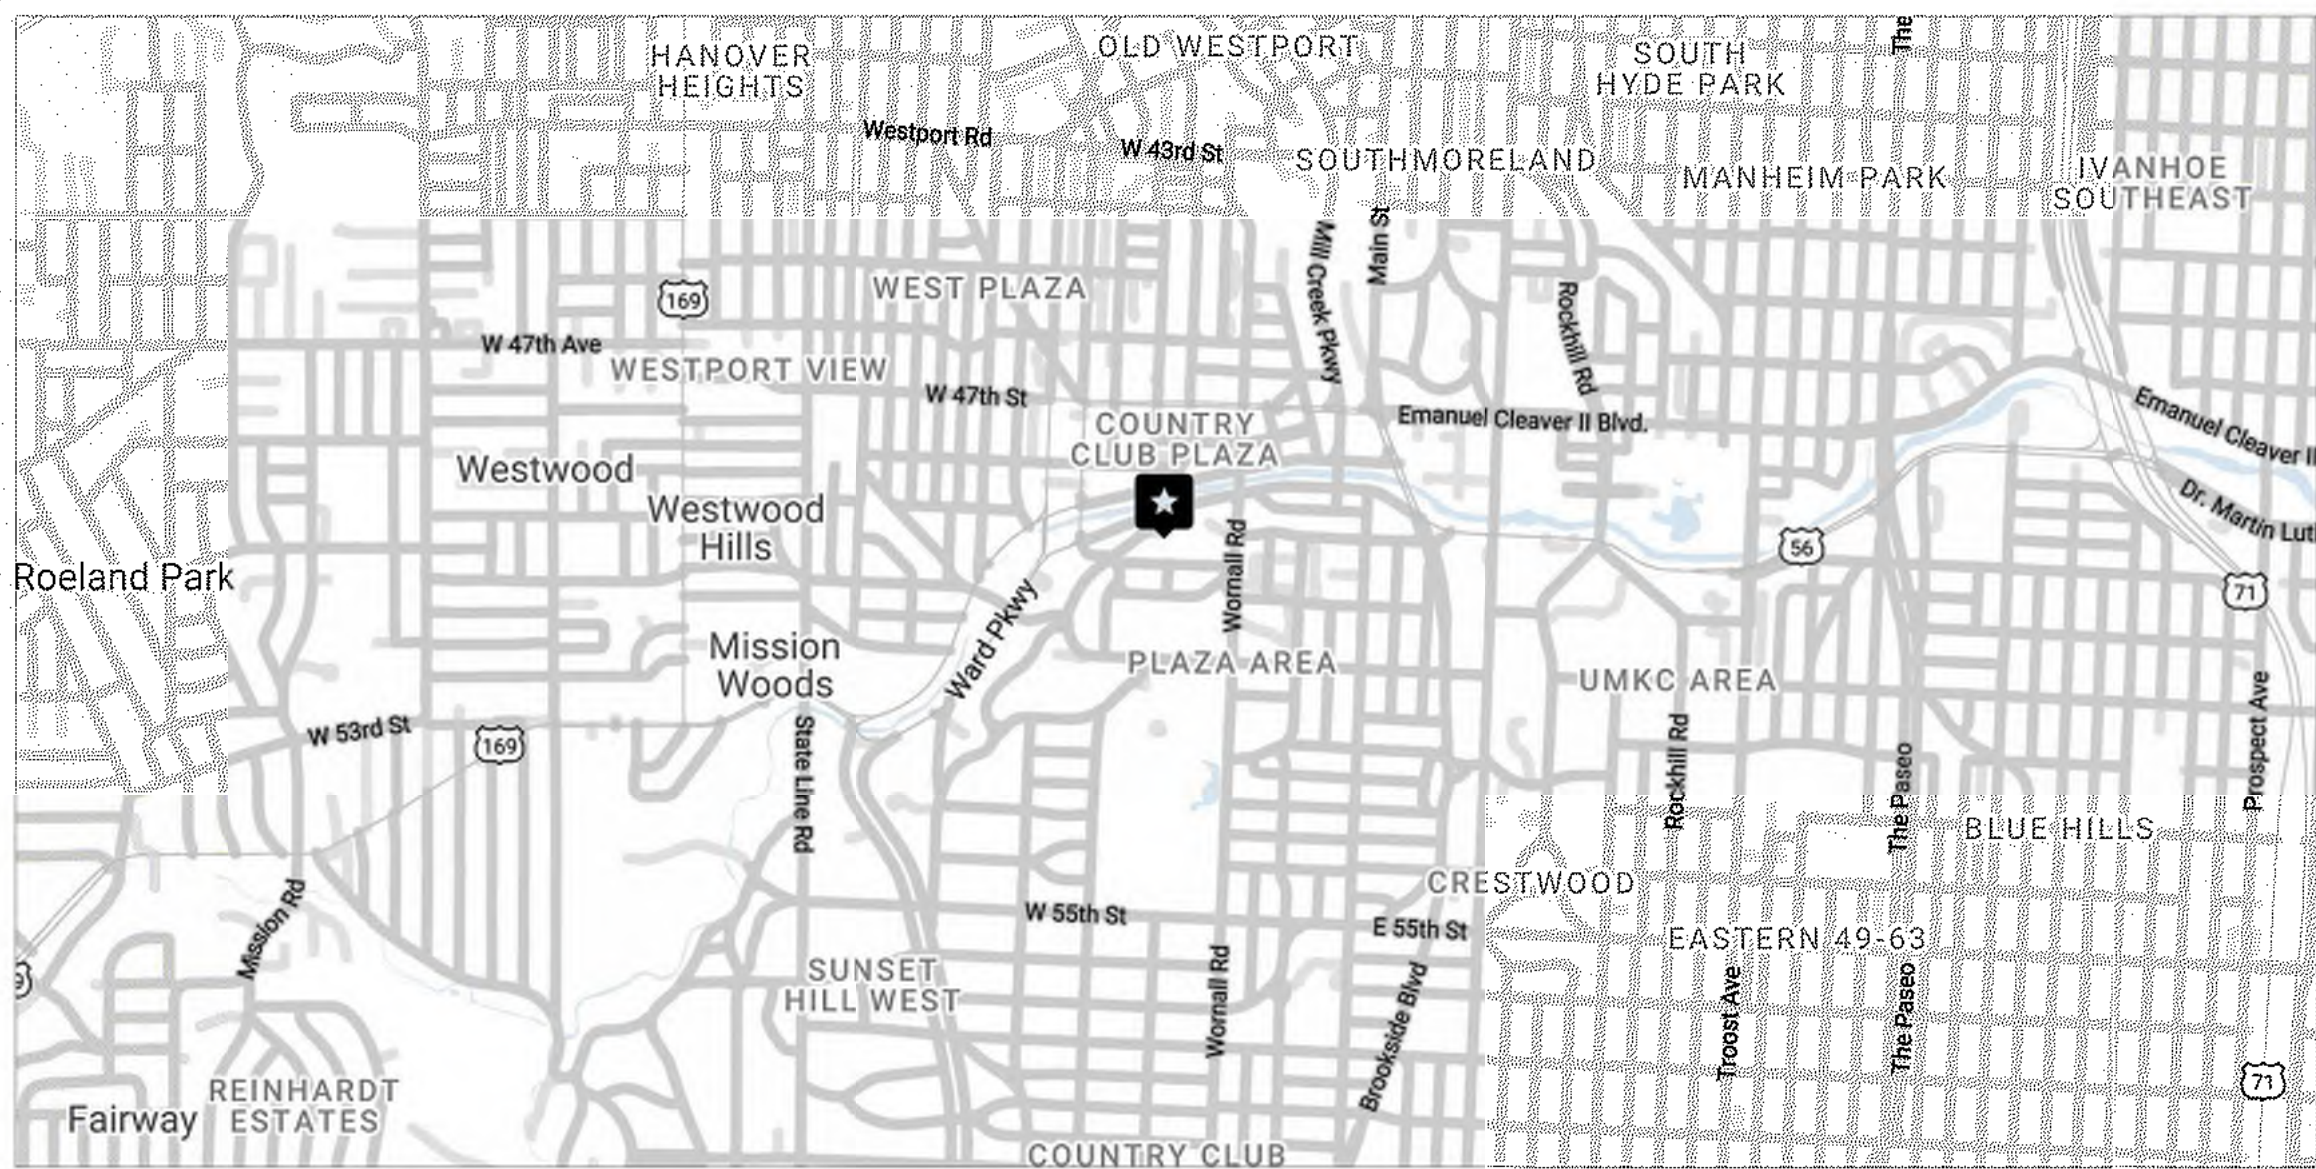

LOCATION MAP

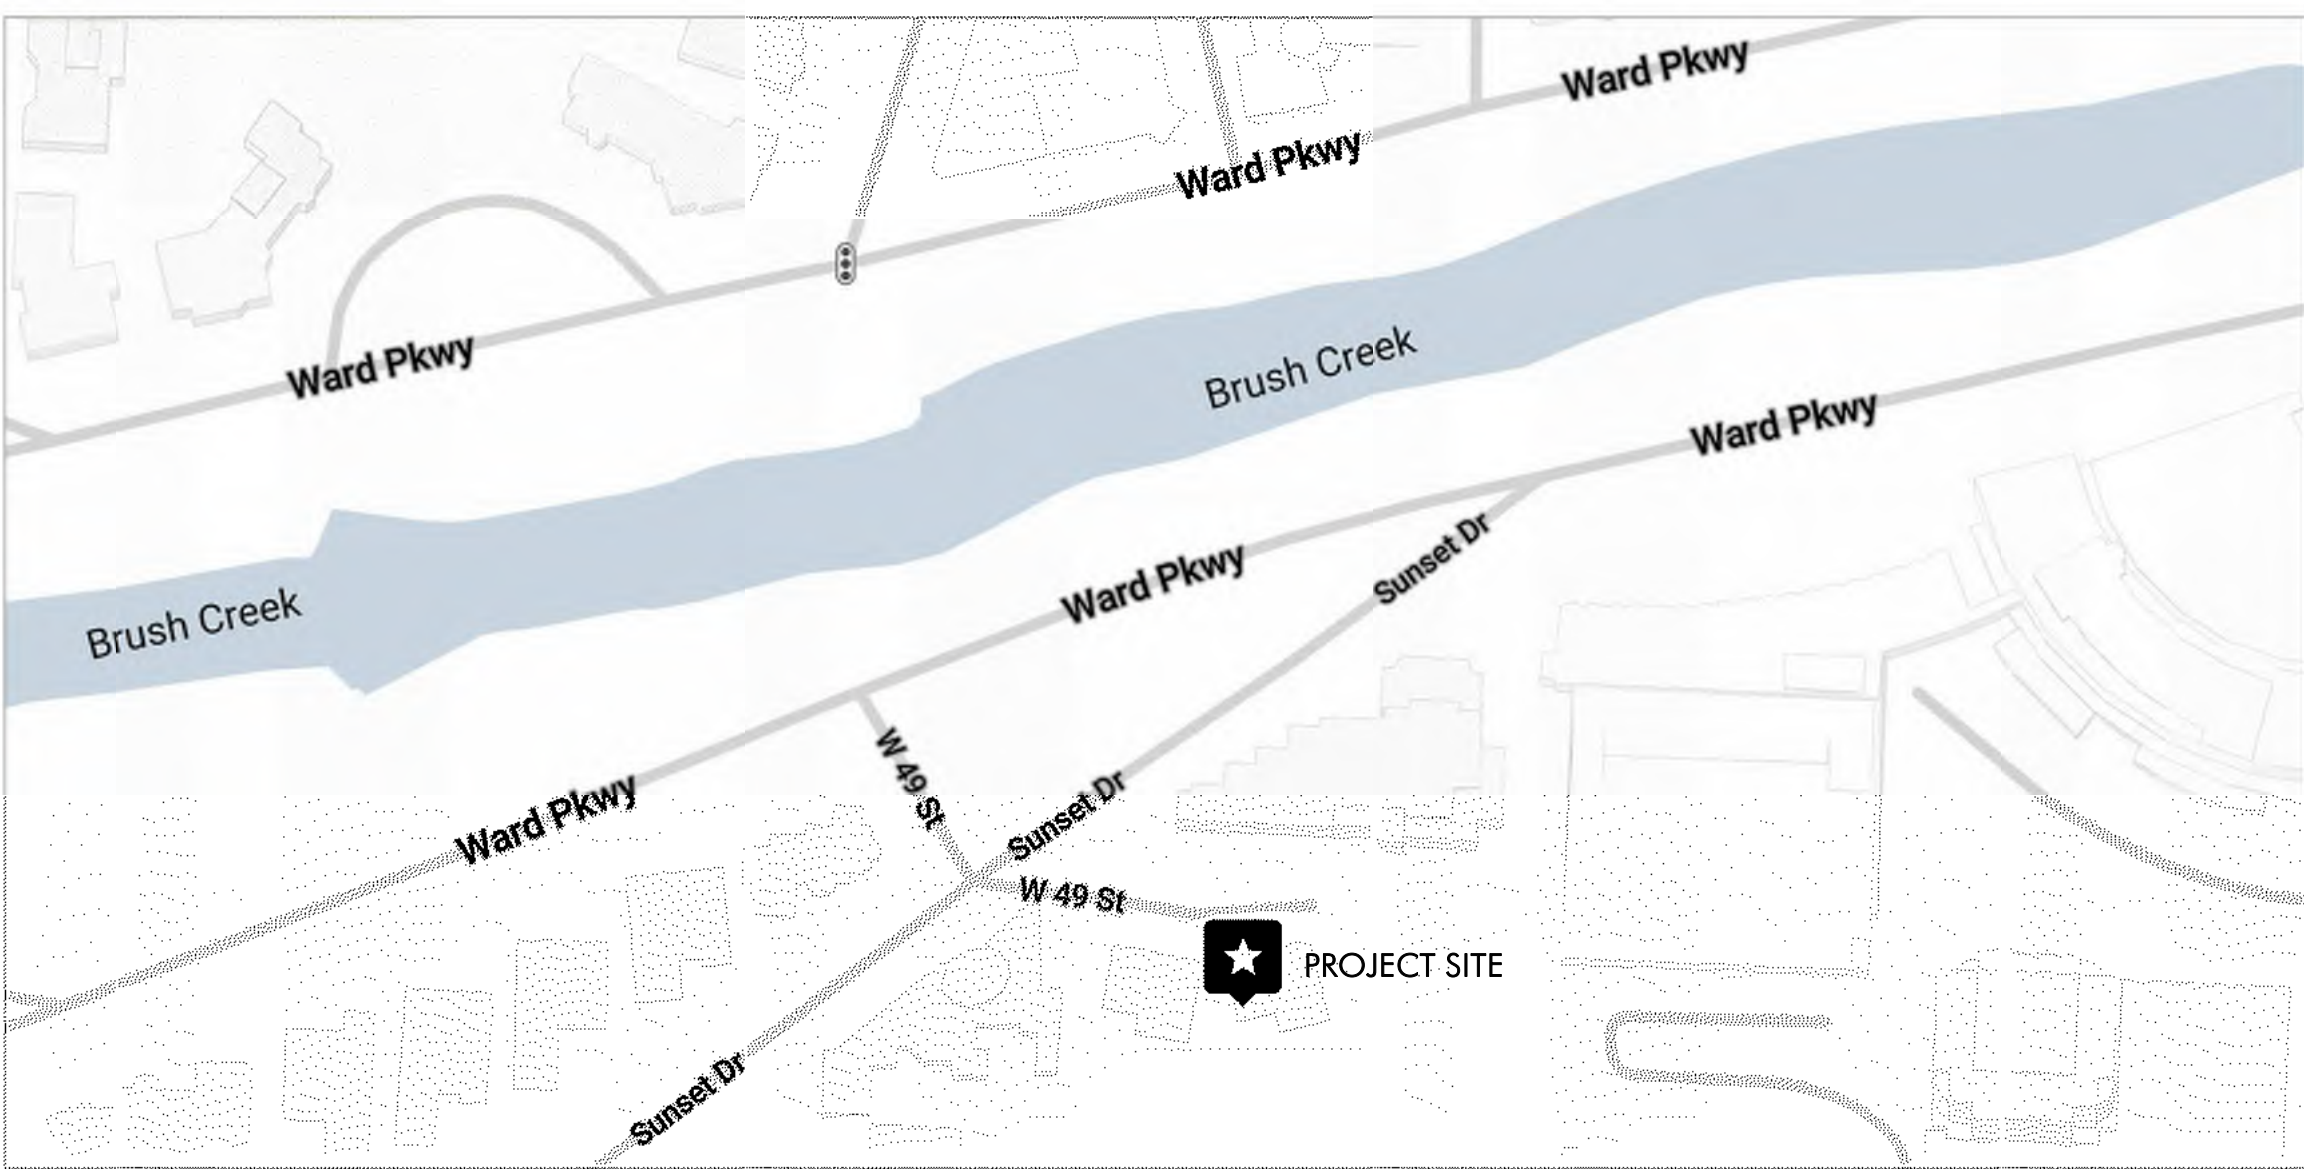

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architecture + design

707 n. 6th street  
kansas city, ks 66101  
www.veritas-ad.com  
913.624.1610

consulting engineer:

FOR REVIEW

SHIRAZ TOWNHOMES

603, 605, & 607 W. 49th ST. KANSAS CITY, MO 64112

REVISIONS

No.	Description	Date

sheet issue date:  
09.27.2024


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20.32

sheet contents:  
TITLE SHEET

sheet no.:  
G101



graphic symbols

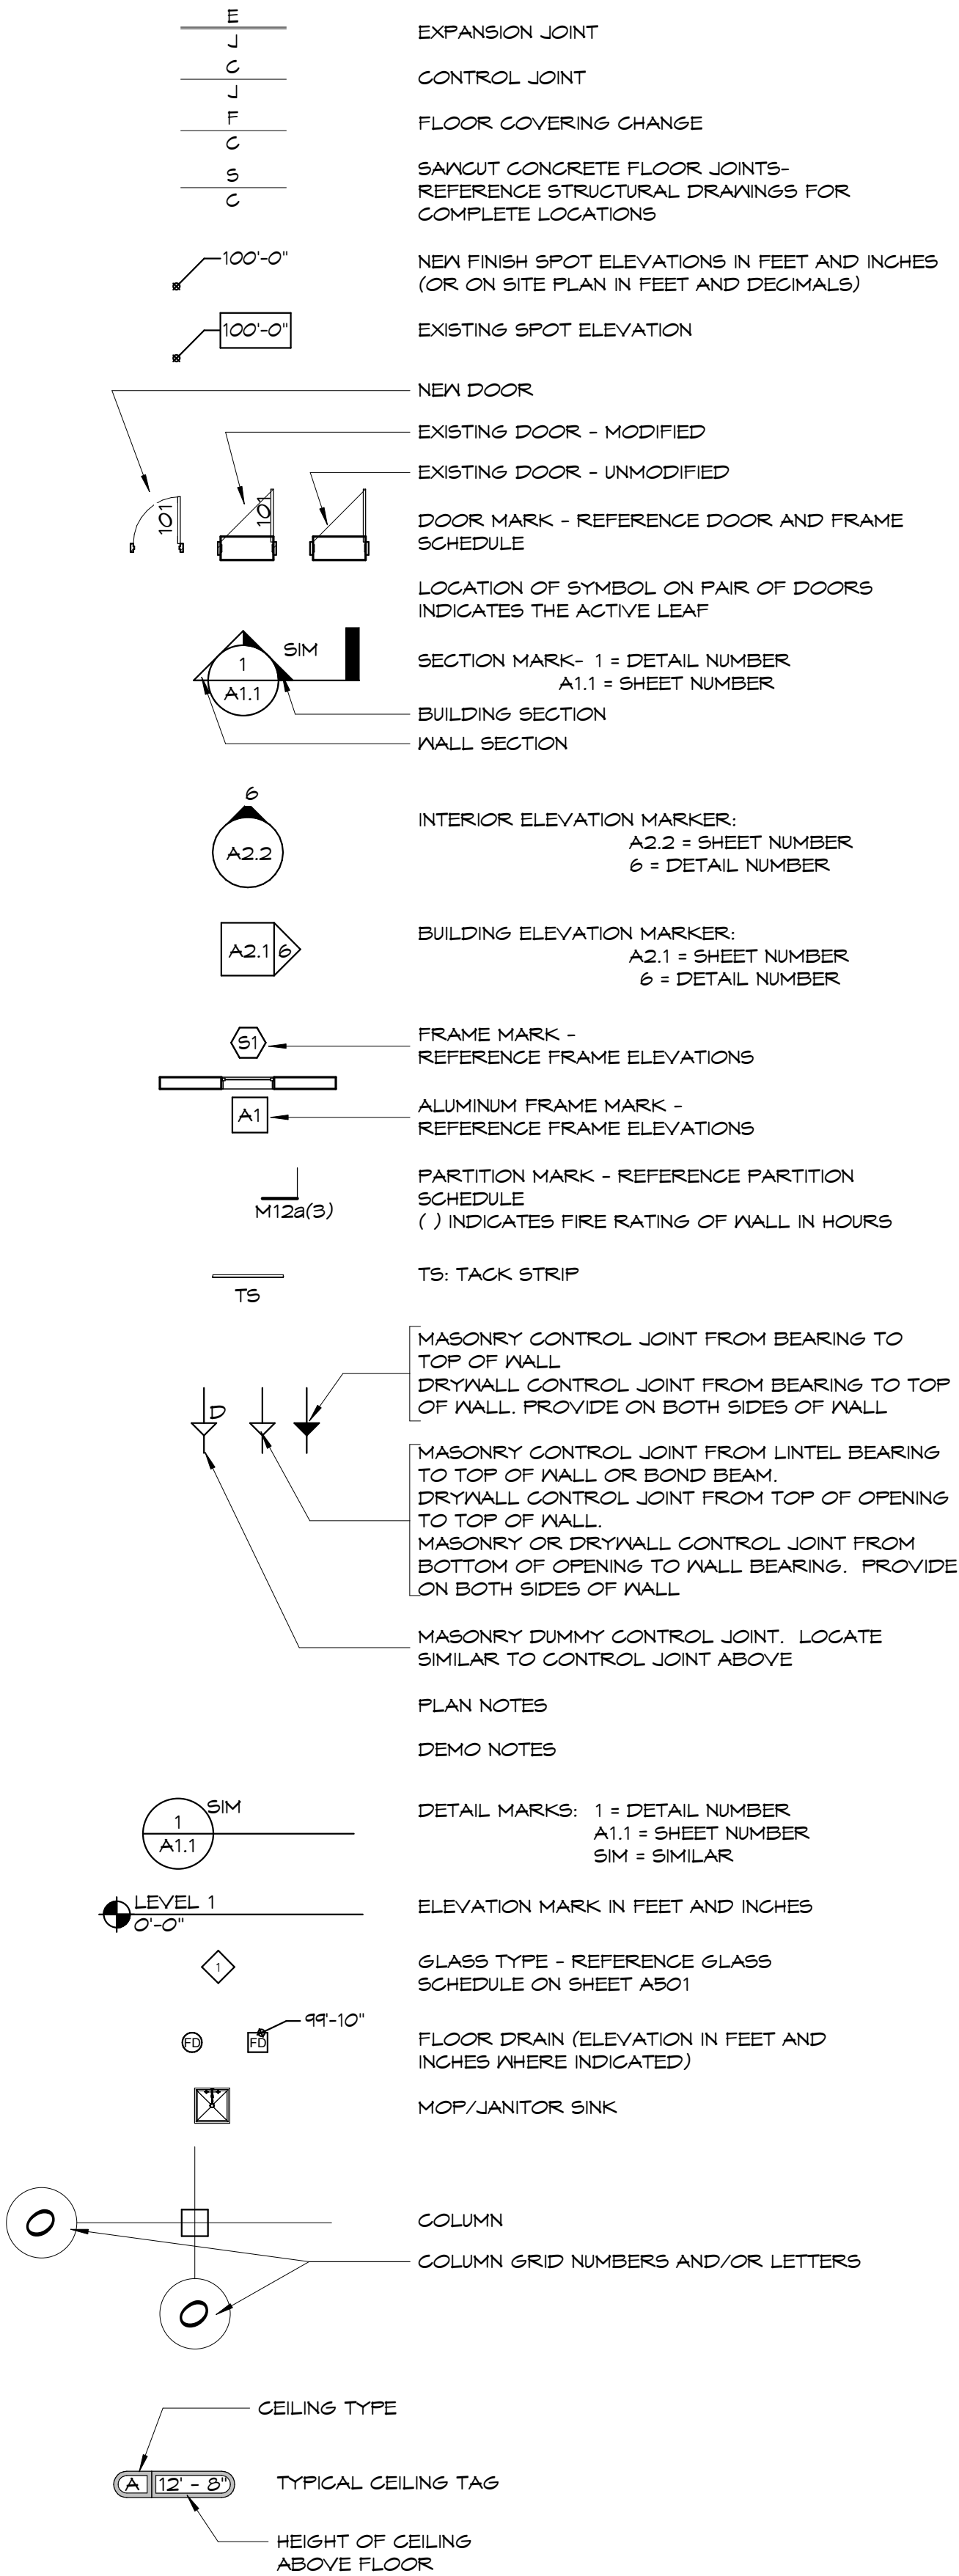

Note: REF. SITE PLAN LEGEND, ROOF PLAN LEGEND AND CEILING PLAN LEGEND FOR ADDITIONAL NOTES AND LEGENDS.

abbreviations

NOTE: REFER TO SPECIFICATIONS FOR ADDITIONAL ABBREVIATIONS OF REFERENCED STANDARDS, REGULATORY AGENCIES, ASSOCIATIONS AND OTHERS

AB	ANCHOR BOLT	MAS	MASONRY
ABV	ABOVE	MAT, MATL	MATERIAL
AD	ACTUAL DIMENSION, ACCESS DOOR	MAX	MAXIMUM
ADJ	ADJACENT	MB	MACHINE
AFF	ABOVE FINISH FLOOR	MC	MECHANICAL CONTRACTOR
AHU	AIR HANDLING UNIT	MDO	MEDIUM DENSITY OVERLAY
ALT	ALTERNATE	MEH	MECHANICAL MECHANISM
ALUM	ALUMINUM	MFSR	MANUFACTURER
ANCH	ANCHOR	MH	MANHOLE
ANGLE	ANGLE	MIN	MINIMUM
ARCH	ARCHITECTURAL	MISC	MISCELLANEOUS
AT	AT	MO	MASONRY OPENING
AVG R	AVERAGE "R" FACTOR FOR INSULATION	MS	MACHINE SCREW
		MTL	METAL
		N	NORTH
B/C	BACK OF CURB	NA	NOT APPLICABLE
BD	BOARD	NC	NOT IN CONTRACT
BLDG	BUILDING	NO #	NUMBER
BM	BENCH MARK	NOM	NOMINAL
BRG	BEARING	NTS	NOT TO SCALE
BTM	BOTTOM	NWCMU	NORMAL WEIGHT CONCRETE MASONRY UNIT
BUR	BUILT-UP ROOFING		
CABT	CABINET	OA	OVERALL
CB	CATCH BASIN	OC(S)	ON CENTER (STAGGERED, IF 2 ROWS)
CH	CHAMFER	OD	OVERFLOW DRAIN
CI	CAST IRON	OFF	OFFICE
CIP	CAST-IN-PLACE	OPER	OPERATOR, OPERABLE, OPERATING
CJ	CONTROL JOINT	OPNG	OPENING
CL	CENTER LINE	OTO	OUT-TO OUT
CLG	CEILING	OZ	OUNCE
CMU	CONCRETE MASONRY UNIT		
CMT	CERAMIC MOSAIC TILE	PARTN	PARTITION
CMP	CORRUGATED METAL PIPE	PBD	PARTICLE BOARD
CO	CLEAN OUT	PC	PORTLAND CEMENT, PIECE
COL	COLUMN	PERIM	PERIMETER
CONC	CONCRETE	PL	PLATE
COND	CONDITION	PLAM	PLASTIC LAMINATE
CONST	CONSTRUCTION	PNL	PANEL
CONT	CONTINUOUS, CONTINUE	PR	PLYWOOD
CR1	COMMUNICATIONS RISER	PR	PAIR
CTSK	COUNTERSUNK	PSF	POUNDS PER SQUARE FOOT
CUH	CABINET UNIT HEATER	PSI	POUNDS PER SQUARE INCH
		PVMT	PAVEMENT
DBL	DOUBLE		
DF	DRINKING FOUNTAIN	QTY	QUANTITY
DIA	DIAMETER	QT	QUARRY TILE
DIM	DIMENSION		
DR	DOOR	R/R	REMOVE & REPLACE
DWG	DRAWING	R	RADIUS
DWG(S)	DRAWING(S)	RA	RETURN AIR
DS(O)	DOWNSPOUT (OUTLET)	RCP	REINFORCED CONCRETE PIPE
DTL	DETAIL	RD	ROOF DRAIN
		REF	REFER TO, REFERENCE
E	EAST	REFL	REFLECTED
EA	EACH	REINF	REINFORCING, REINFORCED
EC	ELECTRICAL CONTRACTOR	REQ'D	REQUIRED
EF	EACH FACE	REV	REVERSED
EJ	EXPANSION JOINT	RJ	RUSTICATION JOINT
ELEG	ELECTRICAL	RMS	ROOMS
EL, ELEV	ELEVATION	RQ	ROUGH OPENING
ENCL	ENCLOSURE	RTU	ROOF TOP UNIT
EQ	EQUAL		
EQUIP	EQUIPMENT	S	SOUTH
E.V.	EACH WAY	SAN	SANITARY
EXP	EXPANSION	SC	SAWCUT
EXT	EXTERIOR, EXTERNAL	SD	SOAP DISPENSER
EXIST EX	EXISTING	SECT	SANITARY
		SF	SQUARE FOOT
FA	FRESH AIR	SFCMU	SPLIT FACE CONCRETE MASONRY UNIT
FD	FLOOR DRAIN	SHT	SHEET
FE	FIRE EXTINGUISHER	SIM	SIMILAR
FEC	FIRE EXTINGUISHER CABINET	SLV	SHORT LEG VERTICAL
FFCO	FLUSH FLOOR CLEANOUT	SMS	SHEET METAL SCREWS
FH	FLAT HEAD	SND	SANITARY NAPKIN DISPENSER
FHG	FIRE HOSE CABINET	SNR	SANITARY NAPKIN RECEPTACLE
FIN	FINISH	SPEC	SPECIFICATION
F	FLOWLINE	SQ	SQUARE
FL, FLR	FLOOR	SS	STAINLESS STEEL
FLRG	FLOORING	STD	STANDARD
FND	FOUNDATION	STL	STEEL
FOS	FACE OF STRUCTURE	STRUCT	STRUCTURAL
FR	FIRE RATED, FIRE RESISTIVE	SUSP	SUSPENSION
FS	FLOOR SINK, FOOD SERVICE	SYM	SYMMETRICAL
FT	FEET OF FOOT		
		TB	TACKBOARD
GA	GAUGE	TDL	TOWEL DISPENSER & DISPOSER (PAPER); OR TRENCH DRAIN
GALV	GALVANIZED	T & G	TONGUE AND GROOVE
GC	GENERAL CONTRACTOR	TEMP	TEMPERED, TEMPORARY
GEN	GENERAL	TEXT	TEXTURED
GI	GALVANIZED IRON	THK	THICK
GL	GLASS	TLT	TOILET
GYP	GYPSUM	TOC	TOP OF CURB OR CONCRETE
		TOS	TOP OF SLAB, STEEL OR STRUCTURE
HB	HOSE BIBB	TP	TOILET PAPER DISPENSER
HC	HANDICAPPED (ACCESSIBLE)	TPL	TWO PERSON LOCKER
HD	HAND DRYER	TWS	TACTILE WARNING SURFACE
HDWE	HARDWARE	TXFR	TRANSFORMER
HD WD	HARD WOOD	TYP	TYPICAL
HM	HOLLOW METAL		
HT	HEIGHT	UNO	UNLESS NOTED OTHERWISE
HORIZ	HORIZONTAL, HORIZONTALLY	US	URINAL SCREEN
HPL	HIGH PRESSURE LAMINATE		
HR	HOUR		
HVAC	HEATING VENTILATING & AIR CONDITIONING		
ID	INSIDE DIAMETER	V.C.P.	VITREOUS CLAY PIPE
INSUL	INSULATION	V.C.T.	VINYL COMPOSITION TILE
INT	INTERIOR	VERT.	VERTICAL, VERTICALLY
INTERM	INTERMEDIATE	V.V.C.	VINYL WALL COVERING
		W	WEST
JB	JUNCTION BOX	W	WITH
JT(S)	JOINT(S)	WC	WATER CLOSET
		WD	WOOD
LB	LOCKER BENCH	WDM	WINDOW
LCS	LIQUID CAULK SURFACE	W/O	WITH OUT
LLV	LONG LEG VERTICAL	WO	WHERE OCCURS
LT HT	LIGHTWEIGHT	WT	WEIGHT
LT	LIGHT	WWF	WELDED WIRE FABRIC
LWCMU	LIGHTWEIGHT CONCRETE MASONRY UNIT	WPS	WATERPROOFING

code notes

BUILDING TYPE: TOWNHOME TRIPLEX  
CONSTRUCTION: V-B  
OCCUPANCY: R  
FIRE SEPARATION: 2 HR UNIT SEPARATION WALL  
FIRE SUPPRESSION: NOT REQUIRED/NOT PROVIDED

- PROJECT TO COMPLY WITH ALL APPLICABLE 2021 INTERNATIONAL RESIDENTIAL CODE REQUIREMENTS AS AMENDED BY THE CITY OF KANSAS CITY MISSOURI
  - NOT LESS THAN ONE OPERABLE EMERGENCY ESCAPE AND RESCUE OPENING SHALL BE PROVIDED AT EVERY BASEMENT, HABITABLE ATTIC, AND EVERY SLEEPING ROOM. THESE SHALL OPEN DIRECTLY INTO A PUBLIC WAY, OR TO A YARD OR COURT THAT OPENS TO A PUBLIC WAY. EMERGENCY ESCAPE OPENINGS SHALL COMPLY WITH SECTION 310 OF THE IRC IN ADDITION TO THE BELOW:
    - EMERGENCY AND ESCAPE RESCUE OPENINGS SHALL HAVE A NET CLEAR OPENING OF NOT LESS THAN 5.7 SQUARE FEET. THE NET CLEAR OPENING SHALL BE PROVIDED AS A PART OF THE NORMAL OPERATION OF THE WINDOW. THE NET CLEAR HEIGHT OF THE OPENING SHALL BE NOT LESS THAN 24 INCHES AND THE NET CLEAR WIDTH SHALL NOT BE LESS THAN 20 INCHES. GRADE FLOOR OPENINGS OR BELOW GRADE OPENINGS MAY HAVE A NET CLEAR OPENING AREA REDUCED TO AN AREA NOT LESS THAN 5 SQUARE FEET
    - EMERGENCY AND ESCAPE RESCUE OPENINGS SHALL HAVE A SILL HEIGHT OF NOT MORE THAN 44 INCHES ABOVE THE FLOOR WHERE THE WINDOW IS ABOVE GRADE. WHERE A WINDOW IS BELOW GRADE, A WINDOW WELL OF GREATER THAN 9 SQUARE FEET AND GREATER THAN 36 INCHES IN WIDTH OR IN LENGTH MUST BE PROVIDED, WHERE THE WINDOW WELL FLOOR IS BELOW GRADE GREATER THAN 44 INCHES, IT MUST BE PROVIDED WITH A LADDER OR STEPS AND DRAINAGE ACCORDING TO R310.2.3
    - AN EMERGENCY ESCAPE AND RESCUE OPENING IS NOT REQUIRED WHERE EXISTING BASEMENTS UNDERGO ALTERATIONS OR REPAIRS, EXCEPT WHERE A NEW SLEEPING ROOM IS CREATED WITHIN AN EXISTING BASEMENT
  - WINDOWS, DOORS, OTHER GLAZING WILL COMPLY WITH THE REQUIREMENTS OF SECTION 308 AND 312.2 OF THE IRC FOR SAFETY GLAZING AND FALL PROTECTION WHERE NEEDED.
    - TEMPERED GLASS REQUIRED IN ALL PANELS OF SWINGING, SLIDING, AND BIFOLD DOORS.
    - TEMPERED GLASS REQUIRED WHERE ADJACENT TO DOOR WHERE THE BOTTOM EXPOSED EDGE OF THE GLAZING IS LESS THAN 60" ABOVE THE FLOOR OR WALKING SURFACE AND:
      - THE GLAZING IS WITHIN 24 INCHES OF EITHER SIDE OF THE DOOR IN THE PLANE OF THE DOOR IN A CLOSED POSITION
      - WHERE THE GLAZING IS ON A WALL LESS THAN 180 DEGREES FROM THE PLANE OF THE DOOR IN A CLOSED POSITION AND WITHIN 24 INCHES OF THE HINGE SIDE OF AN IN-SWINGING DOOR
    - TEMPERED GLASS REQUIRED IN WINDOWS THAT MEET ALL THE FOLLOWING CONDITIONS:
      - THE AREA OF ANY INDIVIDUAL PANE IS LARGER THAN 9 SQUARE FEET
      - THE BOTTOM EDGE OF THE GLAZING IS LESS THAN 18 INCHES ABOVE THE FLOOR
      - THE TOP EDGE OF THE GLAZING IS MORE THAN 36" ABOVE THE FLOOR
      - ONE OR MORE WALKING SURFACES ARE WITHIN 36", MEASURED HORIZONTALLY AND IN A STRAIGHT LINE, OF THE GLAZING.
    - TEMPERED GLASS REQUIRED WHERE USED AS A COMPONENT OF A REQUIRED GUARDRAIL.
  - THE GRADE AND SPECIES OF LUMBER BEING USED IS SPF # 2 UNLESS NOTED OTHERWISE
  - THE MAXIMUM RISE PERMITTED FOR NEW STAIRS IS 7.75 INCHES, AND THE MINIMUM RUN PERMITTED IS 10 INCHES MEASURED NOSE TO NOSE. EXISTING STAIRS MAY REMAIN AS EXISTING IF UNMODIFIED.
  - NEW STAIRS TO HAVE GUARDS ACCORDING TO R312.1 EXISTING GUARDS MAY REMAIN AS EXISTING IF UNMODIFIED
  - NEW STAIRS TO HAVE HANDRAILS ACCORDING TO R311.7.B. EXISTING HANDRAILS MAY REMAIN AS EXISTING IF UNMODIFIED.
  - A WATER-RESISTIVE EXTERIOR WALL COVERINGS PER SECTION 703.2 OF THE IRC WILL BE PROVIDED WHERE SIDING REQUIRED REPAIRS.
  - INTERCONNECTED CARBON MONOXIDE DETECTORS WILL BE INSTALLED PER R315 OUTSIDE OF EACH SEPARATE SLEEPING AREA IN THE IMMEDIATE VICINITY OF THE BEDROOMS. WHERE A FUEL-BURNING APPLIANCE IS LOCATED INSIDE A BEDROOM, A CARBON MONOXIDE ALARM SHALL BE INSTALLED INSIDE THAT BEDROOM.
  - SMOKE DETECTORS WILL BE INSTALLED PER R314. REQUIRED LOCATIONS OF SMOKE ALARMS INCLUDE
    - INSIDE EACH SLEEPING ROOM
    - OUTSIDE EACH SEPARATE SLEEPING AREA IN THE IMMEDIATE VICINITY OF THE BEDROOMS.
    - ON EACH ADDITIONAL STORY OF THE DWELLINGS, INCLUDING BASEMENTS AND HABITABLE ATTICS AND NOT INCLUDING CRAWL SPACES AND UNINHABITABLE ATTICS.
  - SMOKE ALARMS SHALL BE INSTALLED LESS THAN 8 FEET HORIZONTALLY FROM THE DOOR OR OPENING OF A BATHROOM THAT CONTAINS A BATHTUB OR SHOWER UNLESS THIS WOULD PREVENT PLACEMENT OF A SMOKE ALARM REQUIRED BY THIS SECTION.
  - SMOKE ALARMS MUST BE INSTALLED LESS THAN 1FT FROM CEILING WHERE INSTALLED ON A WALL
  - SMOKE ALARMS MUST BE INSTALLED GREATER THAN 2FT FROM ANY HVAC INLET/OUTLET GRILLE
- COMPLY WITH THE PHYSICAL SECURITY ORDINANCE R326. THIS INCLUDES BUT IS NOT LIMITED TO (3) 4" HINGES AND REQUIRED FASTENING, DEADBOLT AND STRIKE SPECIFICATIONS, WINDOW GLAZING FOR ADEQUATE VISION TO EXTERIOR, AND ADEQUATE EXTERIOR LIGHTING.
  - PROVIDE "UFER" GROUND PER IRC SECTION 3603.1

BUILDING ENVELOPE COMPLIANCE CERTIFICATE

- PREScriptive BUILDING ENVELOPE REQUIREMENTS R401.2.1
- ALL COMPONENTS MUST COMPLY TO THIS TABLE
- CODE EDITION: 2021 INTERNATIONAL ENERGY CONSERVATION CODE (IECC)
- CLIMATE ZONE 4A

LOCATION	REQUIRED	PROVIDED
ATTIC SPACE	R-38	NO ATTIC
CONCEALED DUCTS	R-8	R-8
FLOORS	R-30	NA
FENESTRATION U-FACTOR	U ≤ 0.30	U ≤ 0.25
GLAZED FENESTRATION SHGC	SHGC ≤ 0.40	SHGC ≤ 0.24
ROOF / CEILING	R-60 CONTINUOUS	R-60 CONTINUOUS
SLAB	R-10 FOR 4'-0"	R-10 CONTINUOUS
WALLS - WOOD FRAME	R-20+5ci or 13+10ci	R-23 + 9ci or R-19 + 12ci
MASS WALLS	R-8 or R-13	R-13.5
BASEMENT WALL	10ci or R-13	12.4ci

\*WHERE MORE THAN HALF OF THE INSULATION IS ON THE INTERIOR OF THE MASS WALL

general notes

- GENERAL CONTRACTOR SHALL NOTIFY THE ARCHITECT OF ANY DISCREPANCIES BETWEEN ARCHITECTURAL AND STRUCTURAL DRAWINGS, AND BETWEEN MULTIPLE DRAWINGS. THE ARCHITECT WILL DETERMINE WHICH SHALL GOVERN.
- GENERAL CONTRACTOR SHALL VERIFY ALL DIMENSIONS AND CONDITIONS OF THE JOB SITE INCLUDING UTILITIES AND EXISTING STRUCTURES PRIOR TO BEGINNING WORK AND REPORT ANY DISCREPANCIES TO THE ARCHITECT.
- GENERAL CONTRACTOR SHALL BE RESPONSIBLE FOR STABILITY OF THE STRUCTURE DURING CONSTRUCTION INCLUDING ALL SHORING AND BRACING REQUIRED TO RESIST REQUIRED VERTICAL AND LATERAL FORCES.
- ALL ARCHITECTURAL FLOOR PLAN DIMENSIONS ARE FROM FACE OF CONCRETE OR FACE OF STUD.
- INTERIOR WALLS ARE TO BE COMPRISED OF 2x4 STUDS AT 16" O.C. MAX WITH 1/2" DRYWALL EACH SIDE UNLESS NOTED OTHERWISE.
- MECHANICAL/PLUMBING SCOPES ARE DESIGN/BUILD. DESIGN TO BE PROVIDED BY SUB-CONTRACTOR TO MEET OR EXCEED CODE REQUIREMENTS; CONTRACTOR TO COORDINATE EACH OTHERS' WORK WITH ARCHITECTURAL PLANS AND TO NOTIFY ARCHITECT OF NEED FOR SOFFITS OR CHASES FOR INSTALLATION OF DUCTWORK OR PLUMBING.
- ELECTRICAL SCOPES ARE DESIGN/BUILD. DESIGN TO BE PROVIDED BY SUB-CONTRACTOR TO MEET OR EXCEED CODE REQUIREMENTS; CONTRACTOR TO INSTALL OUTLETS AS REQUIRED PER CODE. VERIFY ALL LOCATIONS WITH OWNER PRIOR TO BEGINNING DRYWALL.
- COORDINATE ALL WALLS AND DIMENSIONS ON ARCHITECTURAL DRAWINGS WITH STRUCTURAL DRAWINGS.



707 n. 6th street  
kansas city, ks 66101  
www.veritas-ad.com  
913.624.1610

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INFORMATION

sheet no.:

G201







sheet no.:

#### 4 AREA SEPARATION FIREWALL DETAILS



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BXUV.U347 - Fire-resistance Ratings - ANSI/UL 263

Design/System/Construction/Assembly Usage Disclaimer

- Authorities Having Jurisdiction should be consulted in all cases as to the particular requirements covering the installation and use of UL Certified products, equipment, system, devices, and materials.
- Authorities Having Jurisdiction should be consulted before construction.
- Fire resistance assemblies and products are developed by UL for compliance with applicable requirements. The published information cannot always address every construction nuance encountered in the field.
- When field issues arise, it is recommended the first contact for assistance be the technical service staff provided by the product manufacturer noted for the design. Users of fire resistance assemblies are advised to consult the general Guide Information for each product category and each group of assemblies. The Guide Information includes specifics concerning alternate materials and alternate methods of construction.
- Only products which bear UL's Mark are considered Certified.

Fire-resistance Ratings - ANSI/UL 263







BXUV - Fire Resistance Ratings - ANSI/UL 263 Certified for United States  
BXUV7 - Fire Resistance Ratings - CANULC-S101 Certified for Canada

See General Information for Fire Resistance Ratings - ANSI/UL 263 Certified for United States  
Design Criteria and Allowable Variations  
See General Information for Fire Resistance Ratings - CANULC-S101 Certified for Canada  
Design Criteria and Allowable Variations


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May 30, 2022


- Nonbearing Wall Rating — 2 Hr (See Items 5, 5A and 5B) (Separation Wall, See Items 1,2 and 3)  
Bearing Wall Rating 2 Hr (Protected Wall, See Items 5 and 5A)  
Nonbearing Wall Rating 2 Hr (Protected Wall, See Item 5, 5A and 5B)  
Finish Rating — 120 Min (See Item 5)  
STC Ratings — 61, 69, 70 (See Items 8, 8A and 8B)  
\* Indicates such products shall bear the UL or cUL Certification Mark for jurisdictions employing the UL or cUL Certification (such as Canada), respectively.

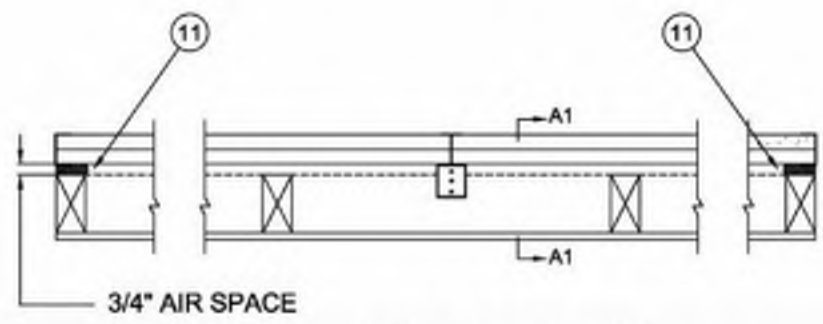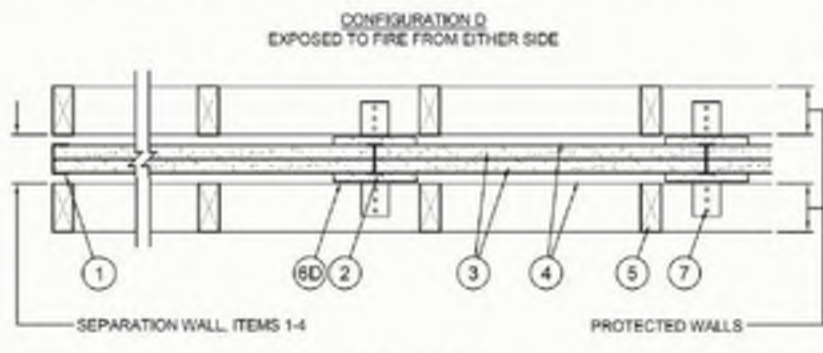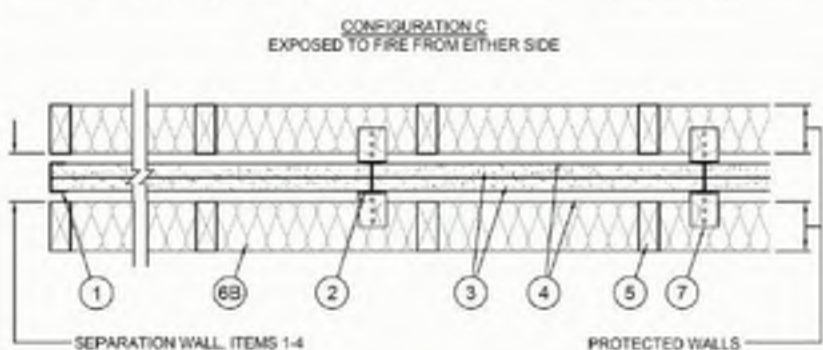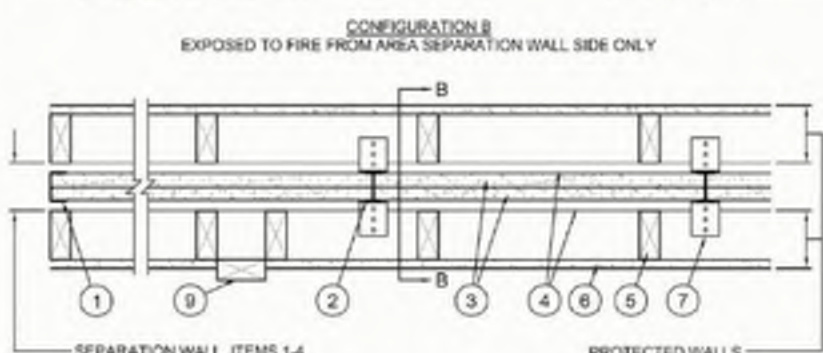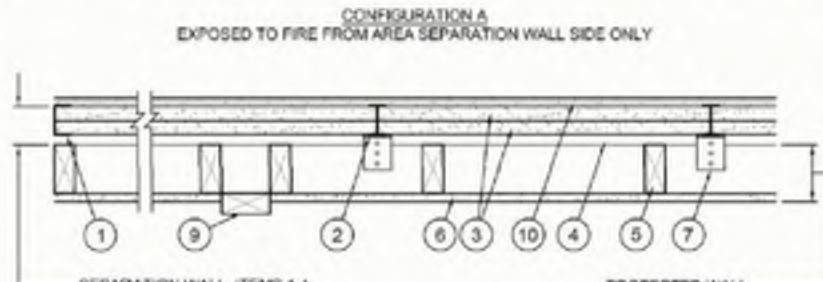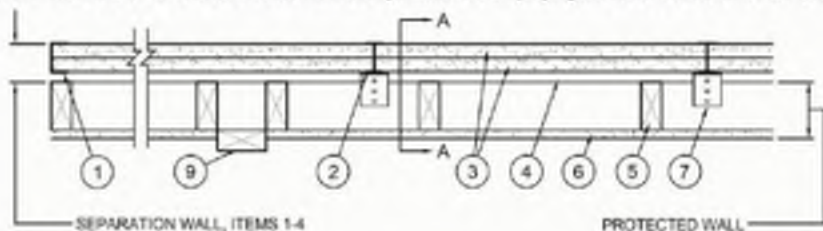

CONFIGURATIONS A and C  
EXPOSED TO FIRE FROM AREA SEPARATION WALL ONLY

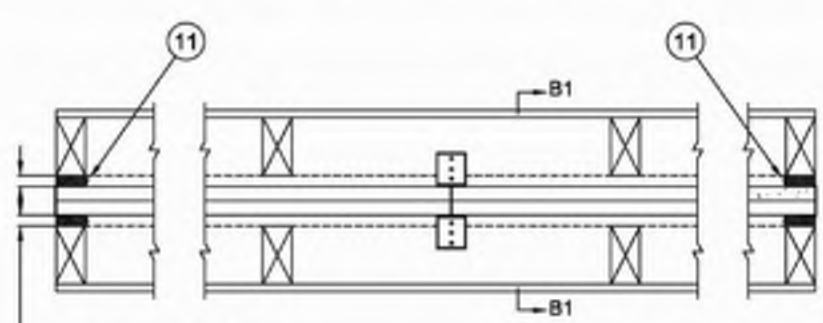

CONFIGURATIONS B and D  
EXPOSED TO FIRE FROM EITHER SIDE

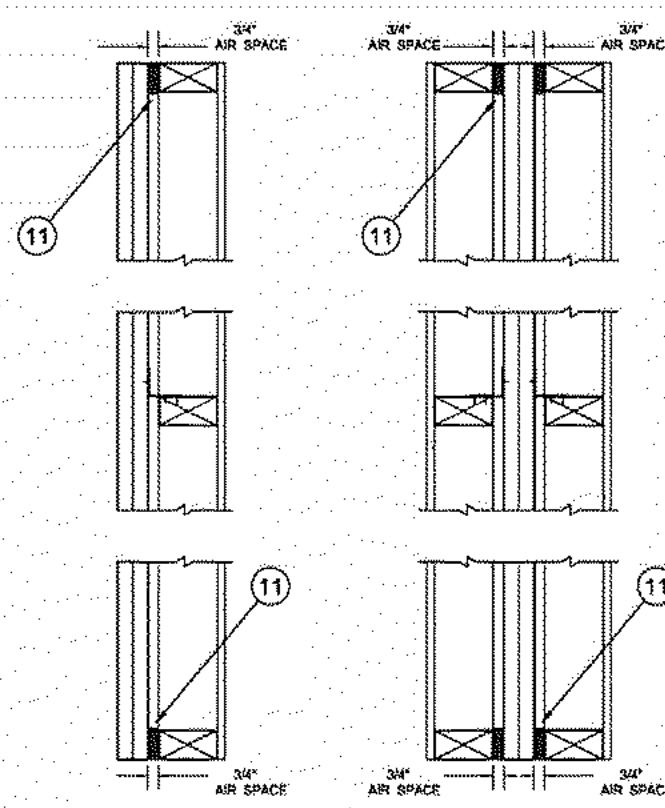

SECTION A1-A1

SECTION B1-B1

SEPARATION WALL: Non-bearing, Max Height - 66 ft - see Item 8)

1. **Steel Track** — Floor, sidewall or top wall track: Nom 2 in wide channel shaped with nom 1 in, long legs, formed from No. 25 MSG galv steel, secured with suitable fasteners spaced 24 in. OC.
2. **Steel Studs** — "H" shaped studs formed from No. 25 MSG galv steel having an overall depth of approximately 2 in, and flange width 1-3/8 in.
3. **Gypsum Board\*** — Two layers of 1 in, thick gypsum wallboard liner panels, supplied in nom 24 in widths. Vertical edges of panels friction fit into "H" shaped studs.  
**NATIONAL GYPSUM CO** — Types FSW, FSW-A, FSW-1, FSW-9

PROTECTED WALL: Bearing or Nonbearing Wall, as indicated in Items 4, 4A and 4B. When Bearing, Load Restricted for Canadian Applications — See Guide B0027)

4. **Air Space** — Minimum 3/4-in. air space.

5. **Wood Studs** — For Bearing or Nonbearing Wall Rating — Nom 2 by 4 in, max spacing 24 in. OC. Studs cross braced at mid-height where necessary for clip attachment. Min 3/4 in. separation between wood framing and fire separation wall. Finish rating evaluated for wood studs only.

5A. **Steel Studs** — (As an alternate to Item 5, not shown) — For Bearing Wall Rating — Corrosion protected steel studs, min No. 20 MSG 0.0329 in, min bare metal thickness steel or min 3- 1/2 in. wide, min No. 20 GSG 0.036 in, thick galv steel or No. 20 MSG 0.033 in, thick primed steel, cold formed, shall be designed in accordance with the current edition of the Specification for the Design of Cold-Formed Steel Structural Members by the American Iron and Steel Institute. All design details enhancing the structural integrity of the wall assembly, including the axial design load of the studs, shall be as specified by the steel stud designer and/or producer, and shall meet the requirements of all applicable local code agencies. The max stud spacing of wall assemblies shall not exceed 24 in. OC. Studs attached to floor and ceiling tracks with 1/2 in, long Type S-12 steel screws on both sides of studs or by welded or bolted connections designed in accordance with the AISI specifications. Top and bottom tracks shall consist of steel members, min No. 20 MSG 0.0329 in, min bare metal thickness steel or min No. 20 GSG 0.036 in, thick galv steel or No. 20 MSG 0.033 in, thick primed steel, that provide a sound structural connection between steel studs, and to adjacent assemblies such as a floor, ceiling, and/or other walls. Attached to floor and ceiling assemblies with steel fasteners spaced not greater than 24 in. OC. Studs cross-braced with stud framing at midheight where necessary for clip attachment. Min 3/4 in. separation between steel framing and area separation wall. Finish rating has not been evaluated for Steel Studs.

5B. **Steel Studs** — (As an alternate to Items 5 and 5A, for use in Configuration B only, not shown) — For Nonbearing Wall Rating — Channel shaped, fabricated from min 25 MSG corrosion-protected steel, min 3-1/2 in. wide, min 1-1/4 in. return, spaced a max of 24 in. OC. Studs to be cut 3/8 to 3/4 in. less than assembly height. Top and bottom tracks shall be channel shaped, fabricated from min 25 MSG corrosion-protected steel, min width to accommodate stud size, with min 1 in, long legs, attached to floor and ceiling with fasteners 24 in. OC max. Studs cross-braced with stud framing at midheight where necessary for clip attachment. Min 3/4 in. separation between steel framing and area separation wall. Finish rating has not been evaluated for Steel Studs.

6. **Gypsum Board** — **Classified or Unclassified** — Min 1/2 in, thick, 4 ft wide, applied horizontally or vertically. Wallboard attached to wood studs (Item 5) with 1-1/4 in, long steel drywall screws spaced 12 in. OC. Wallboard attached to steel studs (Item 5A or 5B) with 1 in, long Type 5 steel screws spaced 12 in. OC. Vertical joints located over studs. Horizontal joints shall be butted tight to form a closed joint. As an option, joints covered with paper tape and joint compound. As an option, screw heads covered with joint compound.

6A. **Plywood Sheathing or OSB** — (not shown) — As an alternate to Item 6, Min 1/2 in, thick plywood or OSB applied horizontally or vertically to wood or steel studs. Vertical joints located over studs. Horizontal joints shall be butted tight to form a closed joint. Fastened to studs with nails or screws of sufficient length, spaced 12 in. OC. Joints and fastener heads are not required to be treated. Aluminum clips shall be spaced as described in Item 7.

6B. **Batts and Blankets\*** — (Not shown) — As an alternate to Items 6 and 6A, Glass fiber or mineral wool insulation, min 3-1/2 in, thick, placed to completely fill the wood or steel stud cavities. When Batts and Blankets are used in place of Items 6 and 6A, the max height is 54 ft and the aluminum clips (Item 7) shall be spaced a max of 5 ft OC vertically. Min 3/4 in. separation between insulation and area separation wall. See Batts and Blankets (BKNV) category in the Building Materials Directory and Batts and Blankets (BZ JZ) category in the Fire Resistance Directory for name of Classified Companies.

6C. **Wall and Partition Facings and Accessories\*** — (not shown) — As an alternate to Items 6A and 6B, 4 ft wide panels, applied vertically. Panels attached to wood studs (Item 4) with 1-5/8 in, long steel drywall screws spaced 16 in. OC. Vertical joints located over studs. Joints covered with paper tape and joint compound. As an option, screw heads covered with joint compound.

**NATIONAL GYPSUM CO** — Type SoundBlock Gypsum Board.  
**PARCO BUILDING PRODUCTS L LC, DBA PARCO GYPSUM** — Types QuietRock QR-520, QuietRock QR-510, QuietRock QR-525

6D. **Gypsum Board\*** — As an alternate to Item 6 - Min 5/8 in, thick, min. 6 in, wide batten strips, applied on both sides of Steel Studs (Item 2) and horizontal back to back Steel Track (Item 1). Min 5/8 in, thick, min. 3 in, wide batten strips applied on both sides of single Steel Track (Item 1) at perimeter of assembly. Batten strips secured to studs with 1-1/4 in, long Type 5 steel screws spaced 12 in. OC. Batten joints shall be butted tight to form a closed joint. As an option, entire sheet of gypsum board may be used in lieu of the battens. Clip placement as in Item 7, 7A, 7B, or 7C.  
**NATIONAL GYPSUM CO** — Type FSW-3, FSW, FSW-A.

6E. **Fiber, Sprayed\*** — Optional - Not Shown - Spray applied cellulose material. The fiber is applied with water to completely fill the enclosed cavity in accordance with the application instructions supplied with the product with a nominal dry density of 2.7 lb/ft<sup>3</sup>. Alternate Application Method: The fiber is applied without water or addition of a nominal dry density of 3.5 lb/ft<sup>3</sup> in accordance with the application instructions supplied with the product.  
**U S GREENTRIER L LC** — SANCETURRY, FRM, INS73S, NS74S and INS76SLD for use with wet or dry application, INS53SLD, INS54SLD, INS55SLD, INS76SLD and INS77SLD are to be used for dry application only.

7. **Aluminum Clips** — Aluminum angle, 0.049 in, thick, 2 in, wide with 2 in, and 2-1/2 in, legs. Clips secured with Type S screws 3/8 in, long to "H" studs and with 1-1/4 in, long screws to wood framing or steel framing through holes provided in clips.

7A. Clip placement for separation walls up to 23 ft High: Space clips a max of 10 ft OC vertically between wood or steel framing and "H" studs.

7B. Clip placement for separation walls up to 54 ft High: Space clips as described in Item 6A for upper 24 ft. Remaining wall area below requires clips spaced a max of 5 ft OC vertically between wood or steel framing and "H" studs.

7C. Clip placement for separation walls up to 66 ft High: Space clips as described in Item 6A for upper 24 ft. Space clips as described in Item 6B for middle 30 ft. Remaining wall area below requires clips spaced a max of 39 in. OC vertically between wood or steel framing and "H" studs.

8. **STC Rating** — The STC Rating of the wall assembly is 61 when it is constructed as described by Items 1 through 6, except:  
A. Item 5, above — Wood Studs — Shall be spaced 16 in. OC.

B. Item 6, above — Gypsum Board — Min. weight 1.5 pcf. Shall be applied vertically and attached to studs with 1-1/4 in, long steel drywall screws spaced 16 in. OC. Joints and screwheads shall be covered with paper tape and joint compound.

C. Item 7, above — Aluminum Clips — Spaced a max of 10 ft OC vertically.

D. Batts and Blankets\* — The cavities formed by the wood studs shall be friction fit with 3-1/2 in, thick fiberglass insulation batts, min. 0.80 pcf. See Batts and Blankets (BKNV) category in the Building Materials Directory and Batts and Blankets (BZ JZ) category in the Fire Resistance Directory for name of Classified Companies.

E. Max Height of Separation Wall is 23 ft.

F. The STC rating applies to Configuration B only.

G. Steel Studs (Items 5A, 5B), Plywood Sheathing or OSB (Item 5A and Item 9) and Batts and Blankets (Items 6B) not evaluated as alternatives for obtaining STC rating.

9A. **STC Rating** — The STC Rating of the wall assembly is 69 when it is constructed as described by Items 1 through 6, except:  
A. Item 5, above — Wood Studs — Shall be spaced 16 in. OC.

B. Item 6C, above — Wall and Partition Facings and Accessories\* — Type QuietRock QR-525 panels shall be installed.

C. Item 7, above — Aluminum Clips — Spaced a max of 10 ft OC vertically.

D. Batts and Blankets\* — The cavities formed by the wood studs shall be friction fit with 3-1/2 in, thick fiberglass insulation batts, min. 1.0 pcf. See Batts and Blankets (BKNV) category in the Building Materials Directory and Batts and Blankets (BZ JZ) category in the Fire Resistance Directory for name of Classified Companies.

E. Max Height of Separation Wall is 23 ft.

F. The STC rating applies to Configuration B only.

G. Steel Studs (Items 5A, 5B), Plywood Sheathing or OSB (Item 6A and Item 10) and Batts and Blankets (Items 6B) not evaluated as alternatives for obtaining STC rating.

9B. **STC Rating** — The STC Rating of the wall assembly is 70 when it is constructed as described by Items 1 through 7, except:  
A. Item 5, above — Wood Studs — Shall be spaced 16 in. OC.

B. Item 6C, above — Wall and Partition Facings and Accessories\* — Type QuietRock QR-525 panels shall be installed as described in Item 5C.

C. Item 7, above — Aluminum Clips — Spaced a max of 10 ft OC vertically.

D. Batts and Blankets\* — The cavities formed by the wood studs shall be friction fit with 3-1/2 in, thick fiberglass insulation batts, min. 1.0 pcf. See Batts and Blankets (BKNV) category in the Building Materials Directory and Batts and Blankets (BZ JZ) category in the Fire Resistance Directory for name of Classified Companies.

E. Max Height of Separation Wall is 23 ft.

F. The STC rating applies to Configuration B only.

G. Steel Studs (Items 5A, 5B), Plywood Sheathing or OSB (Item 6A and Item 10) and Batts and Blankets (Items 6B) not evaluated as alternatives for obtaining STC rating.

9. **Non-Bearing Wall Partition Intersection** — (Optional) Wall system consisting of nominal 2 by 4 in. stud or nominal 2 by 6 in. stud. Maximum one non-bearing wall partition intersection per stud cavity.

10. **Plywood Sheathing or OSB** — (Optional) — Min 1/2 in, thick plywood or OSB applied horizontally or vertically to "H" studs on area separation wall side of Configuration B. Vertical joints located over studs. Fastened to "H" studs with screws of sufficient length, spaced a maximum of 12 in. OC.

11. **Caulking and Sealants\*** — (Optional) - Intended for use as an air barrier - Not evaluated as fireblocking) - A bead of sealant applied around the partition perimeter in the 3/4 in, air space between wood framing (Item 5) and shaftliner panels (Item 3) to create an air barrier.

**DUPONT DE NEMOURS, INC.** — Great Stuff Gaps & Cracks, Great Stuff Pro Gaps & Cracks, Great Stuff Pro Window & Door  
**ICF CONSTRUCTION INC** — Firetek, Window & Door, Insulating Foam Sealant, Multi-Purpose, HC Sealants, Black Foam Sealant, Extreme Window & Door Extreme, Fast Foam, Gun Foam, and Straw Foam

\* Indicates such products shall bear the UL or cUL Certification Mark for jurisdictions employing the UL or cUL Certification (such as Canada), respectively.

Last Updated on 2022-05-30

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consulting engineer.

FOR REVIEW

SHIRAZ TOWNHOMES

603, 605, & 607 W. 49th ST. KANSAS CITY, MO 64112

REVISIONS

No.	Description	Date
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sheet issue date:  
09.27.2024

project no.:  
20.32

sheet contents:  
FIRE RESISTANT  
ASSEMBLIES


sheet no.:

G204



1 overall architectural site plan

1" = 10'-0"

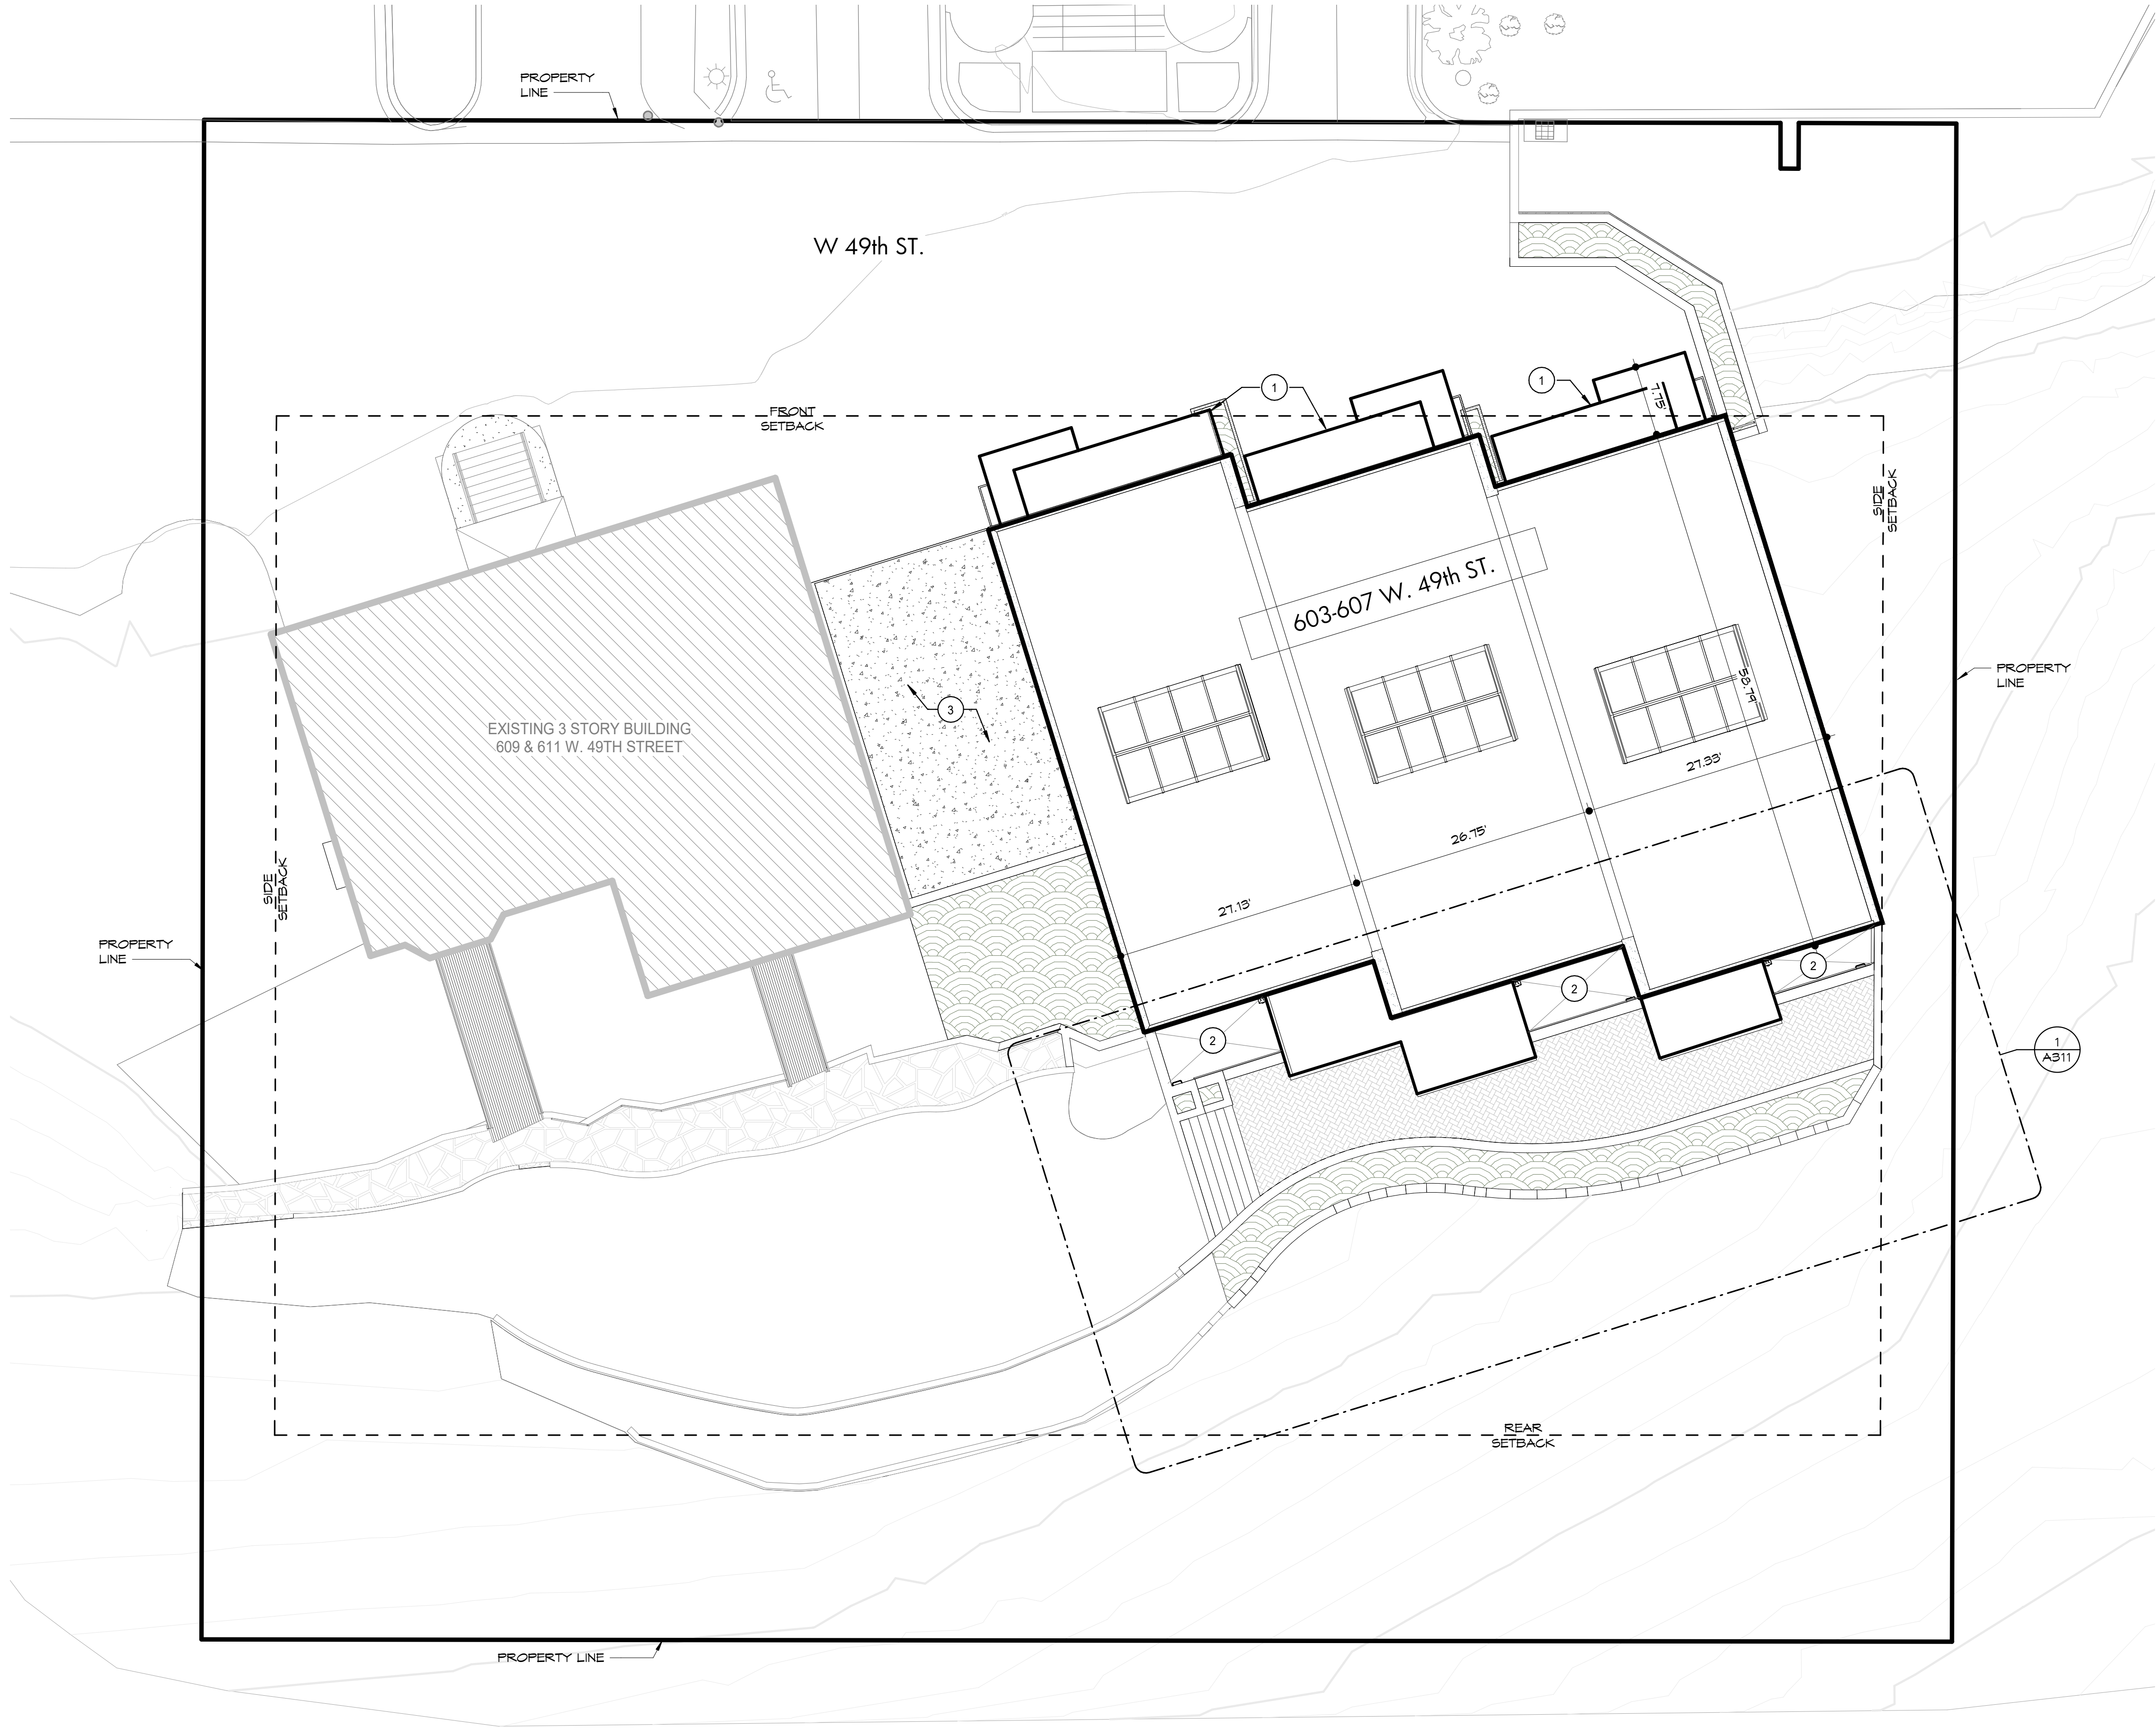

site zoning notes

project description

THREE NEW TOWNHOMES CONSTRUCTED AS ONE BUILDING AT 611 N. 49TH STREET IN KANSAS CITY, MISSOURI. EACH UNIT SHALL BE APPROXIMATELY 2500 SQFT. WITH 3 BEDROOMS. THE TOWNHOMES SHALL BE DESIGNED ACCORDING TO THE 2021 INTERNATIONAL RESIDENTIAL CODE, AS ALLOWED BY THE CITY OF KANSAS CITY, MISSOURI.

general information

LOCATION: 603/605/607 N. 49TH STREET  
KANSAS CITY, MO 64112  
ZONING: R-5  
BUILDING GROSS AREA: 11,533 SQ. FT.

setback and height limitations

FRONT YARD SETBACK: 25 FT  
SIDE YARD SETBACK: 5 FT  
REAR YARD SETBACK: 30 FT  
MAXIMUM BUILDING HEIGHT: 35 FT

legal description

ARNOLD PLACE LOT 2

residential areas - unit a

MAIN FLOOR: 1,280 SQFT.  
SECOND FLOOR: 1,262 SQFT.  
TOTAL LIVING AREA: 2,542 SQFT.  
UNFINISHED SPACES: 660 SQFT.  
GARAGE: 660 SQFT.

residential areas - unit b

MAIN FLOOR: 1,270 SQFT.  
SECOND FLOOR: 1,266 SQFT.  
TOTAL LIVING AREA: 2,536 SQFT.  
UNFINISHED SPACES: 662 SQFT.  
GARAGE: 662 SQFT.

residential areas - unit c

MAIN FLOOR: 1,294 SQFT.  
SECOND FLOOR: 1,212 SQFT.  
TOTAL LIVING AREA: 2,506 SQFT.  
UNFINISHED SPACES: 655 SQFT.  
GARAGE: 655 SQFT.

site legend

	CONCRETE SLAB OR PAD
	LANDSCAPING
	SITE PAVERS

site general notes

- REFERENCE CIVIL DRAWINGS FOR GRADING, LANDSCAPING, UTILITIES AND DETAILED SITE INFORMATION.
- CONTRACTOR TO REMOVE TRASH AND DEBRIS FROM SITE PRIOR TO START OF EXCAVATION.
- CONTRACTOR TO CUT ROUGH GRADE TO 4" BELOW FINAL FLATWORK.
- CONTRACTOR TO LOCATE DEBRIS AND CONCRETE PIECES TO DESIGNATED LOCATION ON/NEAR SITE.
- FINAL GRADE TO BE PITCHED AWAY FROM FOUNDATION 6" IN 10' UNLESS NOTED OTHERWISE.
- CONTRACTOR TO CALL MISSOURI ONE CALL SYSTEM PRIOR TO START OF EXCAVATION.

site plan keynotes

- EXTERIOR CANOPY COMPONENT
- WINDOW WELL
- NEW FIRE ACCESS DRIVE, REF. CIVIL.



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FOR REVIEW

SHIRAZ TOWNHOMES

603, 605, & 607 W. 49th ST. KANSAS CITY, MO 64112

REVISIONS

No.	Description	Date
1	DRC comments	

sheet issue date:  
09.27.2024


project no.:  
20.32

sheet contents:  
ARCHITECTURAL SITE  
PLAN

sheet no.:

A001



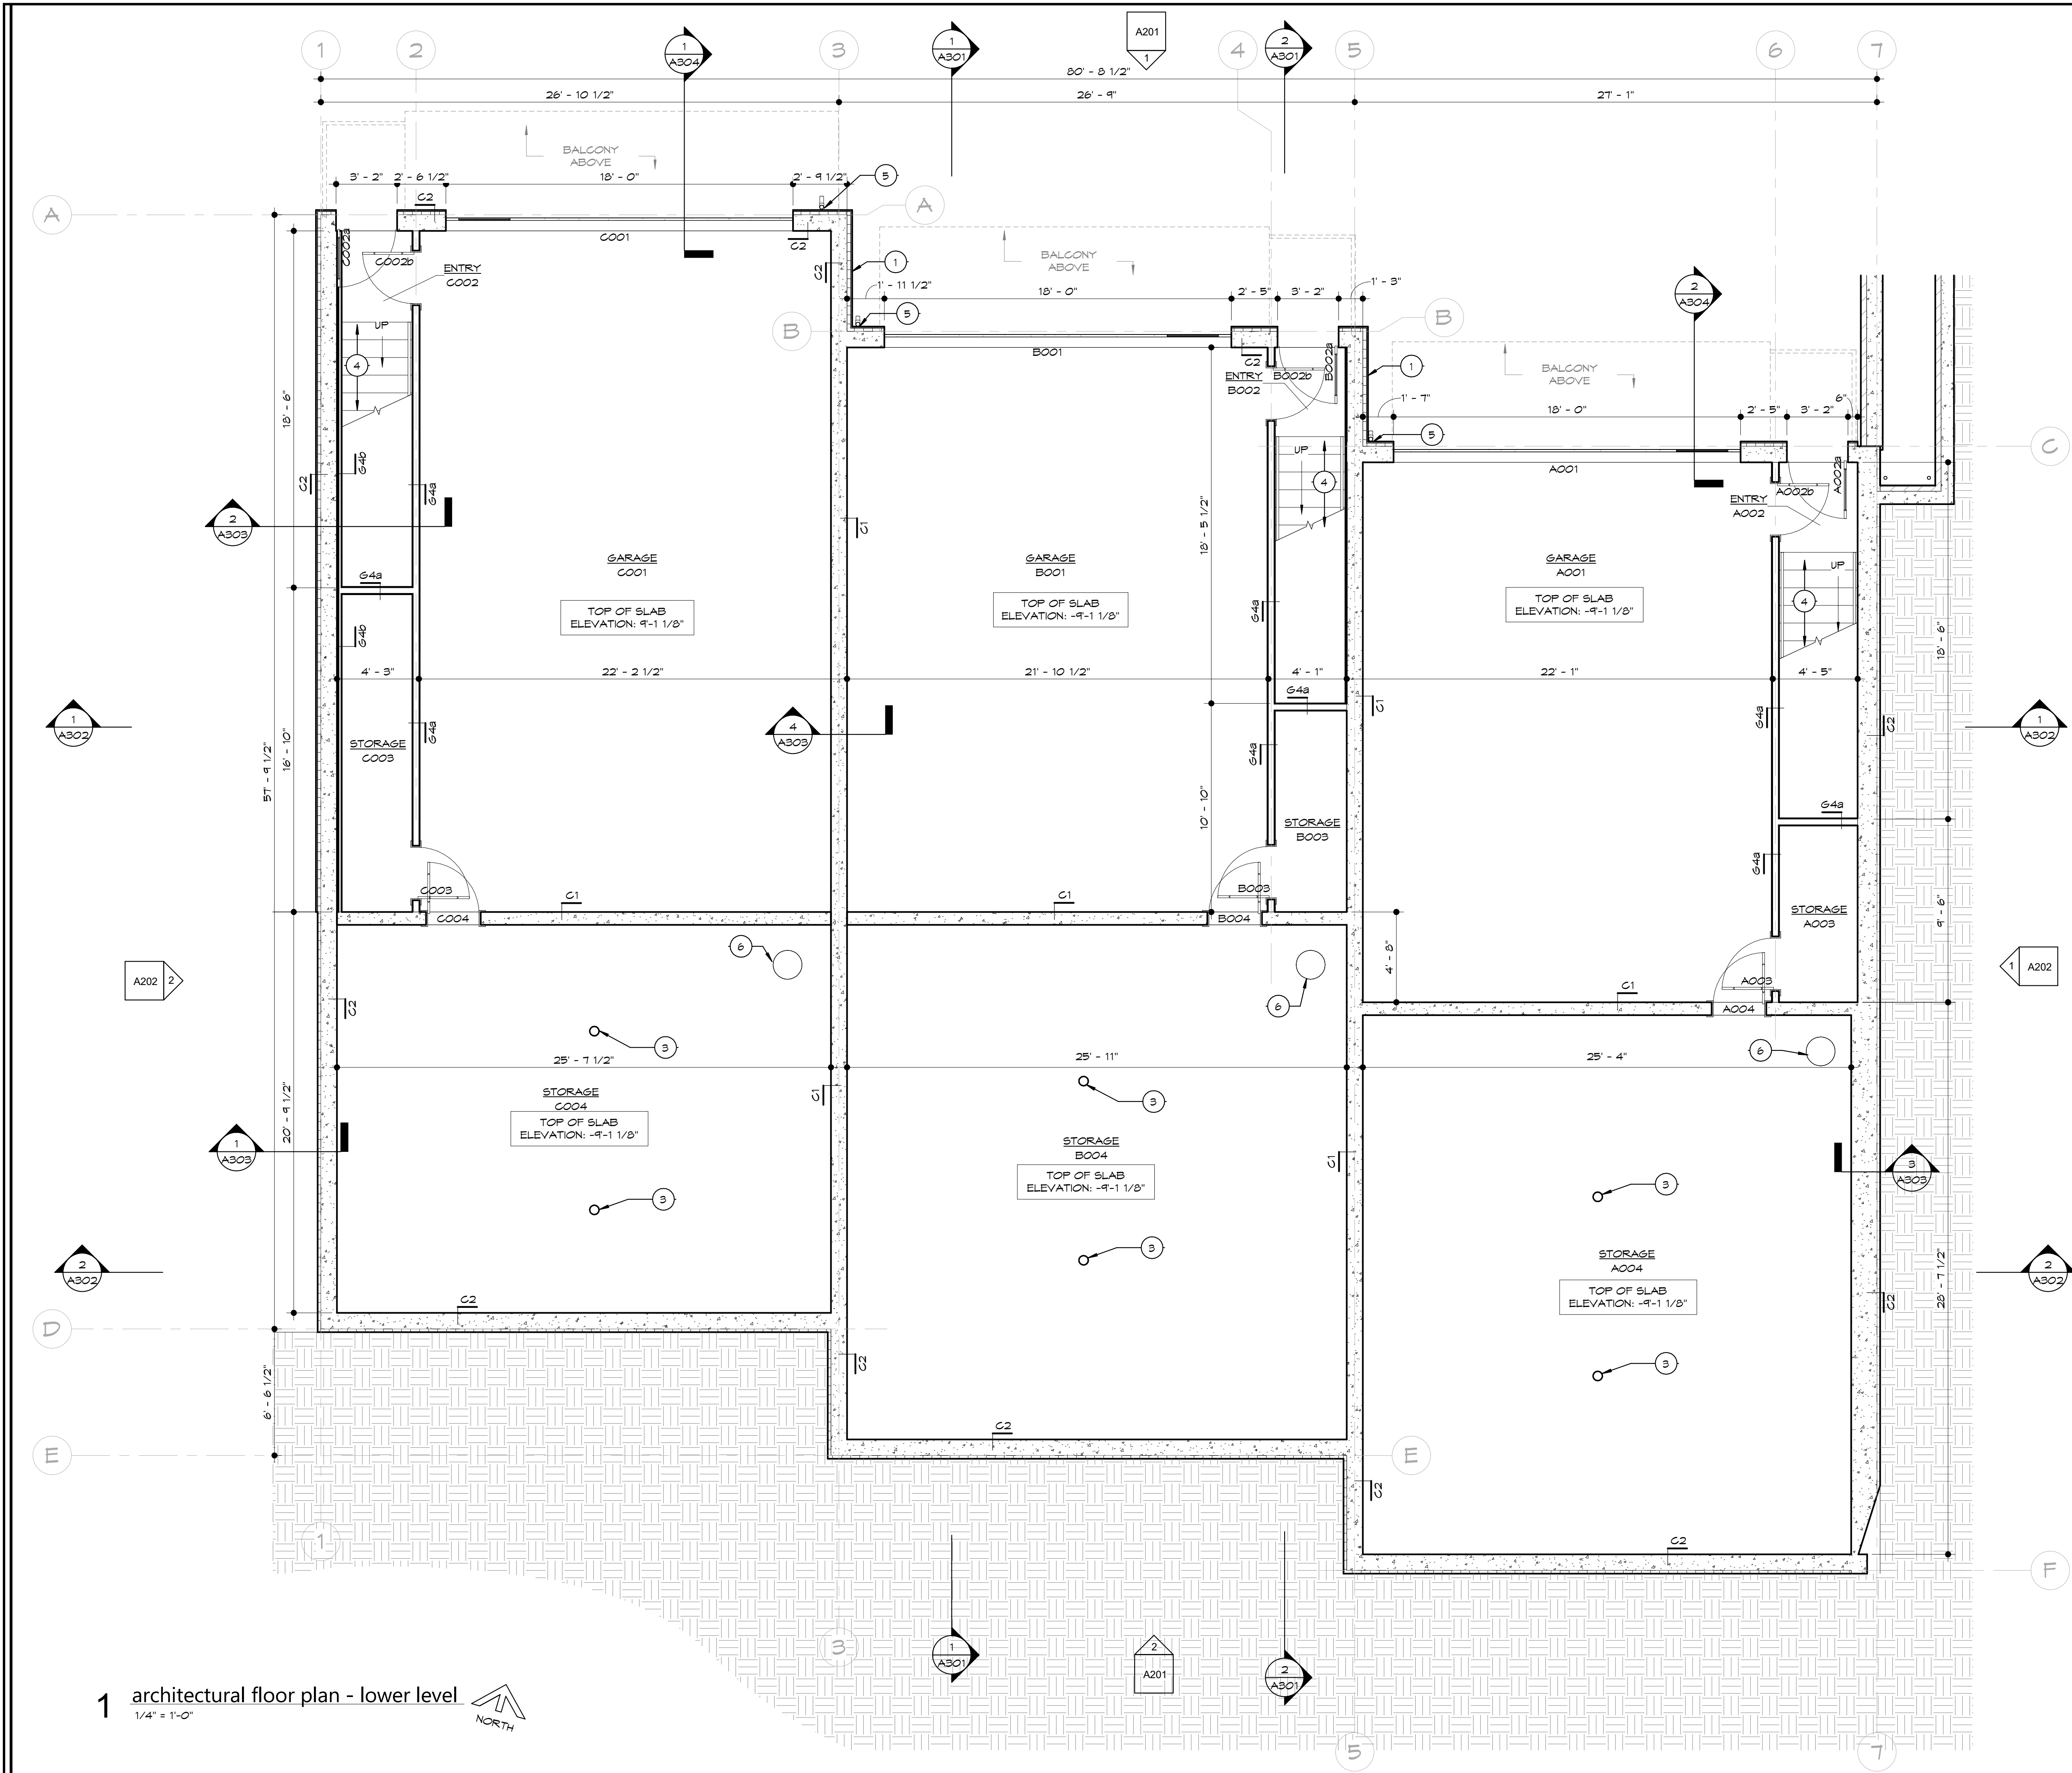

general notes

1. GENERAL CONTRACTOR SHALL NOTIFY THE ARCHITECT OF ANY DISCREPANCIES BETWEEN ARCHITECTURAL AND STRUCTURAL DRAWINGS, AND BETWEEN MULTIPLE DRAWINGS. THE ARCHITECT WILL DETERMINE WHICH SHALL GOVERN.
2. GENERAL CONTRACTOR SHALL VERIFY ALL DIMENSIONS AND CONDITIONS OF THE JOB SITE INCLUDING UTILITIES AND EXISTING STRUCTURES PRIOR TO BEGINNING WORK AND REPORT ANY DISCREPANCIES TO THE ARCHITECT.
3. GENERAL CONTRACTOR SHALL BE RESPONSIBLE FOR STABILITY OF THE STRUCTURE DURING CONSTRUCTION INCLUDING ALL SHORING AND BRACING REQUIRED TO RESIST REQUIRED VERTICAL AND LATERAL FORCES.
4. ALL ARCHITECTURAL FLOOR PLAN DIMENSIONS ARE FROM FACE OF CONCRETE OR FACE OF STUD.
5. INTERIOR WALLS ARE TO BE COMPRISED OF 2x4 STUDS AT 16" O.C. MAX WITH 1/2" DRYWALL EACH SIDE UNLESS NOTED OTHERWISE.
6. MECHANICAL PLUMBING SCOPES ARE DESIGN/BUILD. DESIGN TO BE PROVIDED BY SUB-CONTRACTOR TO MEET OR EXCEED CODE REQUIREMENTS; CONTRACTOR TO COORDINATE EACH OTHERS' WORK WITH ARCHITECTURAL PLANS AND TO NOTIFY ARCHITECT OF NEED FOR SOFFITS OR CHASES FOR INSTALLATION OF DUCTWORK OR PLUMBING.
7. ELECTRICAL SCOPES ARE DESIGN/BUILD. DESIGN TO BE PROVIDED BY SUB-CONTRACTOR TO MEET OR EXCEED CODE REQUIREMENTS; CONTRACTOR TO INSTALL OUTLETS AS REQUIRED PER CODE. VERIFY ALL LOCATIONS WITH OWNER PRIOR TO BEGINNING DRYWALL.
8. COORDINATE ALL WALLS AND DIMENSIONS ON ARCHITECTURAL DRAWINGS WITH STRUCTURAL DRAWINGS.

architectural plan notes

GENERAL: COORDINATE WITH WORK SHOWN ON STRUCTURAL, MECHANICAL, PLUMBING, AND ELECTRICAL DRAWINGS, REF. FE SHEET FOR EQUIP. COORDINATION

NUMBER	NOTE TEXT
1	PROVIDE ADDITIONAL POLYISO OR THICKEN 3-COAT STUCCO AS REQ. TO ALIGN FINISH PLANE WITH ABOVE.
3	STEEL COLUMN, REF. STRUCTURAL.
4	REF BUILDING SECTIONS & STAIR SECTIONS
5	ALUMINUM DOWNSPOUT, REF. ELEVATIONS.
6	SUMP WELL, CONNECT TO DRAIN TILE. COORDINATE WITH OWNER FOR INSTALL OF SUMP PUMP AND ASSOCIATED DISCHARGE ROUTE.

NOTE: REFER TO STRUCTURAL DRAWINGS FOR REINF. STEEL IN EXTERIOR WALLS AND CONCRETE NOT SHOWN

NOTE: REFER TO ALL DETAILS (DETAILS LOCATED ON THIS SHEET, PRECEDING SHEETS AND FOLLOWING SHEETS) FOR APPLICABLE NOTES NOT SHOWN

NOTE: REFER TO ALL SECTIONS (SECTIONS LOCATED ON THIS SHEET, PRECEDING SHEETS AND FOLLOWING SHEETS) FOR APPLICABLE NOTES NOT SHOWN



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FOR REVIEW

SHIRAZ TOWNHOMES

603, 605, & 607 W. 49th ST. KANSAS CITY, MO 64112

REVISIONS  
No. Description Date

sheet issue date:  
09.27.2024


project no.:  
20.32

sheet contents:  
ARCHITECTURAL  
FLOOR PLAN - LOWER  
LEVEL

sheet no.:

A100



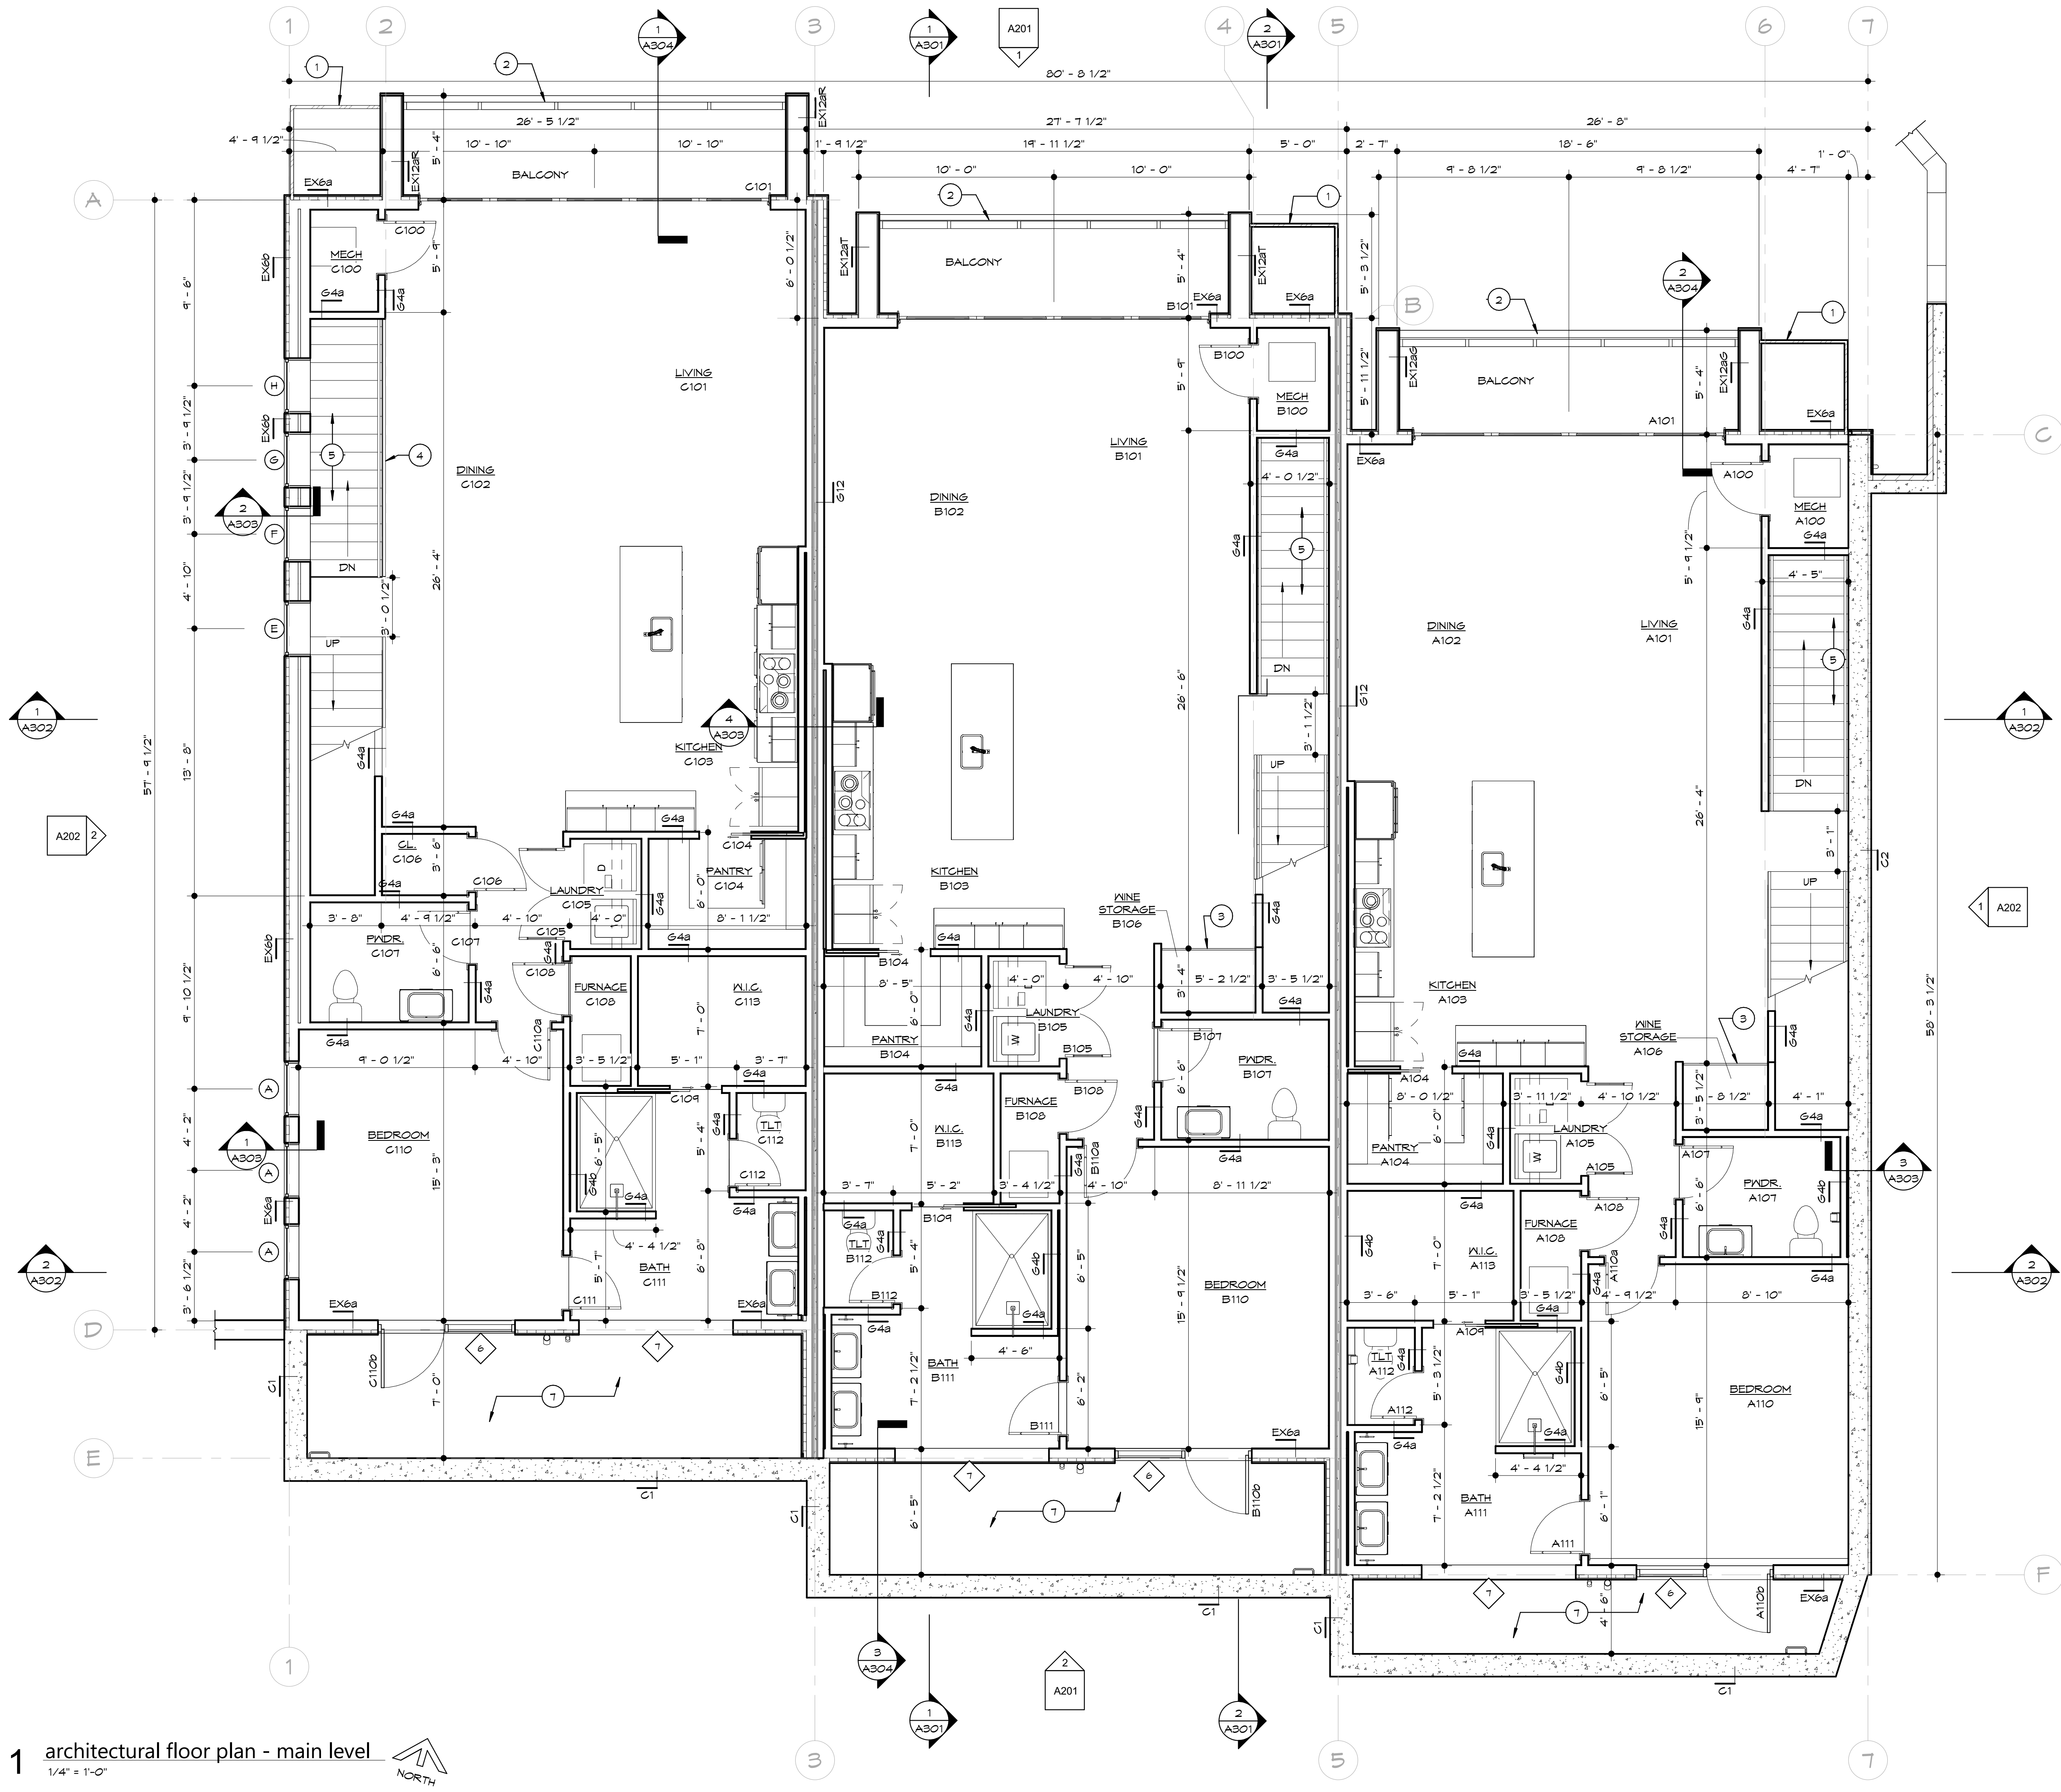

1 architectural floor plan - main level  
1/4" = 1'-0"



general notes

1. GENERAL CONTRACTOR SHALL NOTIFY THE ARCHITECT OF ANY DISCREPANCIES BETWEEN ARCHITECTURAL AND STRUCTURAL DRAWINGS, AND BETWEEN MULTIPLE DRAWINGS. THE ARCHITECT WILL DETERMINE WHICH SHALL GOVERN.
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4. ALL ARCHITECTURAL FLOOR PLAN DIMENSIONS ARE FROM FACE OF CONCRETE OR FACE OF STUD.
5. INTERIOR WALLS ARE TO BE COMPRISED OF 2x4 STUDS AT 16" O.C. MAX WITH 1/2" DRYWALL EACH SIDE UNLESS NOTED OTHERWISE.
6. MECHANICAL PLUMBING SCOPES ARE DESIGN/BUILD. DESIGN TO BE PROVIDED BY SUB-CONTRACTOR TO MEET OR EXCEED CODE REQUIREMENTS; CONTRACTOR TO COORDINATE EACH OTHERS' WORK WITH ARCHITECTURAL PLANS AND TO NOTIFY ARCHITECT OF NEED FOR SOFFITS OR CHASES FOR INSTALLATION OF DUCTWORK OR PLUMBING.
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8. COORDINATE ALL WALLS AND DIMENSIONS ON ARCHITECTURAL DRAWINGS WITH STRUCTURAL DRAWINGS.

architectural plan notes

GENERAL: COORDINATE WITH WORK SHOWN ON STRUCTURAL DRAWINGS AS REQUIRED.

NUMBER NOTE TEXT

- 1 EXTERIOR STEEL COMPONENT, REF. ELEVATIONS & SHEET A303, "FACADE COMPONENT"
- 2 TEMPERED GLASS, EXTERIOR RAILING BY OTHERS, TOP OF RAILING 36" AFF
- 3 WINE STORAGE ROOM - DESIGN BY OTHERS (OPENING, STORAGE, FINISHES, TEMP CONTROL).
- 4 FABRICATED STEEL GUARD RAIL  
\*TOP OF GUARDRAIL = 36" AFF  
\*SHALL NOT ALLOW THE PASSAGE OF A 4" SPHERE  
\*RESIST A UNIFORM LOAD OF 50 LBS PER LINEAR FOOT
- 5 REF BUILDING SECTIONS & STAIR SECTIONS
- 7 WINDOW WELL, GRAVEL BASE, REF. CIVIL & 3/A304 FOR ADDITIONAL INFO.

NOTE: REFER TO STRUCTURAL DRAWINGS FOR REINF. STEEL IN EXTERIOR WALLS AND CONCRETE NOT SHOWN

NOTE: REFER TO ALL DETAILS (DETAILS LOCATED ON THIS SHEET, PRECEEDING SHEETS AND FOLLOWING SHEETS) FOR APPLICABLE NOTES NOT SHOWN

NOTE: REFER TO ALL SECTIONS (SECTIONS LOCATED ON THIS SHEET, PRECEEDING SHEETS AND FOLLOWING SHEETS) FOR APPLICABLE NOTES NOT SHOWN



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REVISIONS		
No.	Description	Date

sheet issue date:  
09.27.2024


project no.:  
20.32

sheet contents:  
ARCHITECTURAL  
FLOOR PLAN - MAIN  
LEVEL

sheet no.:

A101



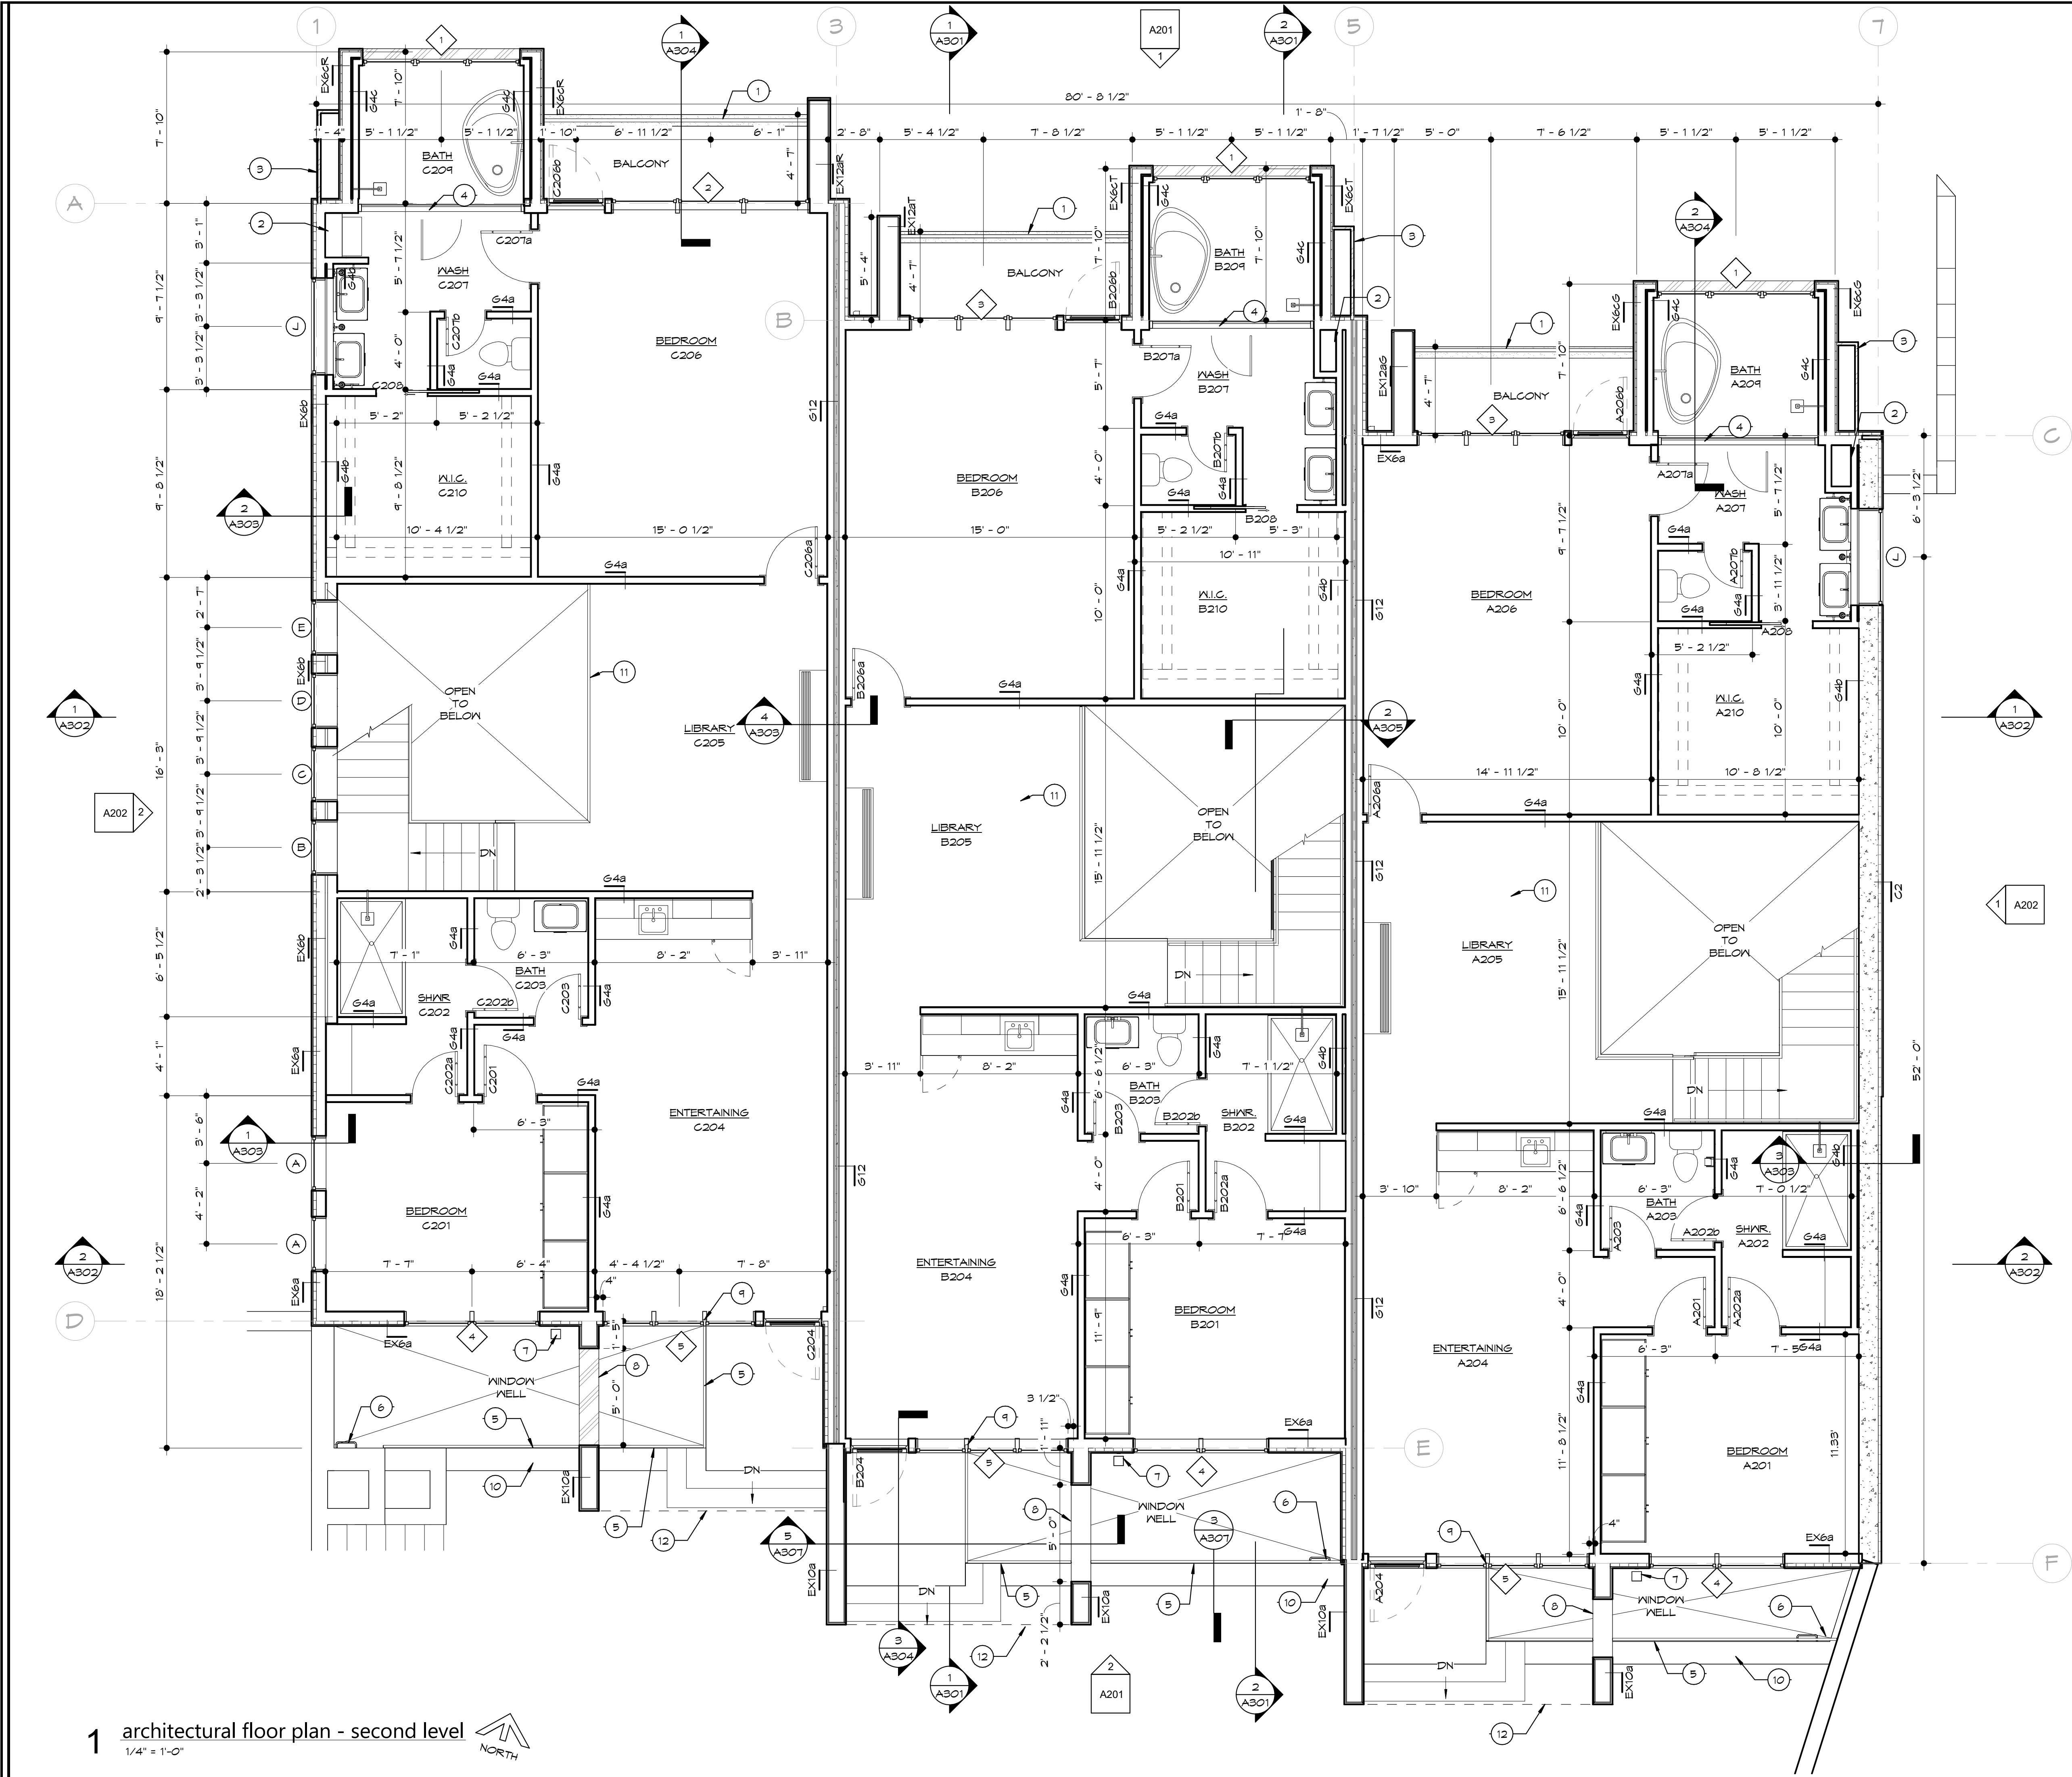

general notes

1. GENERAL CONTRACTOR SHALL NOTIFY THE ARCHITECT OF ANY DISCREPANCIES BETWEEN ARCHITECTURAL AND STRUCTURAL DRAWINGS, AND BETWEEN MULTIPLE DRAWINGS. THE ARCHITECT WILL DETERMINE WHICH SHALL GOVERN.
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8. COORDINATE ALL WALLS AND DIMENSIONS ON ARCHITECTURAL DRAWINGS WITH STRUCTURAL DRAWINGS.

architectural plan notes

GENERAL: COORDINATE WITH WORK SHOWN ON STRUCTURAL, MECHANICAL, PLUMBING, AND ELECTRICAL DRAWINGS, REF. FE SHEET FOR EQUIP. COORDINATION

NUMBER NOTE TEXT

- | NUMBER | NOTE TEXT   |
|--------|---|
| 1      | METAL RAILING, REF DETAIL 2/A306  |
| 2      | CHASE OPENING FOR DUCTWORK  |
| 3      | EXTERIOR STEEL COMPONENT, REF. ELEVATIONS & SHEET A308, 'EXTERIOR DECORATIVE COMPONENT DETAILS'   |
| 4      | FROSTED GLASS CURTAIN WALL BATH ENTRY   |
| 5      | METAL RAILING, REF DETAIL 3/A301  |
| 6      | WINDOW WELL EGRESS LADDER.  |
| 7      | ALUMINUM DOWNSPOUT  |
| 8      | CANOPY OPENING. 60"H, 36" SILL HEIGHT, REF. 4/306 FOR ADDITIONAL INFO   |
| 9      | ALIGN EDGE OF BRIDGE TO EDGE OF WINDOW MULLION  |
| 10     | CONCRETE WINDOW WELL RETAINING WALL. TOP OF WALL TO MATCH TOP OF PAVEMENT ELEVATION. REF. CIVIL AND STRUCTURAL FOR ADDITIONAL INFORMATION                     |
| 11     | FABRICATED STEEL GUARD RAIL<br>•TOP OF GUARDRAIL = 36" AFF<br>•SHALL NOT ALLOW THE PASSAGE OF A 4" SPHERE<br>•RESIST A UNIFORM LOAD OF 50 LBS PER LINEAR FOOT |
| 12     | EDGE OF ENTRY ROOF ABOVE  |

NOTE: REFER TO STRUCTURAL DRAWINGS FOR REINF. STEEL IN EXTERIOR WALLS AND CONCRETE NOT SHOWN

NOTE: REFER TO ALL DETAILS (DETAILS LOCATED ON THIS SHEET, PRECEDING SHEETS AND FOLLOWING SHEETS) FOR APPLICABLE NOTES NOT SHOWN

NOTE: REFER TO ALL SECTIONS (SECTIONS LOCATED ON THIS SHEET, PRECEDING SHEETS AND FOLLOWING SHEETS) FOR APPLICABLE NOTES NOT SHOWN



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REVISIONS

No.	Description	Date
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sheet issue date:  
09.27.2024

project no.:  
20.32

sheet contents:  
ARCHITECTURAL  
FLOOR PLAN - UPPER  
LEVEL

sheet no.:

A102



9/4/2024 1:04:22 PM C:\Users\Todd\Documents\20.32\_Shiraz\_22\_veri-tredder.rvt

1 north elevation  
1/4" = 1'-0"

2 south elevation  
1/4" = 1'-0"

exterior elevation general notes


1. SLOPE GRADE A MINIMUM OF 5% AWAY FROM THE HOUSE FOR A MINIMUM DISTANCE OF 10'-0"
2. MAINTAIN MIN. 8" CLEARANCE BETWEEN FINAL GRADE AND EXPOSED WOOD
3. EXTERIOR SIDING INDICATED ON DRAWINGS SHALL BE INSTALLED OVER BUILDING WRAP, RESULTING IN A WATER-RESISTIVE EXTERIOR WALL SYSTEM COMPLIANT WITH IRC SECTION 103.2.
4. WHERE DIFFERENTIAL BETWEEN PORCH/PATIO AND SURROUNDING GRADE IS GREATER THAN 18" GUARDRAIL SHALL BE PROVIDED. THE GUARDRAIL SHALL BE 42" TALL AND SHALL BE CONSTRUCTED SUCH THAT A 4" SPHERE CANNOT PASS THROUGH IT.
5. REFER TO REFLECTED CEILING PLAN FOR LIGHTING. ALL EXTERIOR LIGHTING SHALL HAVE A CONCEALED LIGHT SOURCE.
6. ALL EXTERIOR METAL SHALL BE CORROSION RESISTANT.
7. ALL EXTERIOR MECHANICAL AND PLUMBING VENT LOCATIONS SHALL BE APPROVED WITH ARCHITECT, PRIOR TO INSTALLATION. ALL PIPING SHALL PAINTED TO MATCH SURROUNDING CONTEXT.

exterior finishes legend



TRADITIONAL STUCCO - SMOOTH:

- 3-COAT SYSTEM OVER DELTA- DRY & LATH OVER R-9 (2") ZIP R-SHEATHING OR, POLYISO INSULATION (PER WALL TYPE)
- SMOOTH FINISH (MEDIUM)
- ELASTOMERIC PAINT

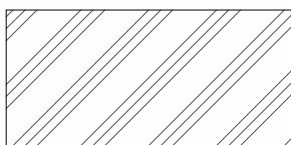

PAC-GLAD METAL FLUSH PANEL SYSTEM

- INSTALL PER MANUFACTURER INSTRUCTIONS.
- COLOR SPECIFIC PER EACH UNIT, REFERENCE PLANS AND WALL TYPES.
- OVER 7/16" ZIP SHEATHING (TAPE SEAMS PER MANUFACTURER.)

exterior elevation keynotes

- 1 GLASS BALCONY RAILING, 36"H, BY OTHERS.
- 2 CUSTOM SKYLIGHT BY OTHERS, REF. REFLECTED CEILING PLAN & DETAIL 1 / A306 FOR ADDITIONAL INFO.
- 3 DECORATIVE STEEL WALL/GUARDRAIL, REF. DETAIL 2 / A306.
- 4 ALUMINUM DOWNSPOUT FOR STORMWATER ROOF DRAINAGE OF EXTERIOR CANOPY & UPPER LEVEL BATHROOM.
- 5 EXTERIOR METAL "RIB" SCULPTURE COMPONENT, REF. SHEET A308.
- 6 ALUMINUM DOWNSPOUT FOR STORMWATER ROOF DRAINAGE OF EXTERIOR CANOPY & MAIN BUILDING ROOF.
- 7 PLANTER RETAINING WALL, REF. CIVIL & STRUCTURAL.
- 8 COLLECTOR BOX FOR THRU-WALL SCUPPER.
- 9 CONCRETE WALL OF WINDOW WELL, REF. STRUCTURAL.
- 10 PARAPET COPING CAP. PAINT TO MATCH COLOR OF STUCCO EXTERIOR FINISH.
- 11 OVERFLOW LAMBS TONGUE DRAIN.
- 12 WALL SCONCE.
- 13 RETAINING WALL, REF STRUCTURAL.

NOTE: REFER TO STRUCTURAL DRAWINGS FOR REINF. STEEL IN EXTERIOR WALLS AND CONCRETE NOT SHOWN

NOTE: REFER TO ALL DETAILS (DETAILS LOCATED ON THIS SHEET, PRECEEDING SHEETS AND FOLLOWING SHEETS) FOR APPLICABLE NOTES NOT SHOWN

NOTE: REFER TO ALL SECTIONS (SECTIONS LOCATED ON THIS SHEET, PRECEEDING SHEETS AND FOLLOWING SHEETS) FOR APPLICABLE NOTES NOT SHOWN



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FOR REVIEW

SHIRAZ TOWNHOMES

603, 605, & 607 W. 49th ST. KANSAS CITY, MO 64112

REVISIONS

No.	Description	Date
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sheet issue date:  
09.27.2024

project no.:  
20.32

sheet contents:  
EXTERIOR ELEVATIONS

sheet no.:


A201



1. SLOPE GRADE A MINIMUM OF 5% AWAY FROM THE HOUSE FOR A MINIMUM DISTANCE OF 10'-0"
2. MAINTAIN MIN. 8" CLEARANCE BETWEEN FINAL GRADE AND EXPOSED WOOD
3. EROSION INDICATED ON DRAWINGS SHALL BE INSTALLED OVER BUILDING WRAP, RESULTING IN A WATER-RESISTIVE EXTERIOR WALL SYSTEM COMPLIANT WITH IRC SECTION 703.2.
4. WHERE DIFFERENTIAL BETWEEN PORCH/PATIO AND SURROUNDING GRADE IS GREATER THAN 18" GUARDRAIL SHALL BE PROVIDED. THE GUARDRAIL SHALL BE 42" TALL AND SHALL BE CONSTRUCTED SUCH THAT A 4" SPHERE CANNOT PASS THROUGH IT.
5. REFER TO REFLECTED CEILING PLAN FOR LIGHTING. ALL EXTERIOR LIGHTING SHALL HAVE A CONCEALED LIGHT SOURCE.
6. ALL EXTERIOR METAL SHALL BE CORROSION RESISTANT.
7. ALL EXTERIOR MECHANICAL AND PIPING VENT LOCATIONS SHALL BE APPROVED WITH ARCHITECT. PRIOR TO INSTALLATION, ALL PIPING SHALL PAINTED TO MATCH SURROUNDING CONTEXT.



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- 3-COAT SYSTEM OVER DELTA- DRY & LATH OVER R-9 (2") ZIP R-SHEATHING OR, POLYISO INSULATION (PER WALL TYPE)
- SMOOTH FINISH (MEDIUM)
- ELASTOMERIC PAINT

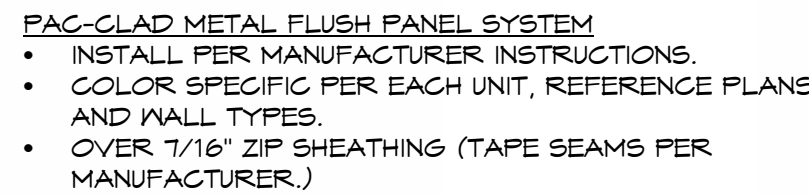

- 1 GLASS BALCONY RAILING, 36"H, BY OTHERS.
- 2 CUSTOM SKYLIGHT BY OTHERS, REF. REFLECTED CEILING PLAN & DETAIL. 1 / A306 FOR ADDITIONAL INFO.
- 3 DECORATIVE STEEL WALL/GUARDRAIL, REF. DETAIL 2 / A306.
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- 12 WALL SCENCE.
- 13 RETAINING WALL, REF. STRUCTURAL.

NOTE: REFER TO ALL SECTIONS (SECTIONS LOCATED ON THIS SHEET, PRECEDING SHEETS AND FOLLOWING SHEETS) FOR APPLICABLE NOTES NOT SHOWN

sheet no.:

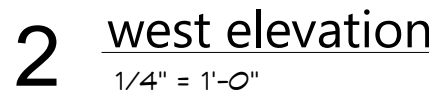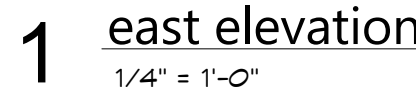

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09.27.2024

sheet contents:

**BUILDING SECTIONS**

sheet no.:







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09.27.2024

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**BUILDING SECTIONS**


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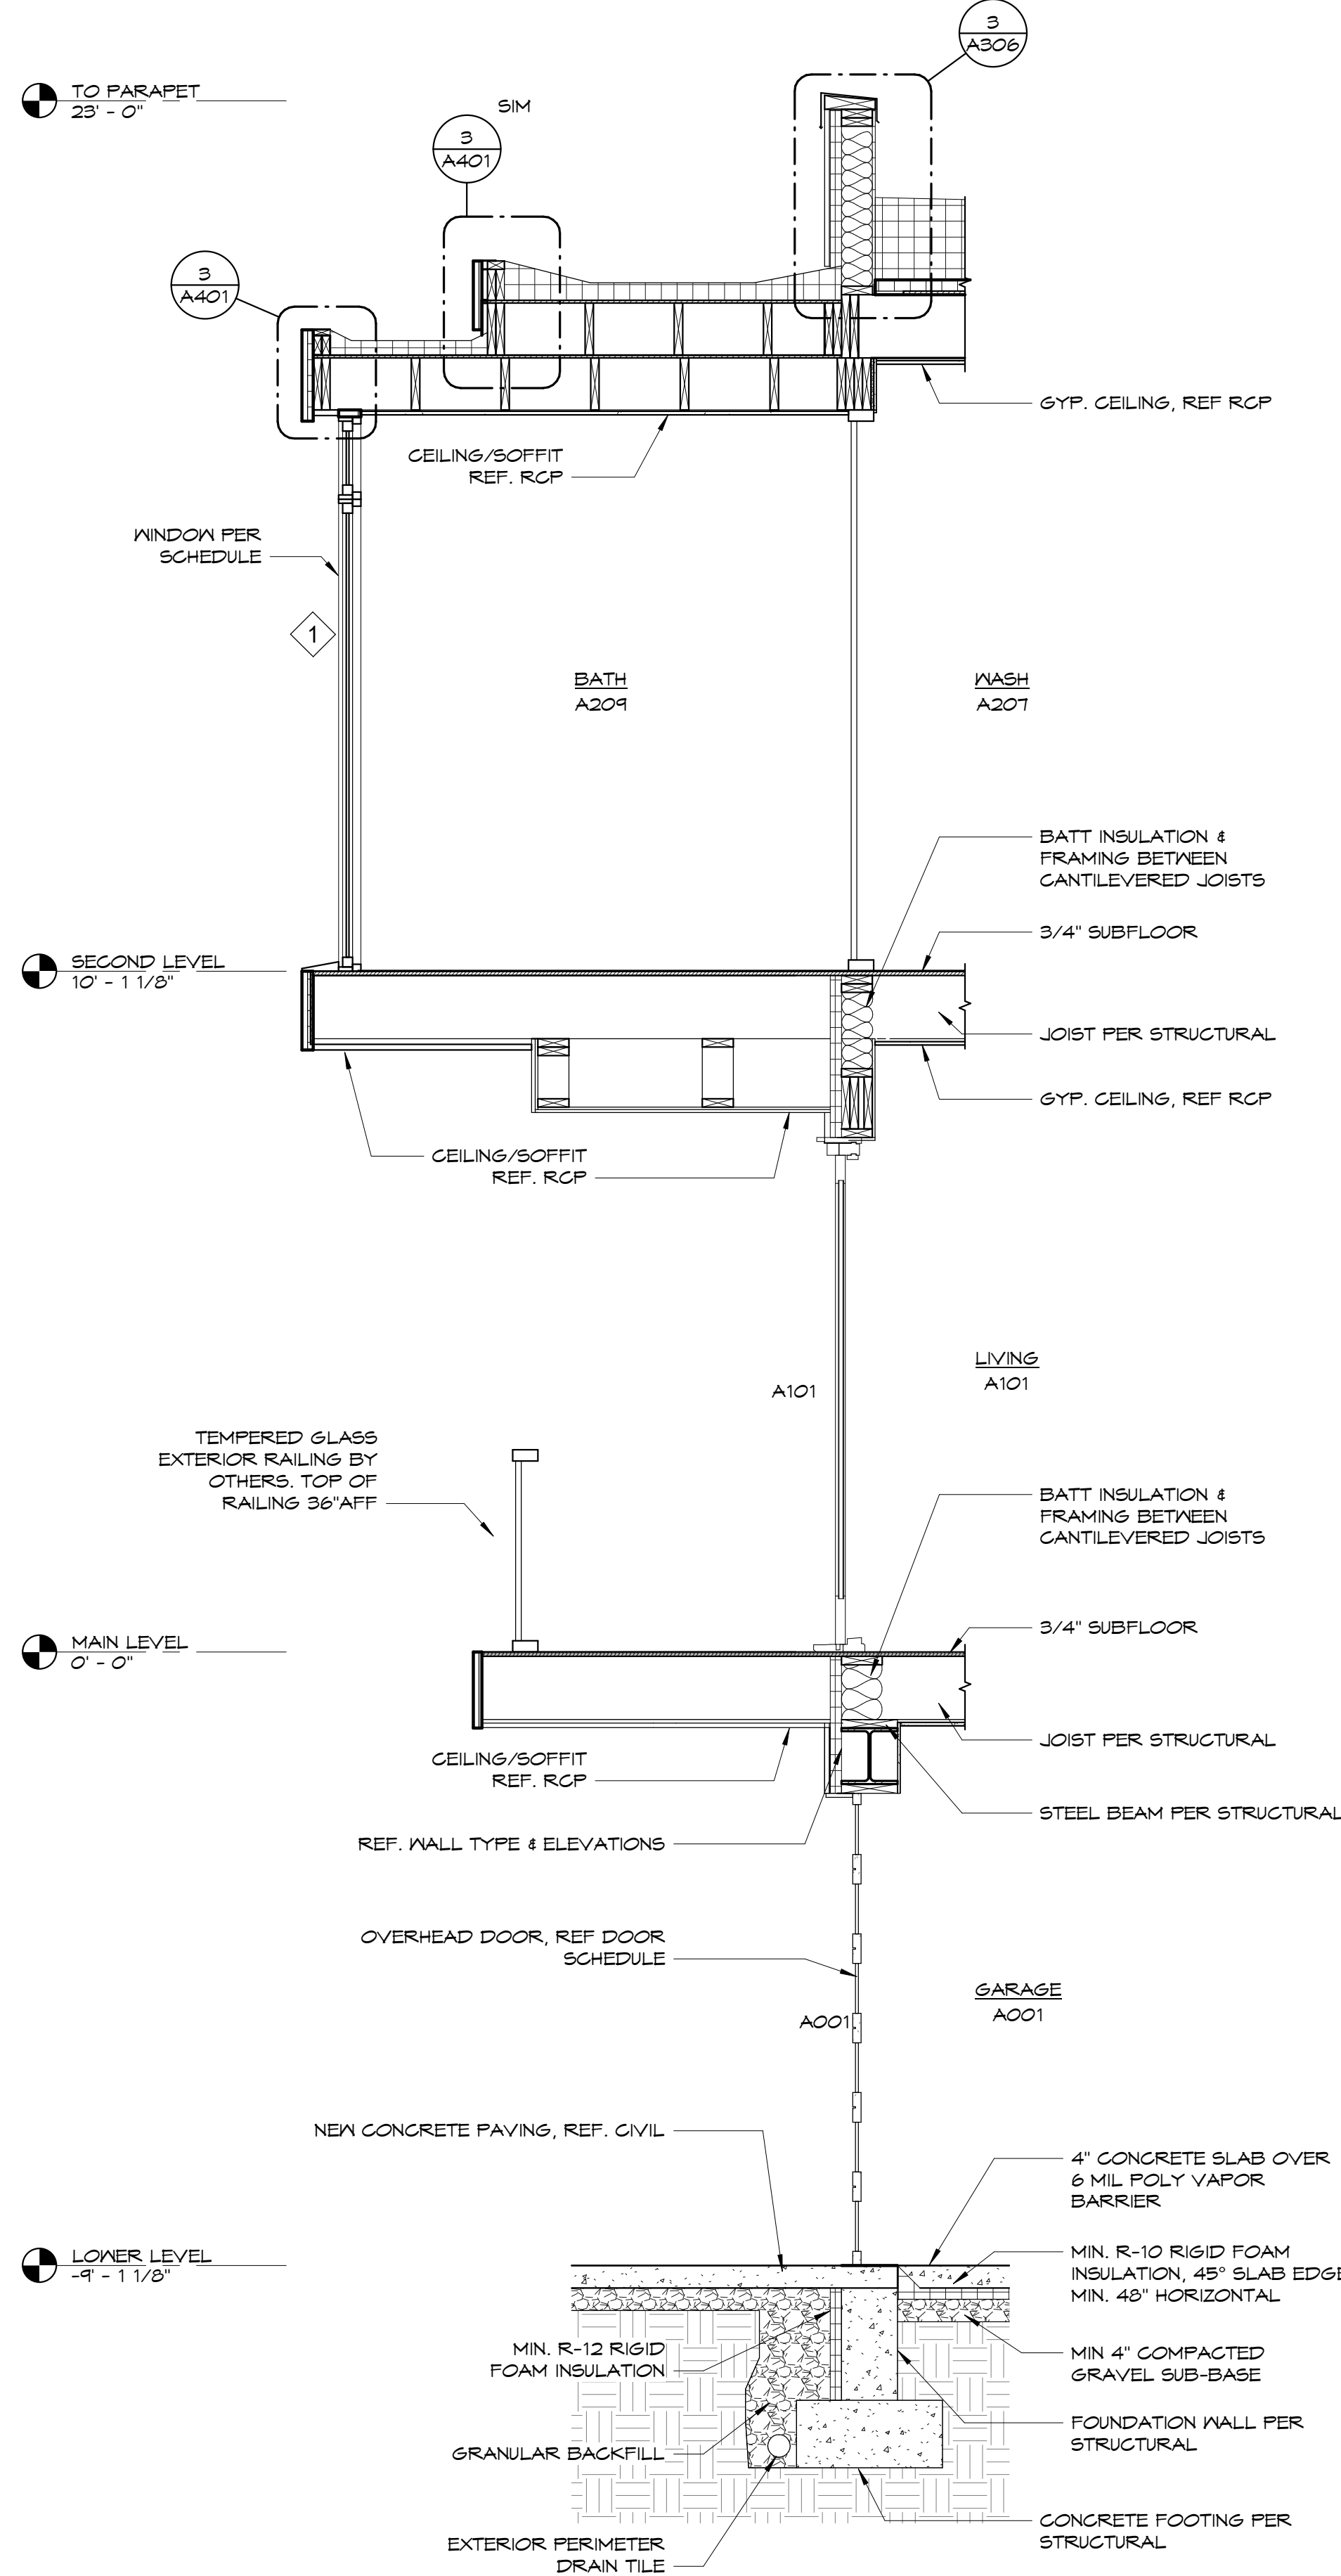
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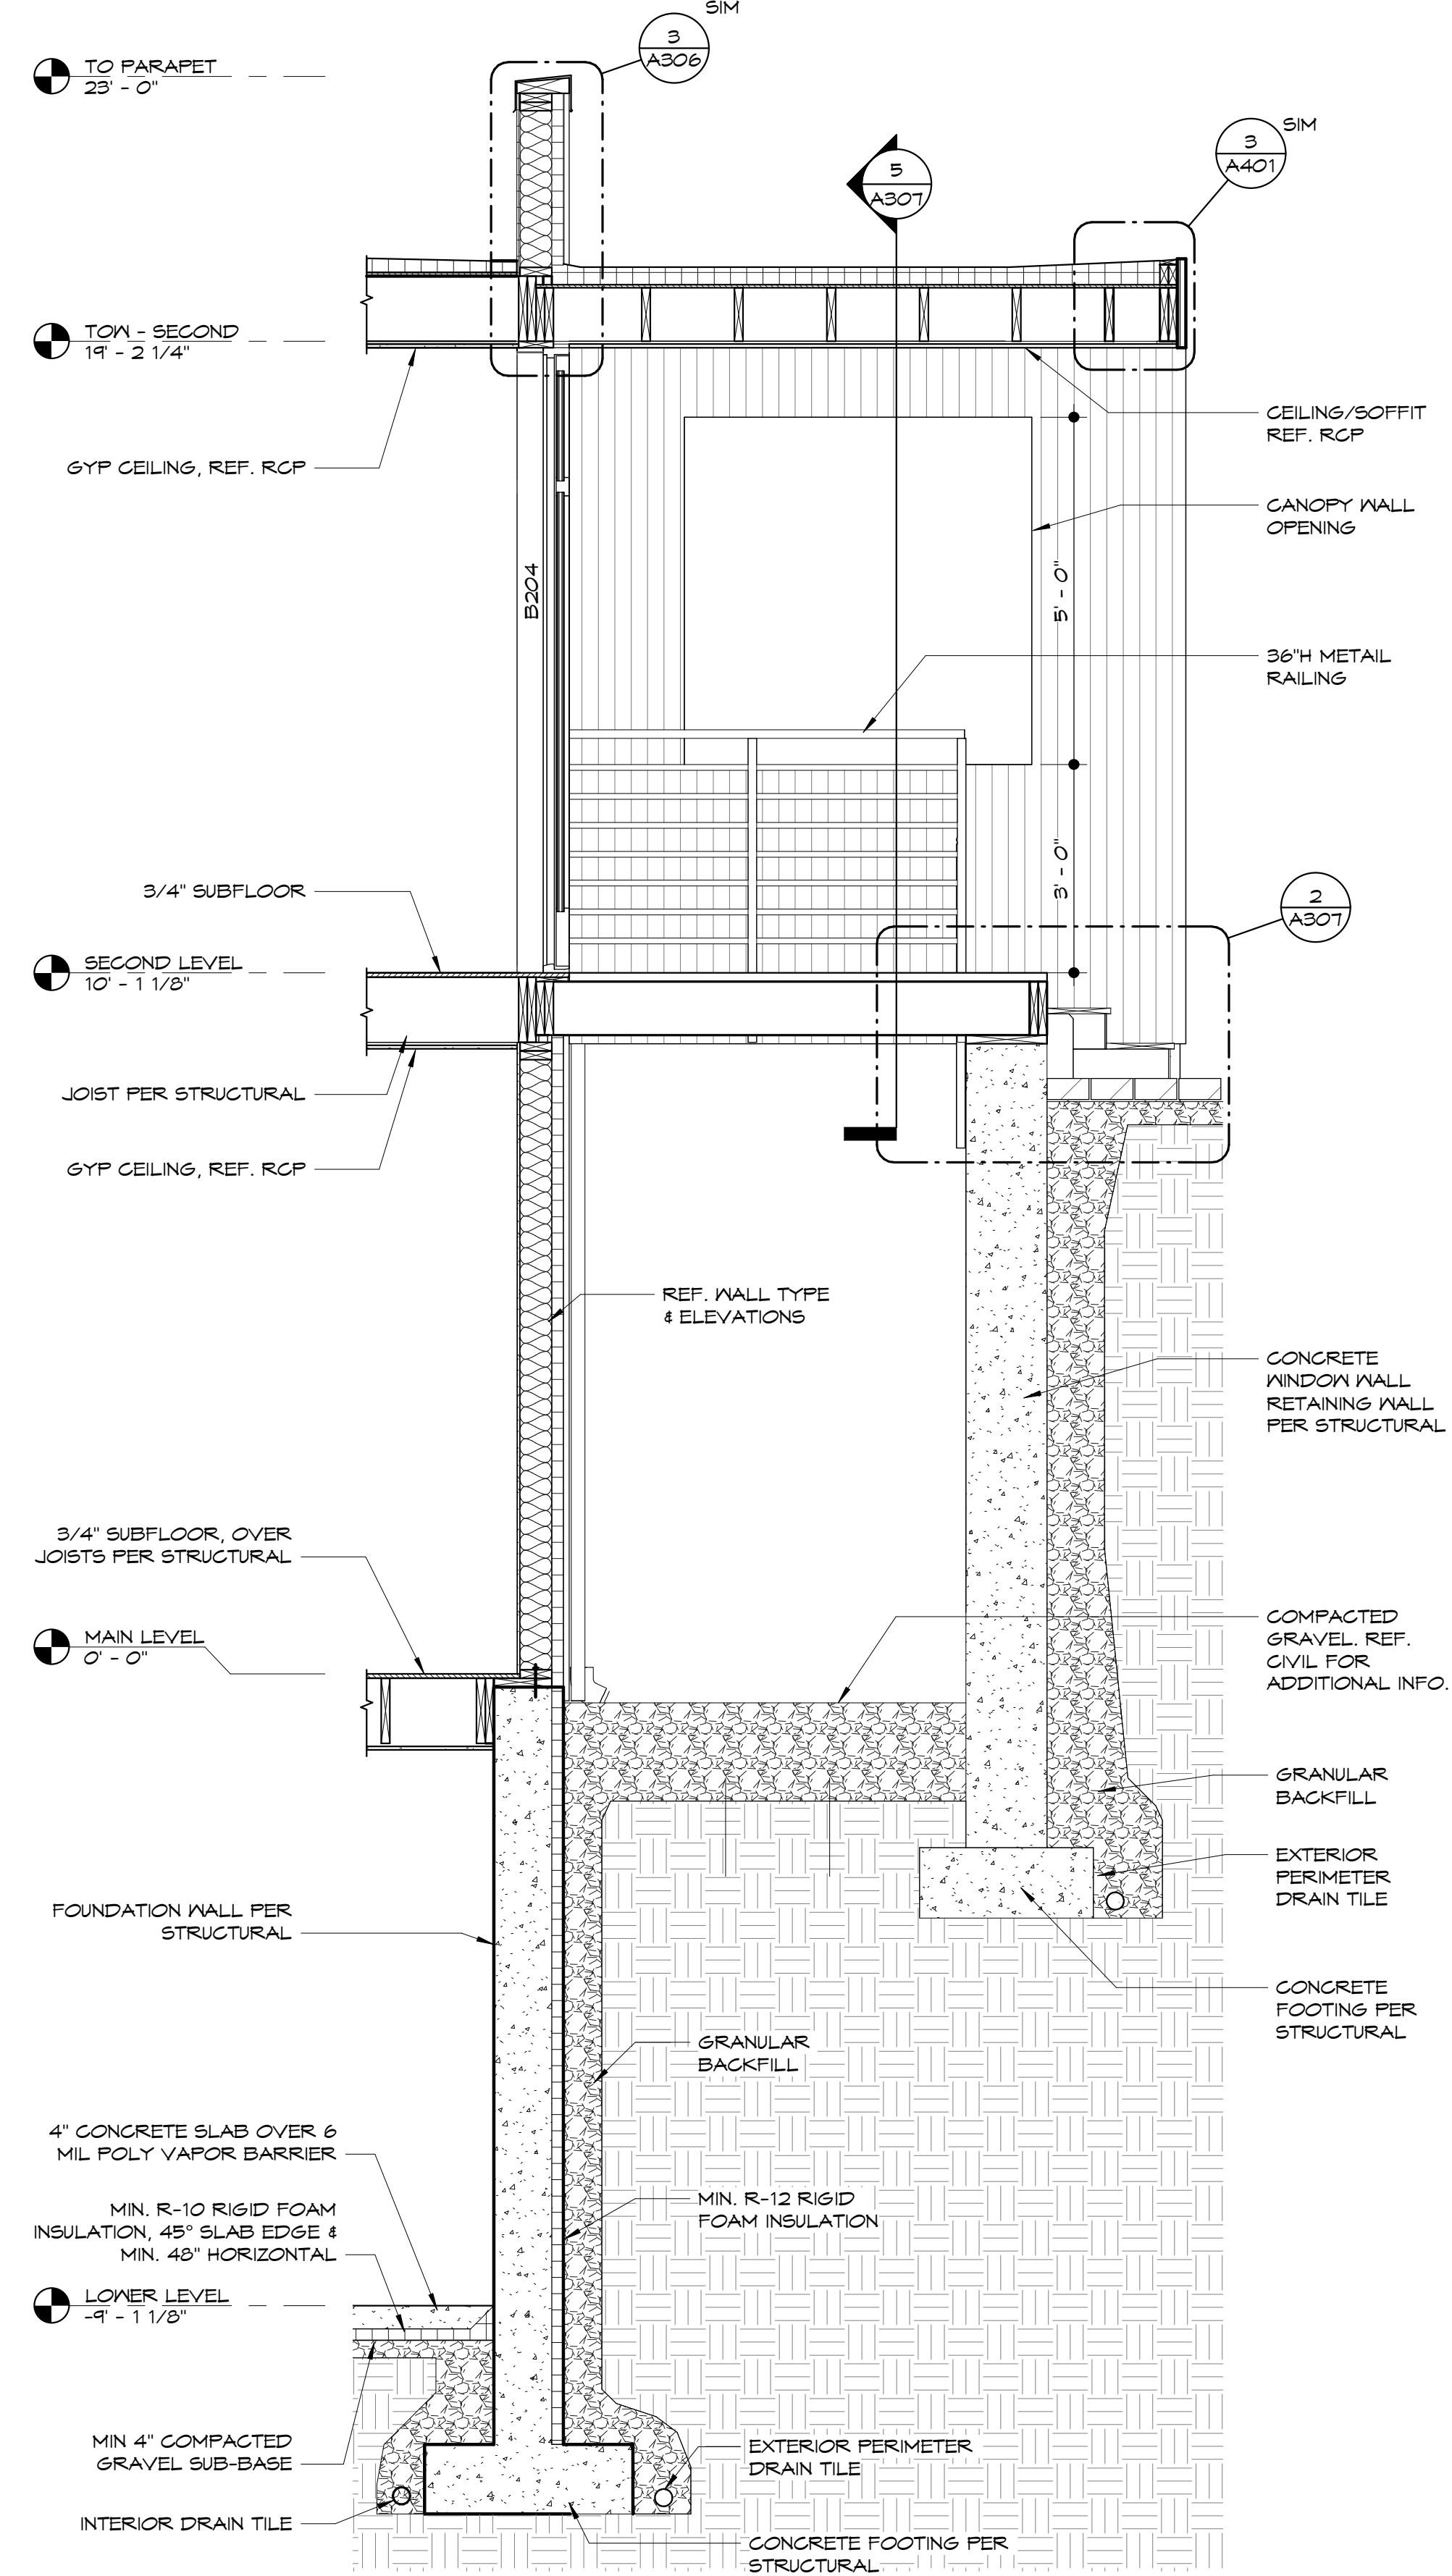
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1 section thru north wall @ balconies  
1/2" = 1'-0"

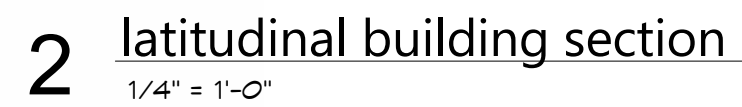


2 section thru north wall @ bathroom  
1/2" = 1'-0"

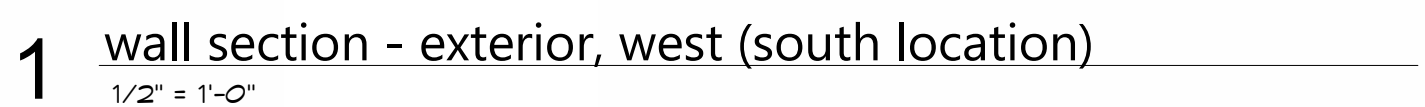

3 section thru rear entry  
1/2" = 1'-0"

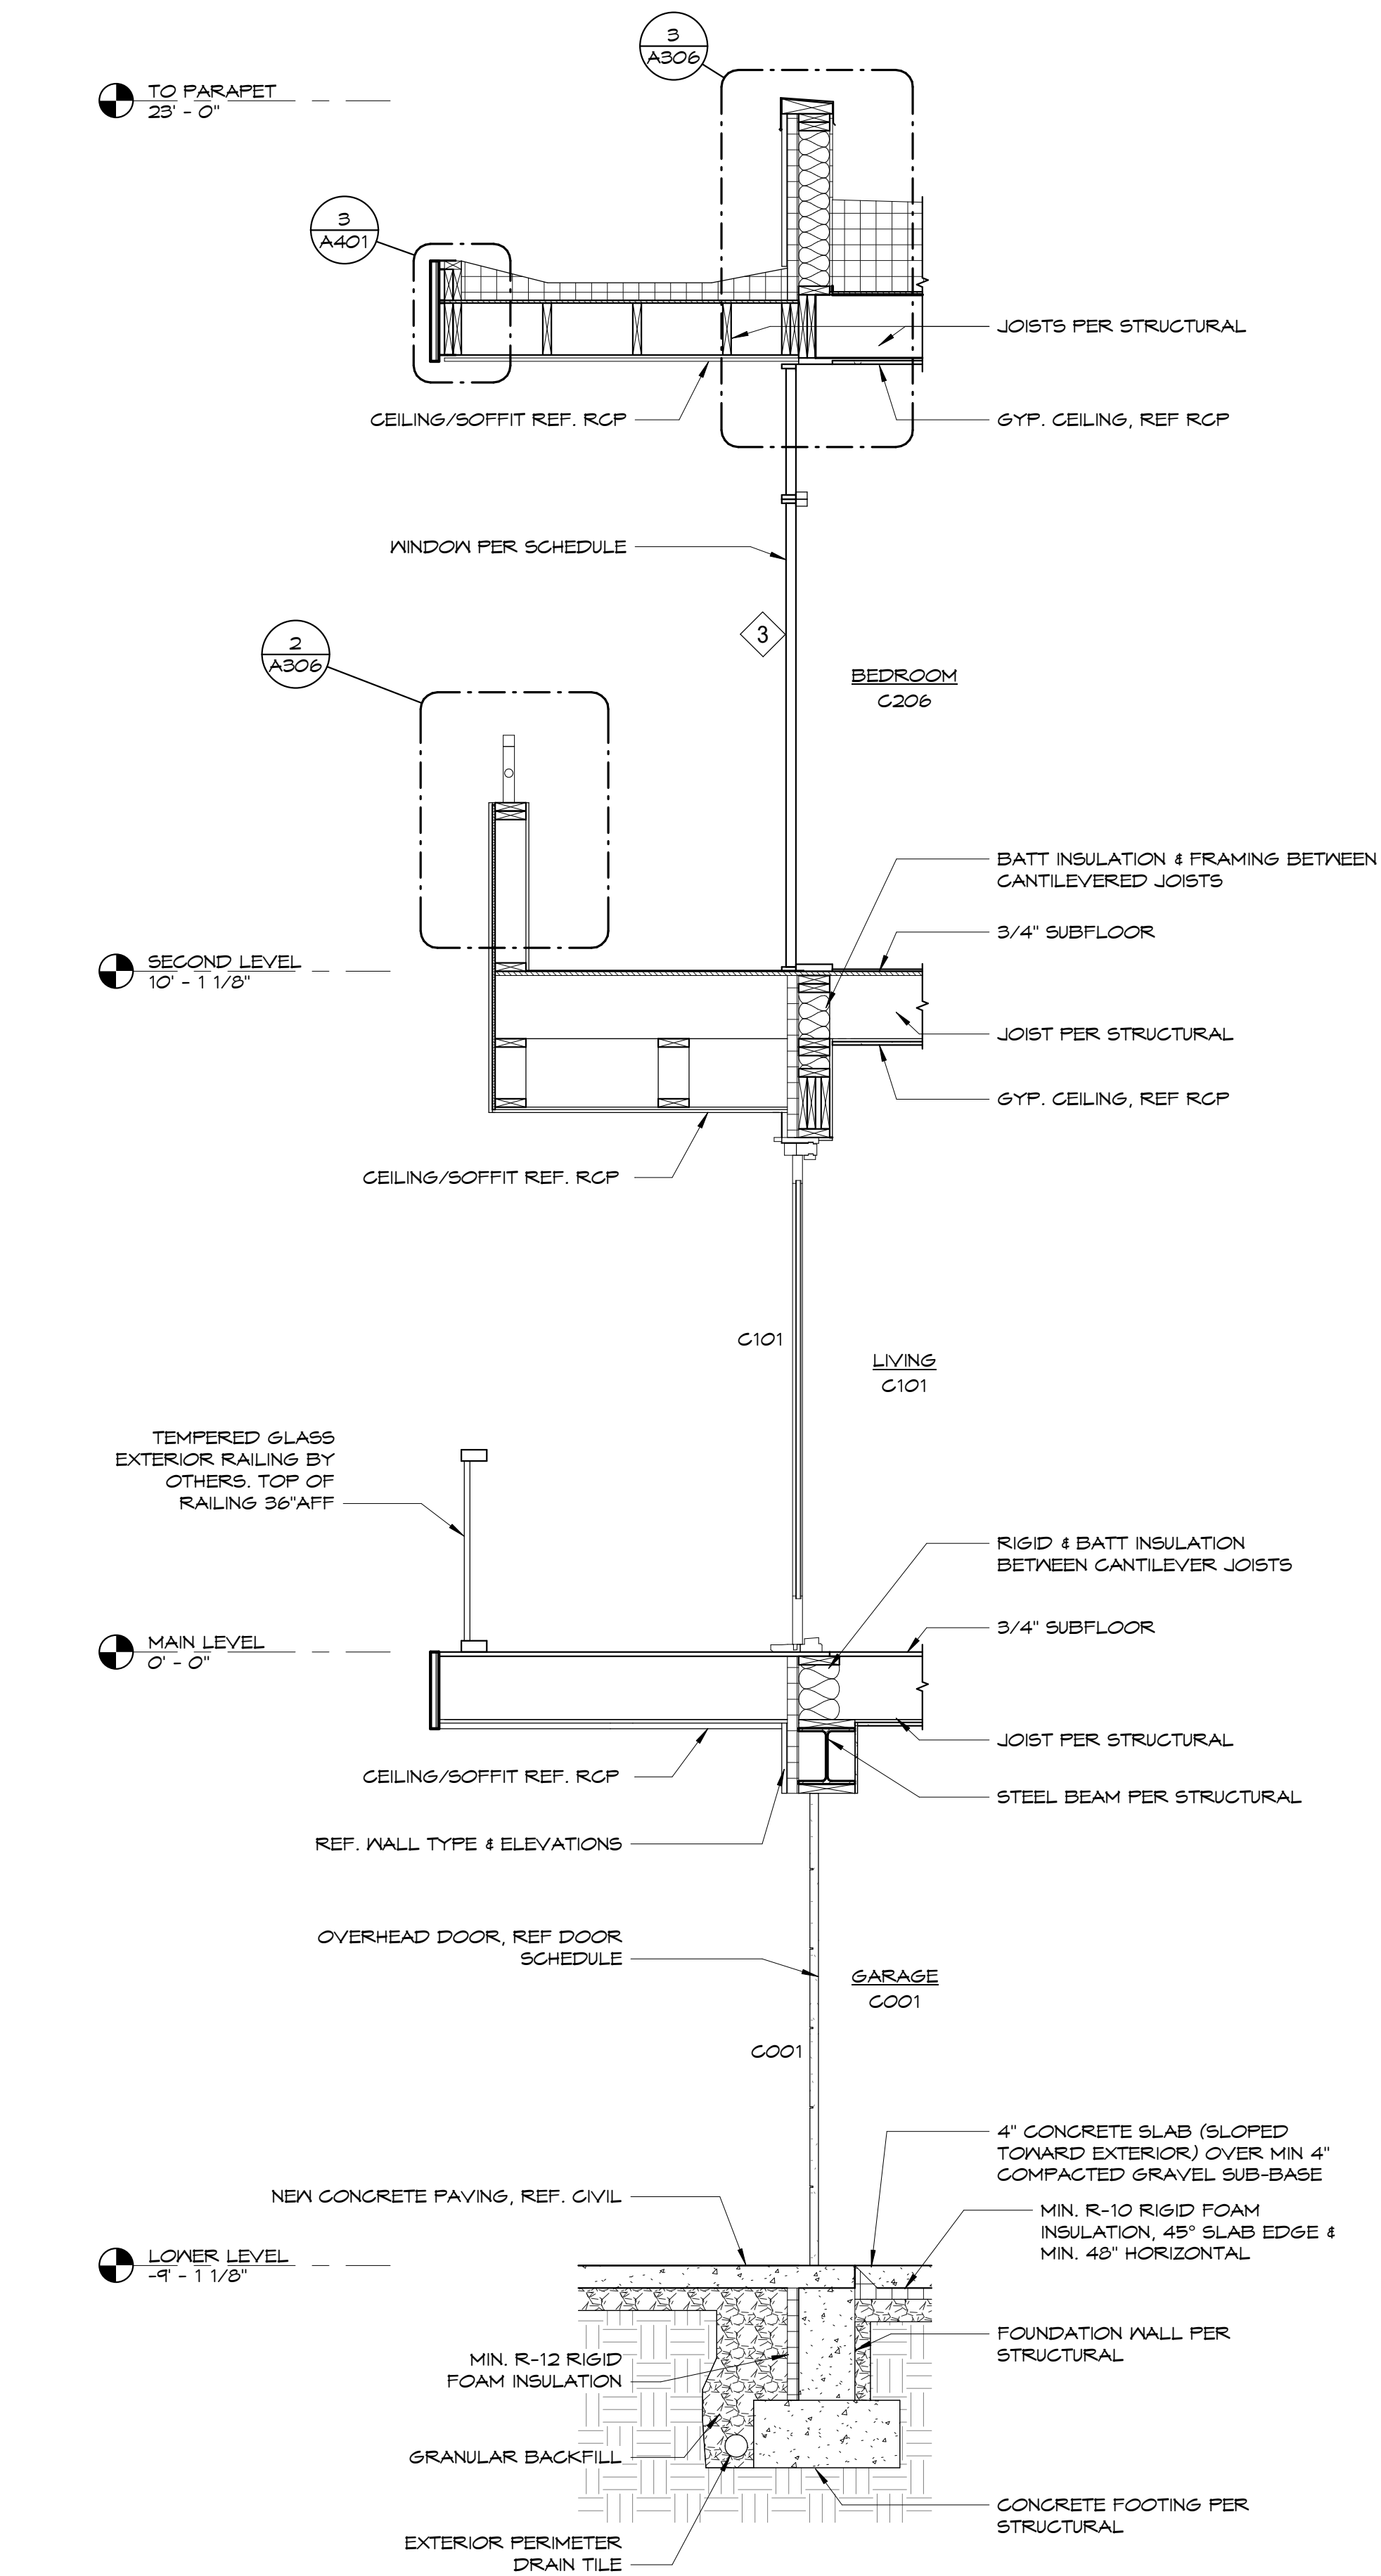


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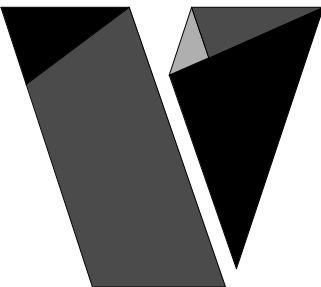
1 stair section - lower level & main level to landing  
1/2" = 1'-0"

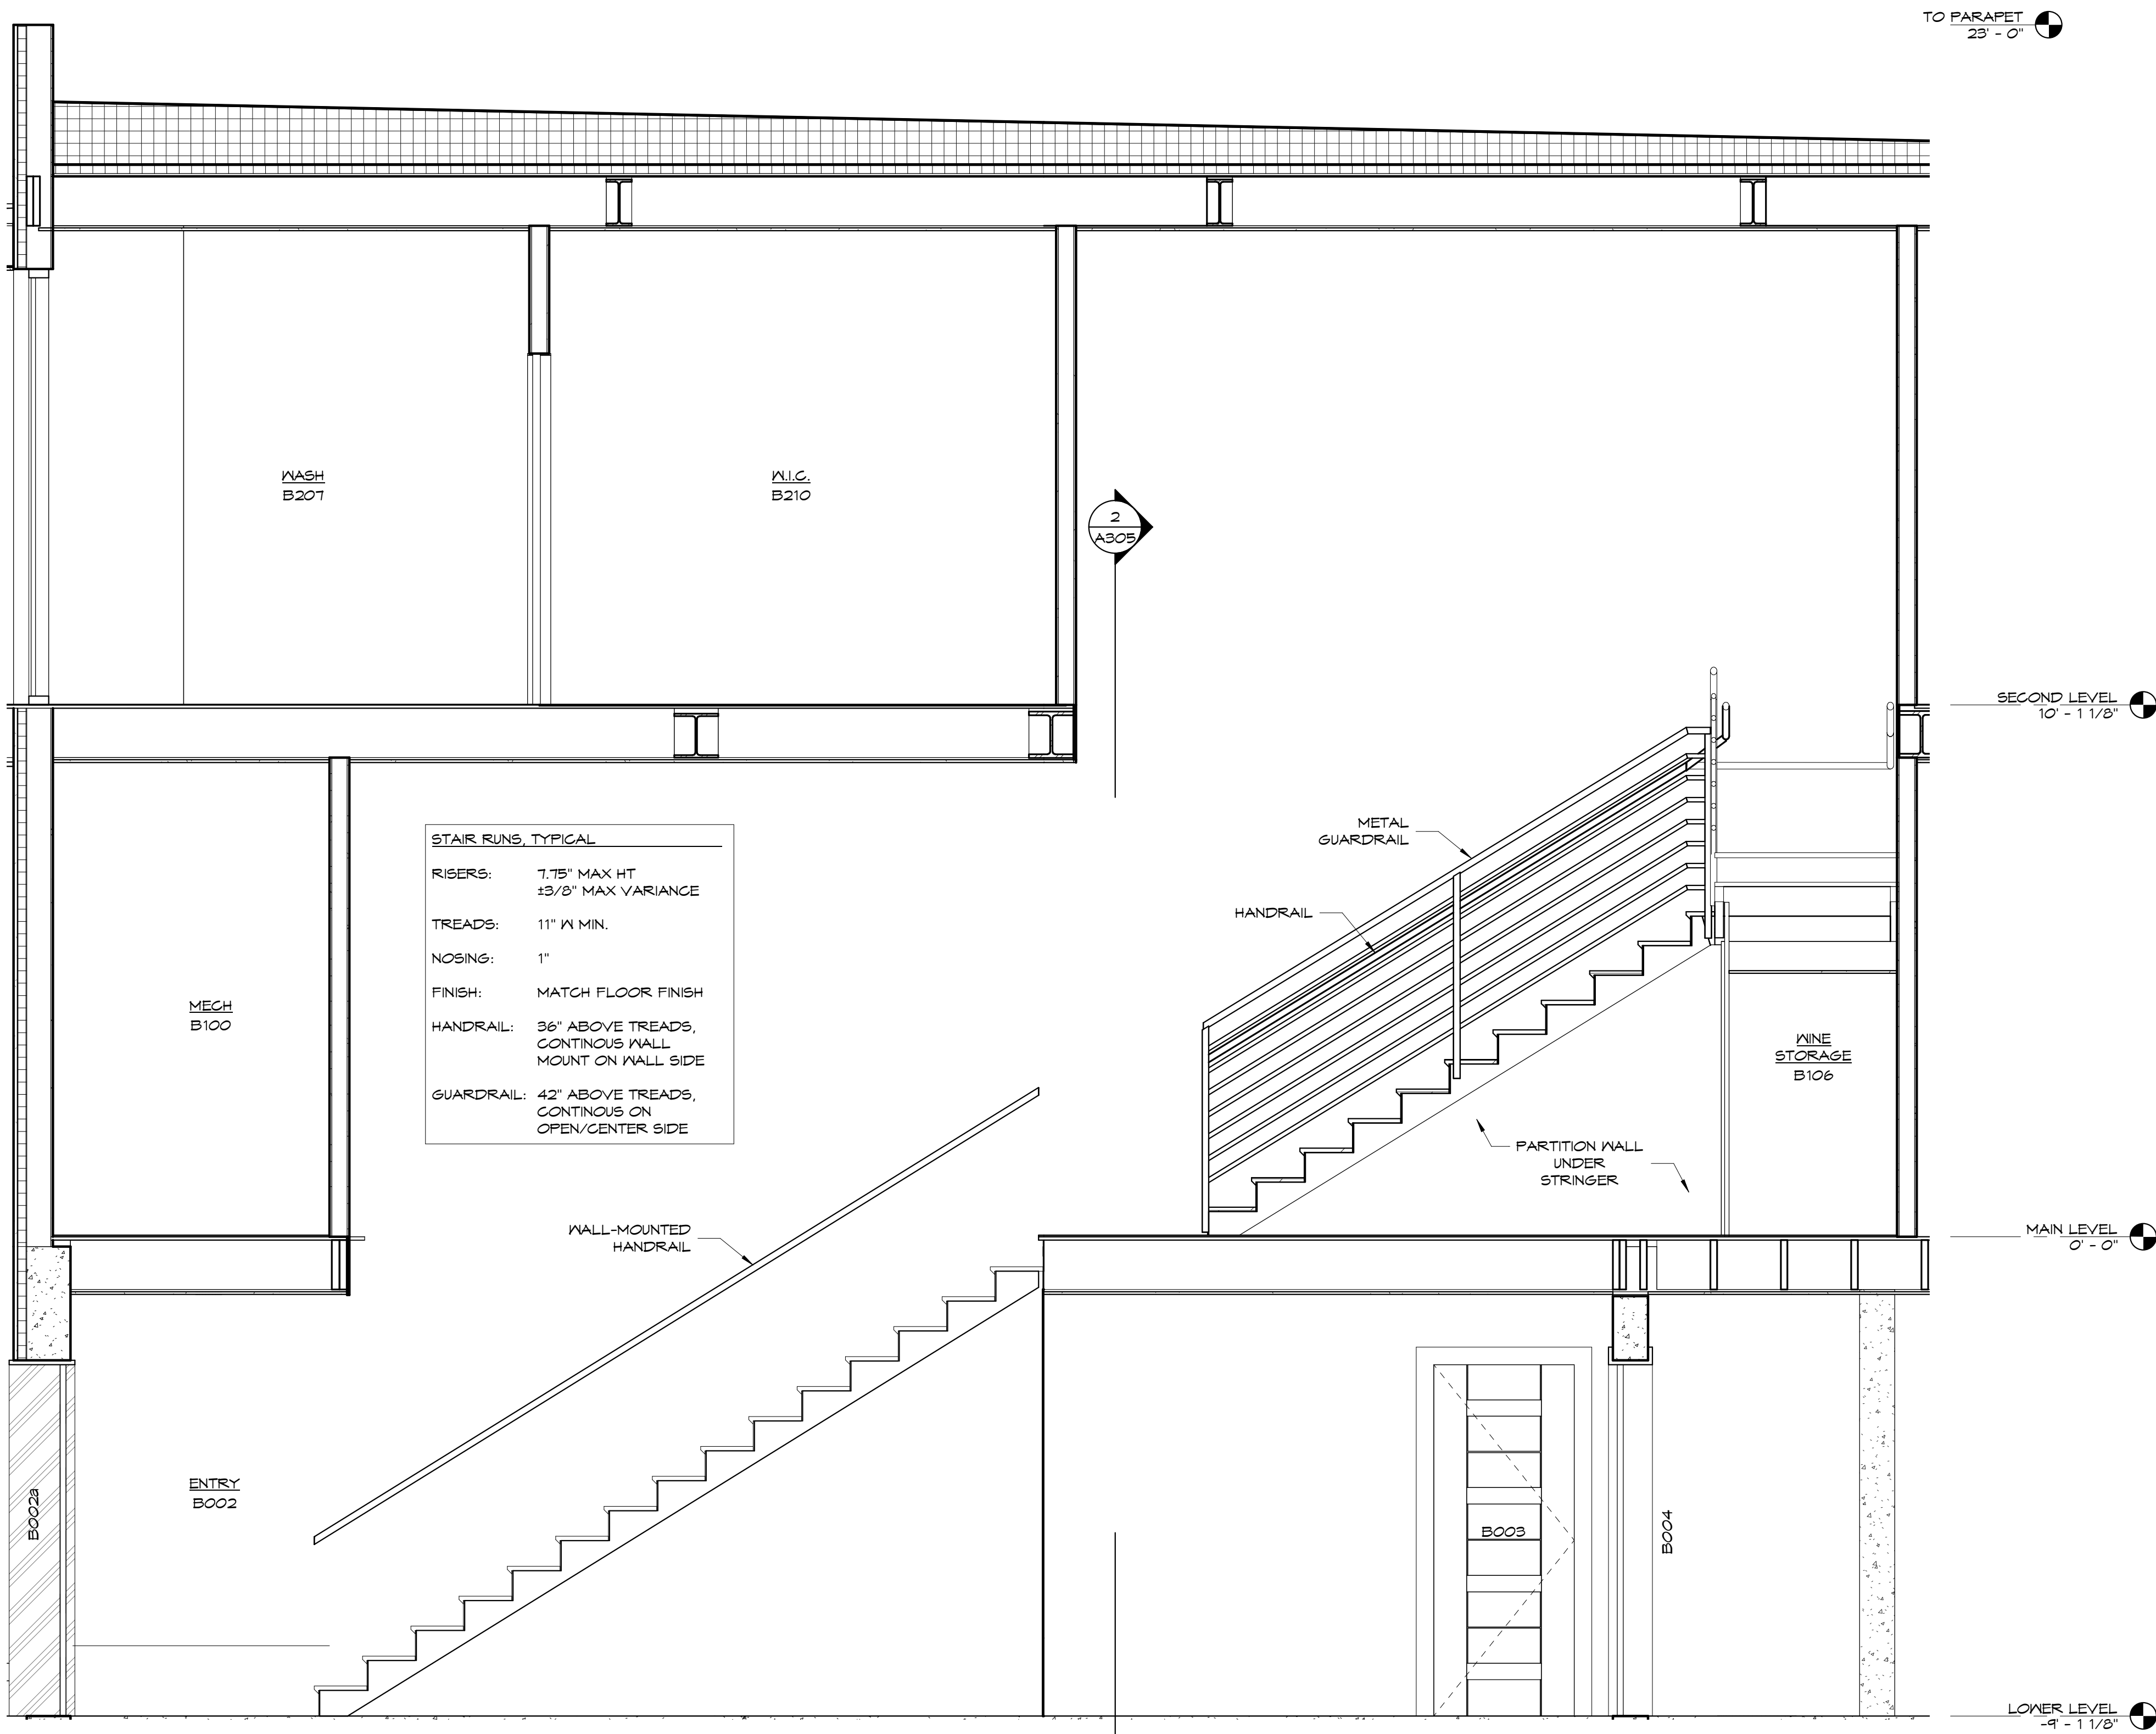stair notes

1. HANDRAIL AND GUARDRAIL FEATURES SHOWN AND DESCRIBED ON THIS SHEET ARE TYPICAL FOR ALL INTERIOR STAIRWAYS IN THIS PROJECT.
2. SEE ARCHITECTURAL FLOOR PLANS FOR LOCATIONS AND SPECIFIC NOTES ON PLACEMENT.
3. ALL STAIRS TO HAVE 11" TREADS AND 1" NOSING. RISE MAY VARY WITHIN CODE LIMITS.
4. PIPE HANDRAIL TO CODE ON BOTH SIDES OF STAIRWAYS HAVING 4 OR MORE STEPS.
5. HANDRAILS WALL MOUNTED WHERE POSSIBLE, WITH GUARDRAIL TO CODE ADDED AS NEEDED ON OPEN SIDE(S).
6. WHERE A STRAIGHT RUN HAS A WALL FOR AT LEAST HALF ITS LENGTH, WALL-MOUNT HANDRAIL WITHOUT GUARDRAIL AND PROVIDE GUARDRAIL ONLY AS NEEDED IN OPEN AREAS.
7. PER IRC 311.1.3.4, HANDRAILS ON STRAIGHT RUNS TO BE CONTINUOUS, REGARDLESS OF CHANGES IN MOUNTING.



2 section thru landing to second level stairs  
1/2" = 1'-0"

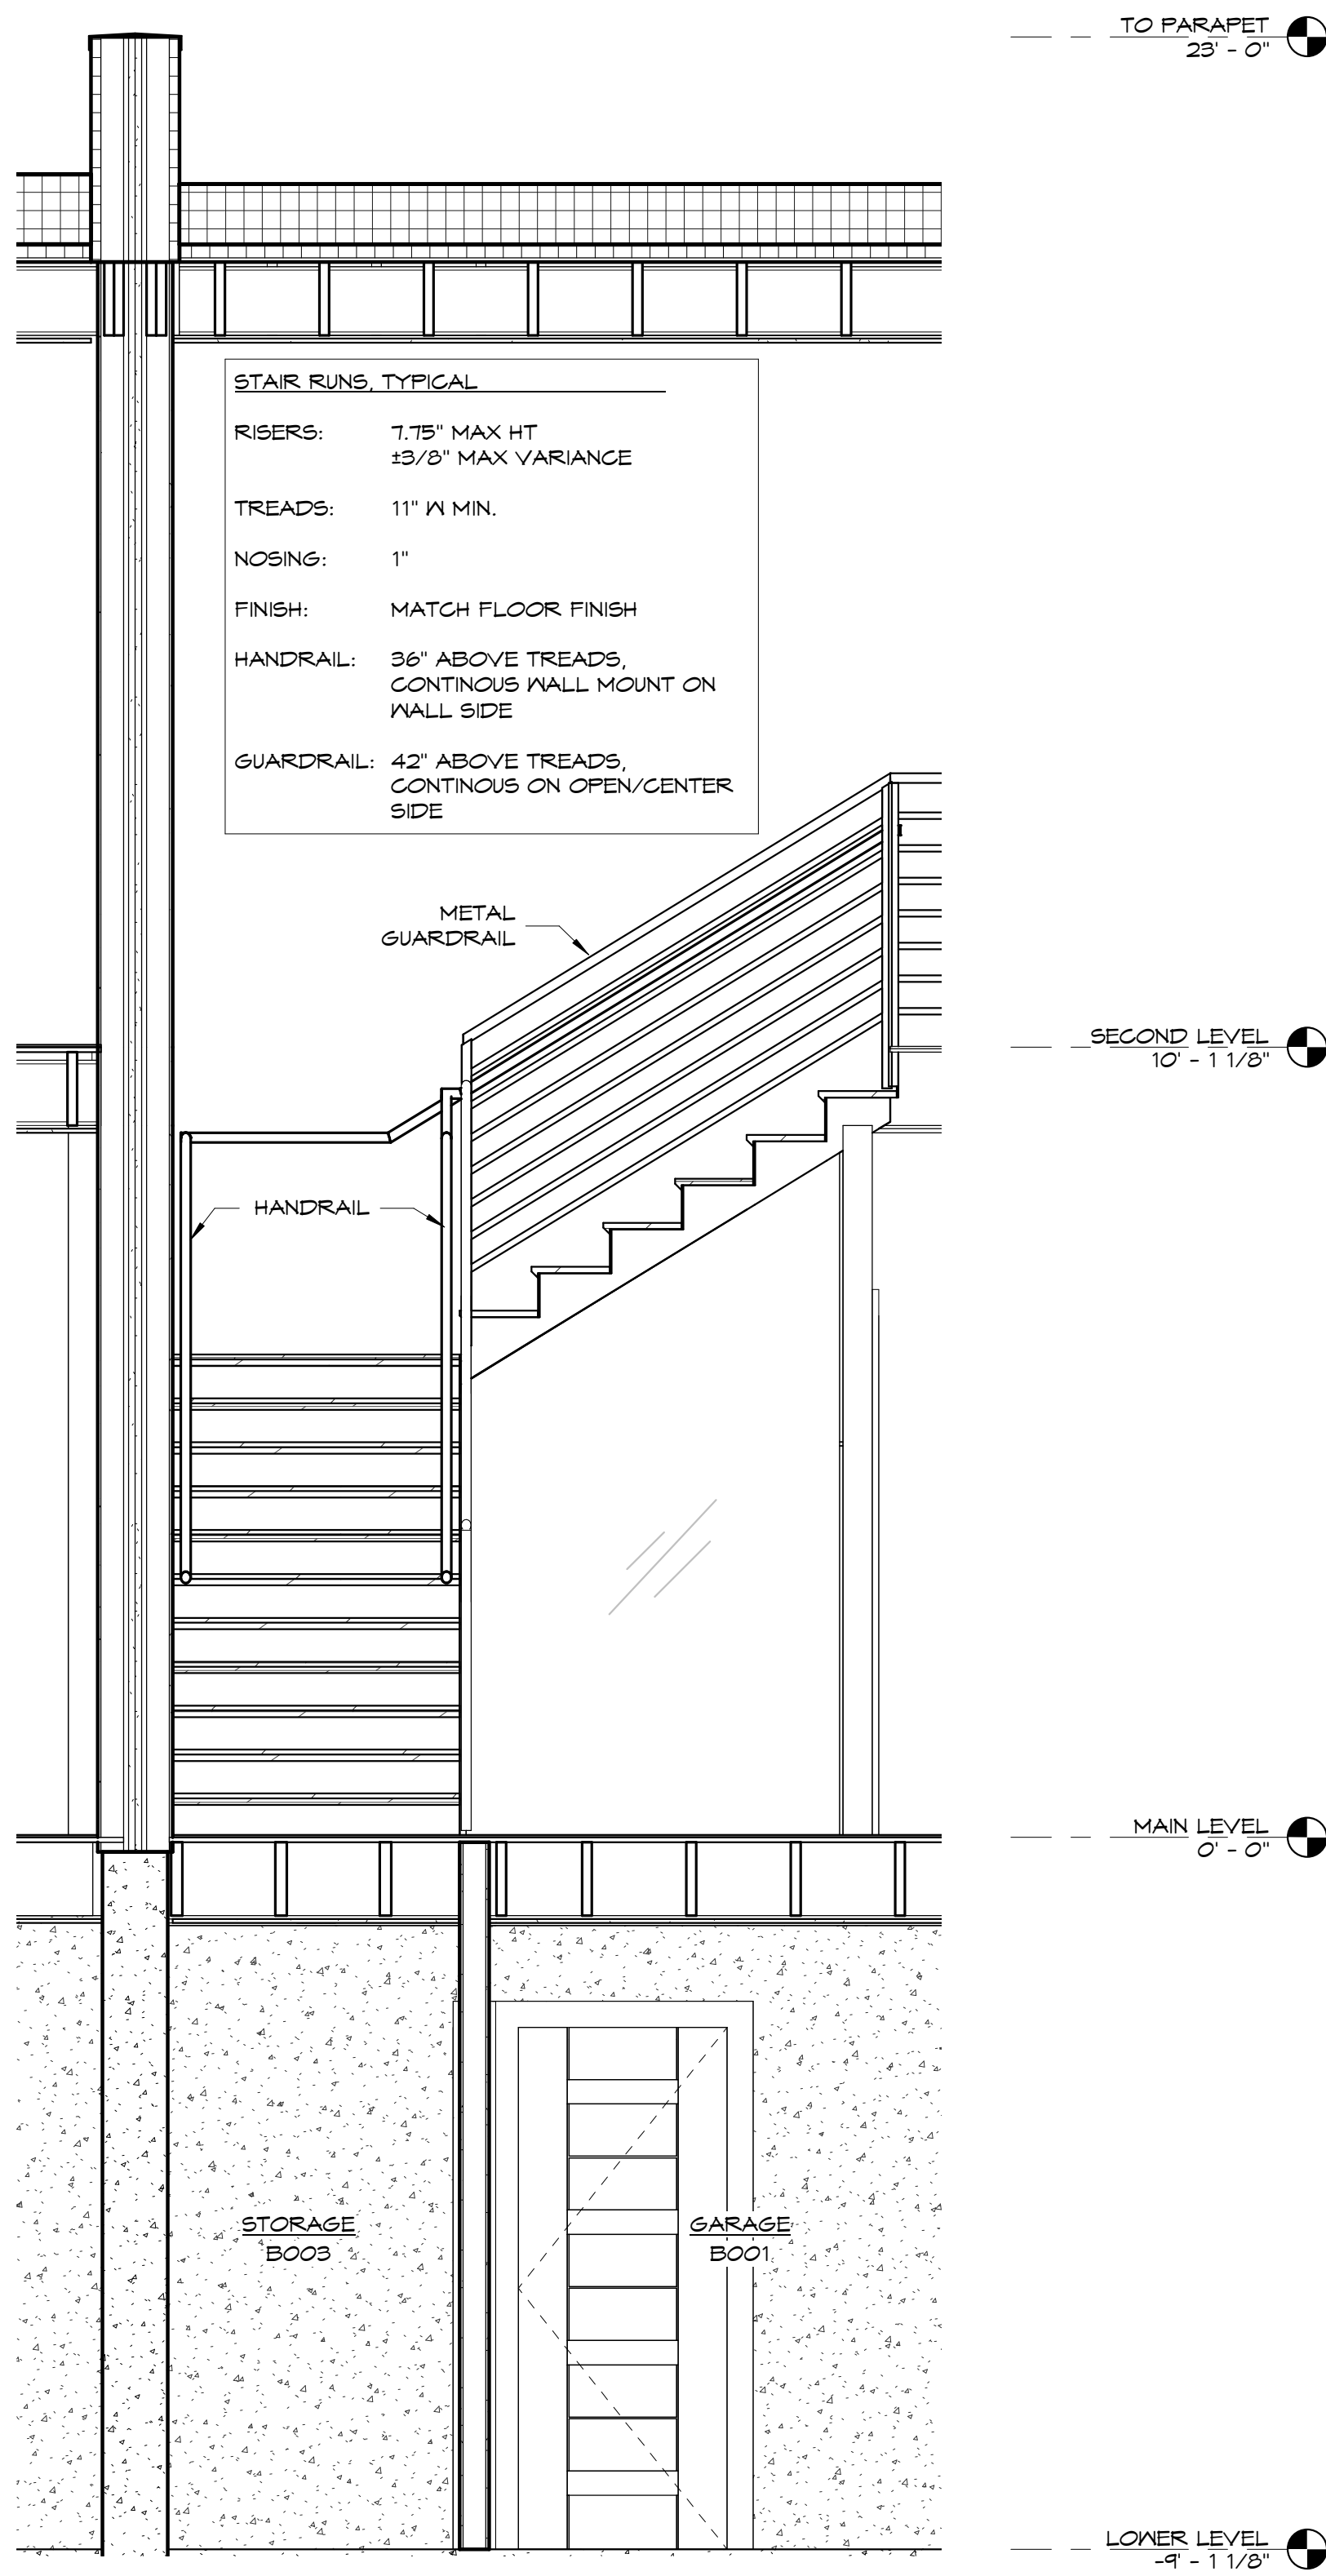

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REVISIONS  
No. Description Date

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09.27.2024

project no.:  
20.32


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STAIR SECTIONS

sheet no.:


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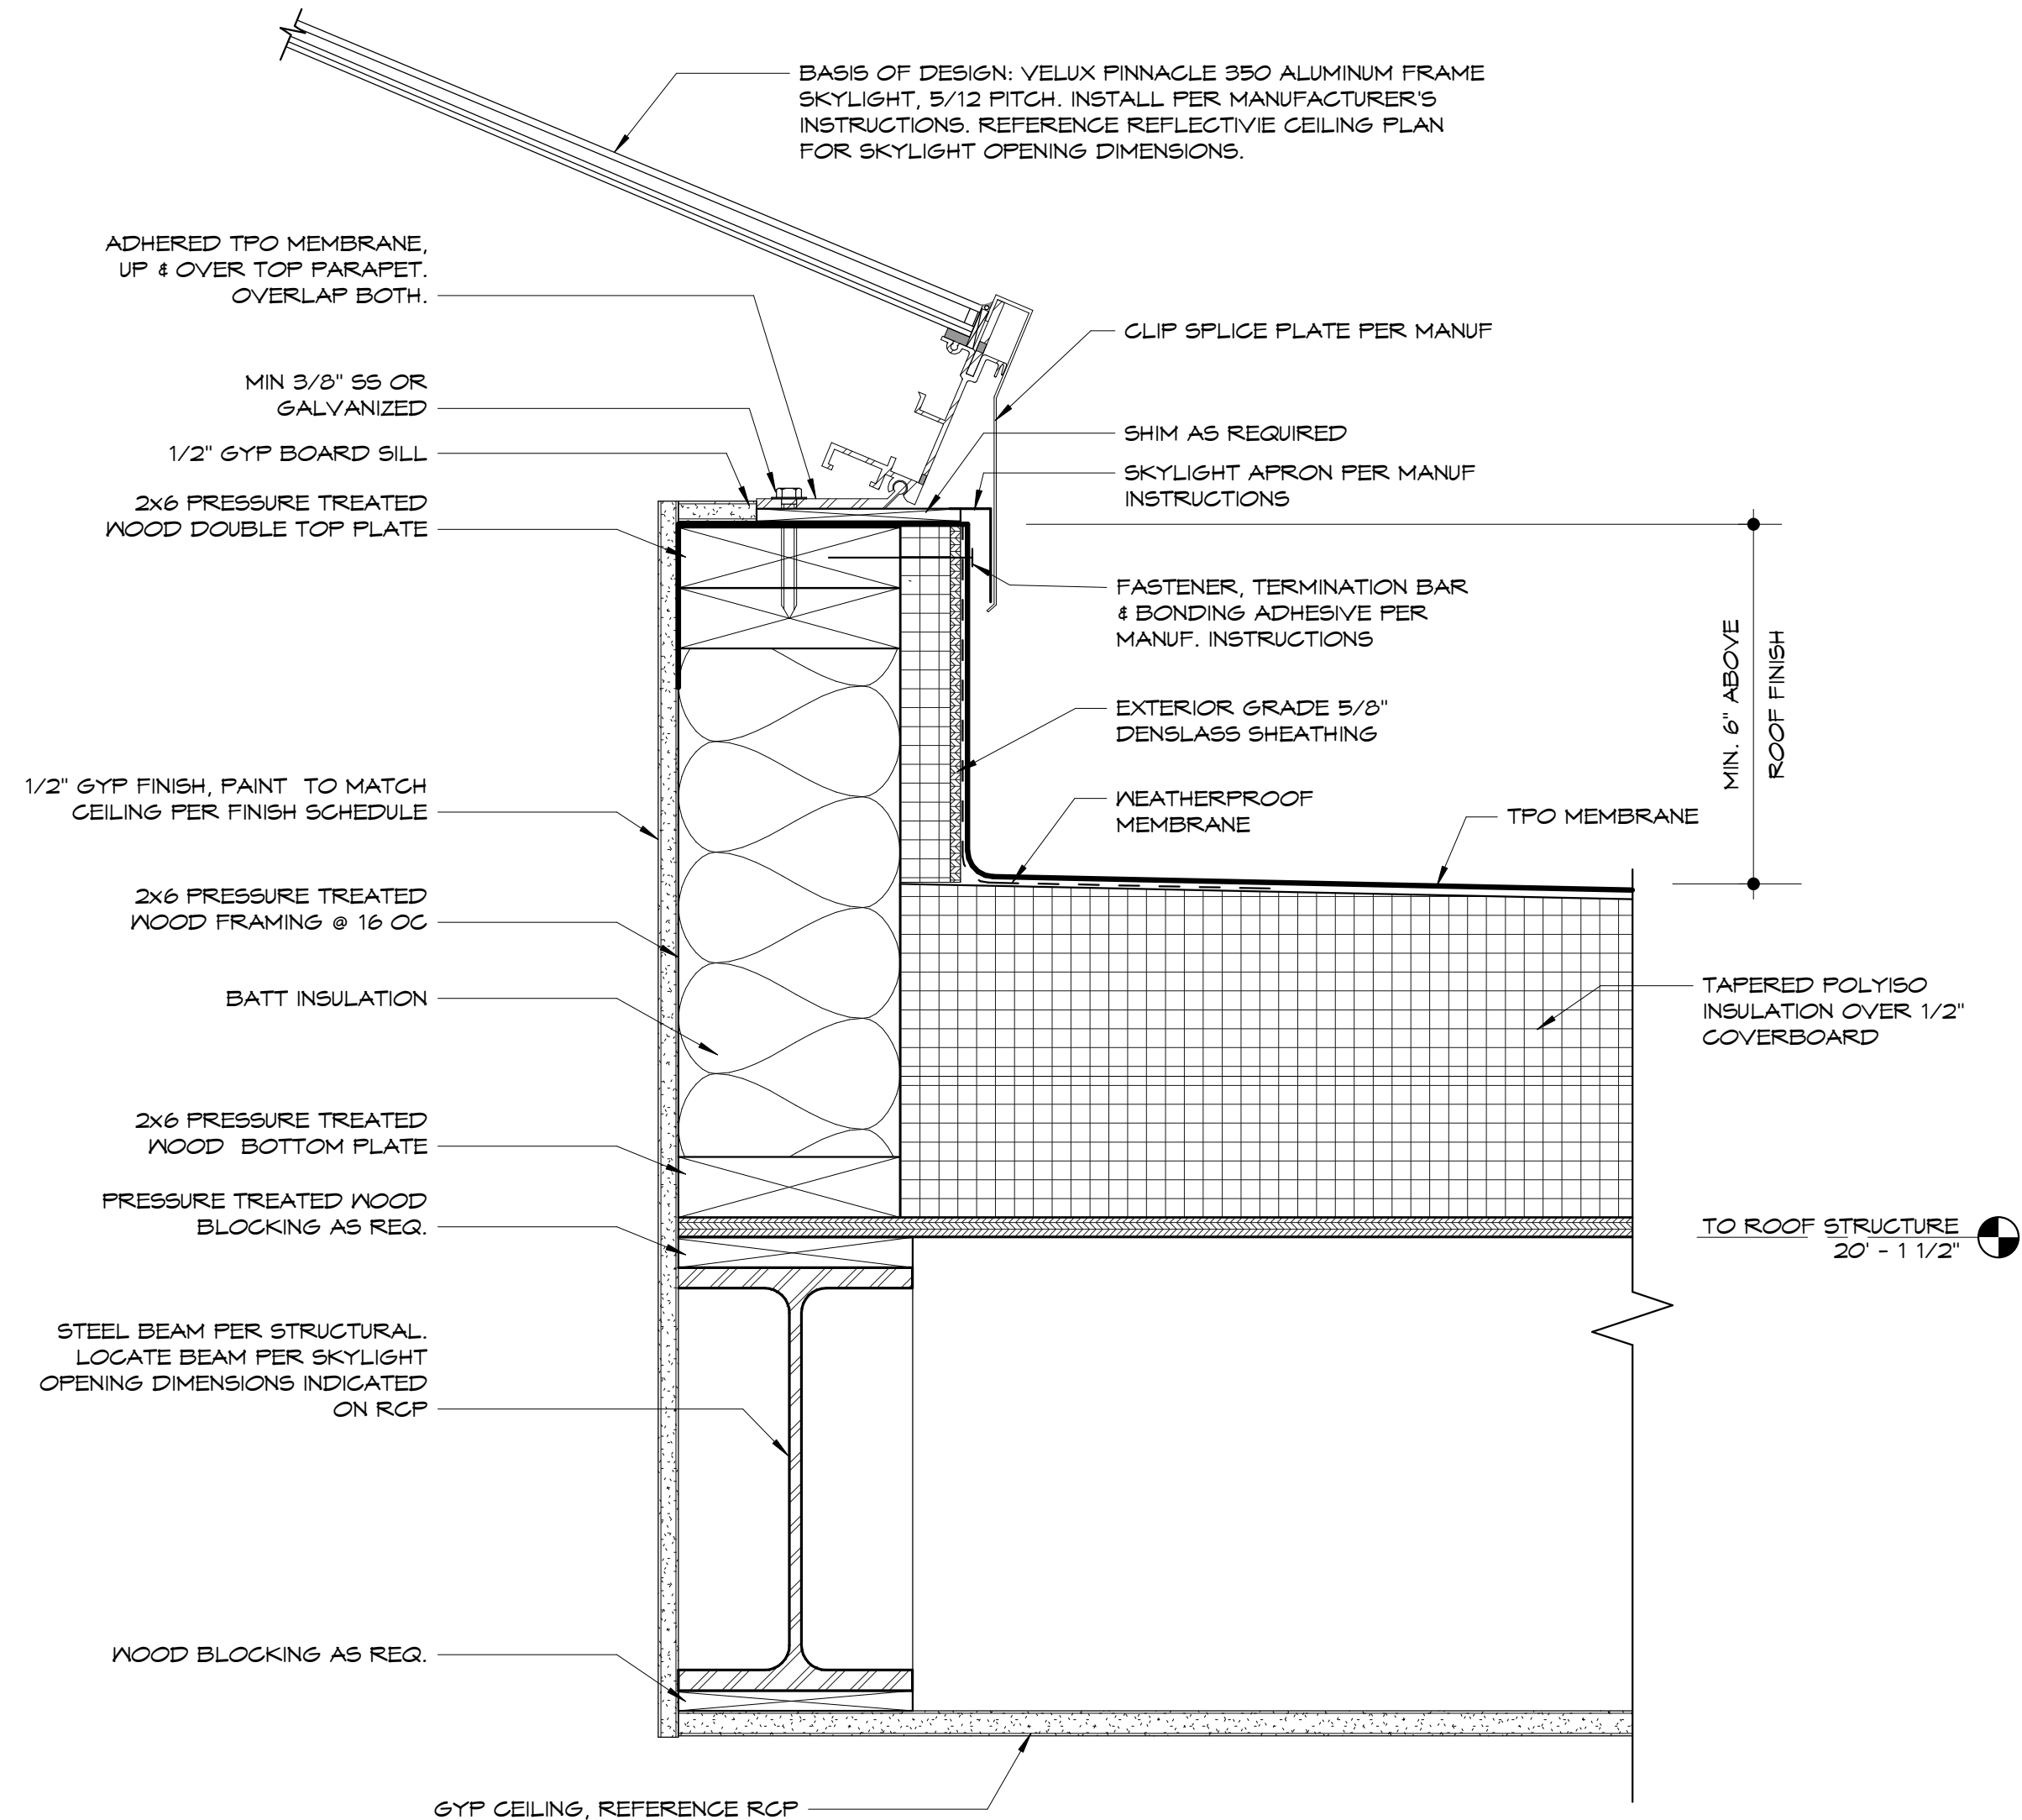
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3 detail at parapet / bathroom roof interface  
3" = 1'-0"



2 upper level deck guardrail detail  
3" = 1'-0"

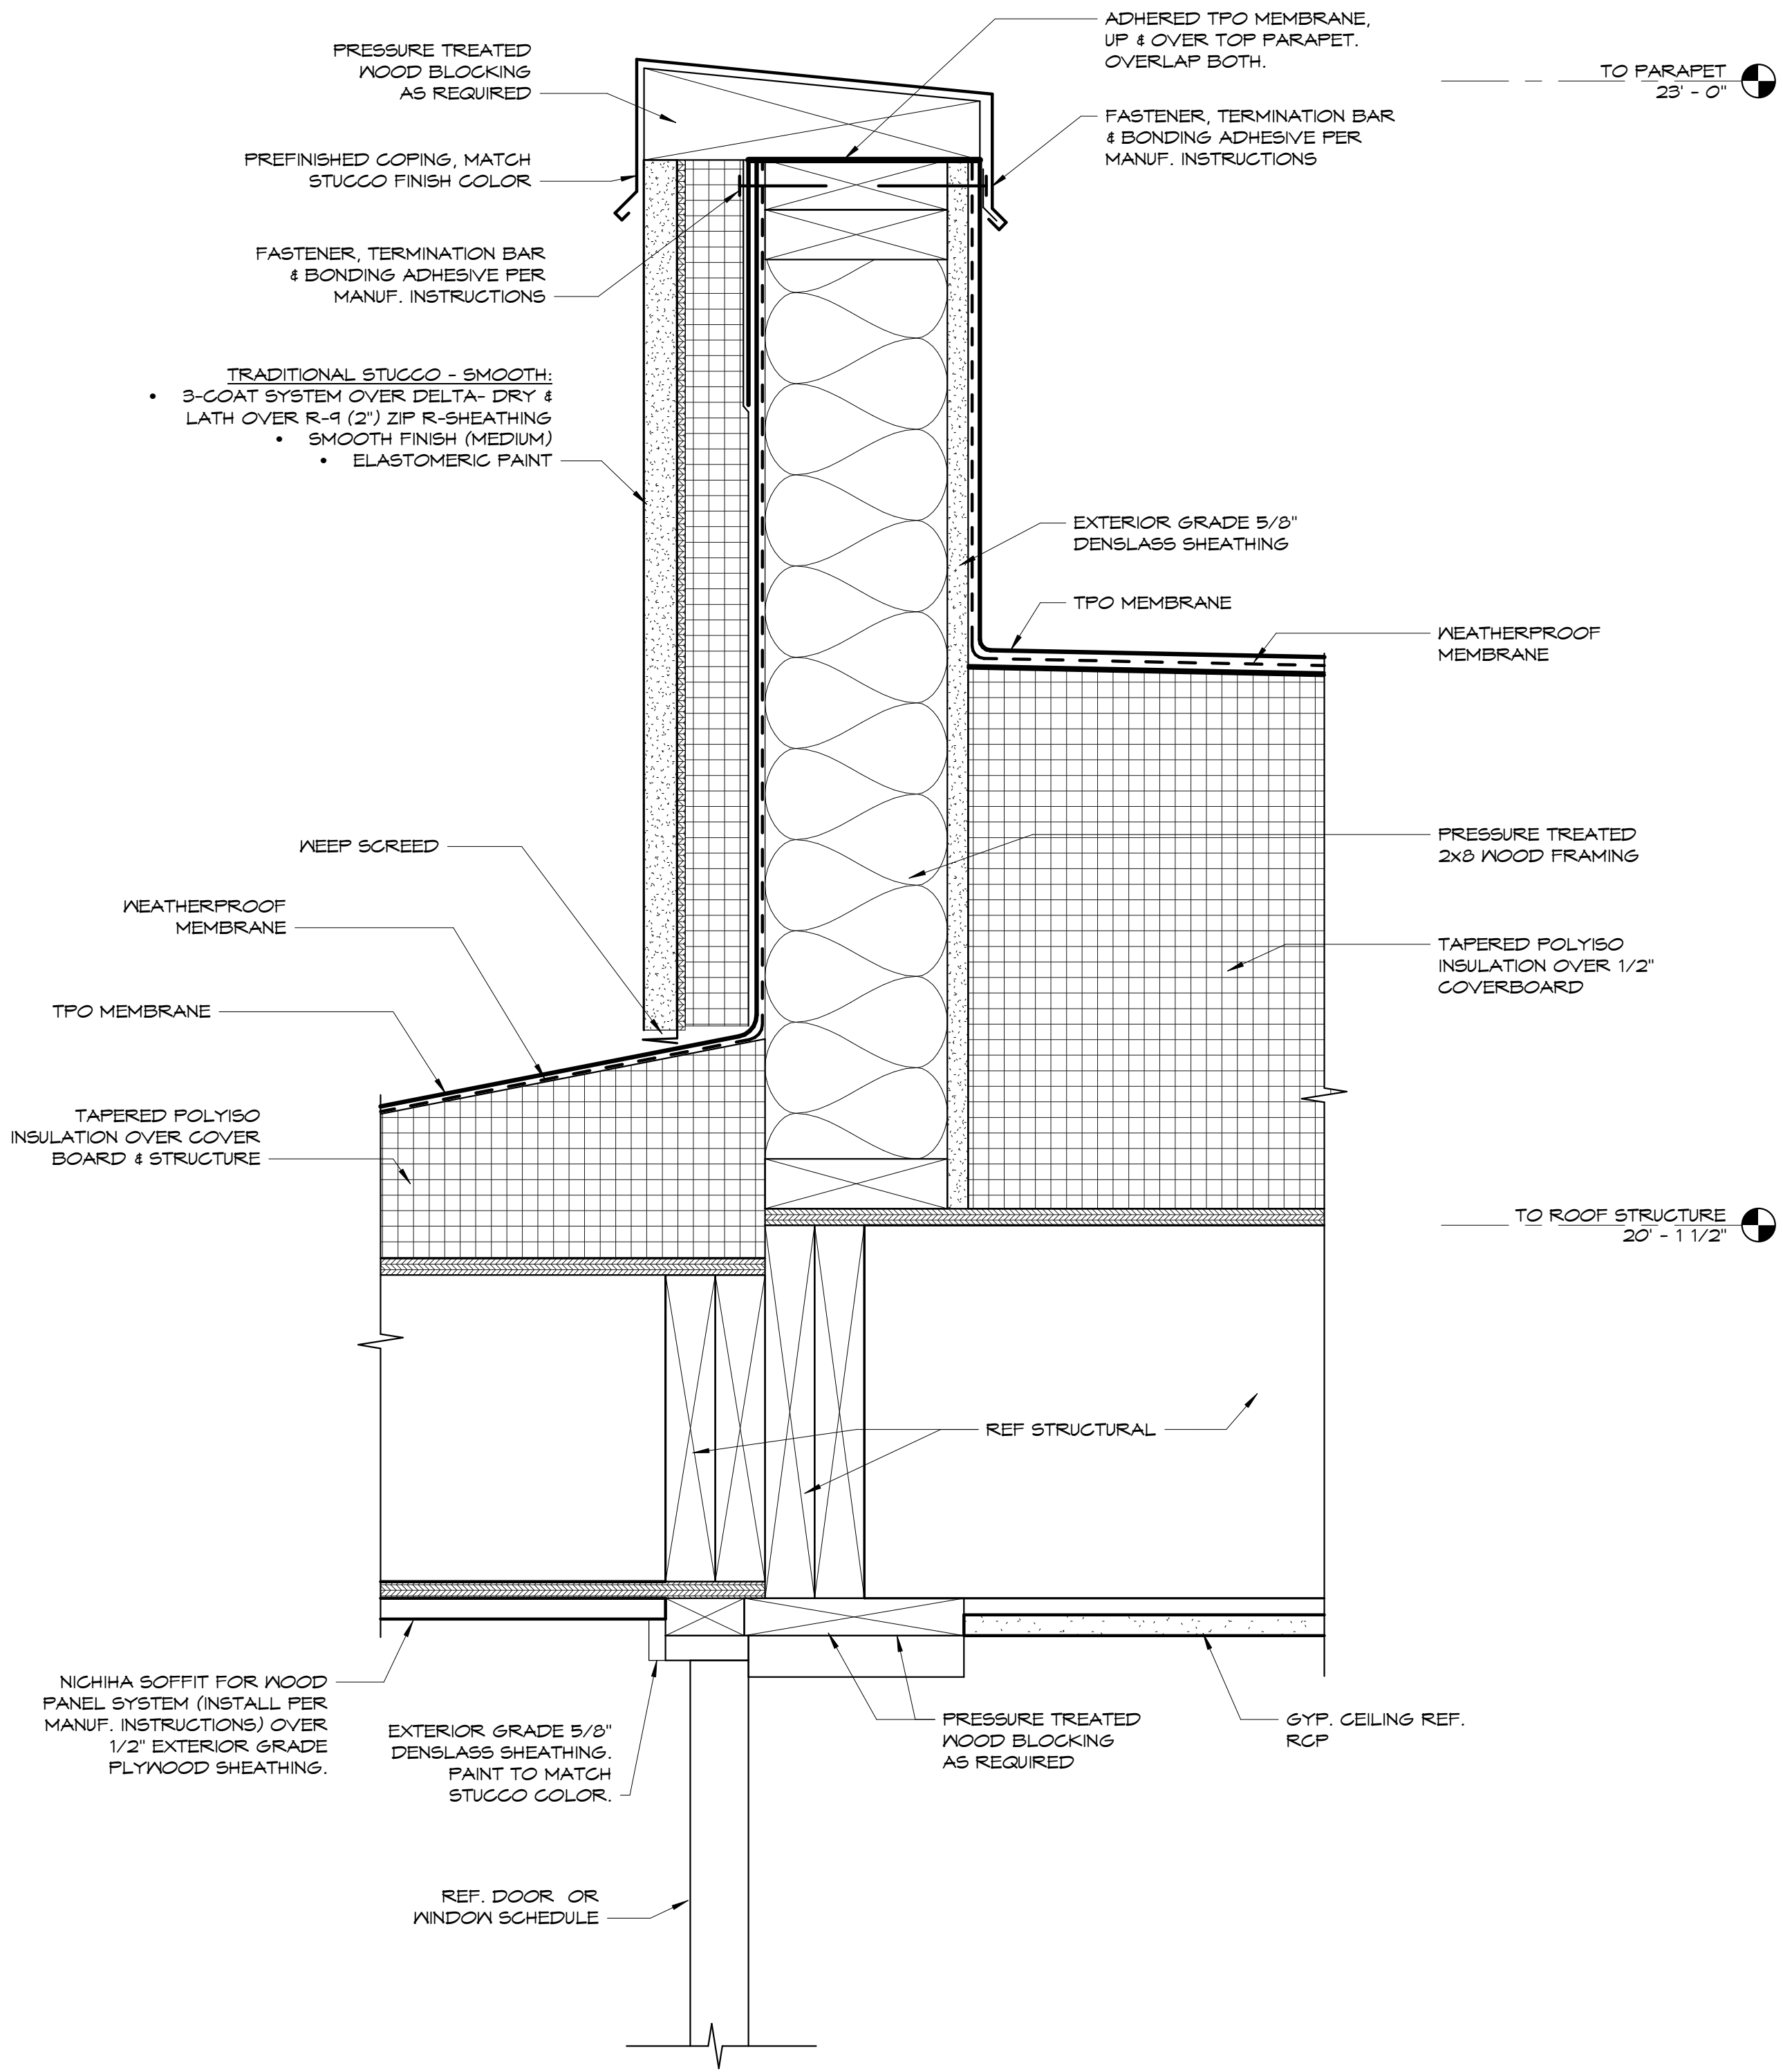

1 skylight curb detail  
3" = 1'-0"
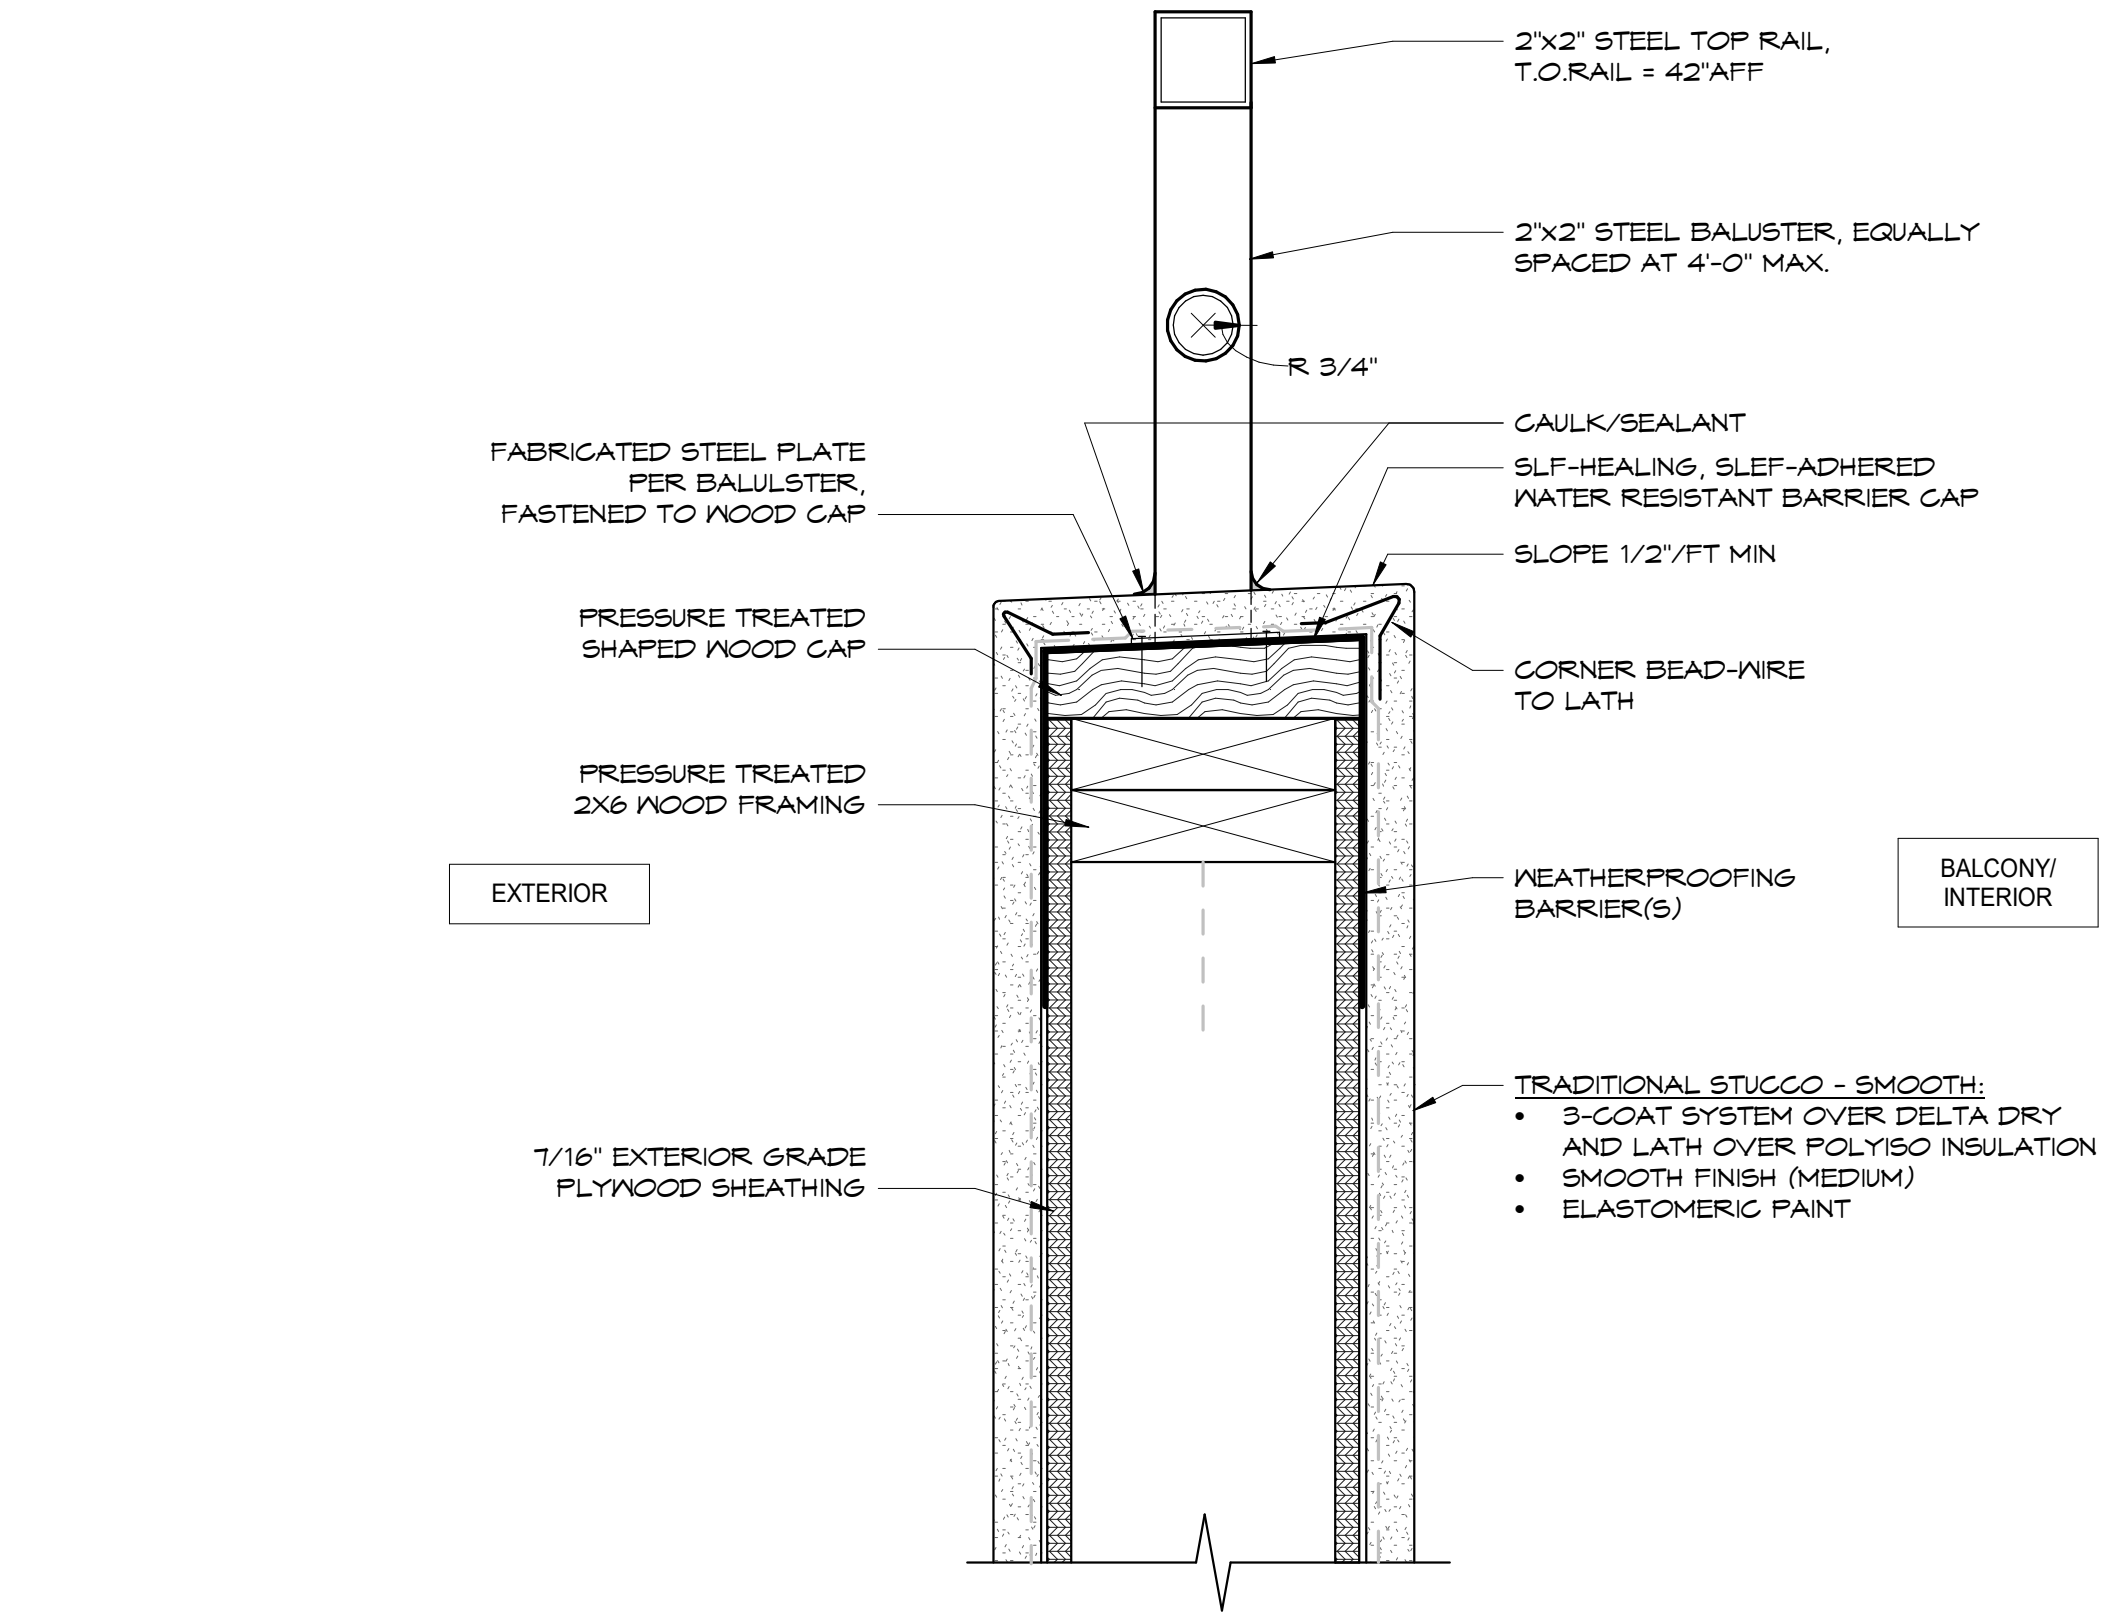
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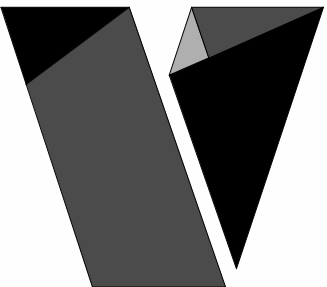
project no.:  
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sheet contents:  
DETAILS

sheet no.:

A306





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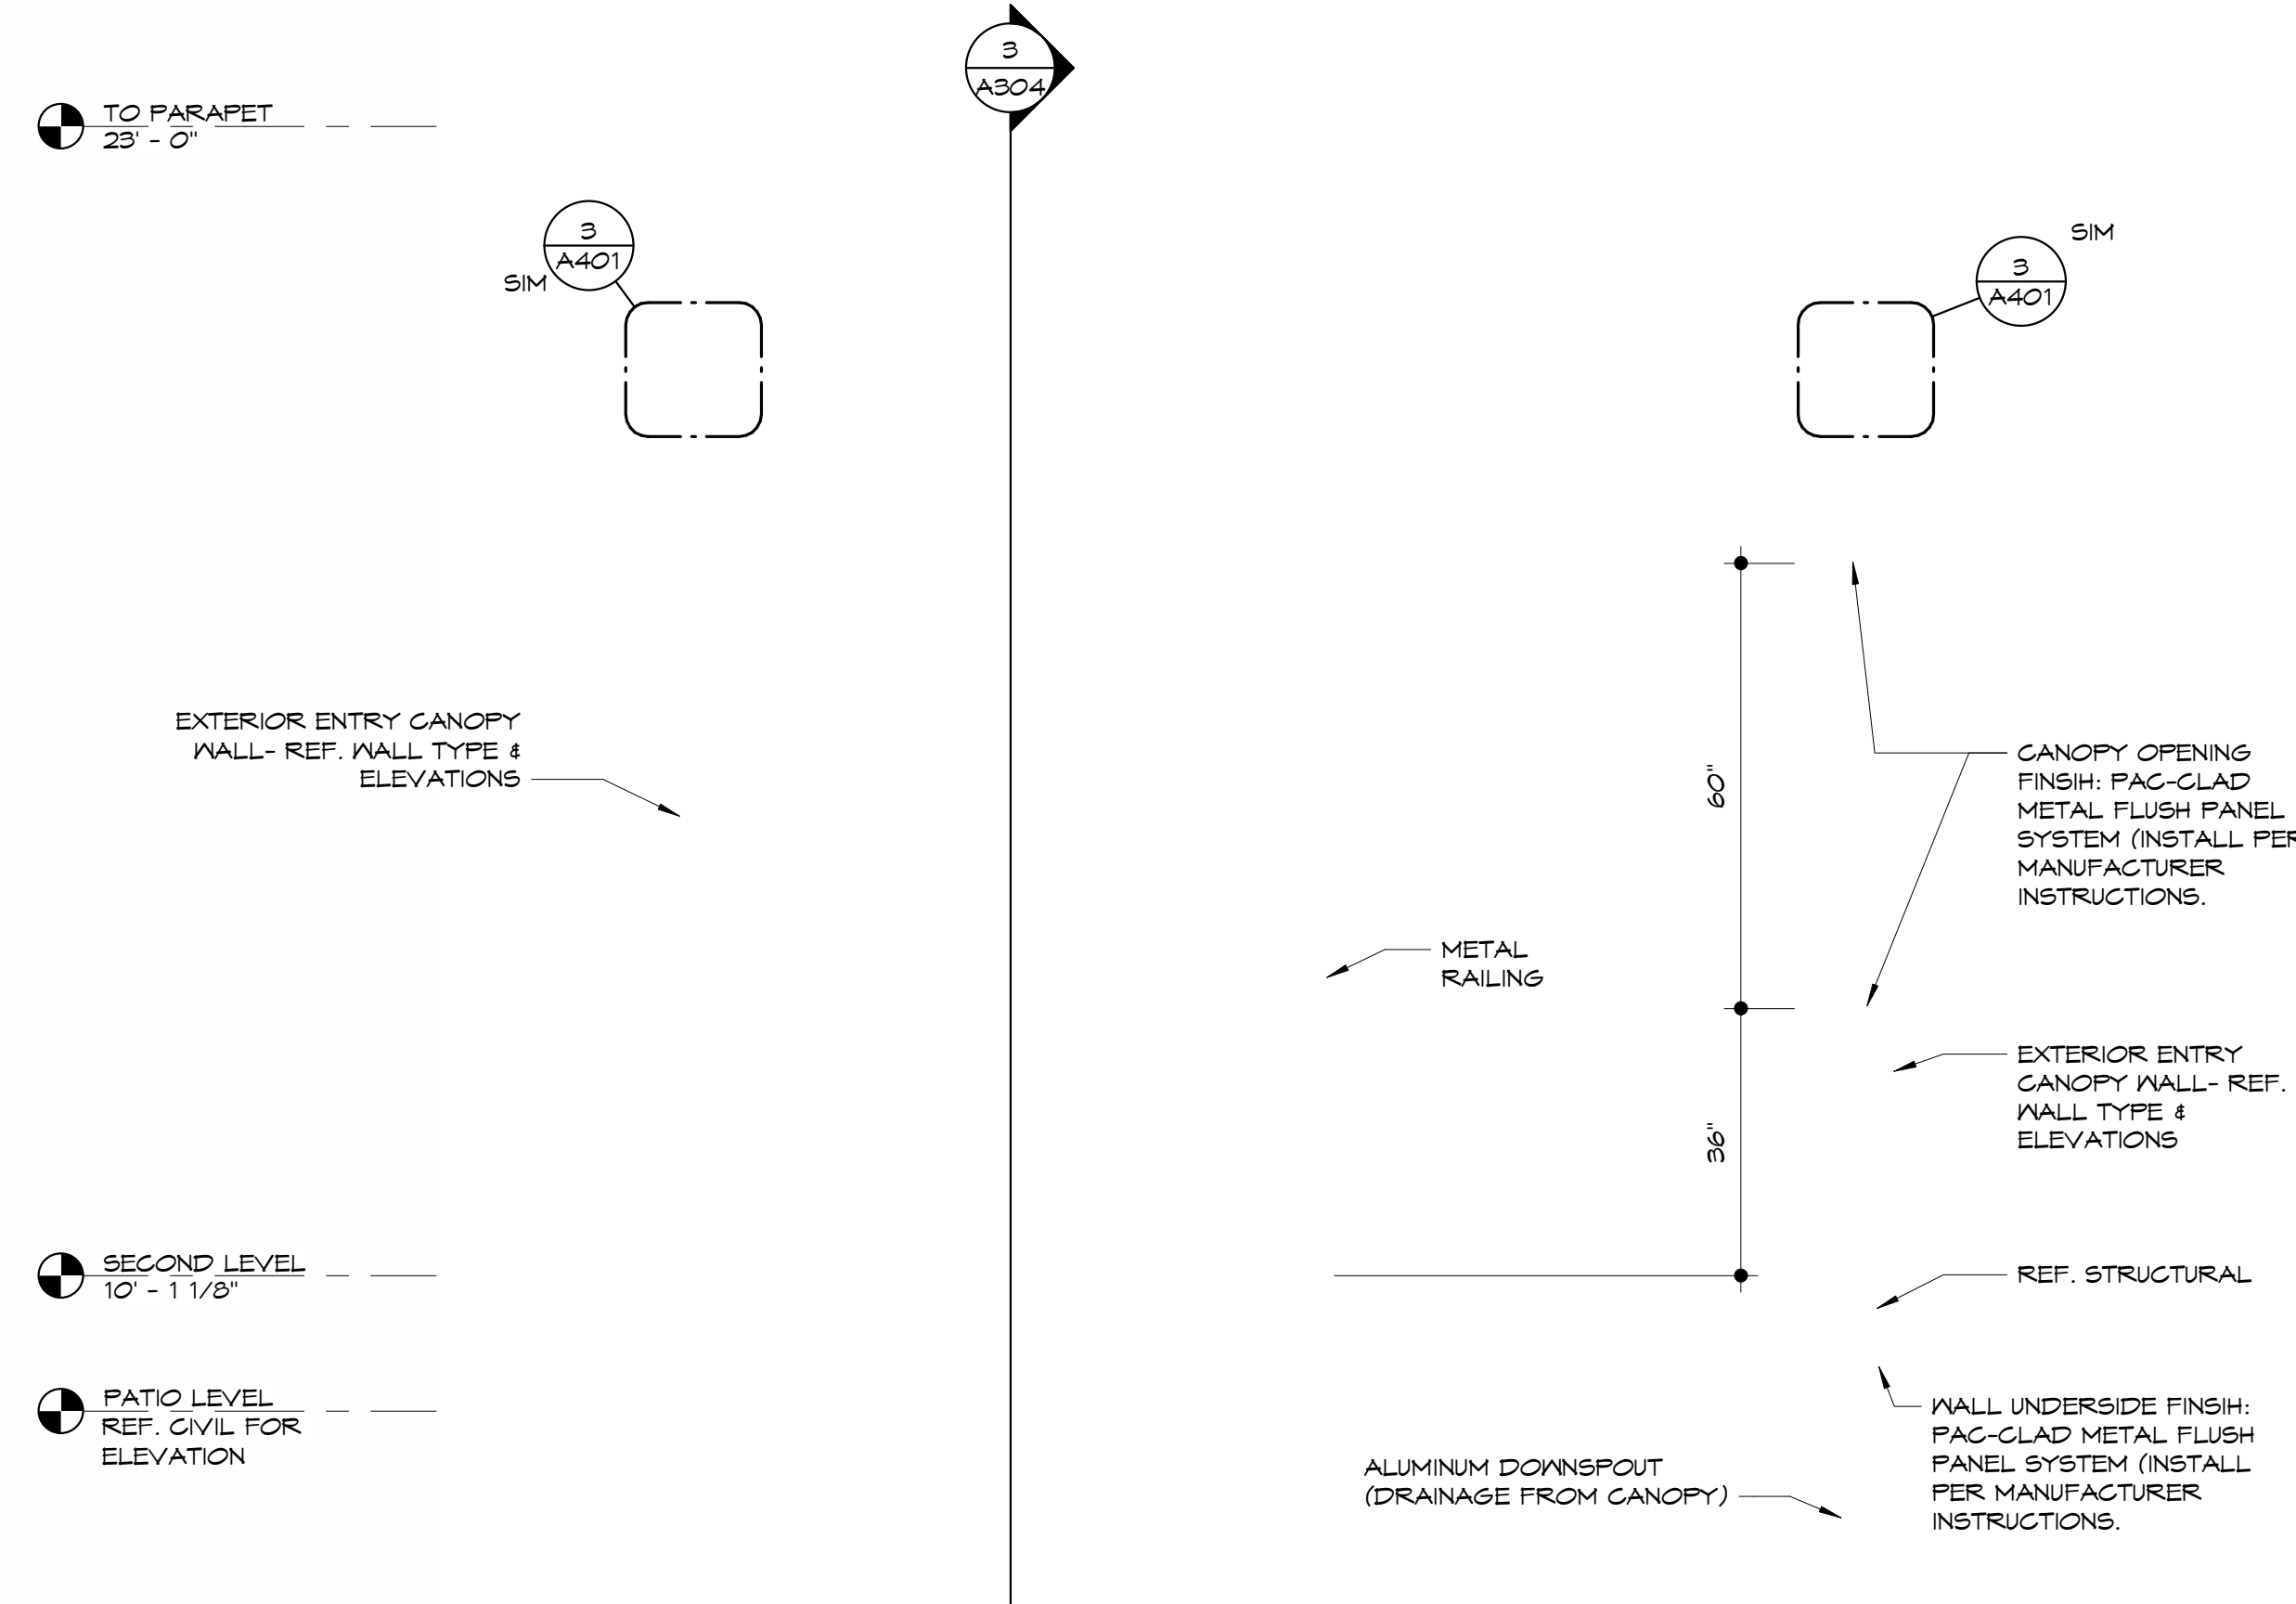
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09.27.2024

project no.:  
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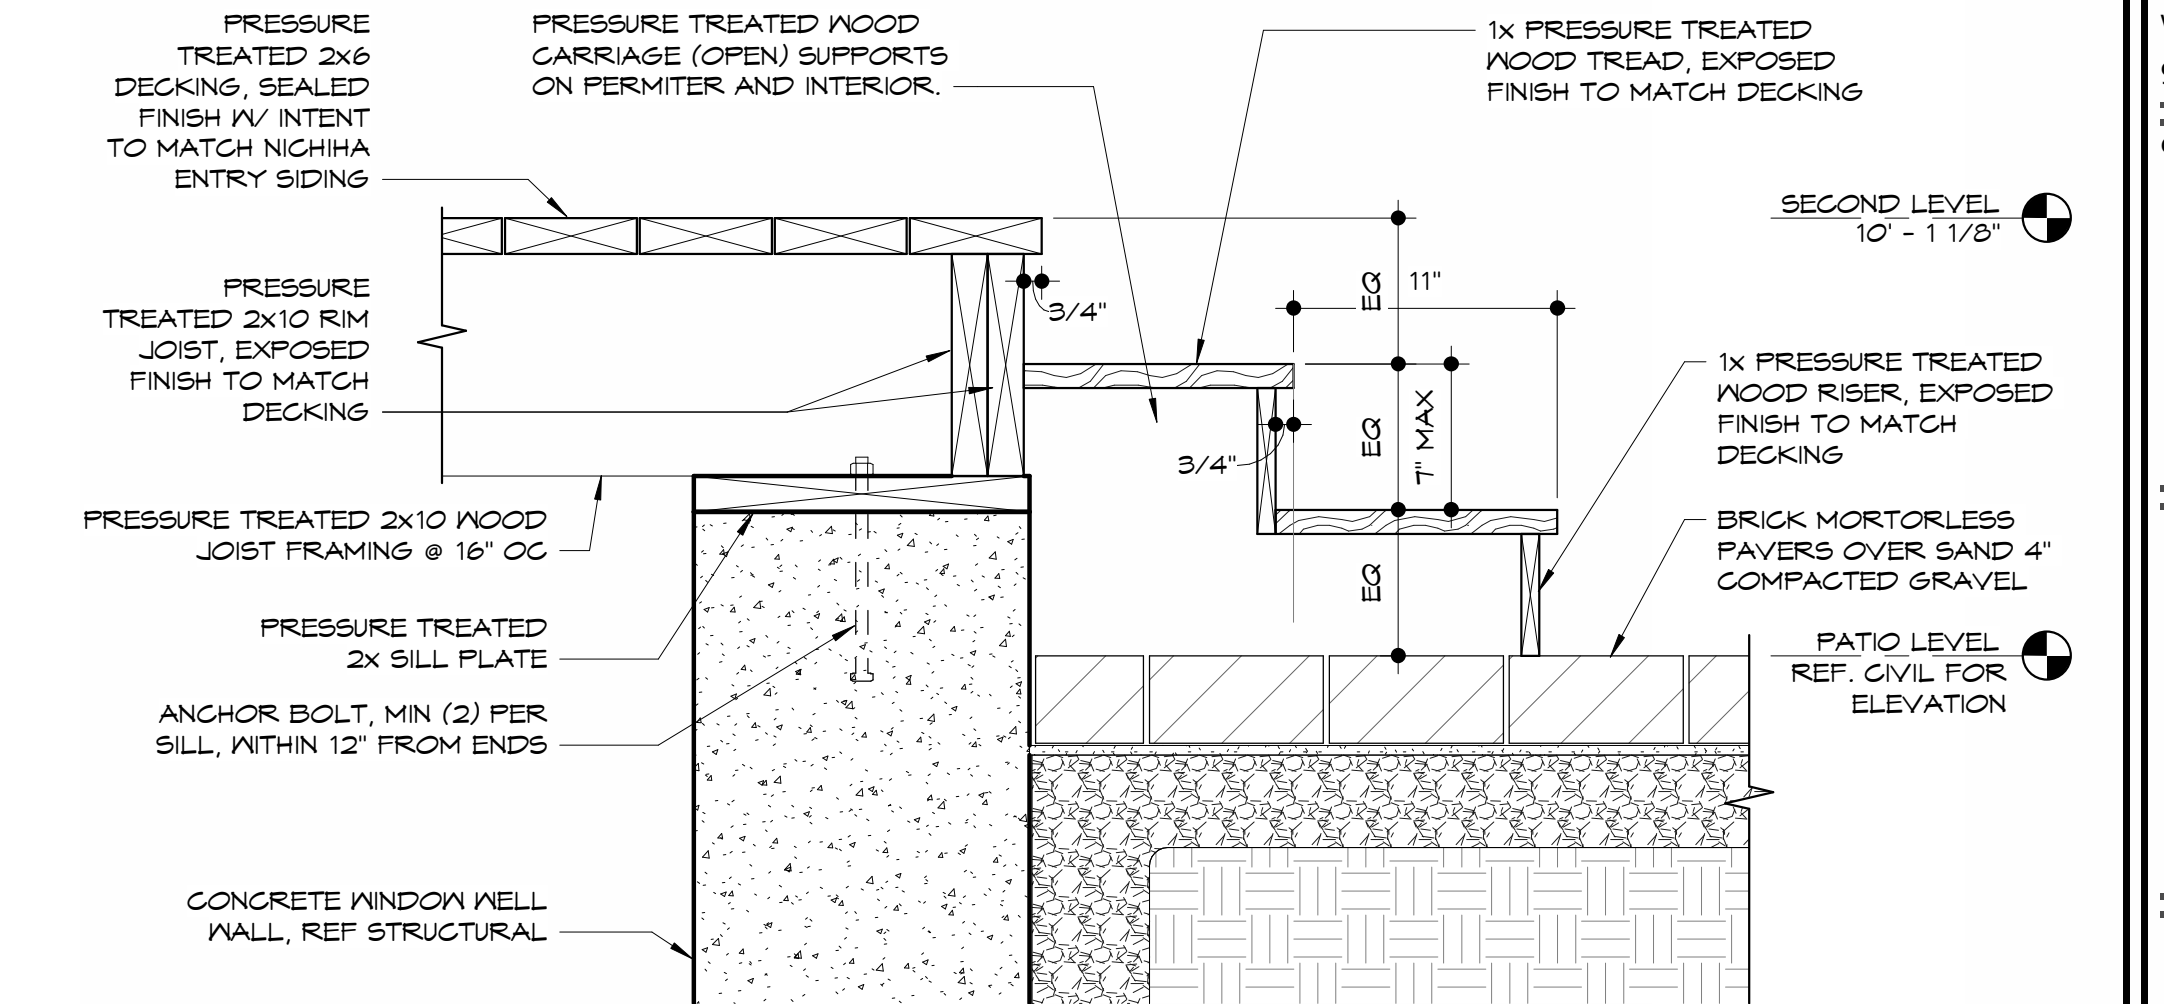
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DETAILS

sheet no.:


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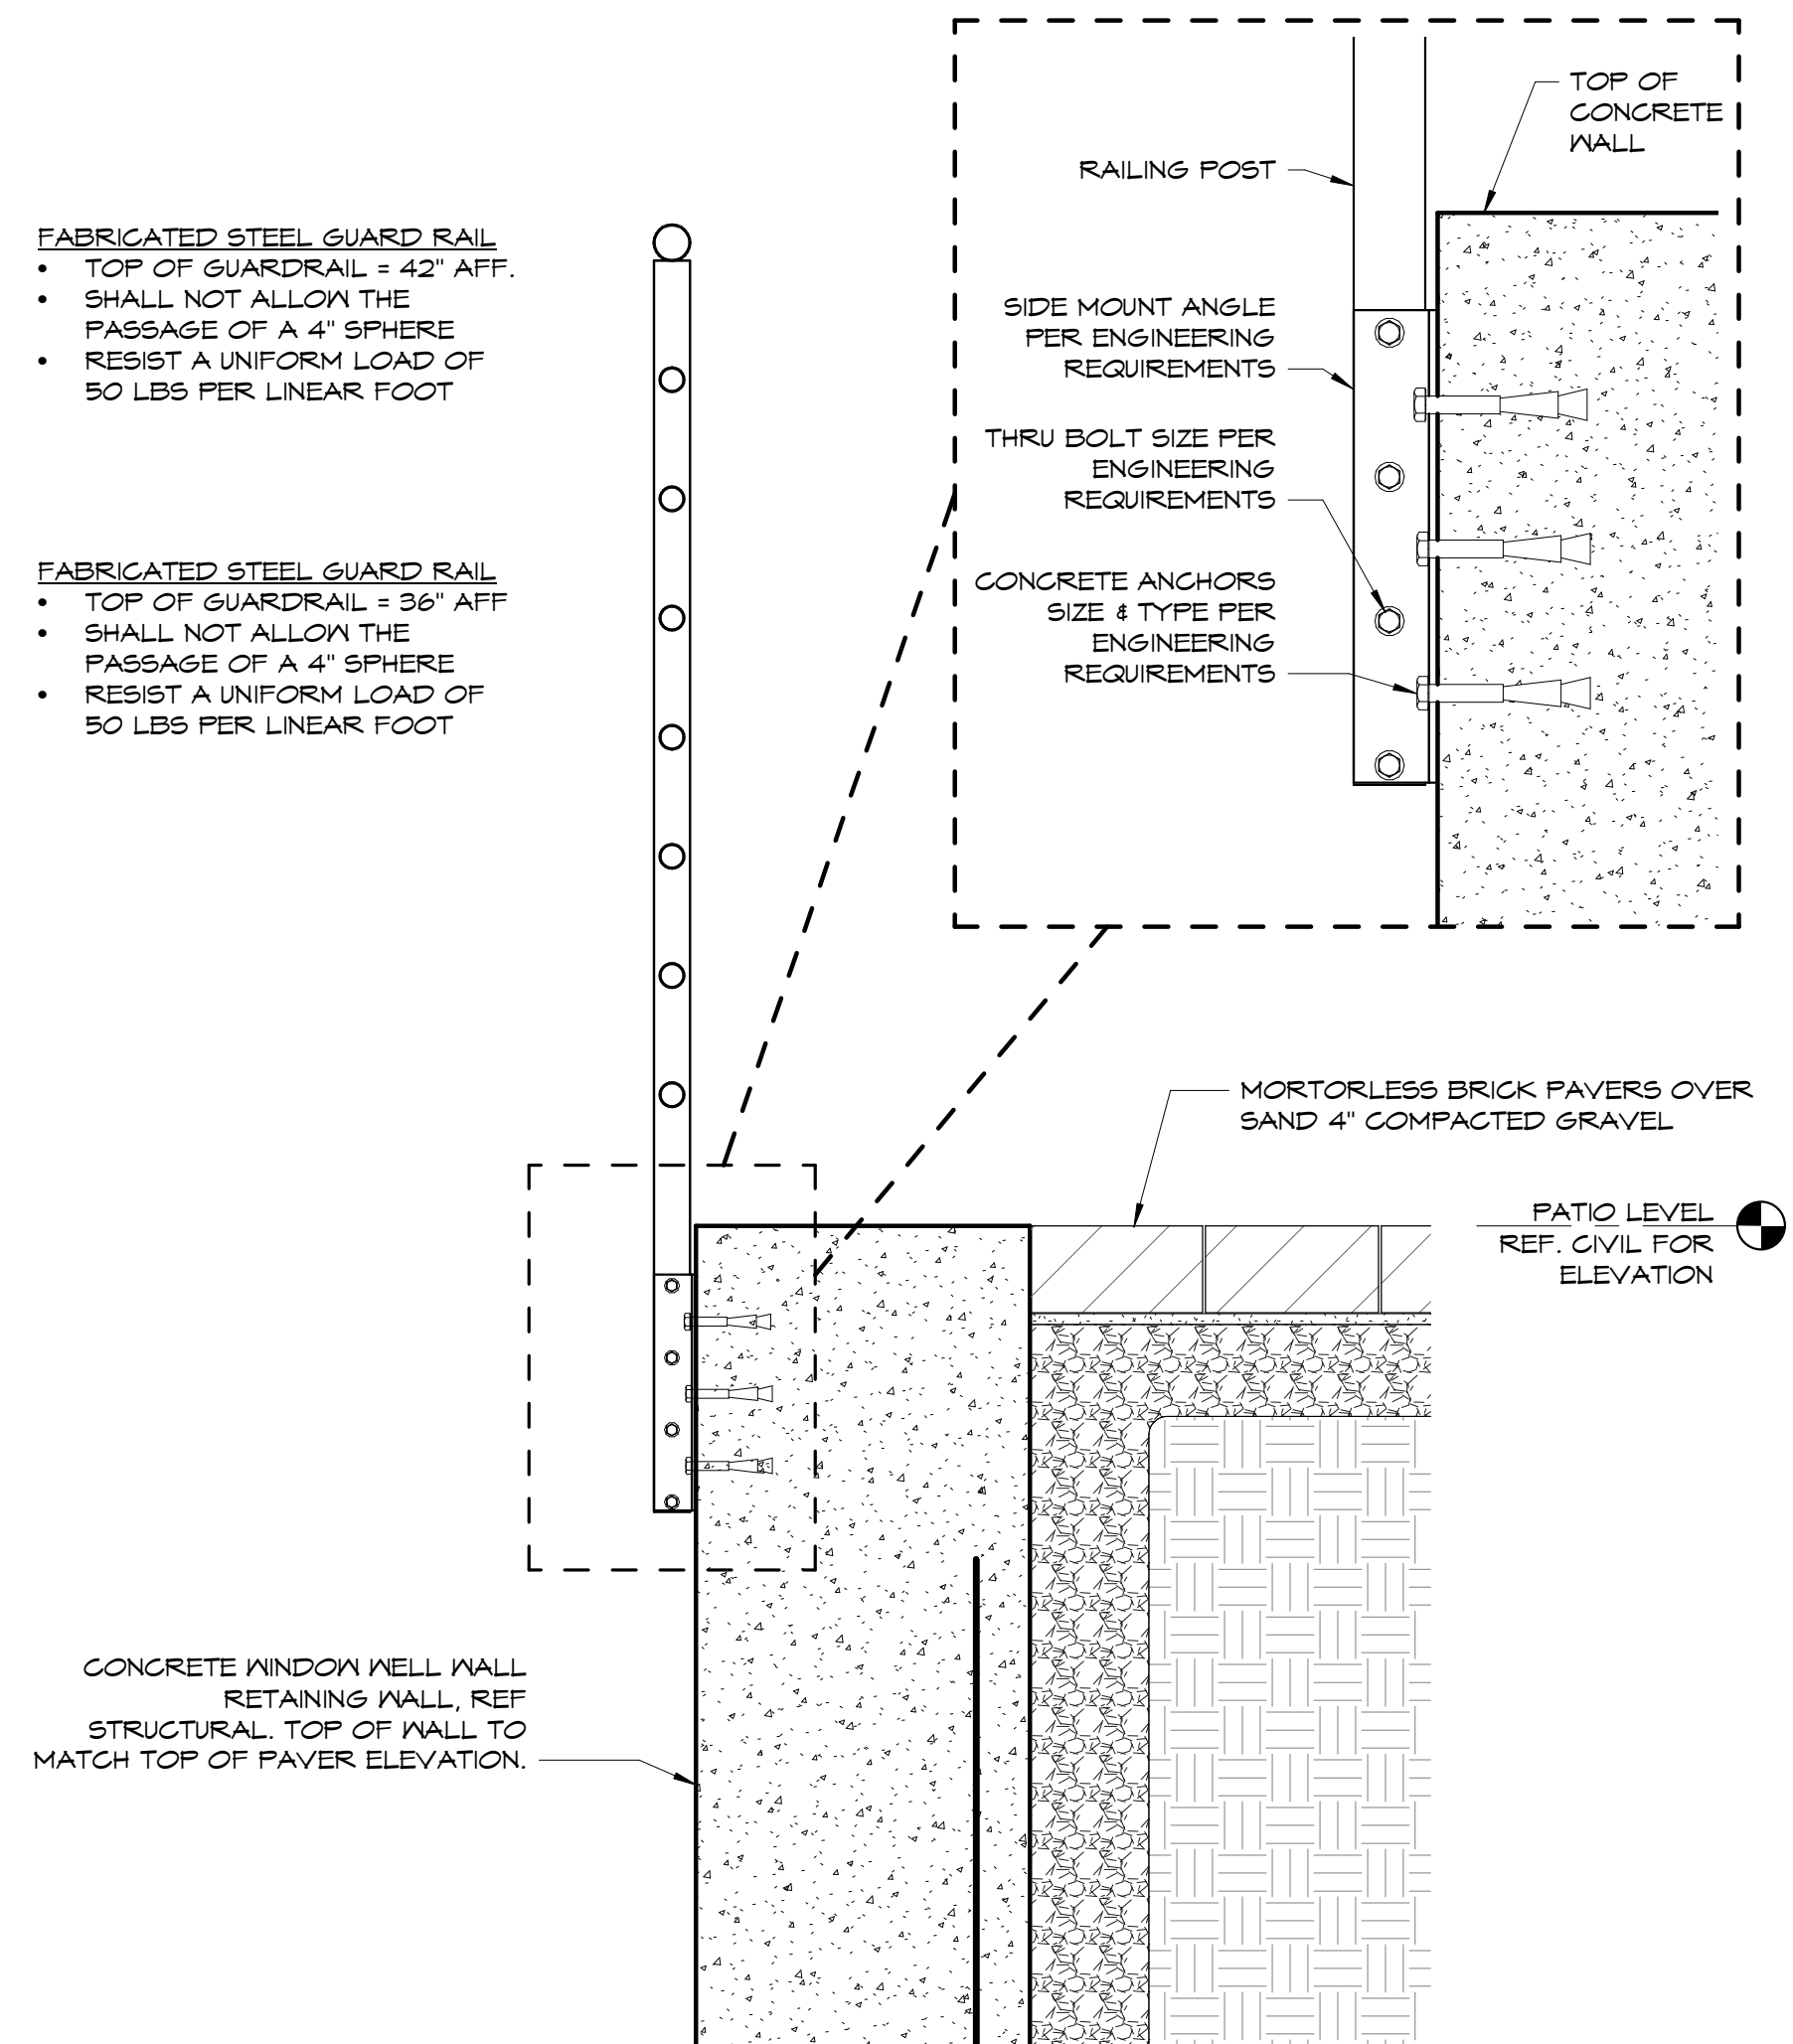
5 longitudinal section thru rear walkway  
1/2" = 1'-0"




2 detail at stair of rear entry  
1 1/2" = 1'-0"



4 detail at top of east exterior wall  
1 1/2" = 1'-0"

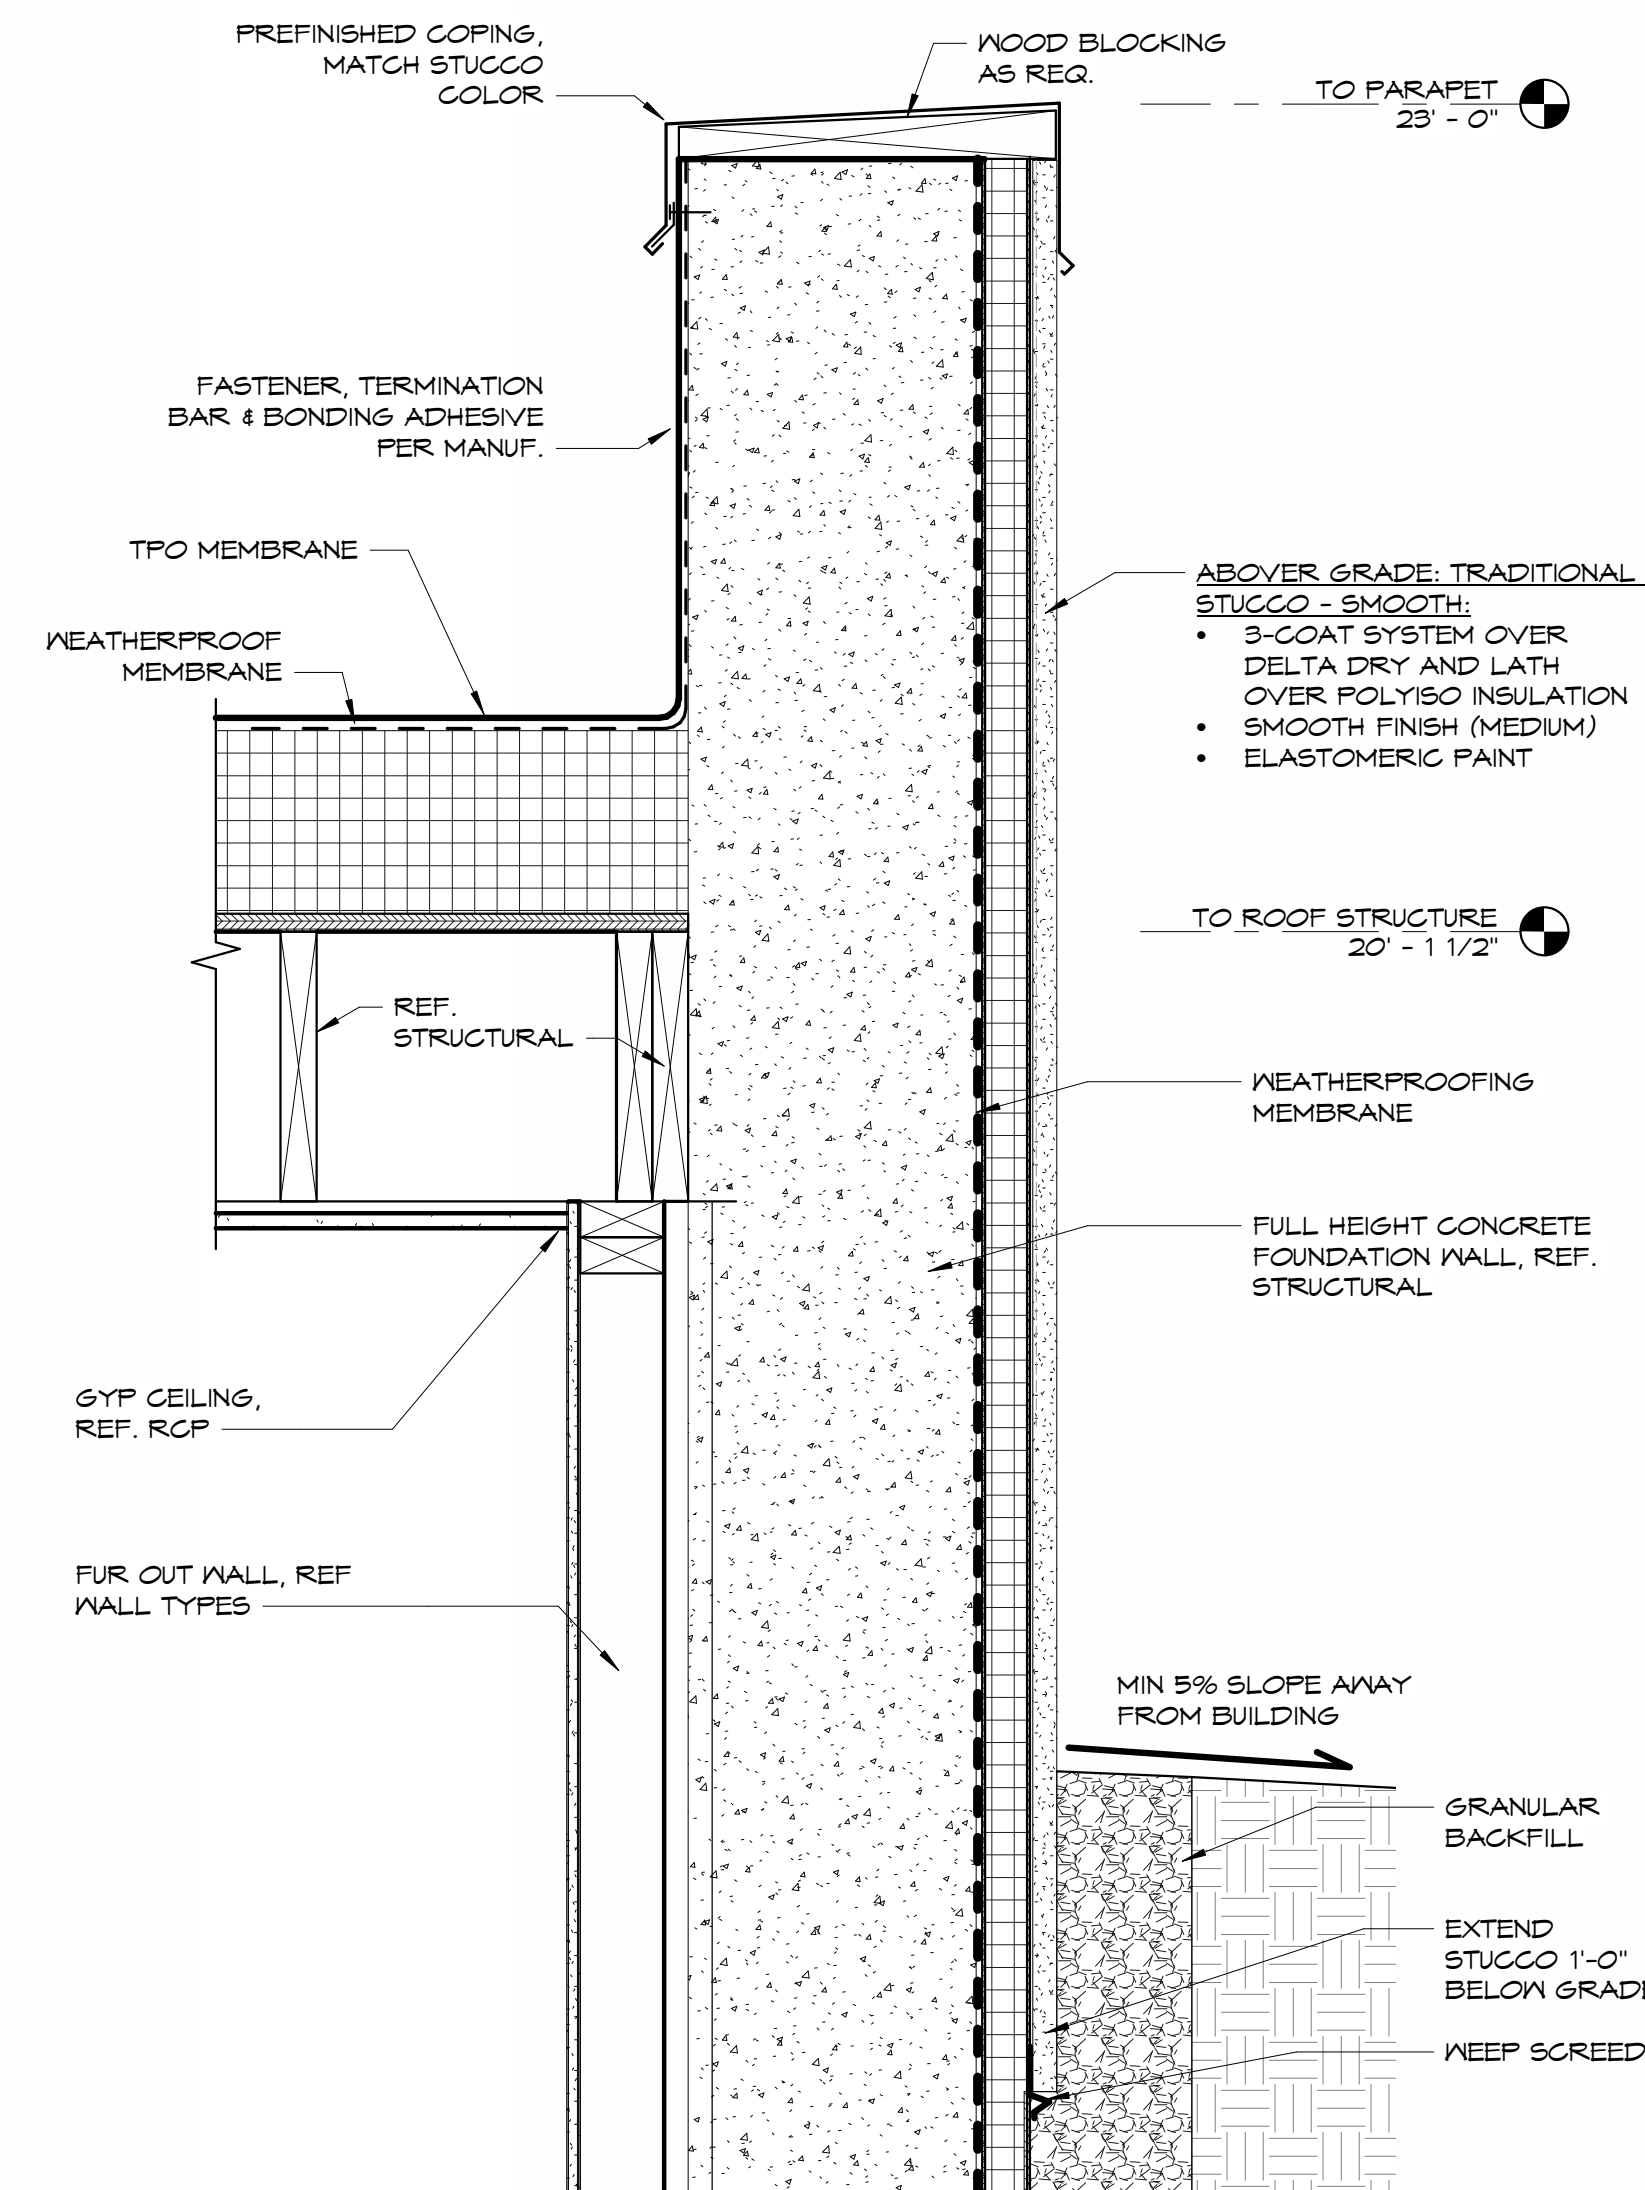

3 exterior guardrail detail  
1 1/2" = 1'-0"

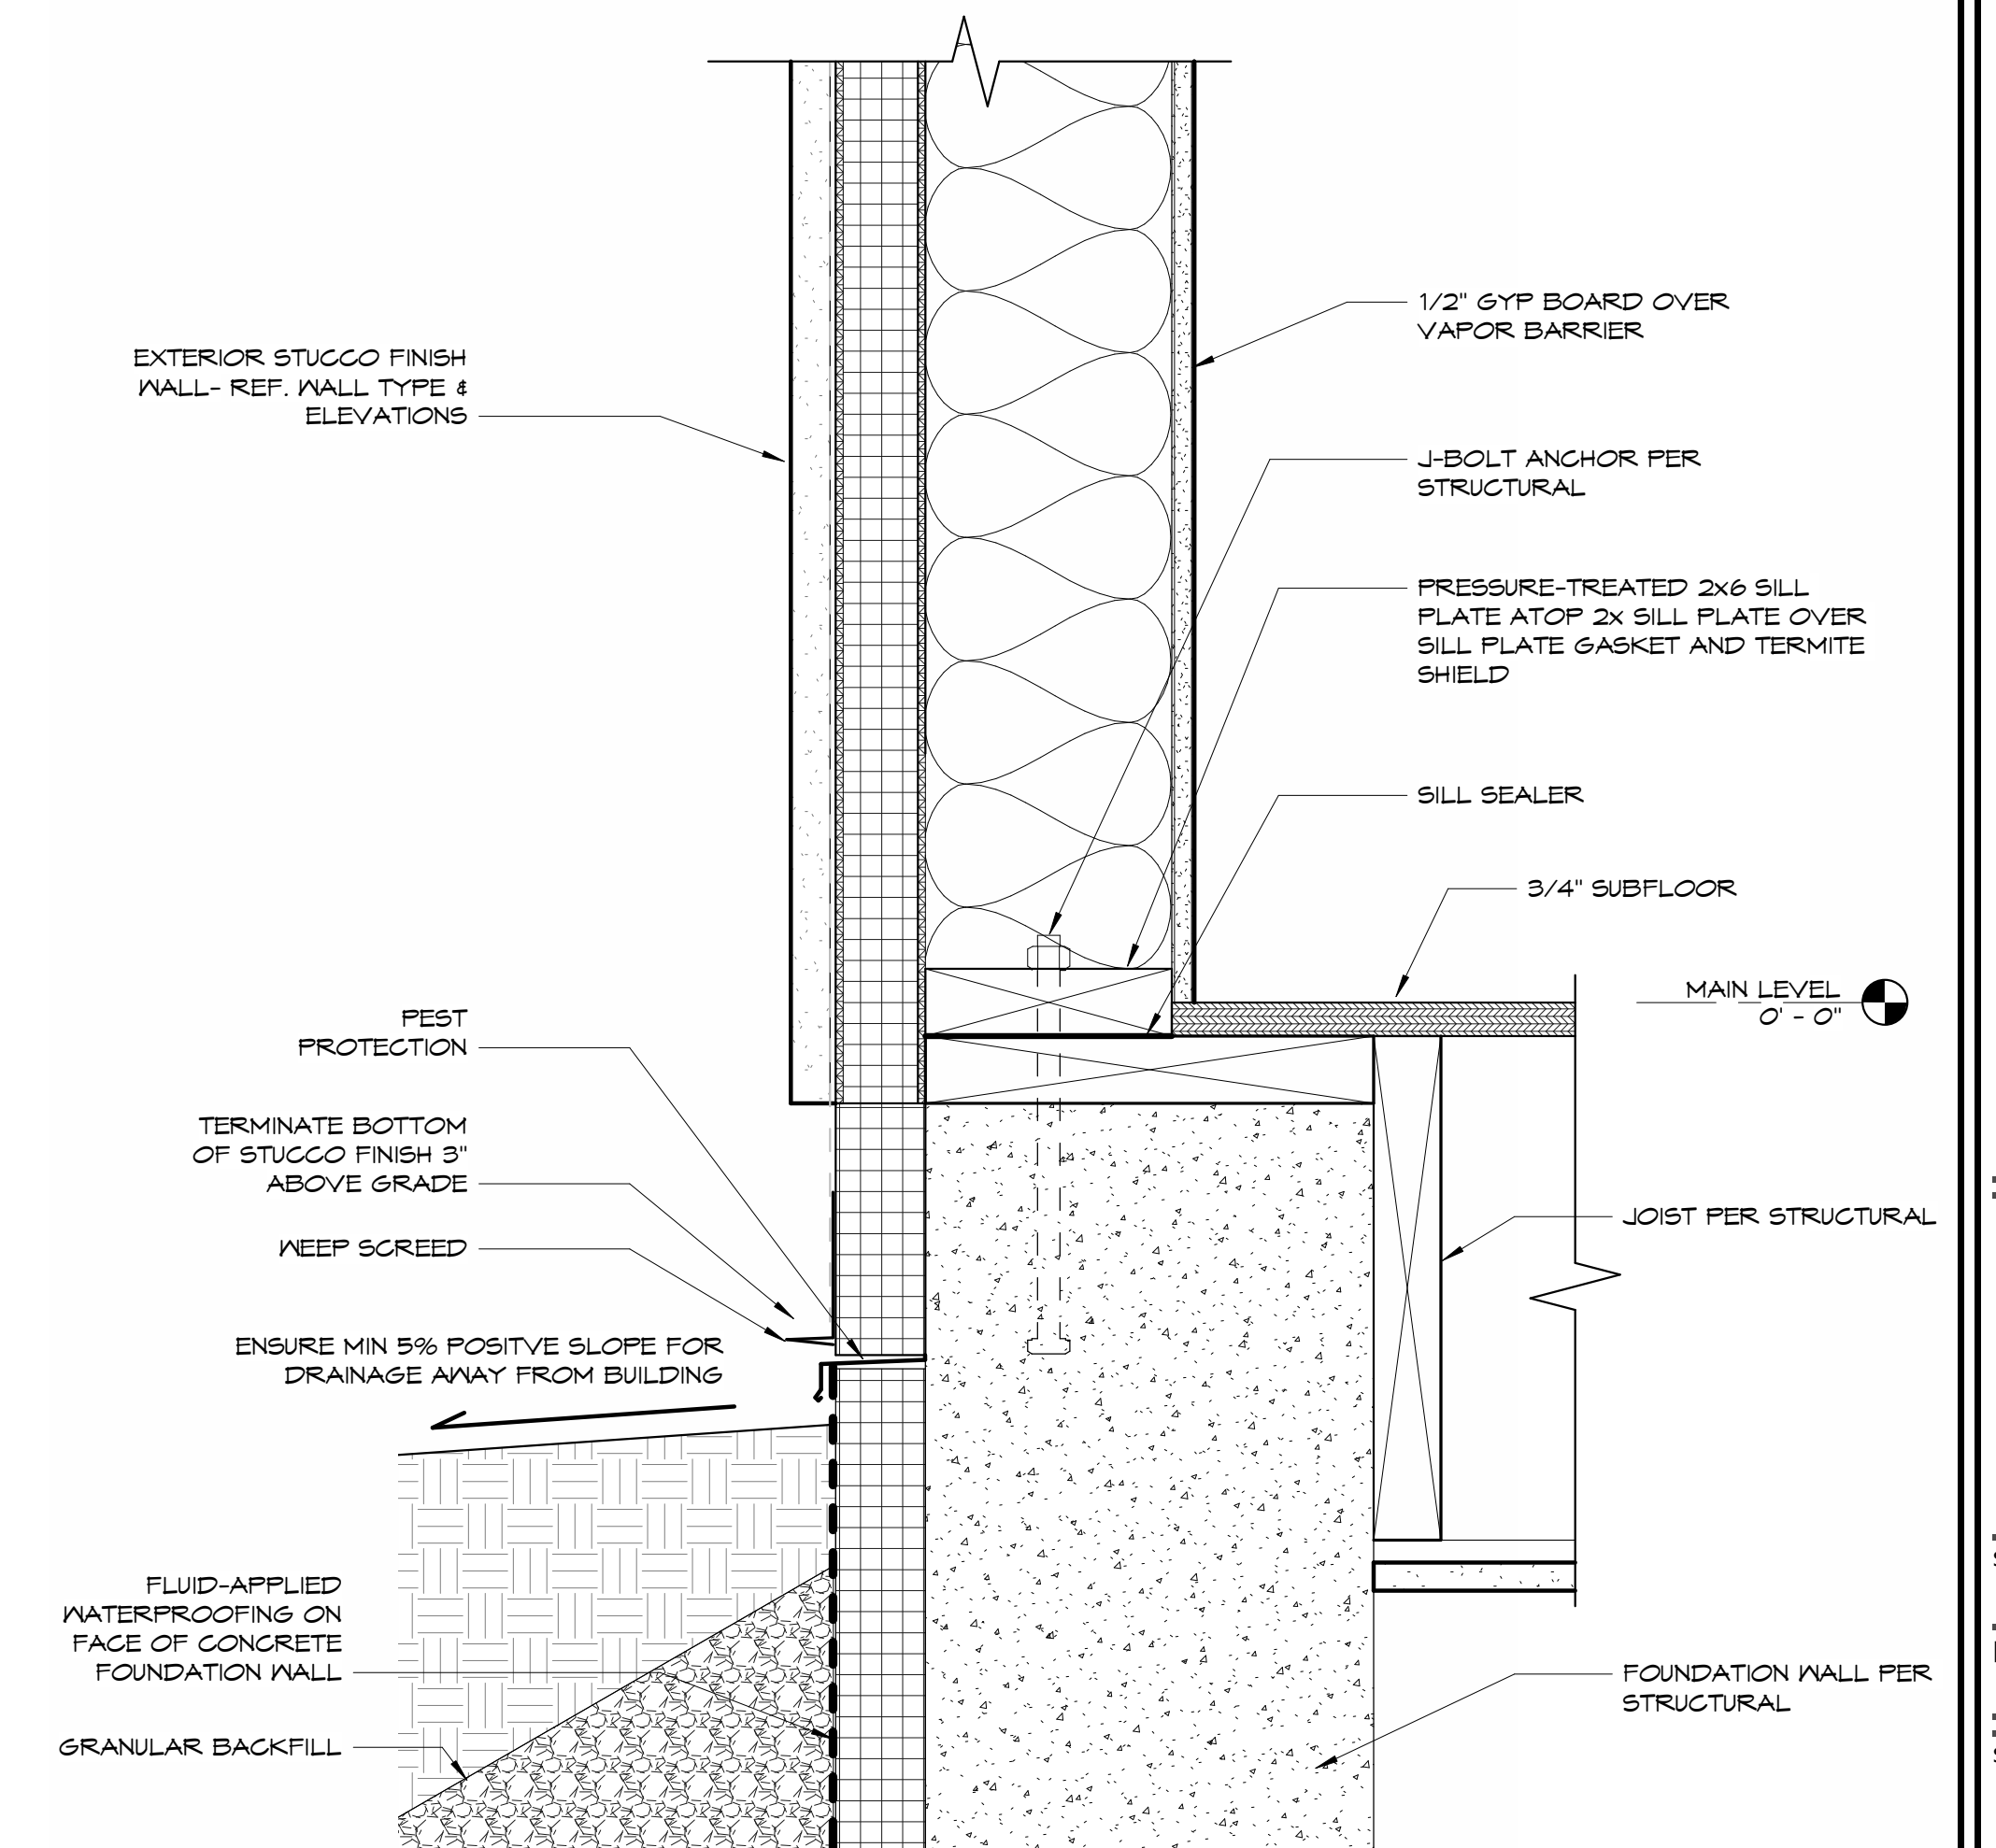

1 detail at base of exterior wall  
3" = 1'-0"



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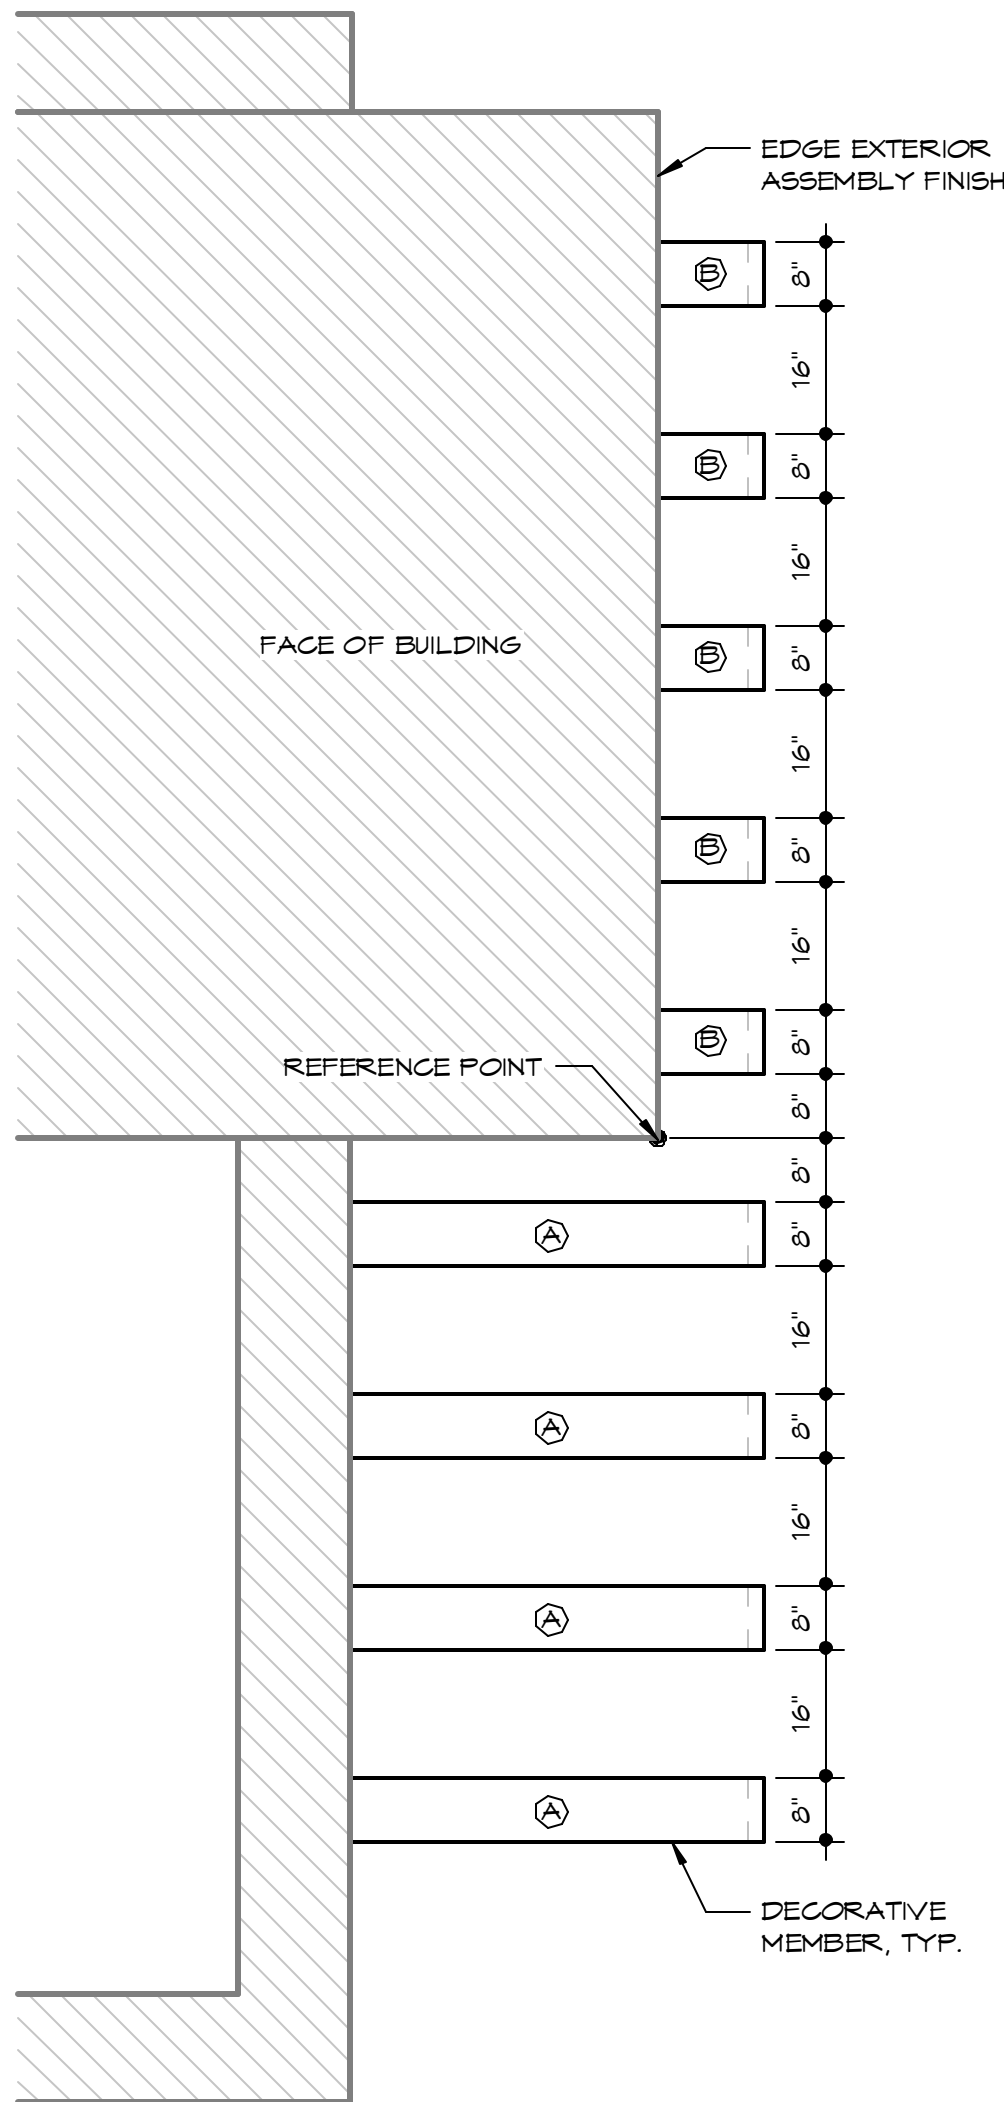
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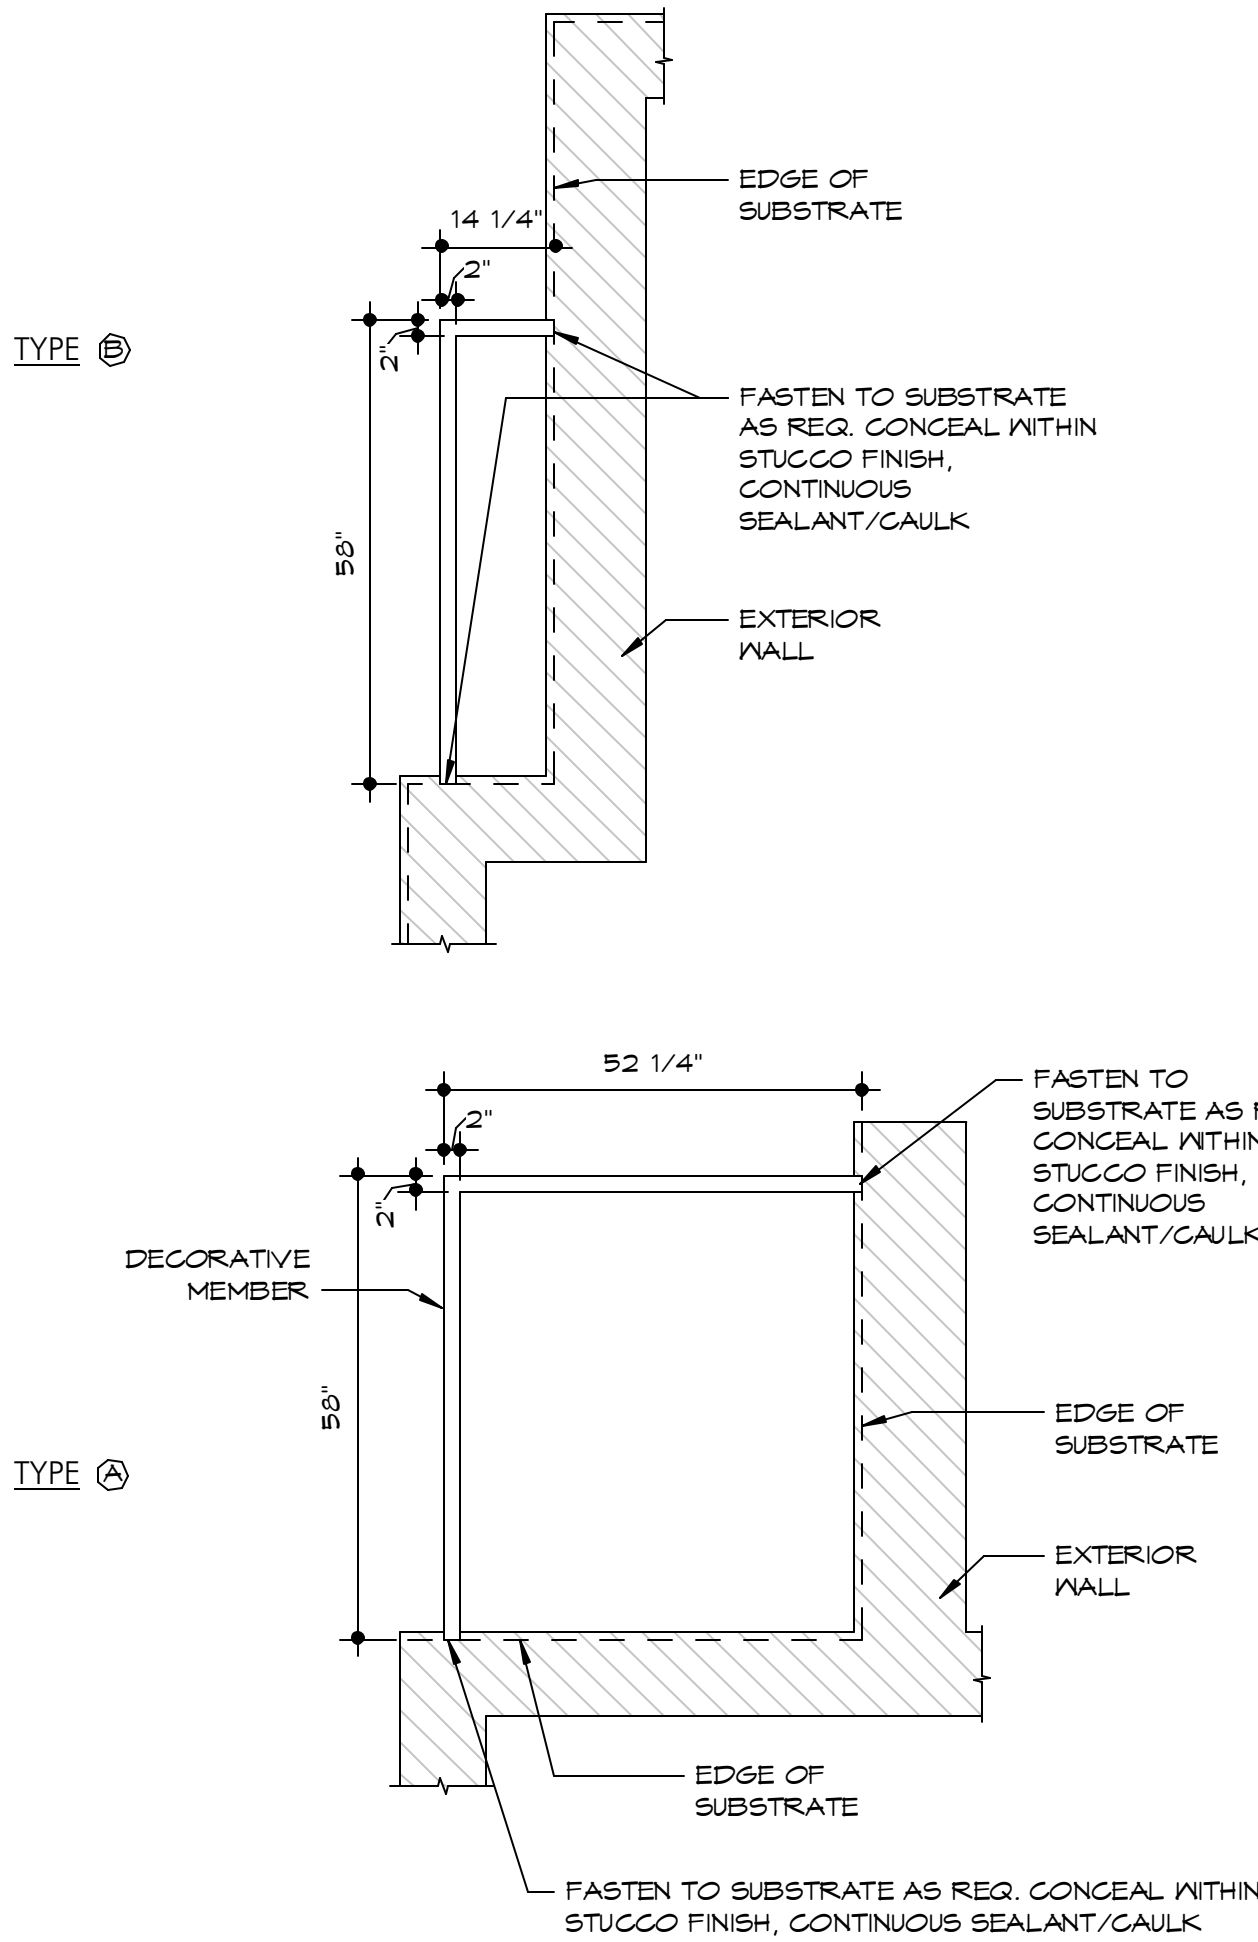
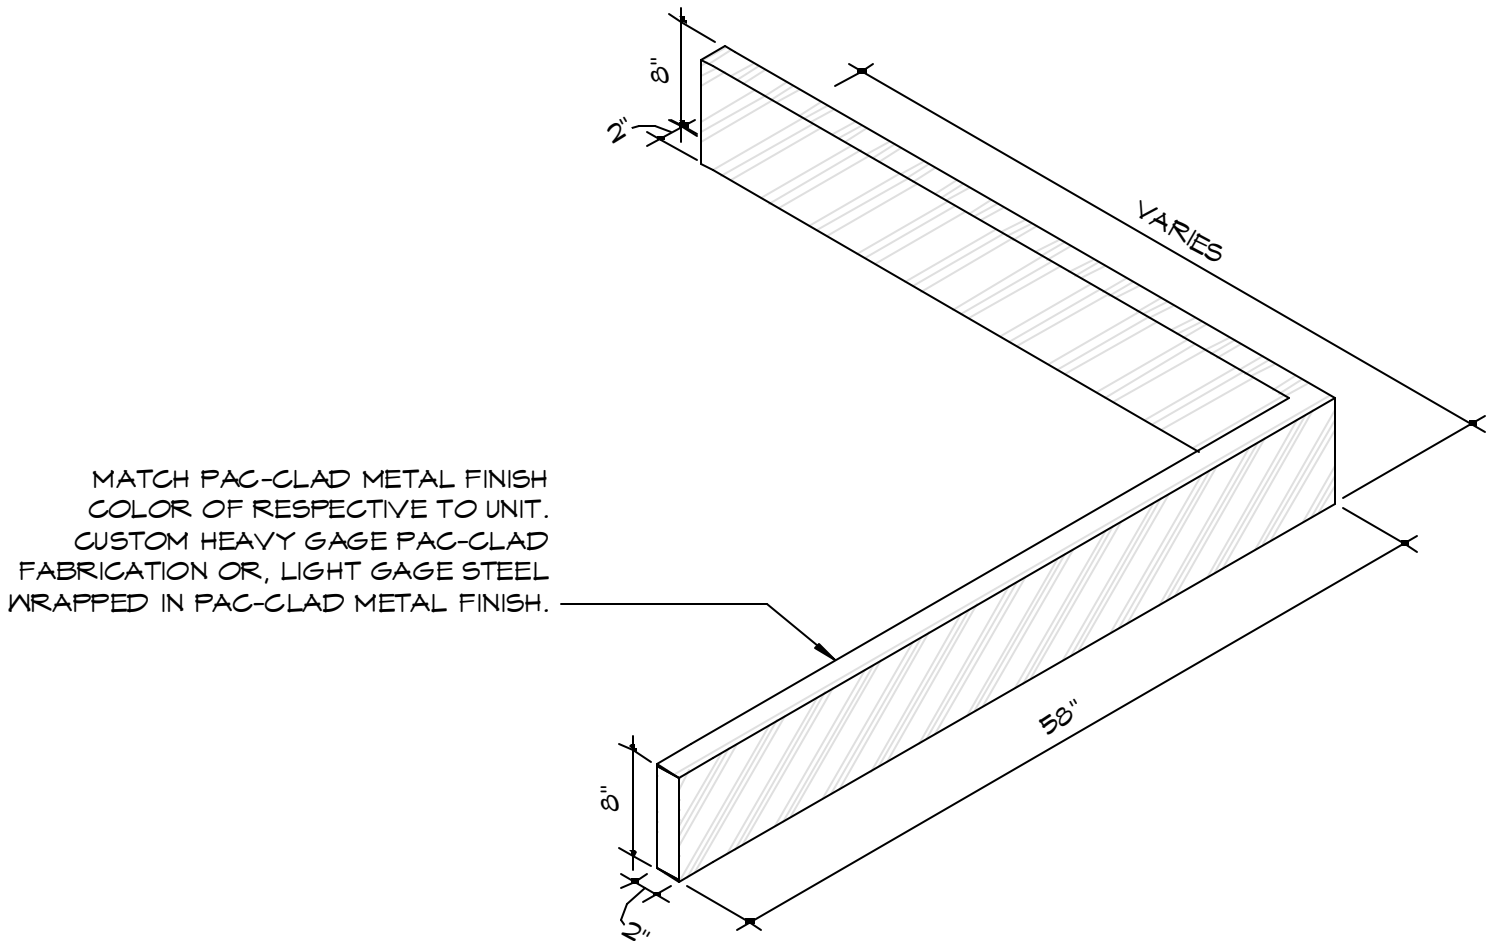
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FACADE COMPONENT

sheet no.:


A308



TYPICAL ELEVATION, NORTH VIEW  
DECORATIVE RIB COMPONENT




UNIT C

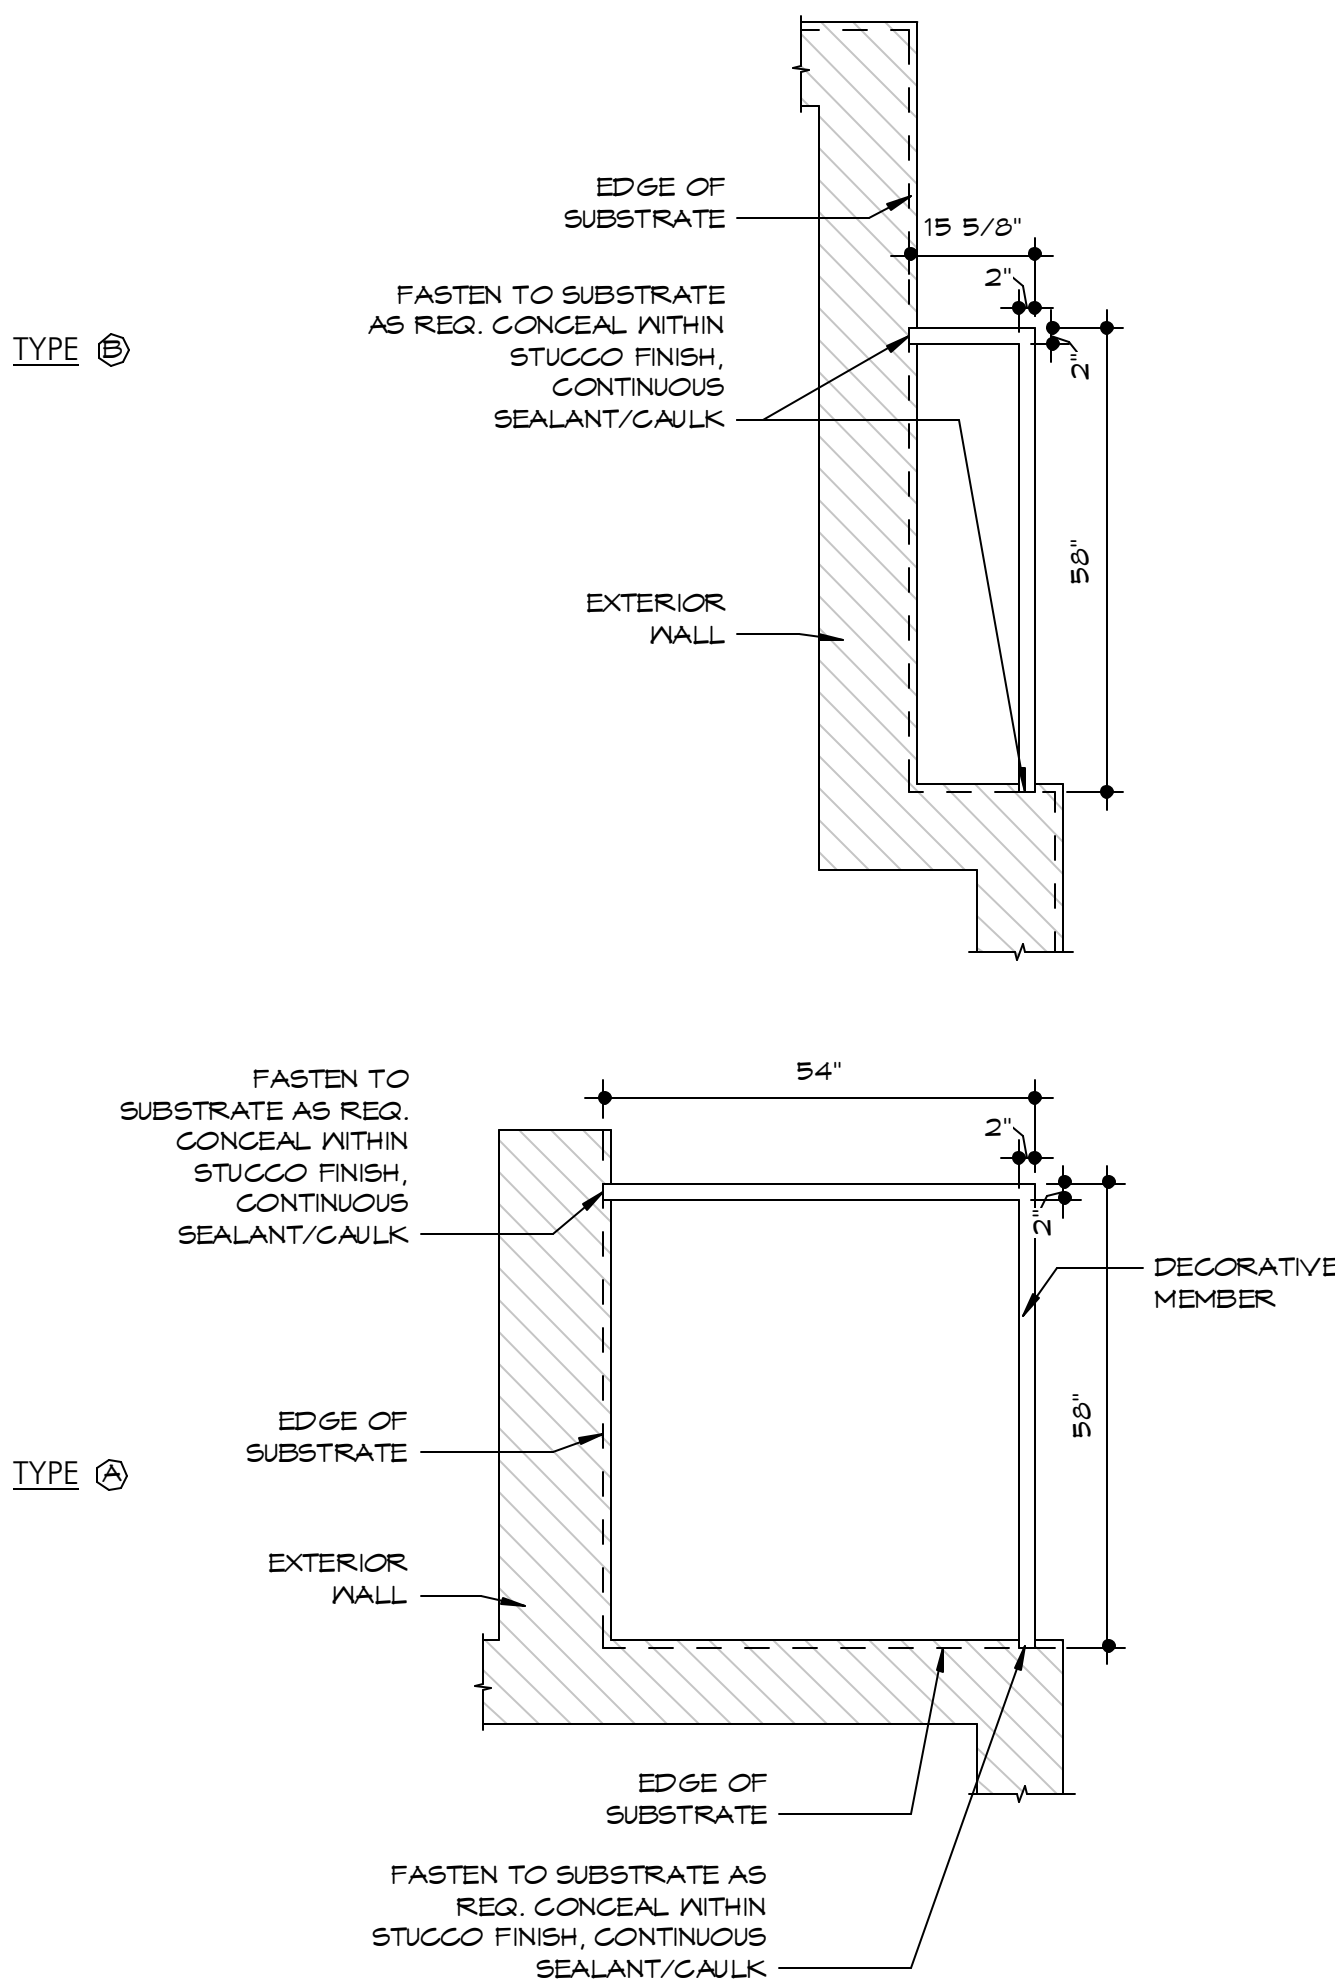

UNITS A & B



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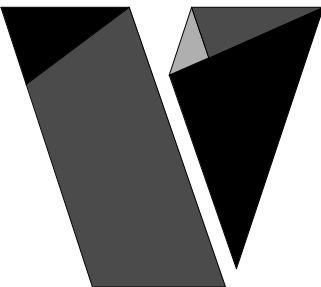
1 rear patio plan  
1/4" = 1'-0"
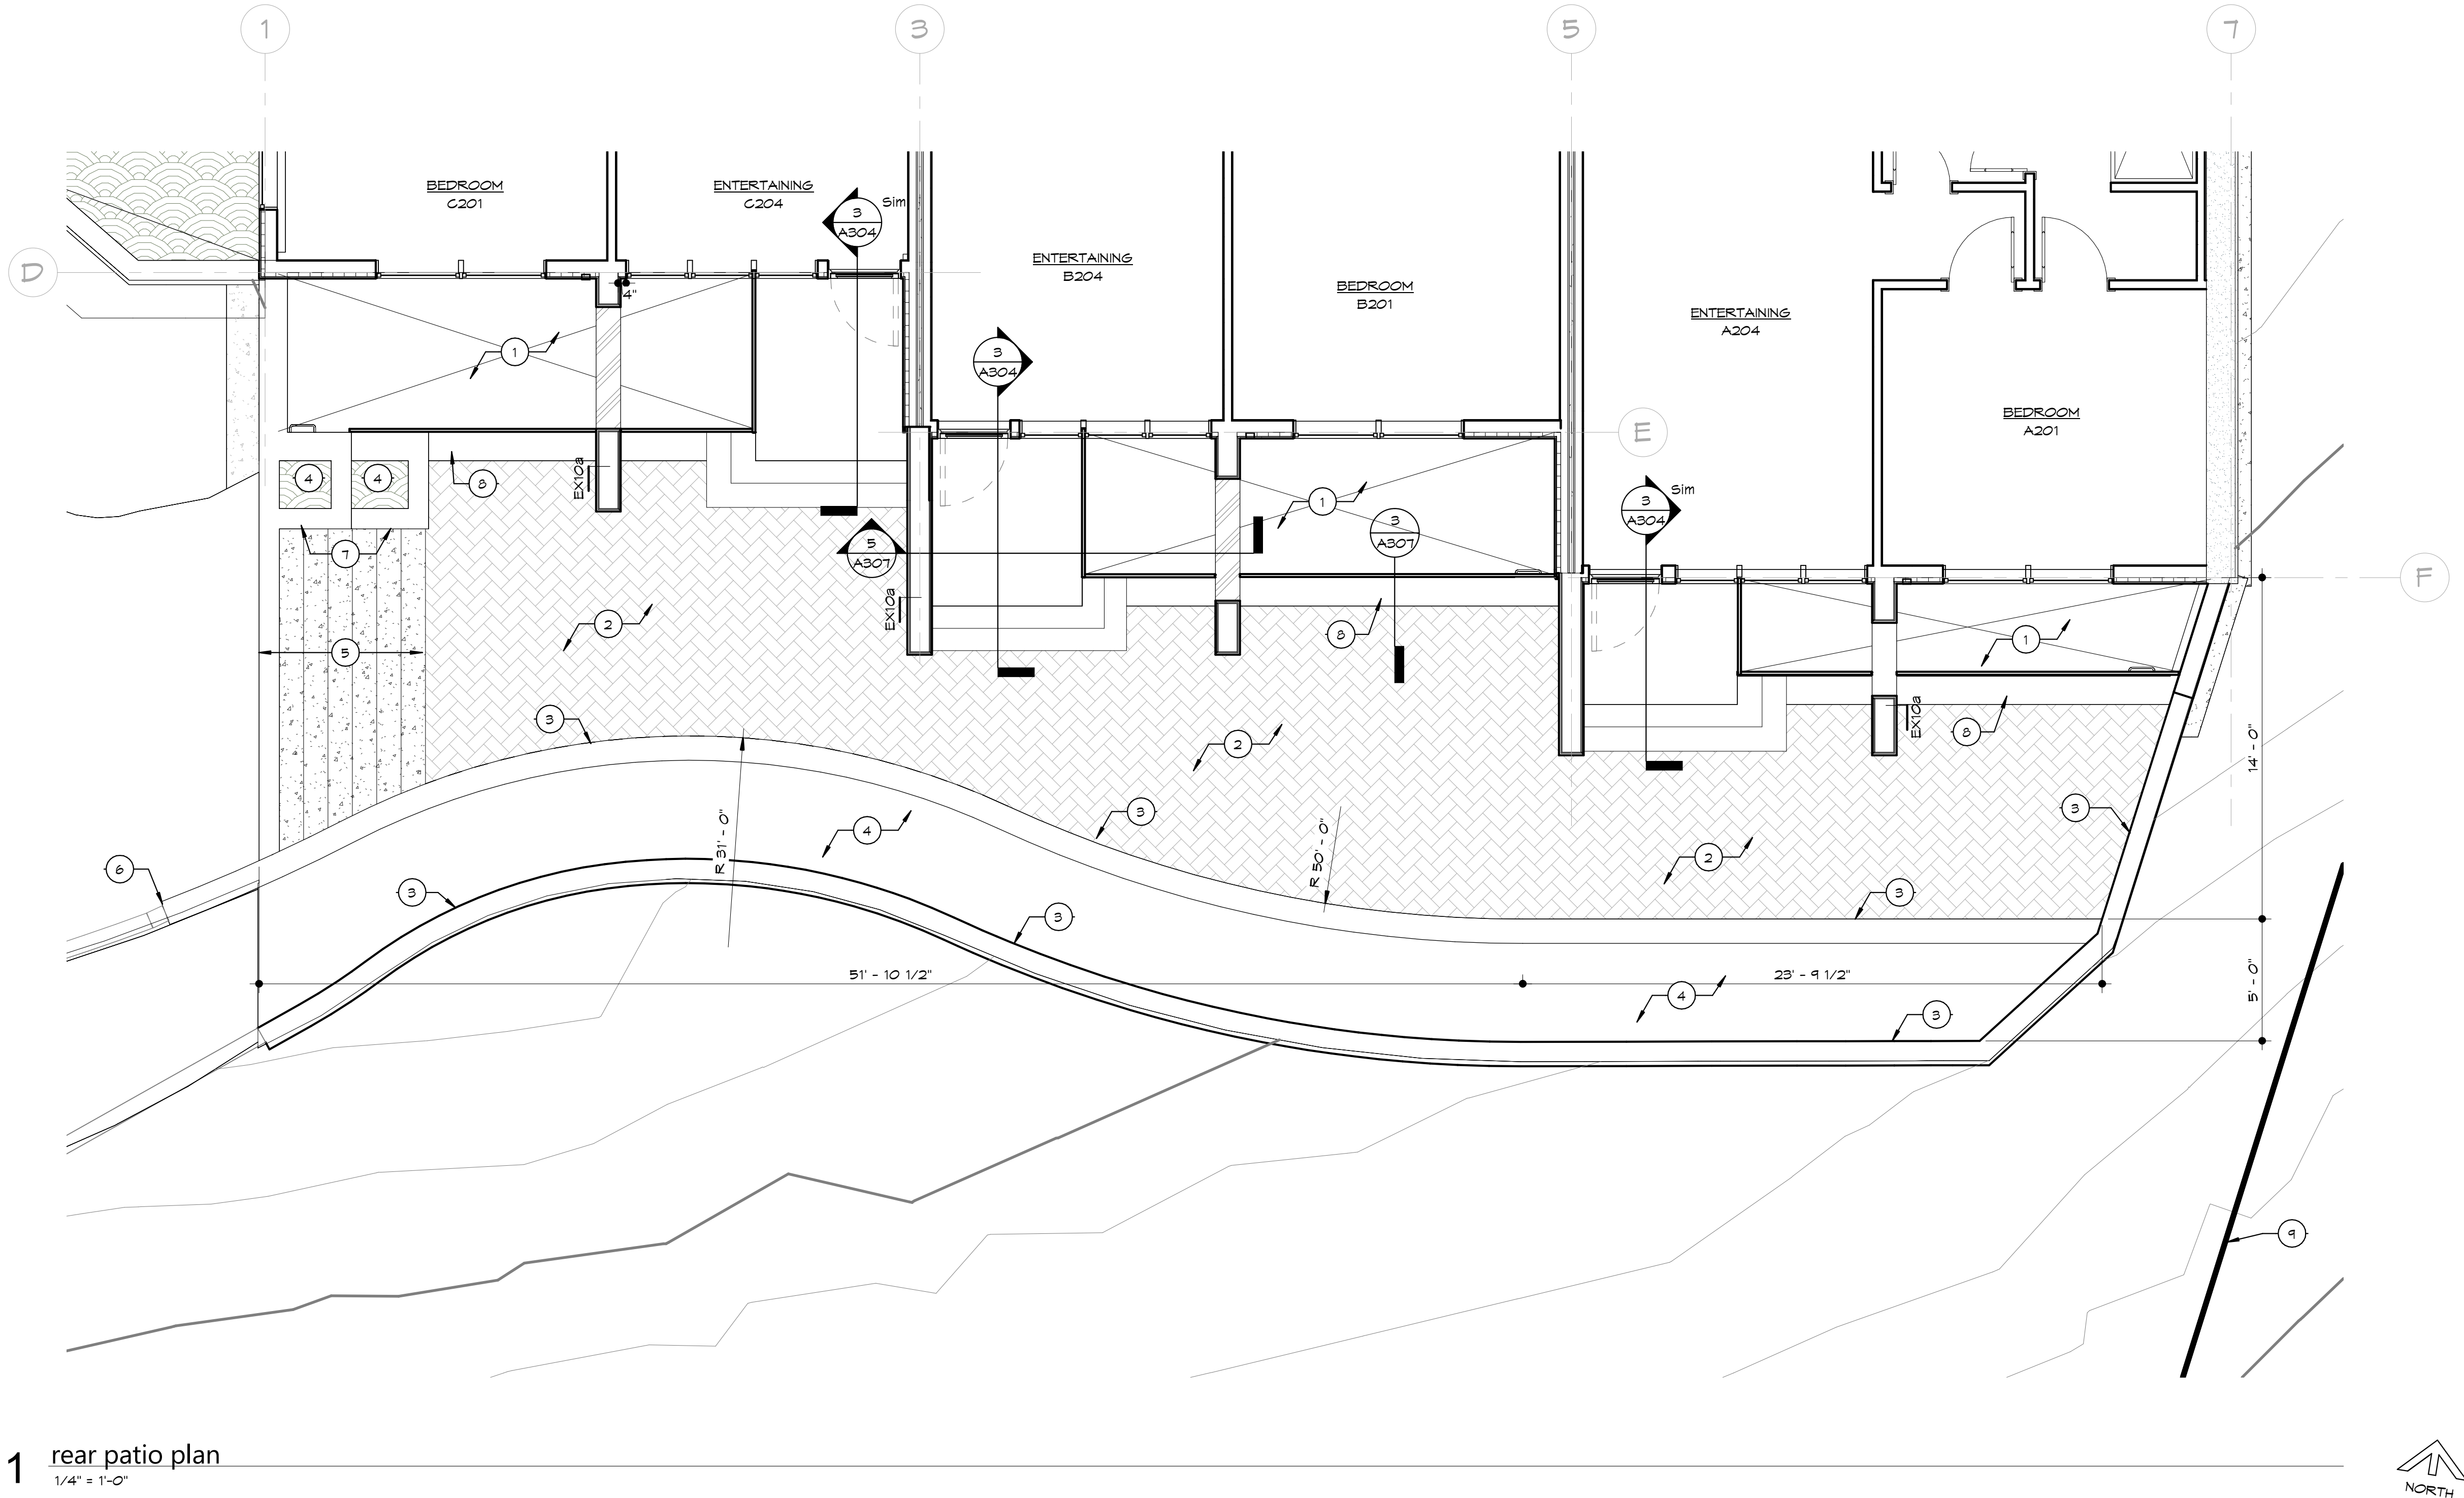
#### patio plan notes

GENERAL: COORDINATE WITH WORK SHOWN ON STRUCTURAL, MECHANICAL, PLUMBING, AND ELECTRICAL DRAWINGS, REF. FE SHEET FOR EQUIP. COORDINATION

#### NUMBER NOTE TEXT

- 1 WINDOW WELL, REF STRUCTURAL FOR ADDITIONAL INFORMATION
- 2 MORTERLESS BRICK PAVERS, REF. CIVIL FOR TOP ELEVATION
- 3 RETAINING WALL, REF. CIVIL AND STRUCTURAL FOR ADDITIONAL INFORMATION
- 4 LANDSCAPING BY OTHERS
- 5 CONCRETE STAIRS FROM NEW PATIO ELEVATION TO ADJACENT EXISTING TERRACE ELEVATION. "T" MAX RISE, 11" MIN RUN.
- 6 NEW RETAINING WALL TO CONNECT SEAMLESSLY WITH EXISTING RETAINING WALL
- 7 CONCRETE OR MASONRY PLANTER BOXERS
- 8 CONCRETE WINDOW WELL RETAINING WALL. TOP OF WALL TO MATCH TOP OF PAVES ELEVATION (EXCEPT UNDER ENTRY LANDING). REF. CIVIL AND STRUCTURAL FOR ADDITIONAL INFORMATION
- 9 PROPERTY LINE, REF. CIVIL DRAWINGS AND ARCHITECTURAL SITE PLAN



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ARCHITECTURAL  
FLOOR PLAN - REAR  
PATIO


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A311





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3 detail at exterior canopy roof edge  
3" = 1'-0"



2 typical parapet detail  
3" = 1'-0"

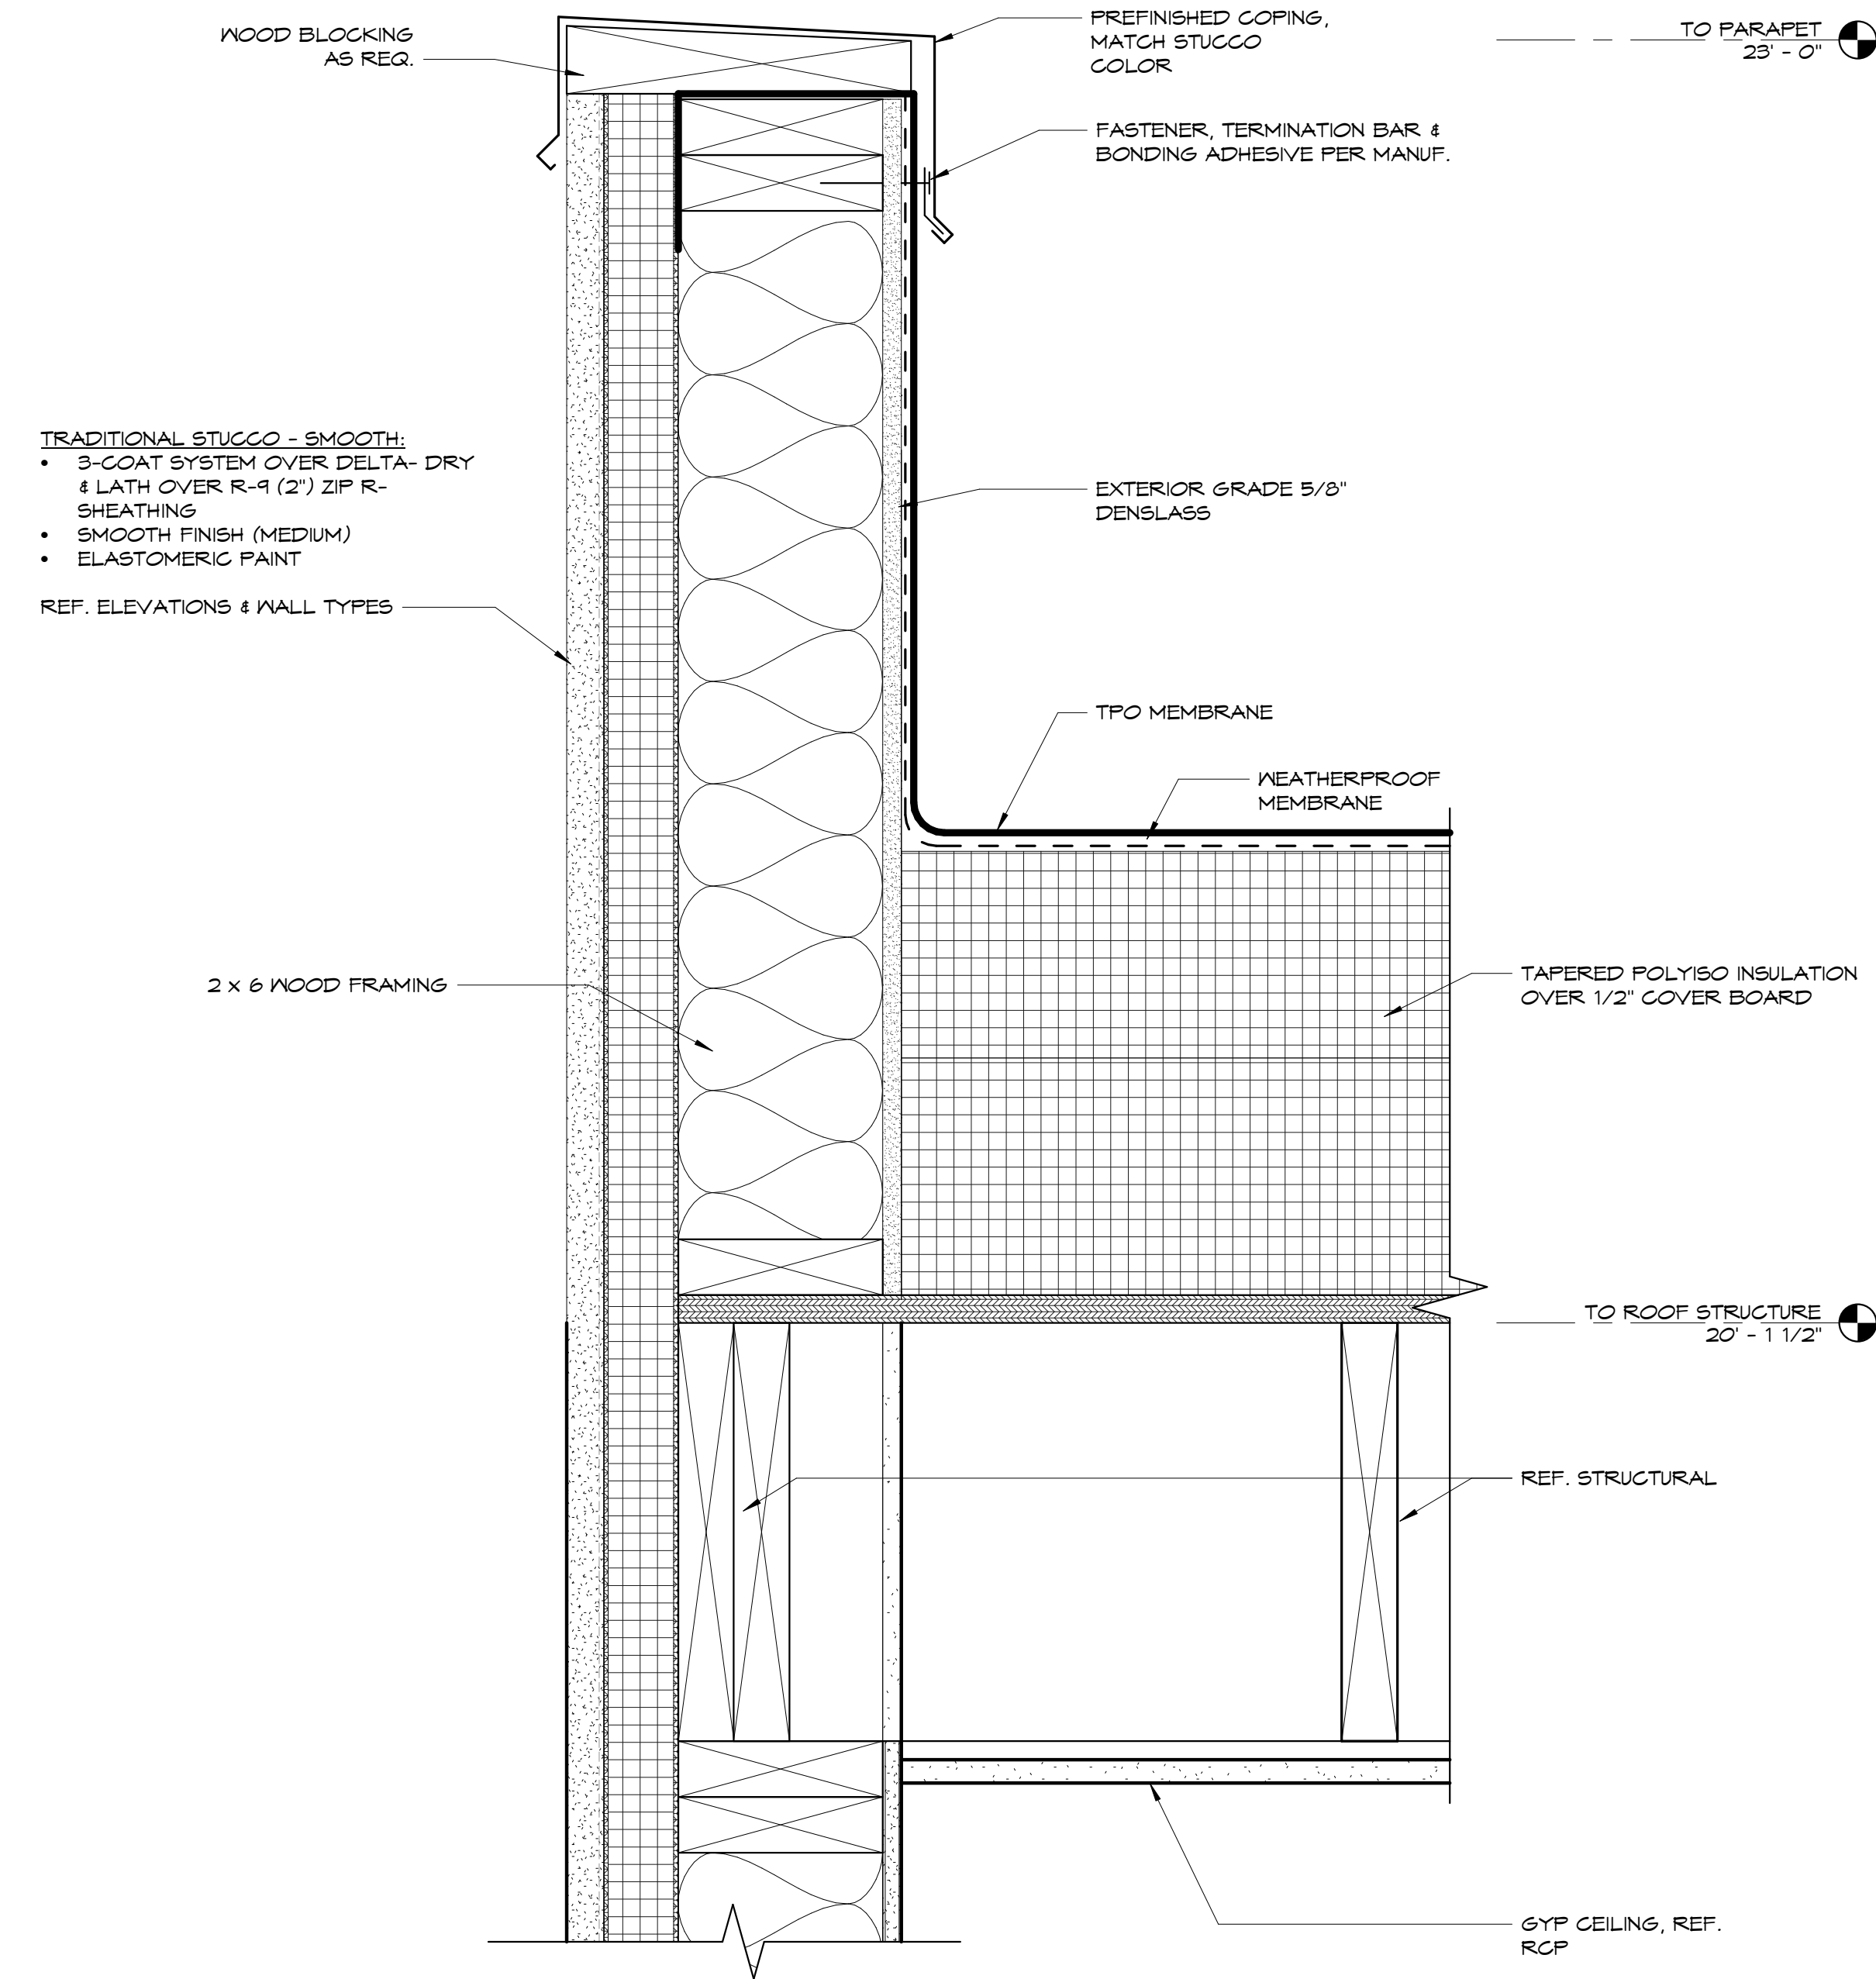

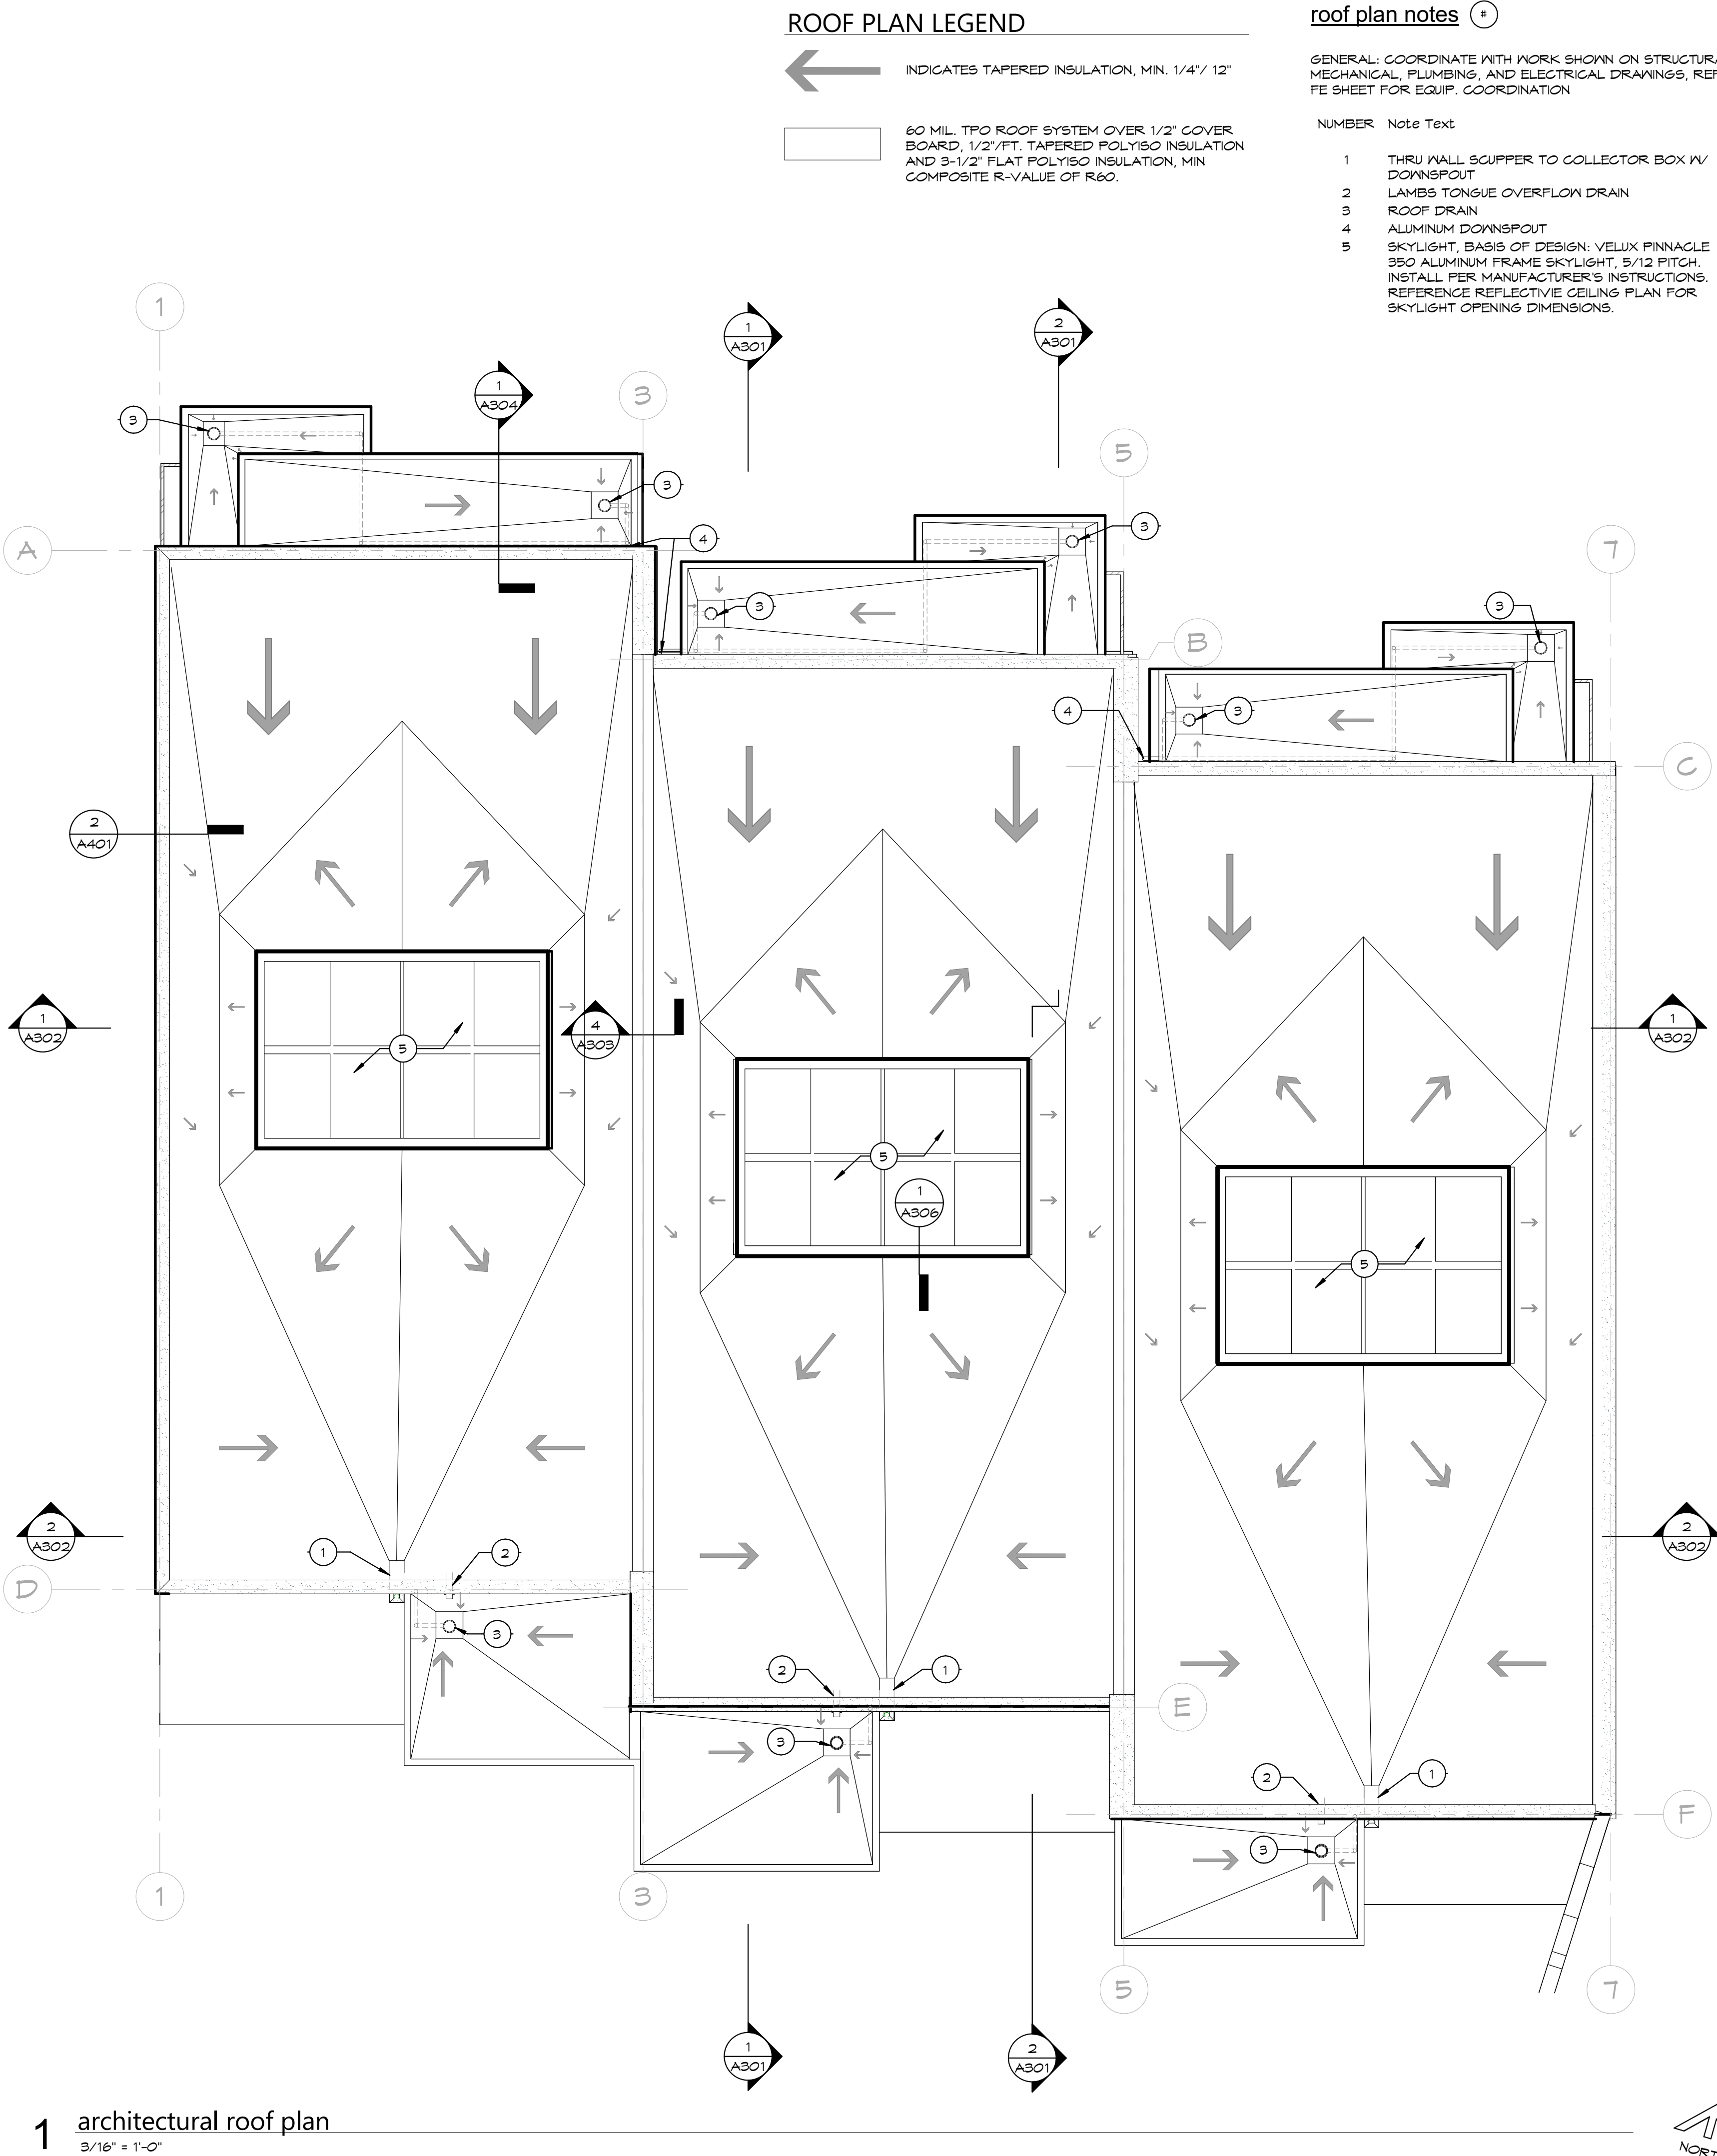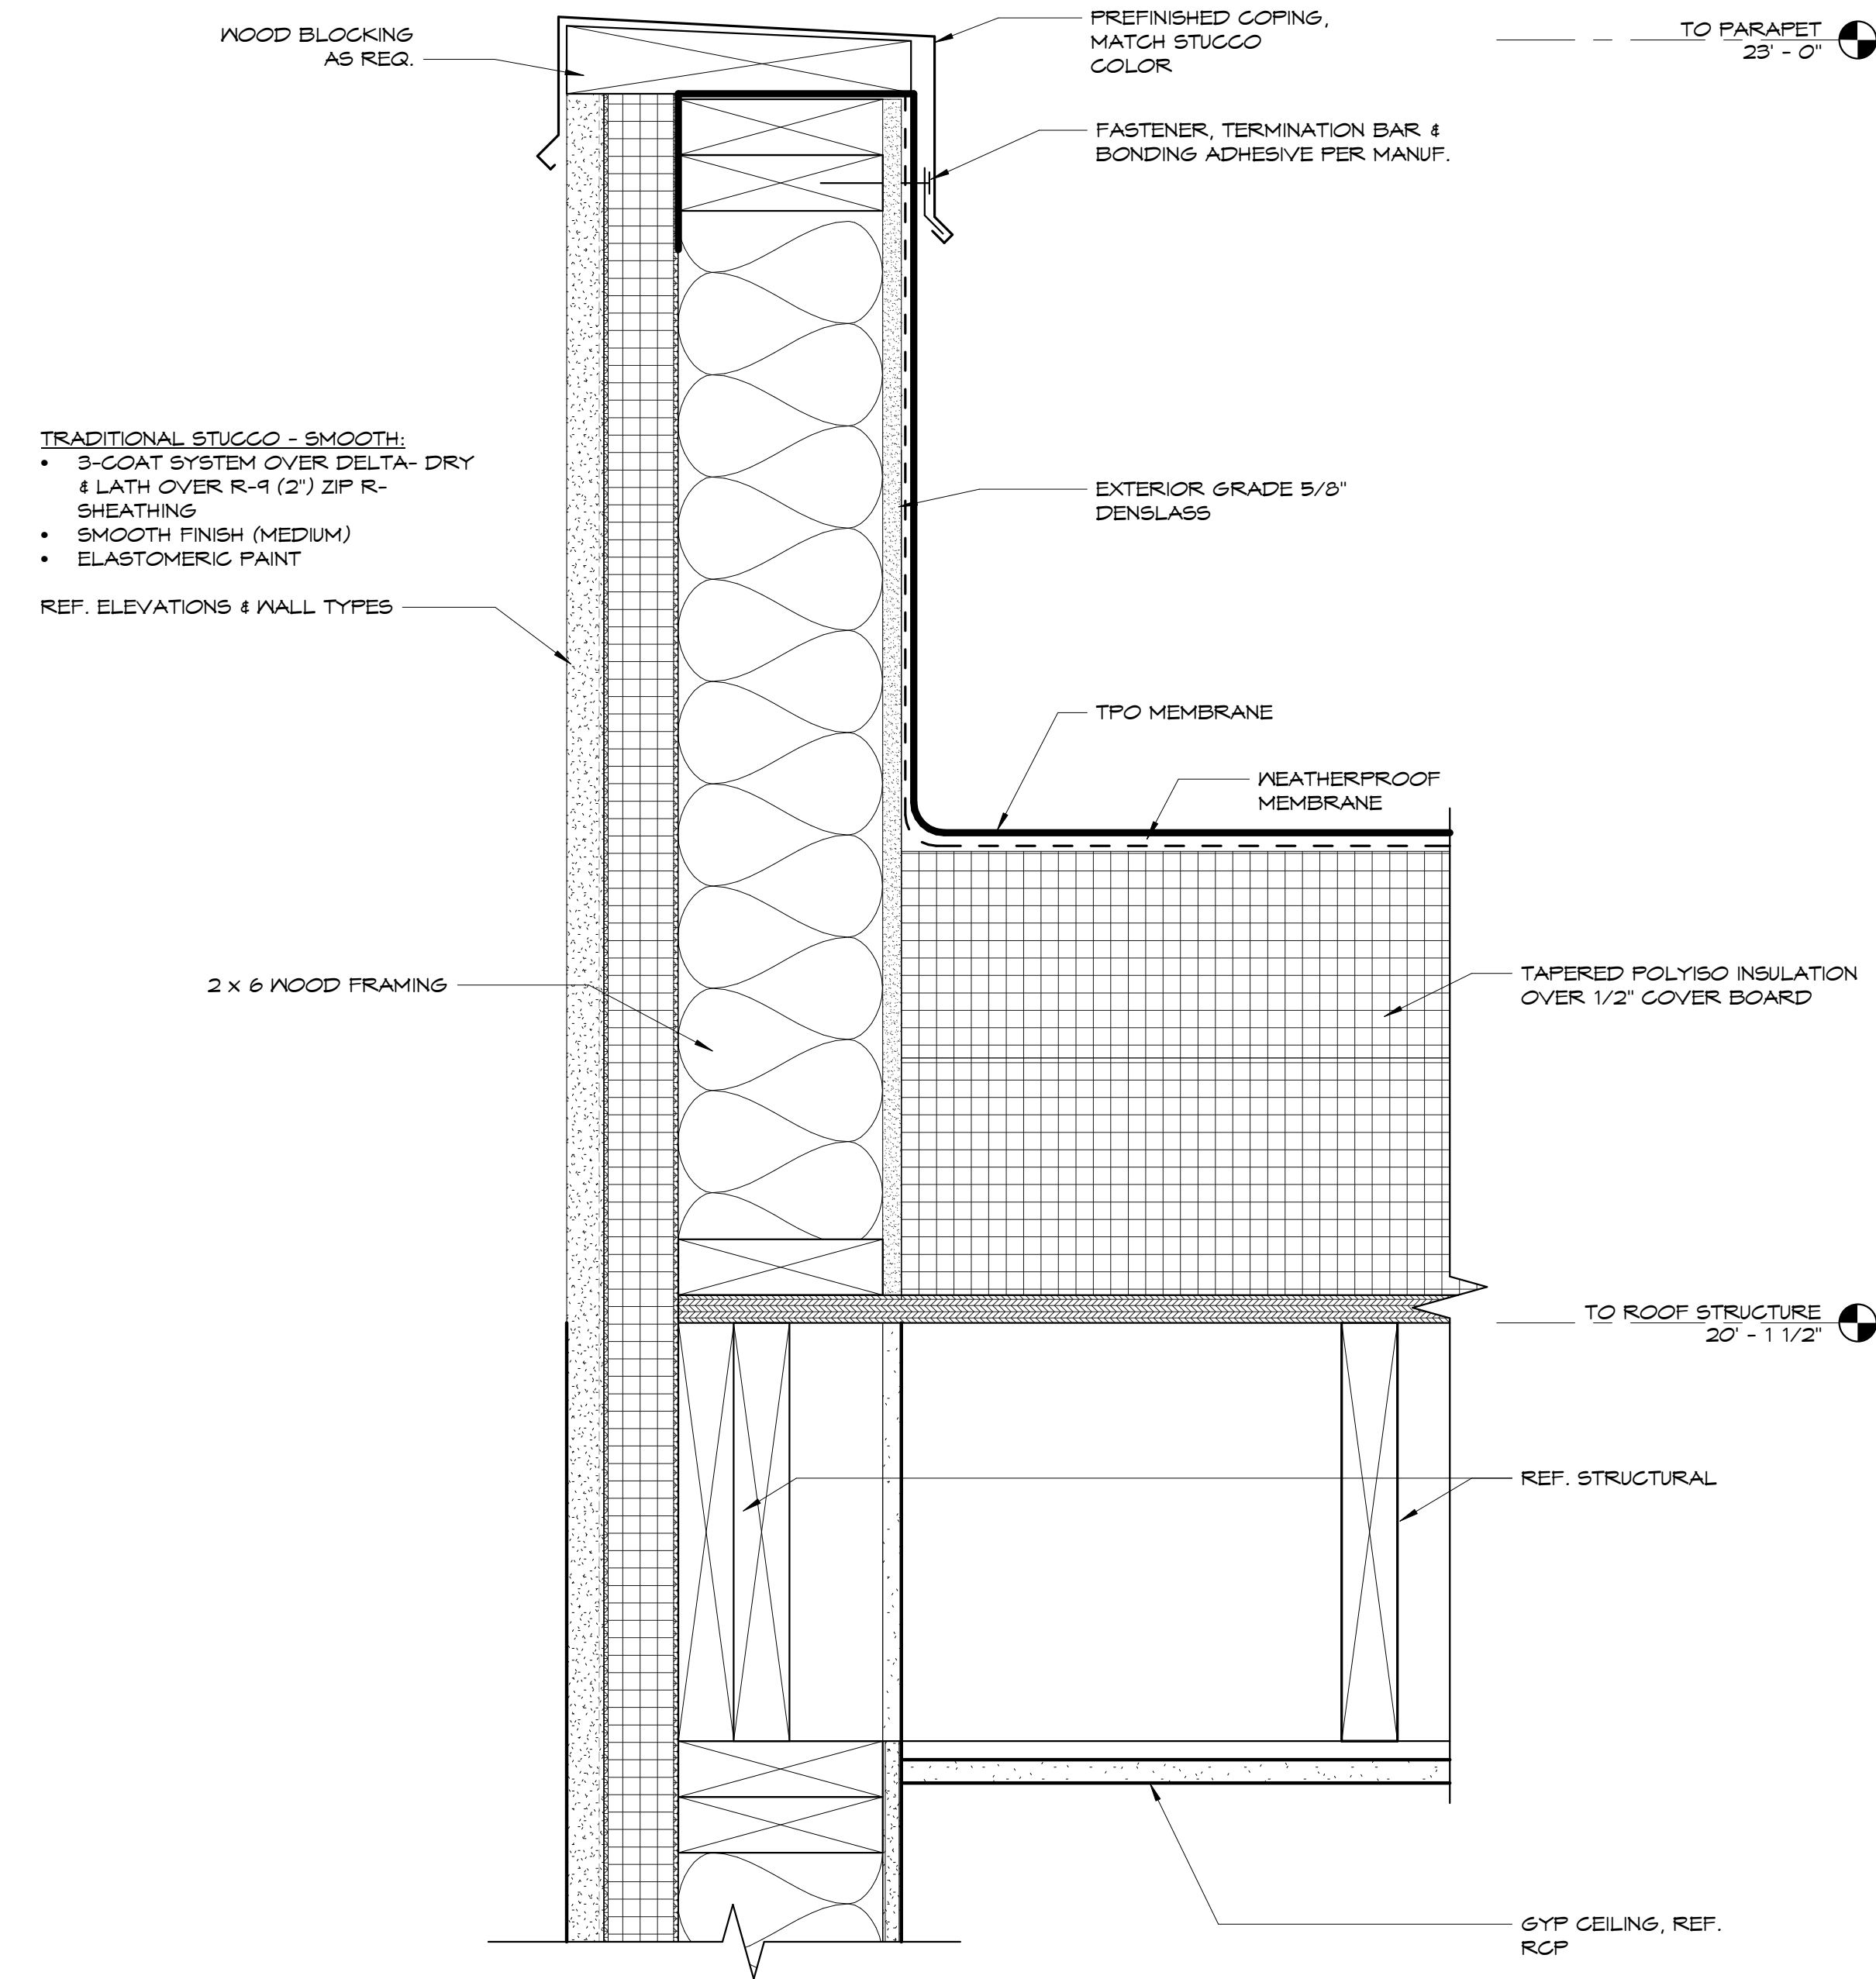

WINDOW SCHEDULE					
MARK	MANUFACTURER	MODEL	WIDTH	HEIGHT	COMMENTS
A	Pella	Impervia, Fixed, Fiberglass	2' - 10"	5' - 0"	WEST BEDROOMS
B	Pella	Impervia, Fixed, Fiberglass	2' - 10"	5' - 0"	WEST STAIR GROUP
C	Pella	Impervia, Fixed, Fiberglass	2' - 10"	7' - 4"	WEST STAIR GROUP
D	Pella	Impervia, Fixed, Fiberglass	2' - 10"	9' - 8"	WEST STAIR GROUP
E	Pella	Impervia, Fixed, Fiberglass	2' - 10"	12' - 0"	WEST STAIR GROUP
F	Pella	Impervia, Fixed, Fiberglass	2' - 10"	3' - 6"	WEST STAIR GROUP
G	Pella	Impervia, Fixed, Fiberglass	2' - 10"	5' - 10"	WEST STAIR GROUP
H	Pella	Impervia, Fixed, Fiberglass	2' - 10"	7' - 10"	WEST STAIR GROUP
J	Pella	Impervia, Fixed, Fiberglass	5' - 0"	1' - 6"	WEST STAIR GROUP


WINDOW GENERAL NOTES

- LISTED MANUFACTURER AND MODEL IS BASIS OF DESIGN, SUBMIT SUBSTITUTE TO ARCHITECT FOR APPROVAL.
- EGRESS WINDOWS SHALL COMPLY WITH SECTION 310 OF THE IRC, A COMPLIANT EGRESS OUT OF THE BASEMENT AND HABITABLE ATTIC WILL BE PROVIDED IF APPLICABLE. SEE DETAIL FOR EGRESS WELL. EGRESS WINDOW SIZE AND LOCATION ARE NOTED ON THESE PLANS.
- WINDOWS SHALL HAVE FALL PROTECTION PER IRC 312.2 AS WHERE NEEDED.
- WINDOWS, DOORS, AND OTHER GLAZING WILL COMPLY WITH THE REQUIREMENTS OF SECTION 308 OF THE IRC FOR SAFETY GLAZING.
- ASSEMBLE/MULL WINDOWS ON SITE AS REQUIRED.


WINDOW THERMAL PROPERTIES

MANUFACTURER: PELLA  
PRODUCT LINE: IMPERVIA  
U-FACTOR: 0.25  
SHGC: 0.55


typical sill/head window detail

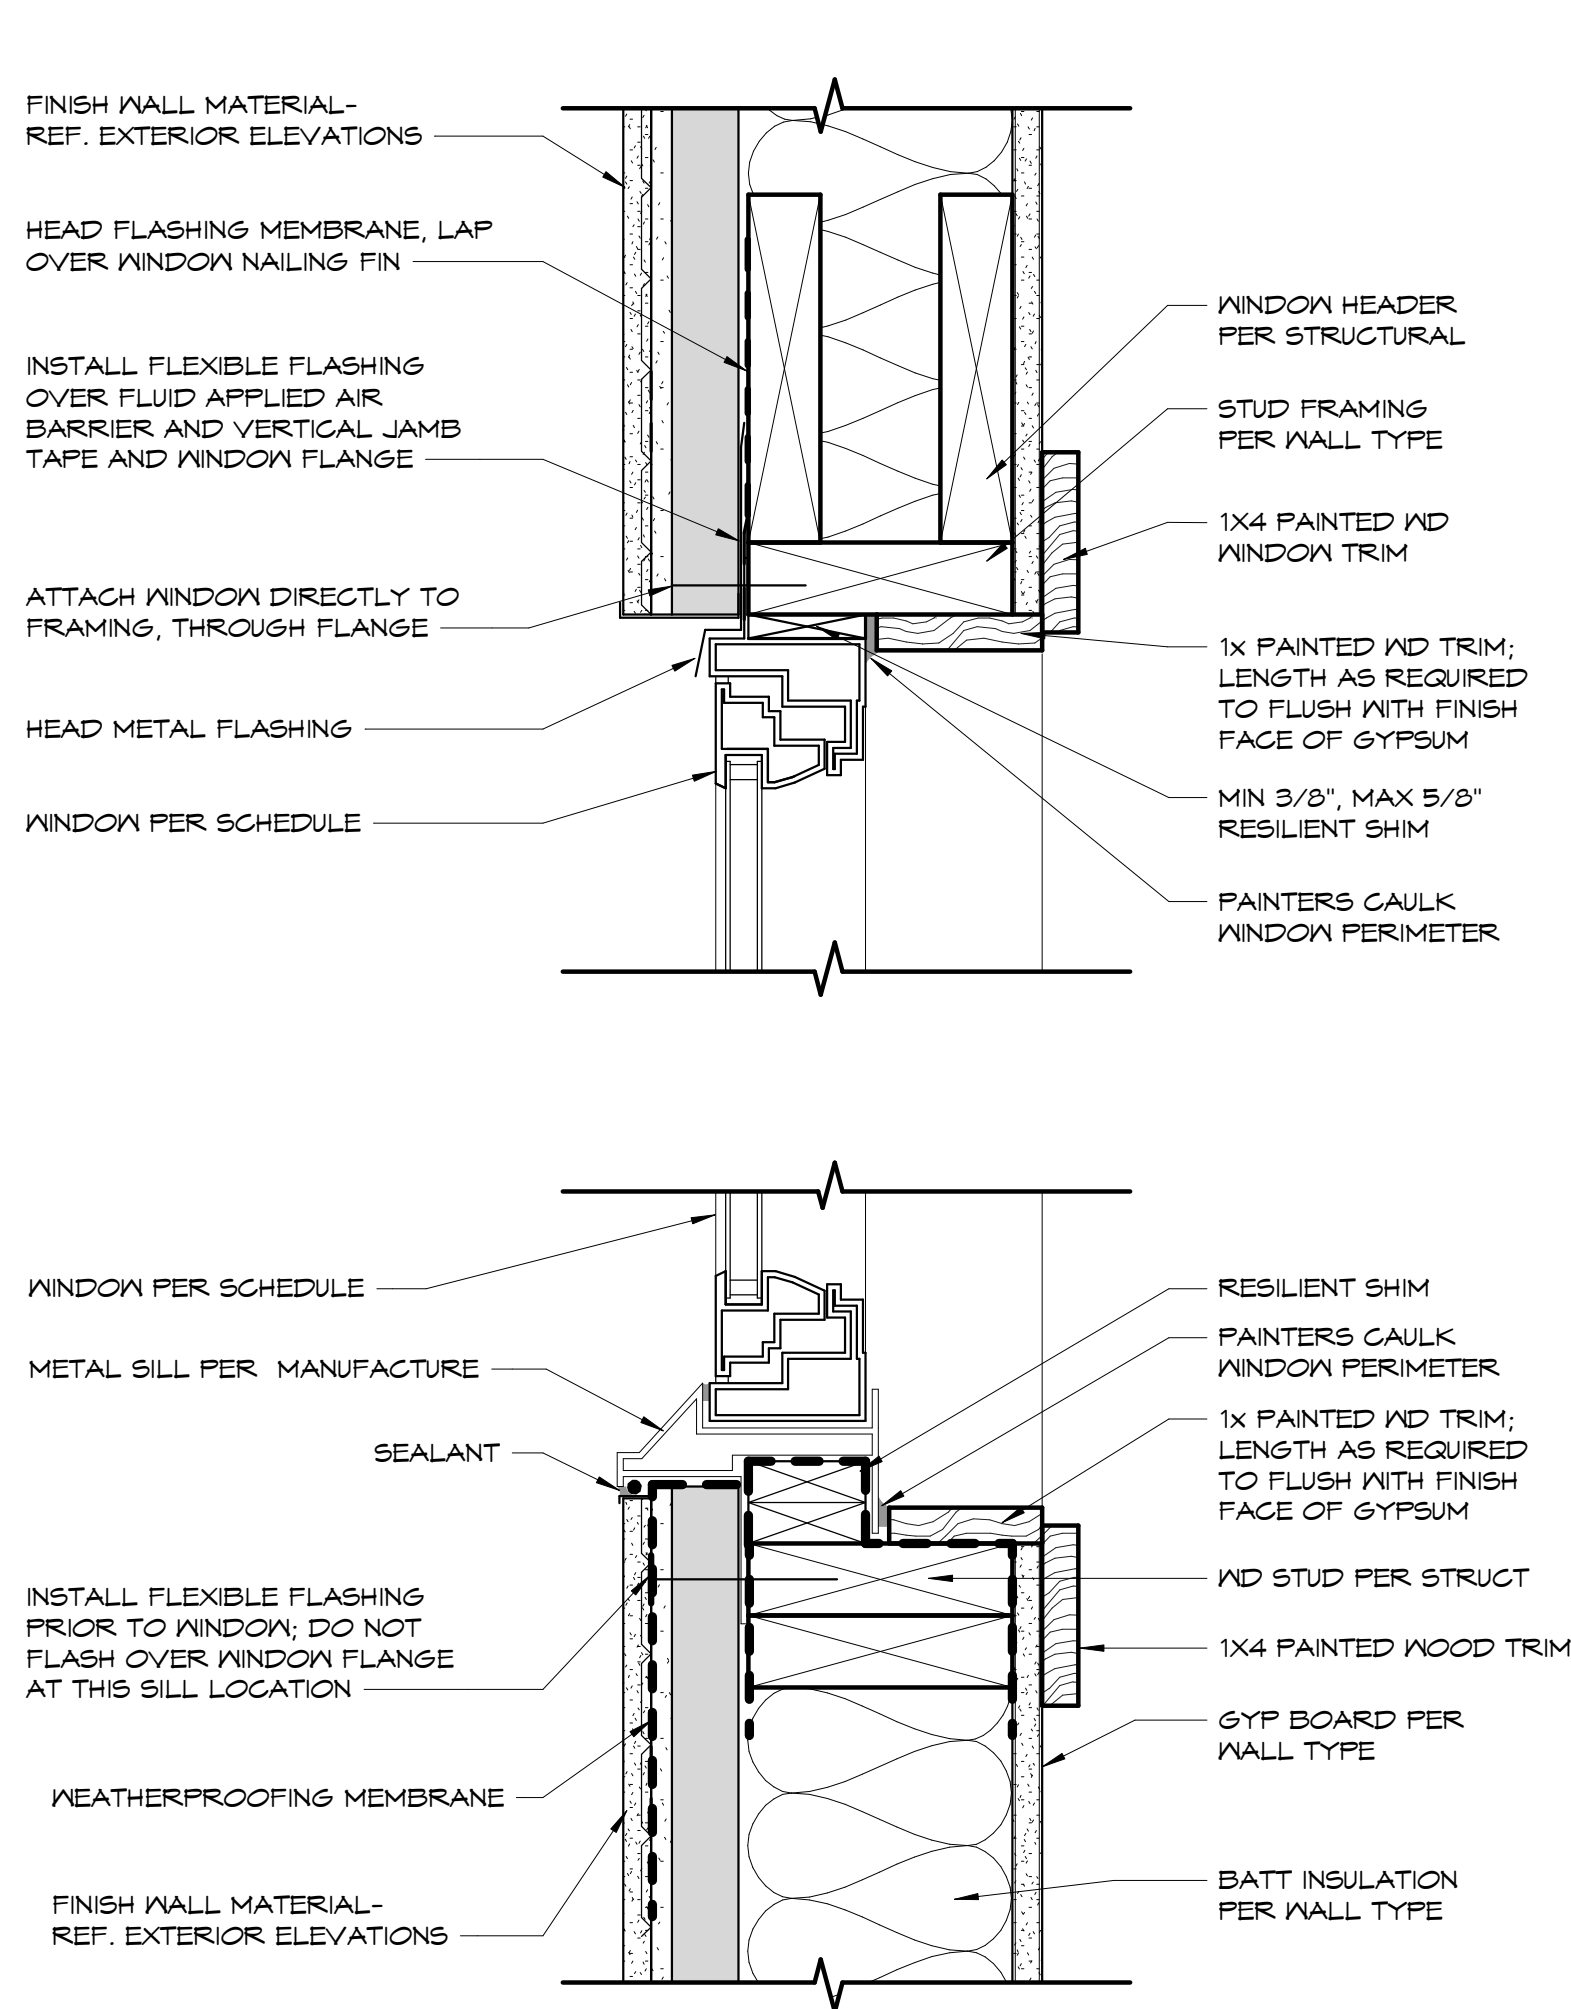

window types - composite & storefront

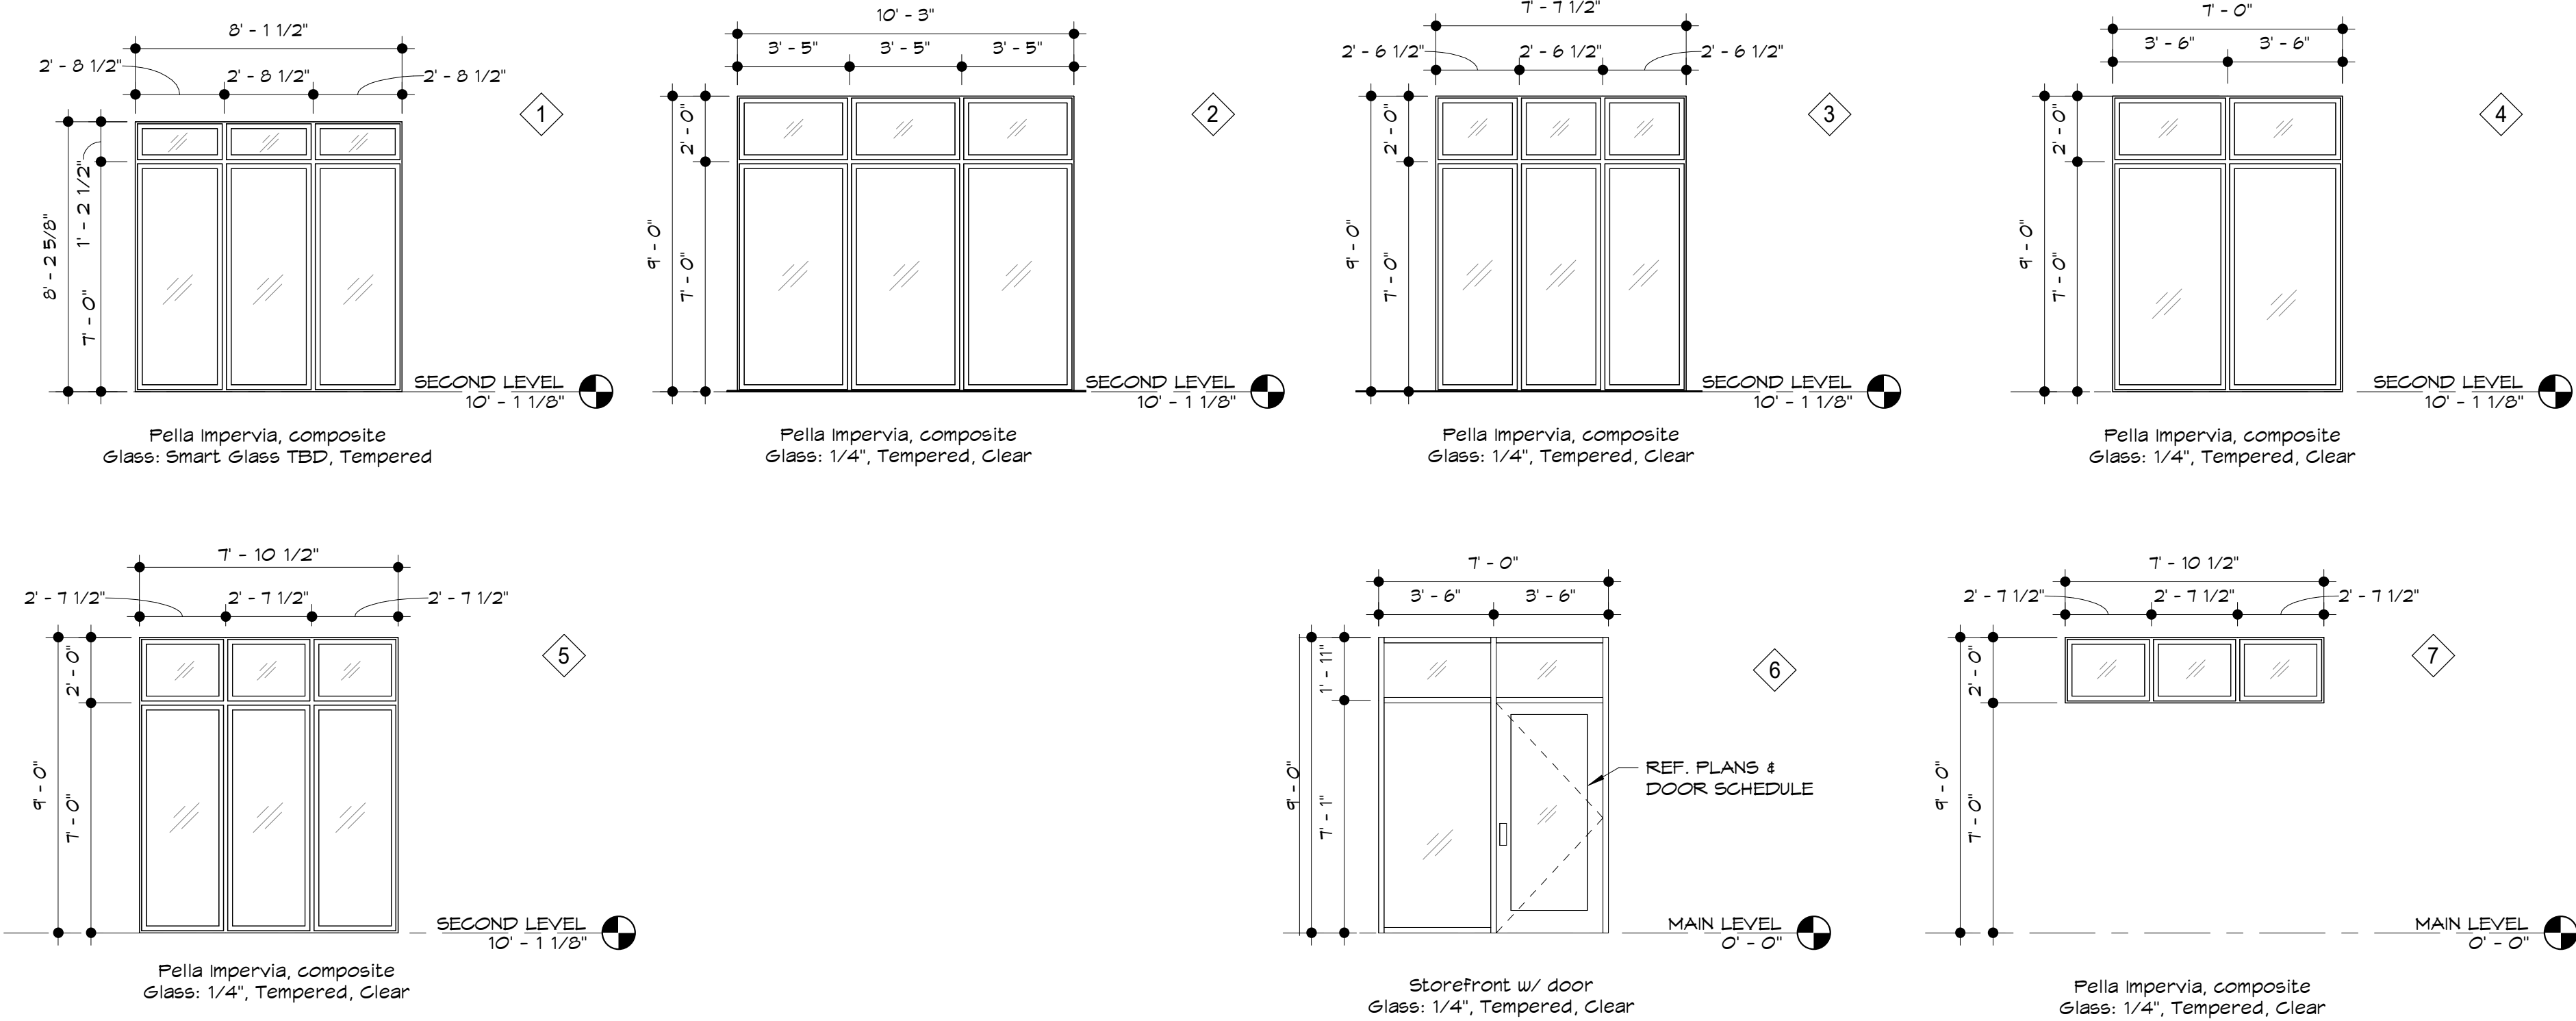

window types - single

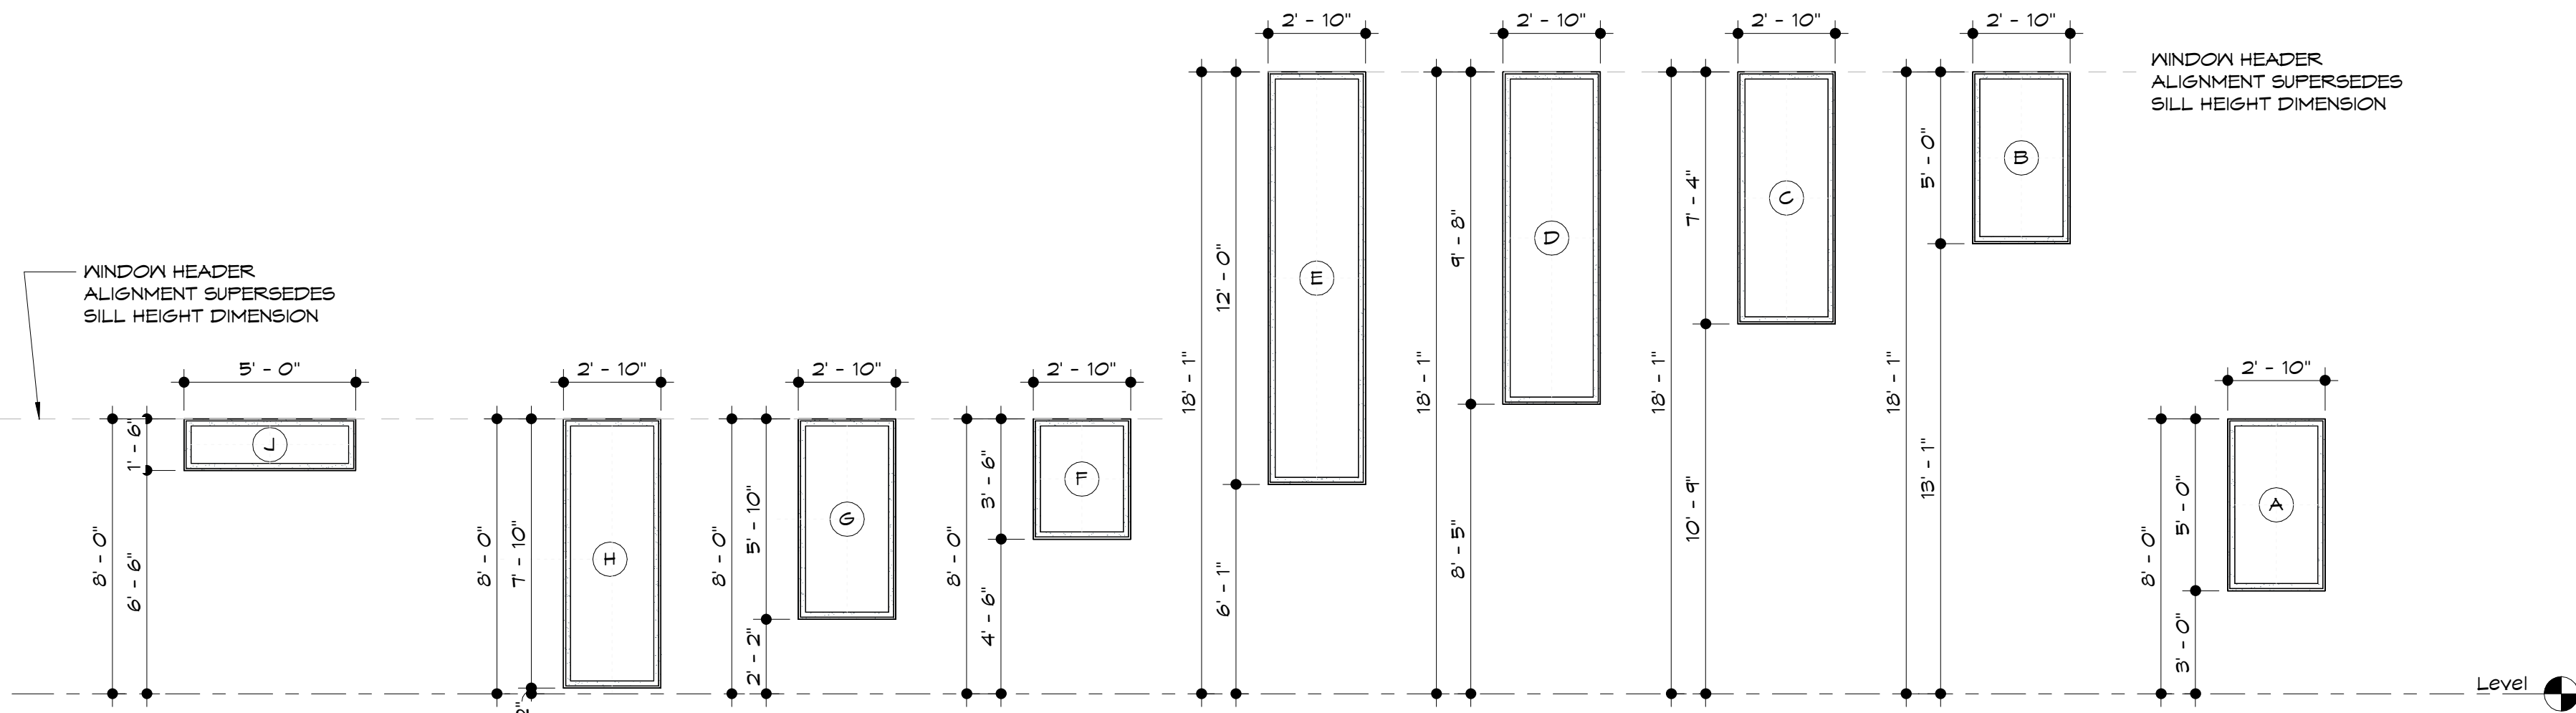

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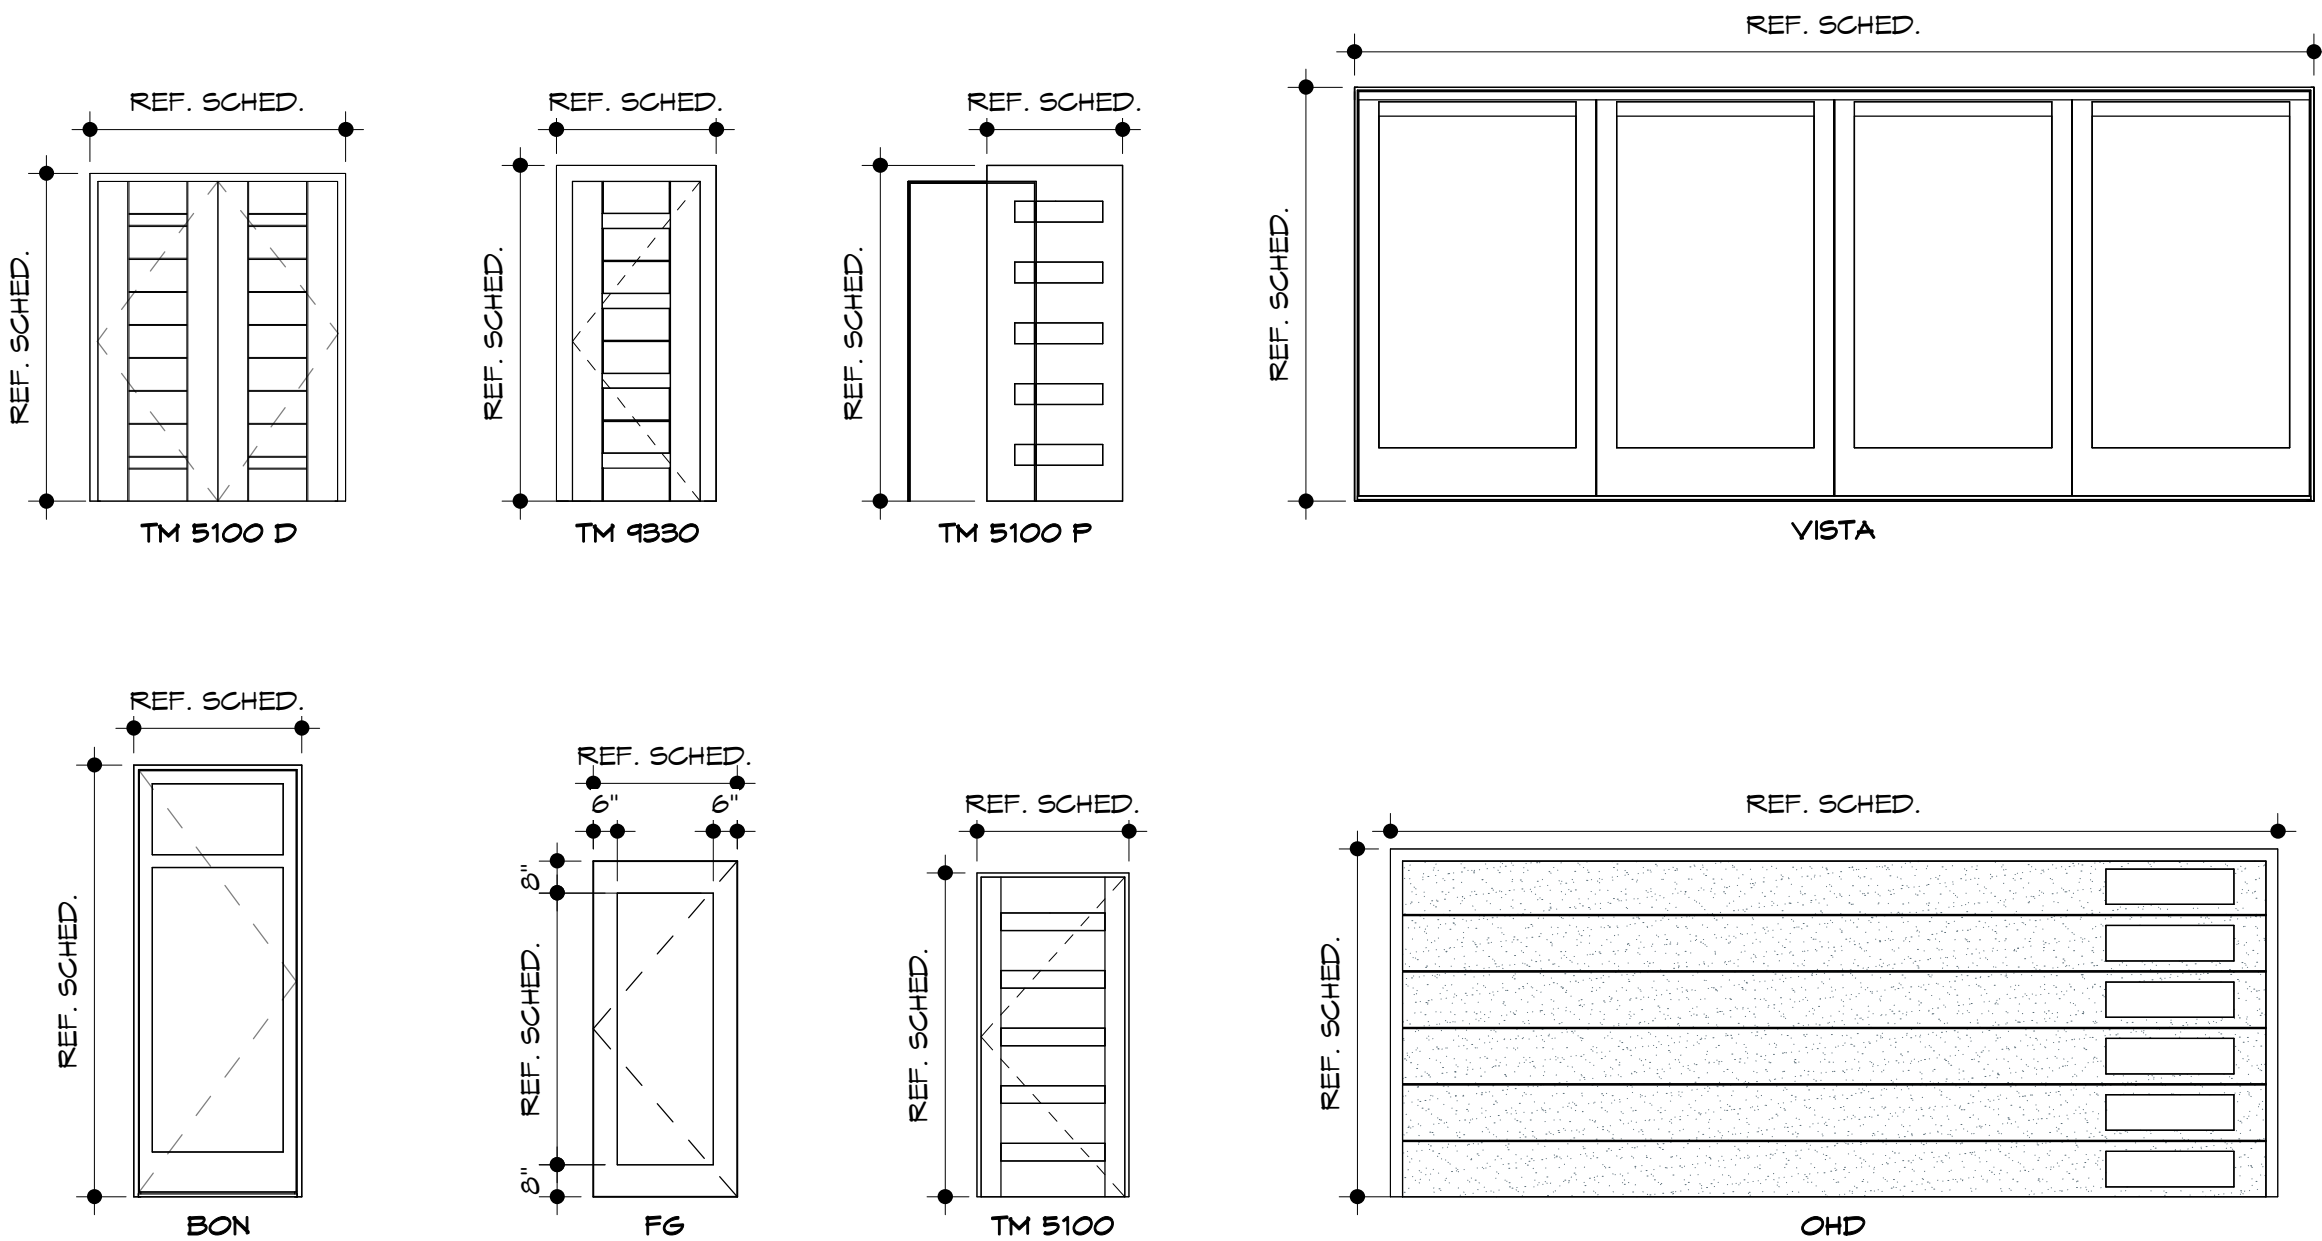
project no.:  
20.32

sheet contents:  
WINDOW  
INFORMATION

sheet no.:



door types



door schedule notes

DOOR GENERAL NOTES

- 1. DOORS SHALL COMPLY WITH THE REQUIREMENTS OF SECTION 308 OF THE IRC FOR SAFETY GLAZING.
- 2. THE GARAGE DOOR(S) SHALL MEET DASHA 90 MPH REQUIREMENTS.

DOOR SCHEDULE LEGEND

DOOR TYPES

BON = Bonelli Hinged Door  
TM 9330 = Trustile Modern (TM) Series Door  
TM 5100 P = Trustile Modern (TM) Series Pocket Door  
TM 9330 D = Trustile Modern (TM) Series Double Door  
VISTA = Kolbe VistaLux® AL Line Folding Door  
FG = Full Glass Patio Door  
TM 5100 = Trustile Modern (TM) Series Exterior Door  
OHD = Overhead Garage Door

DOOR MATERIAL AND FRAME MATERIAL:

S = Steel  
A = Aluminum  
W = Wood

DOOR AND FRAME SCHEDULE					
PLAN MARK	DOOR		DOOR TYPE (A)	DOOR MATERIAL (B)	COMMENTS
	OPENING SIZE W	H			
A001	18' - 0"	7' - 0"	OHD	S	
A002a	3' - 0"	6' - 8"	TM 5100	W	
A002b	2' - 8"	6' - 8"	TM 9330	W	SELF LATCHING & SELF CLOSING HARDWARE PER IRC R302.5.1
A003	2' - 8"	6' - 8"	TM 9330	W	
A004	2' - 8"	6' - 8"	TM 9330	W	
A100	2' - 8"	6' - 8"	TM 9330	W	
A101	16' - 0"	8' - 0"	VISTA	AL	
A104	2' - 8"	6' - 8"	TM 5100 P	W	
A105	2' - 4"	6' - 8"	TM 5100 D	W	
A107	2' - 8"	6' - 8"	TM 9330	W	
A108	2' - 8"	6' - 8"	TM 9330	W	
A109	2' - 8"	6' - 8"	TM 5100 P	W	
A110a	2' - 8"	6' - 8"	TM 9330	W	
A110b	3' - 3"	7' - 0"	FG	ALUM	
A111	2' - 8"	6' - 8"	TM 9330	W	
A112	2' - 4"	6' - 8"	TM 9330	W	
A201	2' - 8"	6' - 8"	TM 9330	W	
A202a	2' - 8"	6' - 8"	TM 9330	W	
A202b	2' - 4"	6' - 8"	TM 9330	W	
A203	2' - 4"	6' - 8"	TM 9330	W	
A204	3' - 0"	9' - 0"	BON	AL	
A206a	2' - 8"	6' - 8"	TM 9330	W	
A206b	3' - 0"	9' - 0"	BON	AL	
A207a	2' - 8"	6' - 8"	TM 9330	W	
A207b	2' - 0"	8' - 0"	TM 9330	W	
A208	2' - 8"	6' - 8"	TM 5100 P	W	
B001	18' - 0"	7' - 0"	OHD	S	
B002a	3' - 0"	6' - 8"	TM 5100	W	
B002b	2' - 8"	6' - 8"	TM 9330	W	SELF LATCHING & SELF CLOSING HARDWARE PER IRC R302.5.1
B003	2' - 8"	6' - 8"	TM 9330	W	
B004	2' - 8"	6' - 8"	TM 9330	W	
B100	2' - 8"	6' - 8"	TM 9330	W	
B101	16' - 0"	8' - 0"	VISTA	AL	
B104	2' - 8"	6' - 8"	TM 5100 P	W	
B105	2' - 4"	6' - 8"	TM 5100 D	W	
B107	2' - 8"	6' - 8"	TM 9330	W	
B108	2' - 8"	6' - 8"	TM 9330	W	
B109	2' - 8"	6' - 8"	TM 5100 P	W	
B110a	2' - 8"	6' - 8"	TM 9330	W	
B110b	3' - 3"	7' - 0"	FG	ALUM	
B111	2' - 8"	6' - 8"	TM 9330	W	
B112	2' - 4"	6' - 8"	TM 9330	W	
B201	2' - 8"	6' - 8"	TM 9330	W	
B202a	2' - 8"	6' - 8"	TM 9330	W	
B202b	2' - 4"	6' - 8"	TM 9330	W	
B203	2' - 4"	6' - 8"	TM 9330	W	
B204	3' - 0"	9' - 0"	BON	AL	
B206a	2' - 8"	6' - 8"	TM 9330	W	
B206b	3' - 0"	9' - 0"	BON	AL	
B207a	2' - 8"	6' - 8"	TM 9330	W	
B207b	2' - 0"	8' - 0"	TM 9330	W	
B208	2' - 8"	6' - 8"	TM 5100 P	W	
C001	18' - 0"	7' - 0"	OHD	S	
C002a	3' - 0"	6' - 8"	TM 5100	W	
C002b	2' - 8"	6' - 8"	TM 9330	W	SELF LATCHING & SELF CLOSING HARDWARE PER IRC R302.5.1
C003	2' - 8"	6' - 8"	TM 9330	W	
C004	2' - 8"	6' - 8"	TM 9330	W	
C100	2' - 8"	6' - 8"	TM 9330	W	
C101	18' - 0"	8' - 0"	VISTA	AL	
C104	2' - 8"	6' - 8"	TM 5100 P	W	
C105	2' - 4"	6' - 8"	TM 5100 D	W	
C106	2' - 8"	6' - 8"	TM 9330	W	
C107	2' - 8"	6' - 8"	TM 9330	W	
C108	2' - 8"	6' - 8"	TM 9330	W	
C109	2' - 8"	6' - 8"	TM 5100 P	W	
C110a	2' - 8"	6' - 8"	TM 9330	W	
C110b	3' - 3"	7' - 0"	FG	ALUM	
C111	2' - 8"	6' - 8"	TM 9330	W	
C112	2' - 4"	6' - 8"	TM 9330	W	
C201	2' - 8"	6' - 8"	TM 9330	W	
C202a	2' - 4"	6' - 8"	TM 9330	W	
C202b	2' - 4"	6' - 8"	TM 9330	W	
C203	2' - 4"	6' - 8"	TM 9330	W	
C204	3' - 0"	9' - 0"	BON	AL	
C206a	2' - 8"	6' - 8"	TM 9330	W	
C206b	3' - 0"	9' - 0"	BON	AL	
C207a	2' - 8"	6' - 8"	TM 9330	W	
C207b	2' - 0"	8' - 8"	TM 9330	W	
C208	2' - 8"	6' - 8"	TM 5100 P	W	

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FOR REVIEW

SHIRAZ TOWNHOMES

603, 605, & 607 W. 49th ST. KANSAS CITY, MO 64112

REVISIONS		
No.	Description	Date

sheet issue date:  
09.27.2024

project no.:  
20.32


sheet contents:  
DOOR INFORMATION

sheet no.:  
A502



1 reflected ceiling plan - lower level

1/4" = 1'-0"

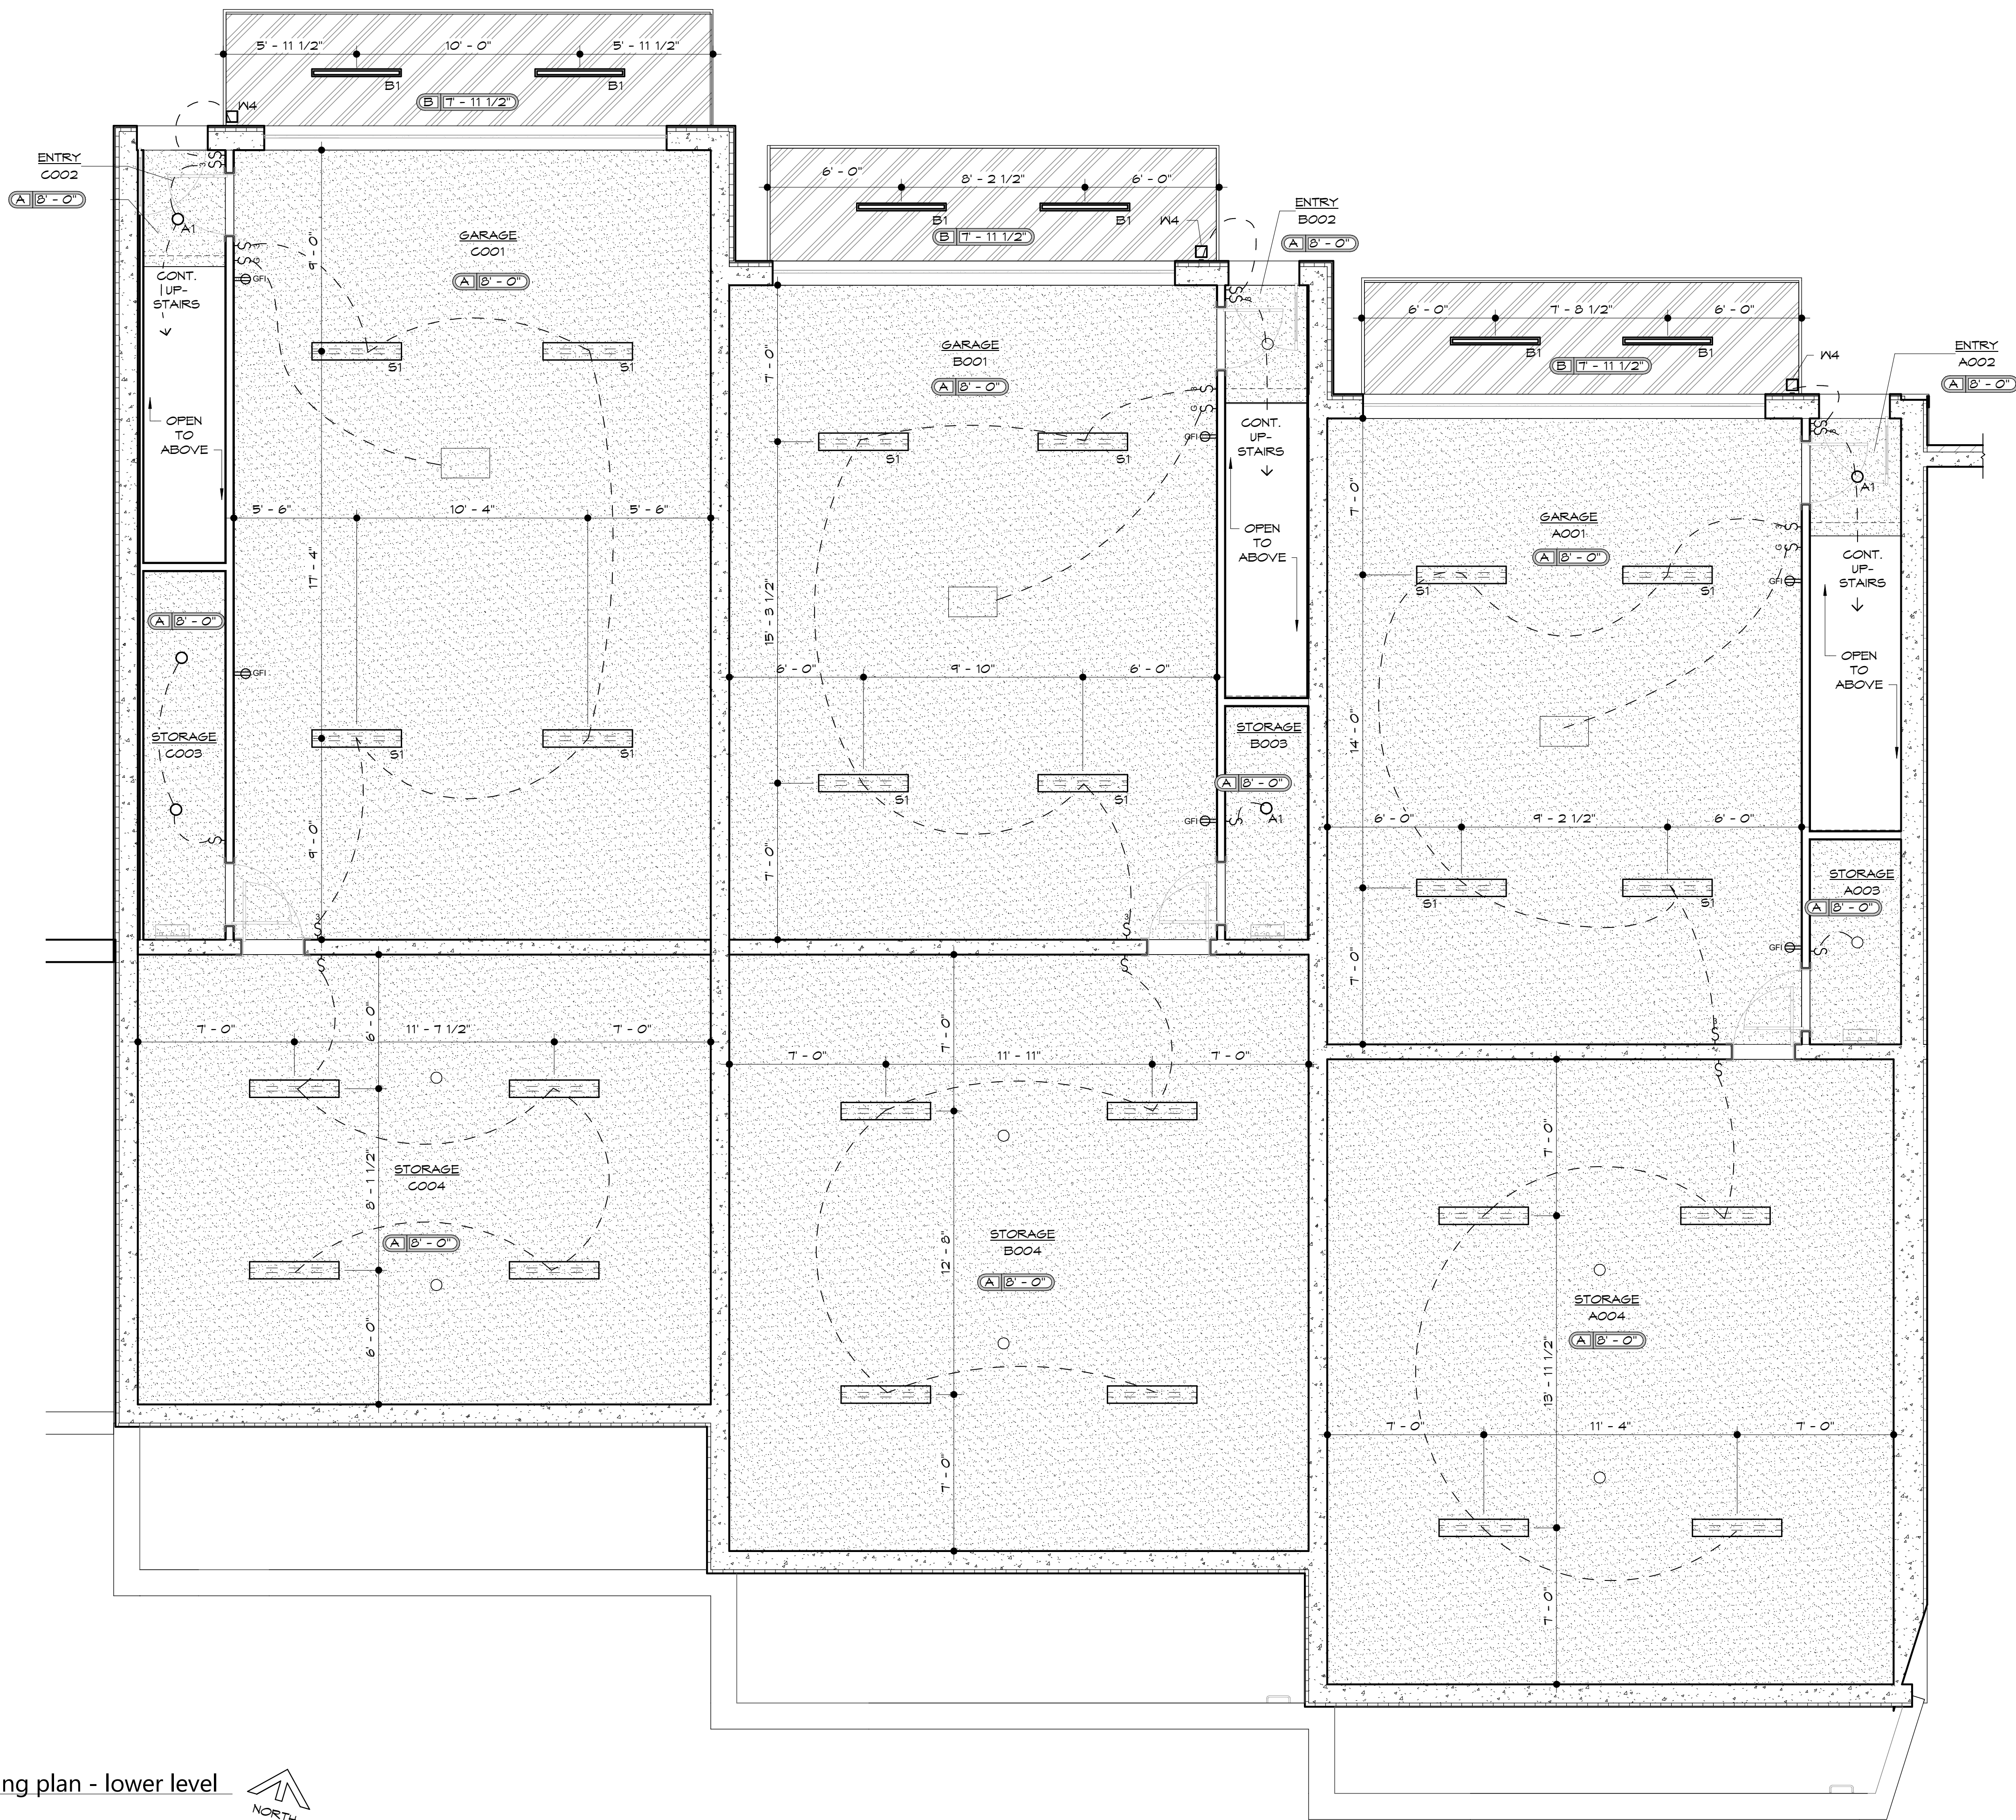

ceiling / electrical general notes

1. CARBON MONOXIDE DETECTORS SHALL BE INSTALLED PER R315.
2. SMOKE DETECTORS SHALL BE INSTALLED PER R314.
3. COORDINATE REQUIREMENTS FOR ALL ELECTRICAL FIXTURES WITH SPECIFIC SELECTED FIXTURE REQUIREMENTS PRIOR TO ROUGH-IN.
4. THIS HOUSE SHALL BE PROVIDED WITH A "UFER" GROUND PER IRC SECTION 3608.1.

reflected ceiling plan legend

CEILING TYPES

TYPE	PATTERN	DESCRIPTION
A		PAINTED GYP. BD. CEILING
B		EXTERIOR METAL SOFFIT, PER UNIT COLOR & MANUF. INSTALL INSTRUCTIONS.
C		EXTERIOR NICHE SOFFIT

lighting fixture schedule - ALL levels

TYPE MARK	DESCRIPTION
A1	6" LED RECESSED CAN LIGHT
A2	6" LED RECESSED CAN LIGHT FOR WET LOCATION
B1	48" LINEAR FIXTURE
C1	MODERN FAN FIXTURE - BLACK WITH BAMBOO
D1	OVER-VANITY FIXTURE
E1	BATHROOM EXHAUST FAN
E2	BATHROOM EXHAUST FAN IV/ INTEGRAL LED
P1	PENDANT- SINGLE
P2	LARGE, HANGING UP-DOWN PENDANT
P3	PENDANT- LINEAR
P4	PENDANT- ACCENT
S1	SHOP LIGHT - 4 FT
W1	WALL SCONCE - INTERIOR - B&L-Moderne Brushed Gold
W2	WALL SCONCE - INTERIOR - [TBD]
W3	WALL SCONCE - INTERIOR - [TBD]
W4	WALL SCONCE - EXTERIOR

OUTLET TYPES

- TELEPHONE/DATA OUTLET; COORDINATE WITH LOCAL PROVIDER AND OWNER
- CABLE-TV OUTLET; COORDINATE EXTERIOR LOCATION WITH LOCAL PROVIDER AND OWNER
- STANDARD DUPLEX OUTLET
- LETTER INDICATING TYPE (WHERE APPLICABLE)
- GFI GFCI OUTLET PER CODE
- USB DUPLEX OUTLET W/ USB OUTLETS
- M DUPLEX OUTLET AT MICROHOOD LOCATION OVER RANGE
  - MOUNT AT 60" A.F.F.
  - GARBAGE DISPOSAL OUTLET UNDER SINK
  - WIRE TO SWITCH LOCATION AS INDICATED
- TV TV OUTLET
  - UTILIZE RECESSED OUTLET- MOUNT AT 60" A.F.F.
- D 4-SLOT DRYER OUTLET (240V)
  - MOUNT AT 36" A.F.F.

FIXTURE CONTROLS

- STANDARD SWITCH
- LETTER/ NUMBER INDICATING TYPE (WHERE APPLICABLE)
- G GARAGE DOOR OPENER SWITCH
- F CEILING FAN SWITCH
  - WIRE FOR INDEPENDENT FAN/SWITCH CONTROLS
- D DIMMER SWITCH
- S 3-WAY SWITCH

REVISIONS		
No.	Description	Date


sheet issue date:  
09.27.2024

project no.:  
20.32

sheet contents:  
CEILING / ELECTRICAL  
PLAN - GARAGE LEVEL

sheet no.:



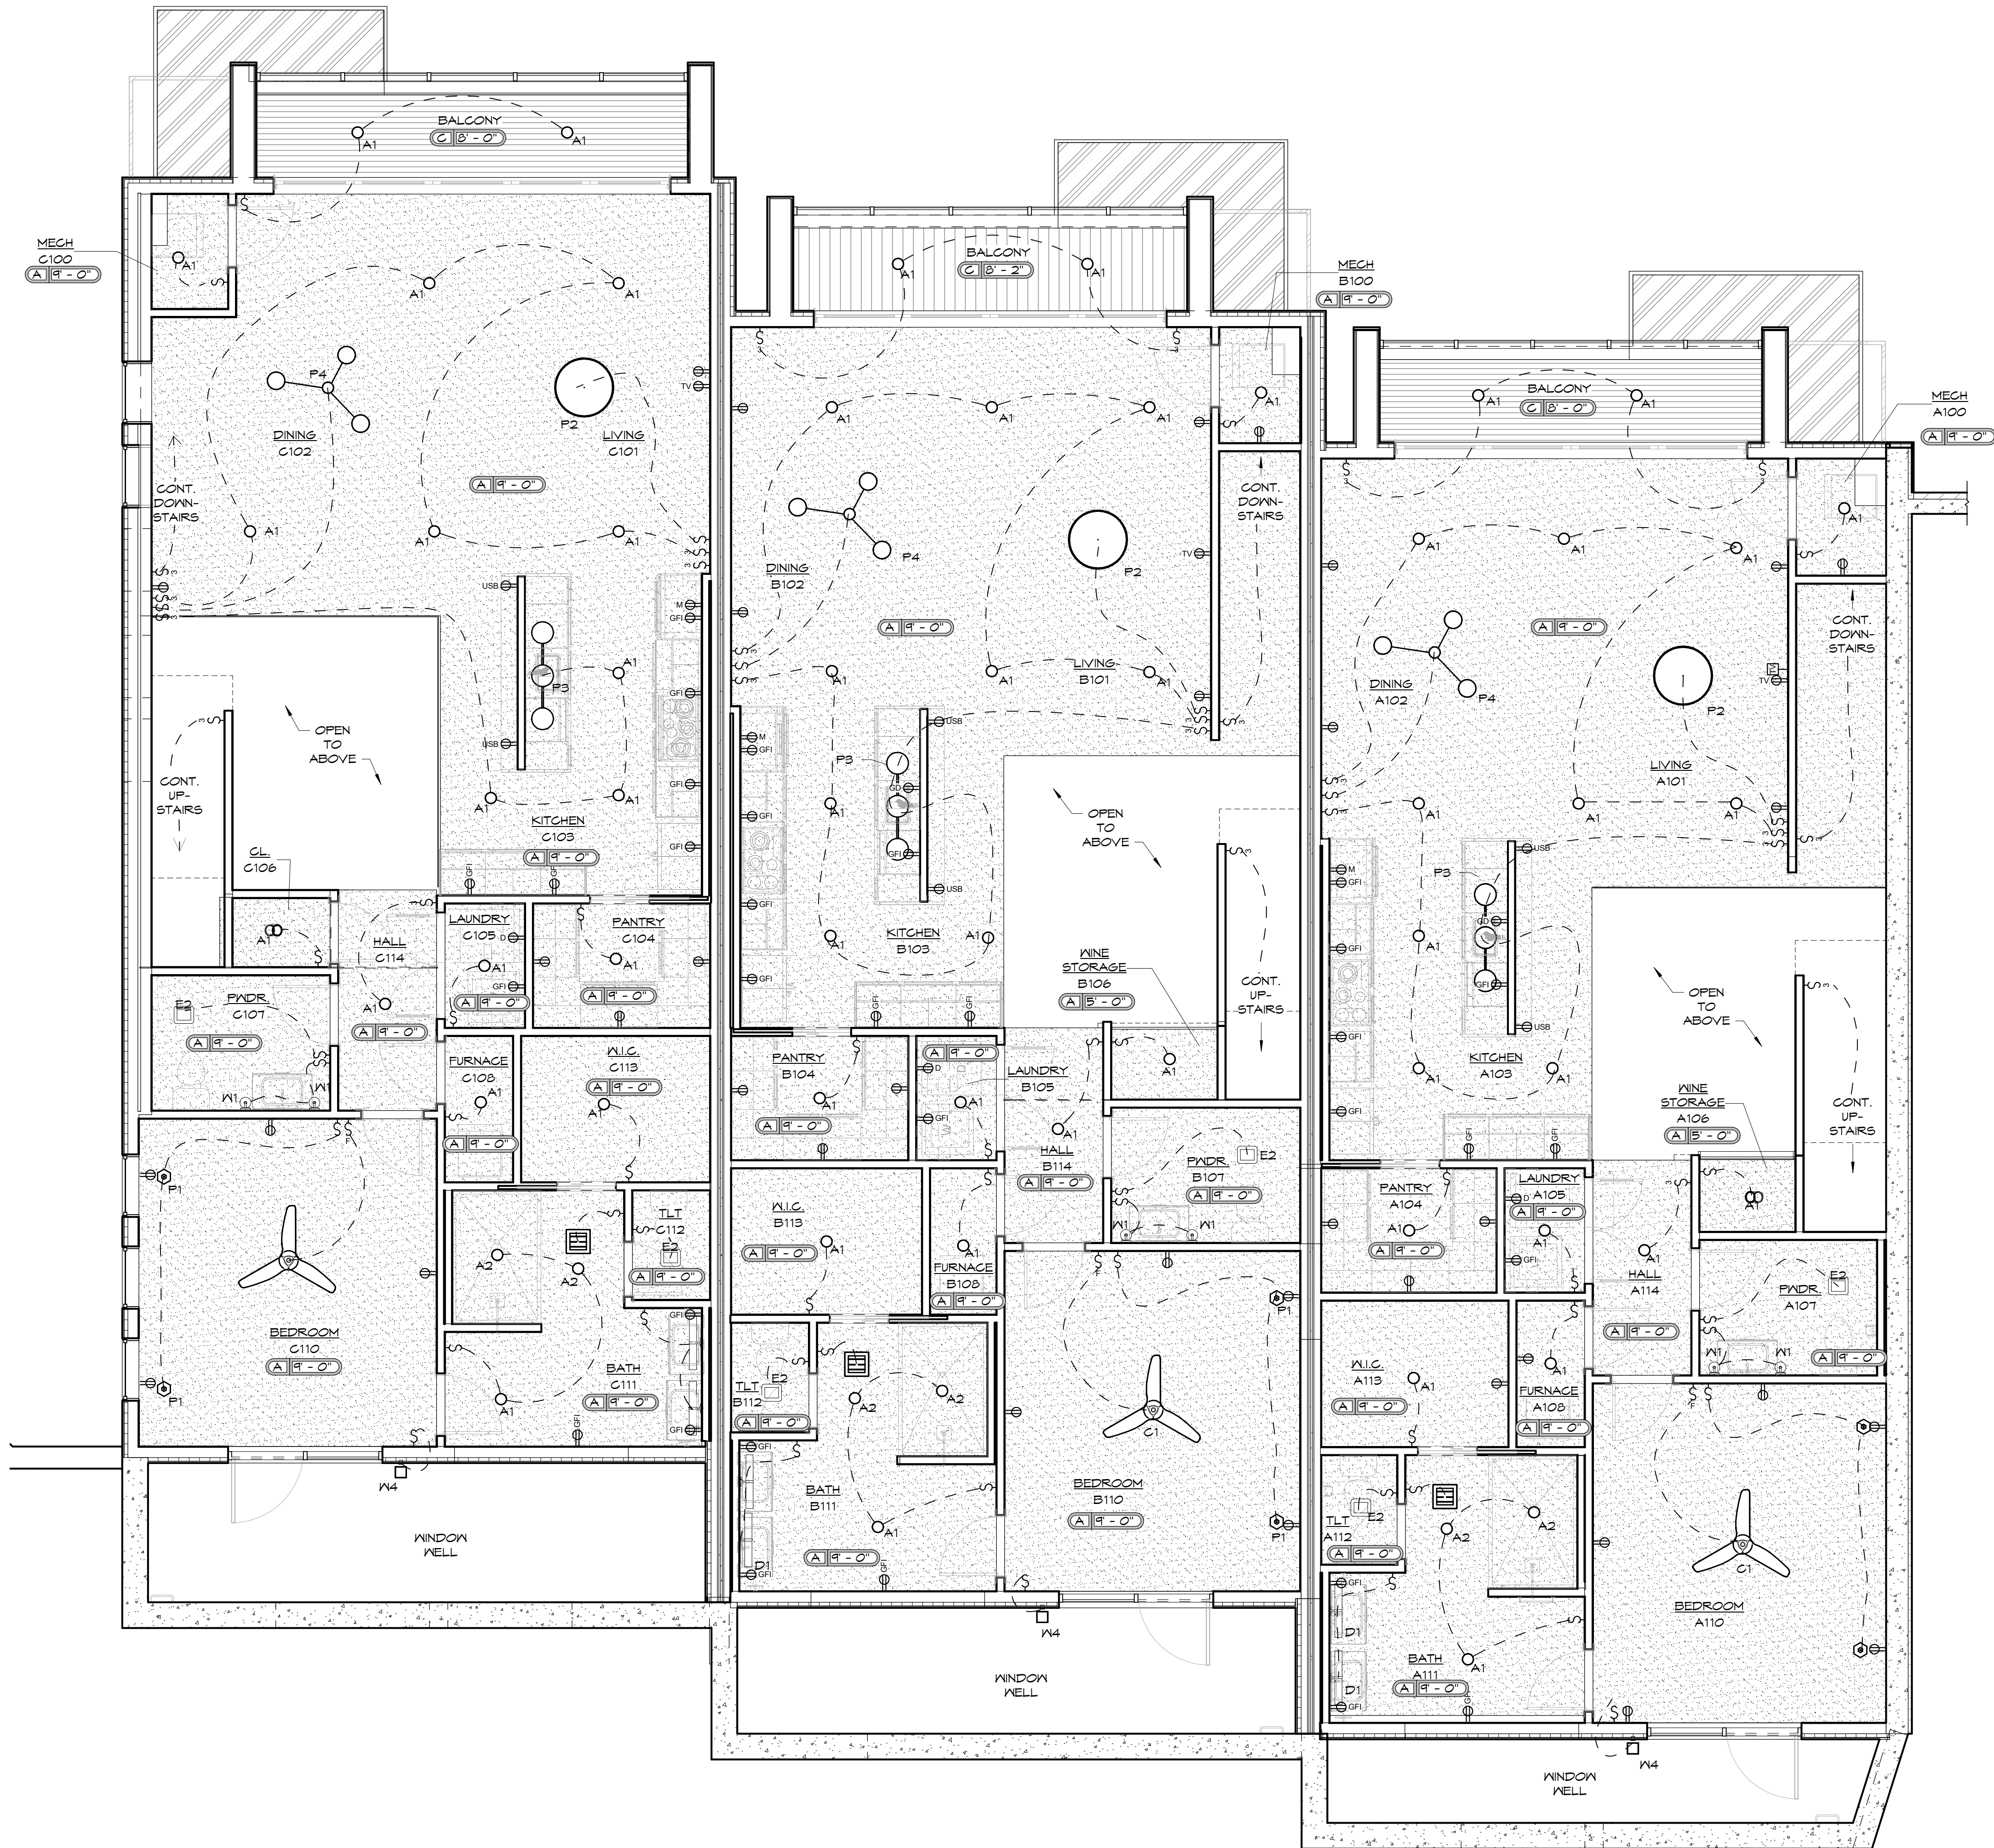

1 reflected ceiling plan - main level  
1/4" = 1'-0"



## ceiling / electrical general notes

1. CARBON MONOXIDE DETECTORS SHALL BE INSTALLED PER R315
2. SMOKE DETECTORS SHALL BE INSTALLED PER R314.
3. COORDINATE REQUIREMENTS FOR ALL ELECTRICAL FIXTURES WITH SPECIFIC SELECTED FIXTURE REQUIREMENTS PRIOR TO ROUGH-IN.
4. THIS HOUSE SHALL BE PROVIDED WITH A "UFER" GROUND PER IRC SECTION 3608.1.

## reflected ceiling plan legend

### CEILING TYPES

TYPE	PATTERN	DESCRIPTION
A		PAINTED GYP. BD. CEILING
B		EXTERIOR METAL SOFFIT, PER UNIT COLOR & MANUF. INSTALL INSTRUCTIONS.
C		EXTERIOR, NICHESOFFIT SOFFIT

## lighting fixture schedule - ALL levels

TYPE MARK	DESCRIPTION
A1	6" LED RECESSED CAN LIGHT
A2	6" LED RECESSED CAN LIGHT FOR WET LOCATION
B1	48" LINEAR FIXTURE
C1	MODERN FAN FIXTURE - BLACK WITH BAMBOO
D1	OVER-VANITY FIXTURE
E1	BATHROOM EXHAUST FAN
E2	BATHROOM EXHAUST FAN IV. INTEGRAL LED
P1	PENDANT- SINGLE
P2	LARGE, HANGING UP-DOWN PENDANT
P3	PENDANT- LINEAR
P4	PENDANT- ACCENT
S1	SHOP LIGHT - 4 FT
W1	WALL SCONCE - INTERIOR - BGL-Moderne Brushed Gold
W2	WALL SCONCE - INTERIOR - [TBD]
W3	WALL SCONCE - INTERIOR - [TBD]
W4	WALL SCONCE - EXTERIOR

### OUTLET TYPES

- TELEPHONE/DATA OUTLET; COORDINATE WITH LOCAL PROVIDER AND OWNER.
- CABLE-TV OUTLET; COORDINATE EXTERIOR LOCATION WITH LOCAL PROVIDER AND OWNER.
- STANDARD DUPLEX OUTLET
- LETTER INDICATING TYPE (WHERE APPLICABLE)
- GFI GFCI OUTLET PER CODE
  - USB DUPLEX OUTLET IV. USB OUTLETS
  - M DUPLEX OUTLET AT MICROHOOD LOCATION OVER RANGE
  - MOUNT AT 60" A.F.F.
  - GARBAGE DISPOSAL OUTLET UNDER SINK
  - WIRE TO SWITCH LOCATION AS INDICATED
- TV TV OUTLET
  - UTILIZE RECESSED OUTLET- MOUNT AT 60" A.F.F.
- D 4-SLOT DRYER OUTLET (240V)
  - MOUNT AT 36" A.F.F.

### FIXTURE CONTROLS

- STANDARD SWITCH
- LETTER/ NUMBER INDICATING TYPE (WHERE APPLICABLE)
- G GARAGE DOOR OPENER SWITCH
  - F CEILING FAN SWITCH
  - WIRE FOR INDEPENDENT FAN/SWITCH CONTROLS
- D DIMMER SWITCH
  - S 3-WAY SWITCH



1 reflected ceiling plan - second level

1/4" = 1'-0"



ceiling / electrical general notes

1. CARBON MONOXIDE DETECTORS SHALL BE INSTALLED PER R315
2. SMOKE DETECTORS SHALL BE INSTALLED PER R314.
3. COORDINATE REQUIREMENTS FOR ALL ELECTRICAL FIXTURES WITH SPECIFIC SELECTED FIXTURE REQUIREMENTS PRIOR TO ROUGH-IN.
4. THIS HOUSE SHALL BE PROVIDED WITH A "UFER" GROUND PER IRC SECTION 3606.1.

reflected ceiling plan legend

CEILING TYPES

TYPE	PATTERN	DESCRIPTION
A		PAINTED GYP. BD. CEILING
B		EXTERIOR METAL SOFFIT, PER UNIT COLOR & MANUF. INSTALL INSTRUCTIONS.
C		EXTERIOR, NICHESOFFIT SOFFIT

lighting fixture schedule - ALL levels

TYPE MARK	DESCRIPTION
A1	6" LED RECESSED CAN LIGHT
A2	6" LED RECESSED CAN LIGHT FOR NET LOCATION
B1	48" LINEAR FIXTURE
C1	MODERN FAN FIXTURE - BLACK WITH BAMBOO
D1	OVER-VANITY FIXTURE
E1	BATHROOM EXHAUST FAN
E2	BATHROOM EXHAUST FAN W/ INTEGRAL LED
P1	PENDANT- SINGLE
P2	LARGE, HANGING UP-DOWN PENDANT
P3	PENDANT- LINEAR
P4	PENDANT- ACCENT
S1	SHOP LIGHT - 4 FT
W1	WALL SCONCE - INTERIOR - B&L-Moderne Brushed Gold
W2	WALL SCONCE - INTERIOR - (TBD)
W3	WALL SCONCE - INTERIOR - (TBD)
W4	WALL SCONCE - EXTERIOR

OUTLET TYPES

- TELEPHONE/DATA OUTLET; COORDINATE WITH LOCAL PROVIDER AND OWNER
- CABLE-TV OUTLET; COORDINATE EXTERIOR LOCATION WITH LOCAL PROVIDER AND OWNER
- STANDARD DUPLEX OUTLET
- LETTER INDICATING TYPE (WHERE APPLICABLE)
- GFI GFCI OUTLET PER CODE
  - USB DUPLEX OUTLET W/ USB OUTLETS
  - M DUPLEX OUTLET AT MICROHOOD LOCATION OVER RANGE
    - MOUNT AT 60" A.F.F.
  - GD GARBAGE DISPOSAL OUTLET UNDER SINK
    - WIRE TO SWITCH LOCATION AS INDICATED
  - TV TV OUTLET
    - UTILIZE RECESSED OUTLET- MOUNT AT 60" A.F.F.
  - D 4-SLOT DRYER OUTLET (240V)
    - MOUNT AT 36" A.F.F.

FIXTURE CONTROLS


- STANDARD SWITCH
- LETTER/ NUMBER INDICATING TYPE (WHERE APPLICABLE)
- G GARAGE DOOR OPENER SWITCH
  - F CEILING FAN SWITCH
    - WIRE FOR INDEPENDENT FAN/SWITCH CONTROLS
  - D DIMMER SWITCH
  - S 3-WAY SWITCH



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1 architectural finish plan - garage level

1/4" = 1'-0"

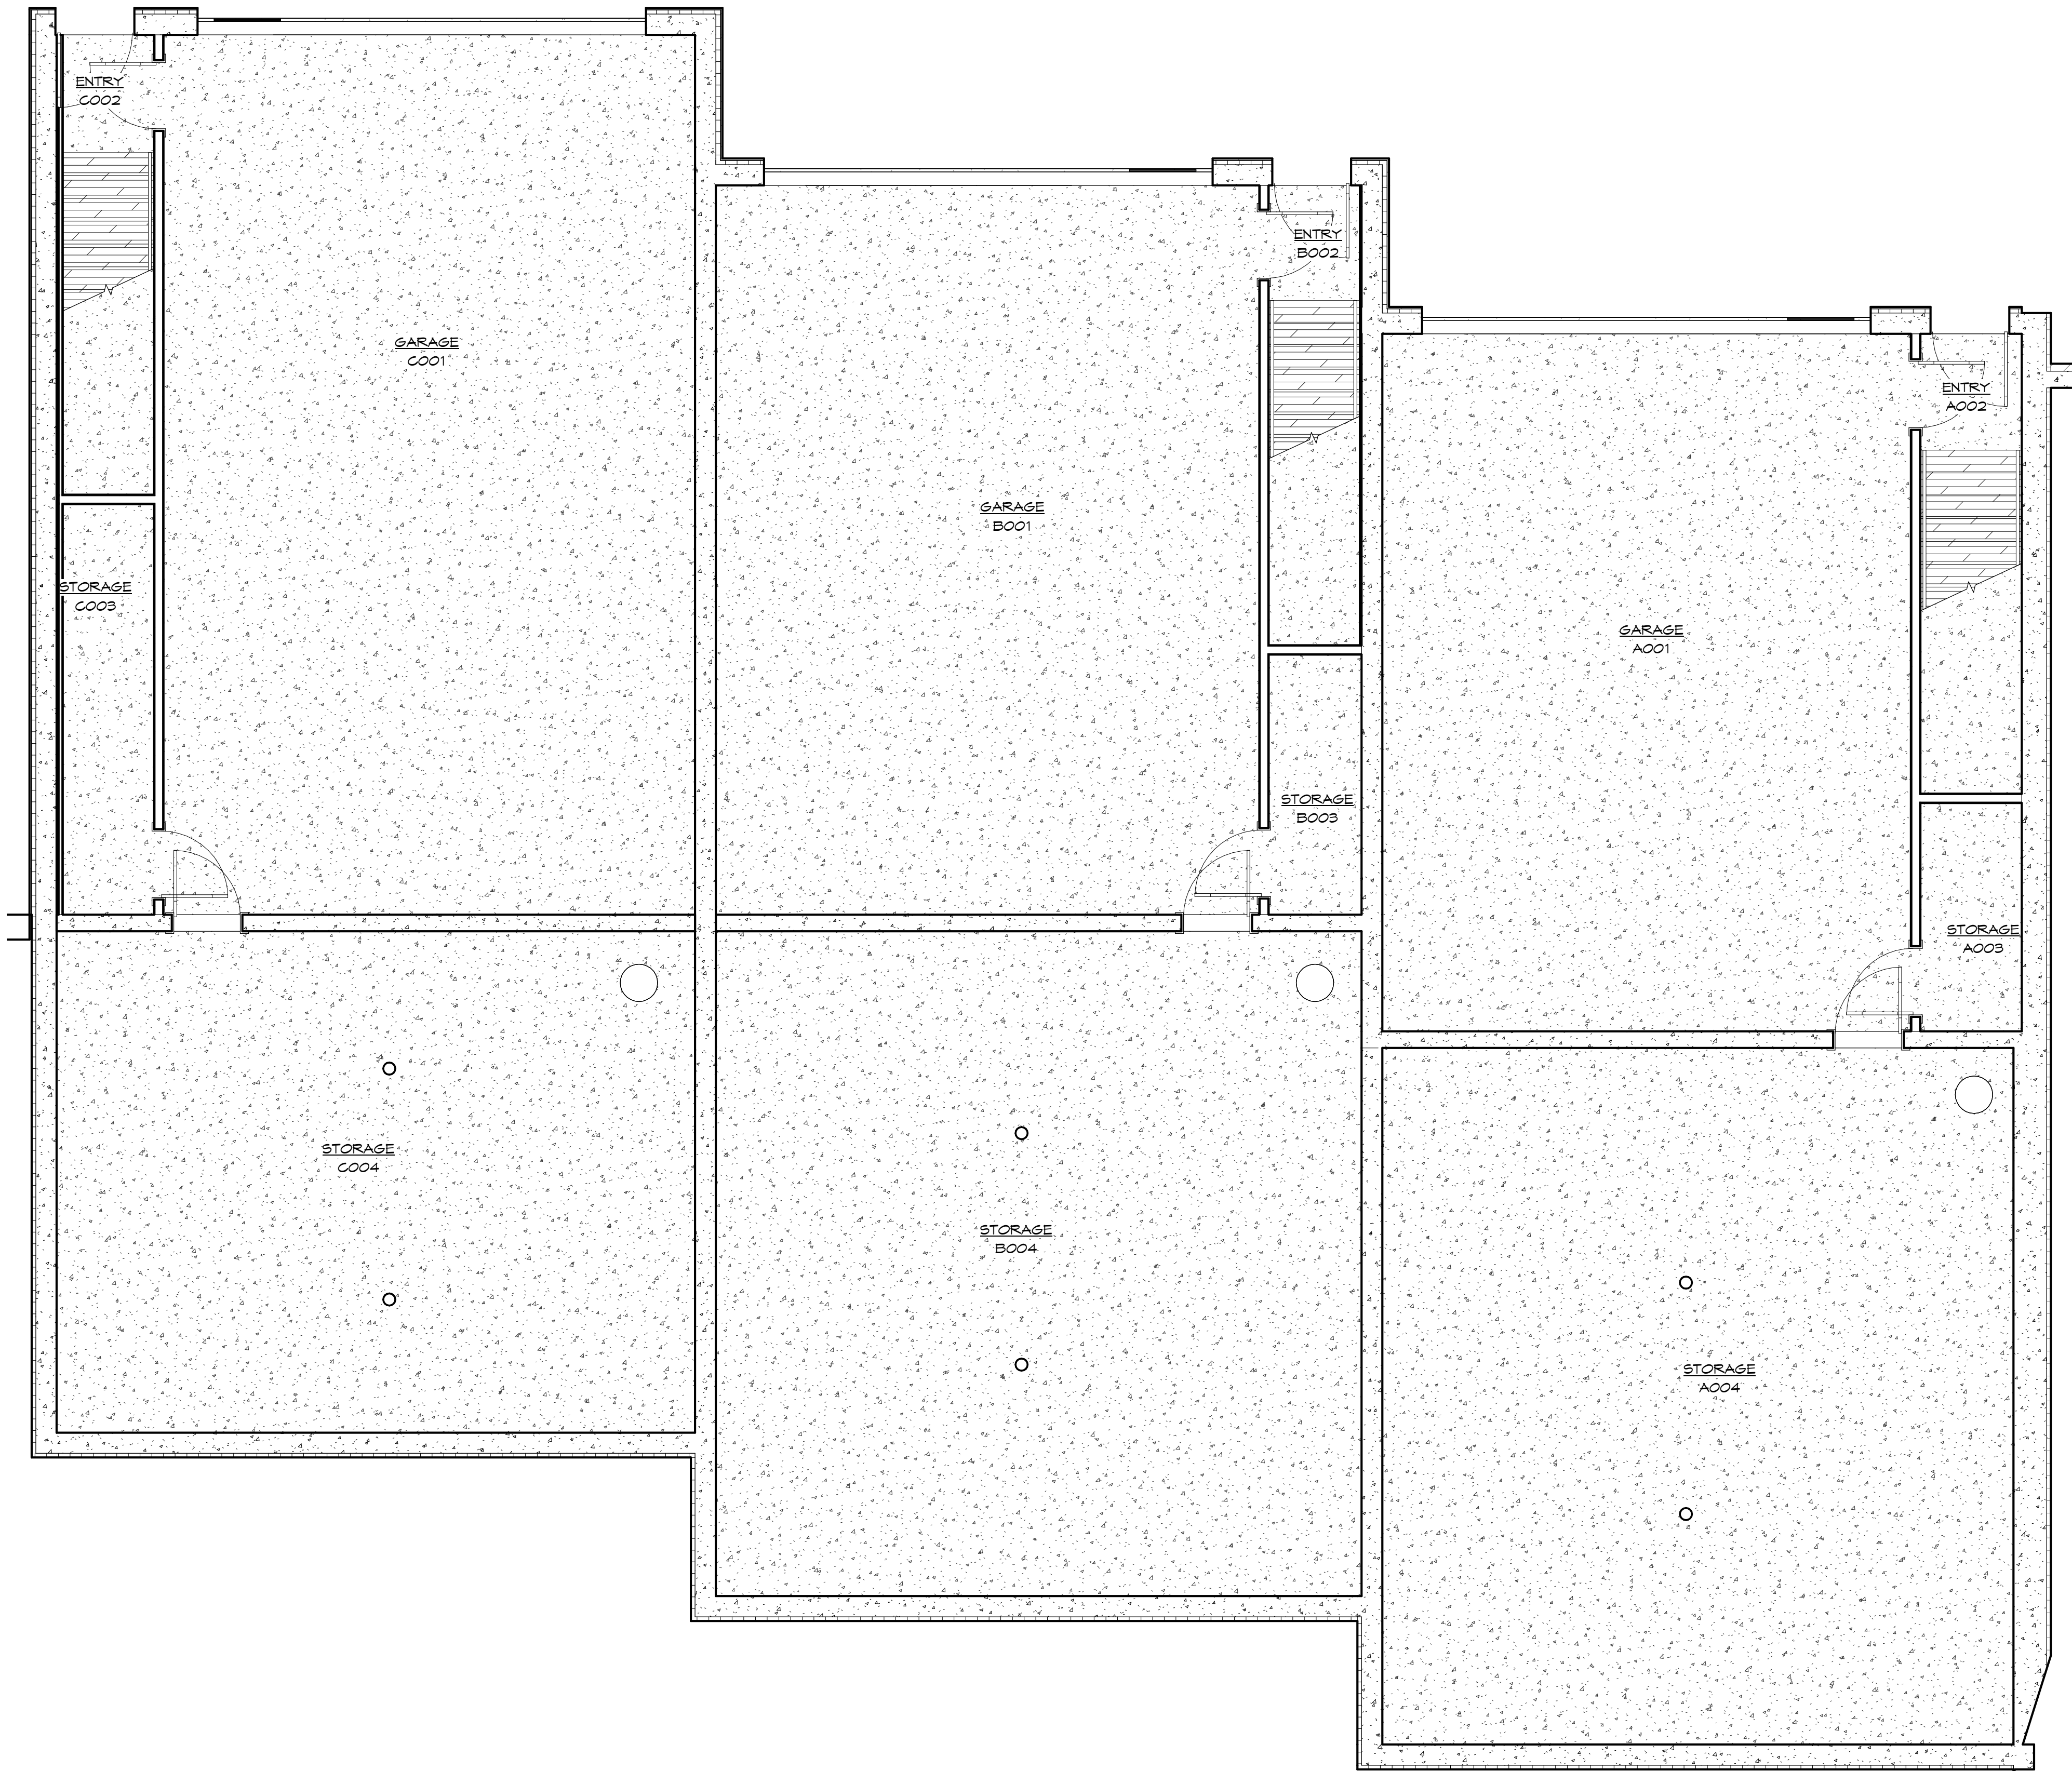

general finish notes

- ALL SHELVING TO HAVE BLOCKING IN WALL OR BRACKETS @3' O.C. MINIMUM U.N.O.

room finish schedule legend

FLOORS

- CPT1 CARPET 1
- CPT2 CARPET 2
- HWD HARDWOOD FLOORING
- LVT1 LUXURY VINYL TILE
- PT1 PORCELAIN TILE
- SC SEALED CONCRETE
- VP VAPOR RETARDER MEMBRANE

WALLS

- EC EXPOSED CONCRETE (TEXTURE OR PATTERN FINISH)
- GL GLASS
- P1 LATEX ENAMEL PAINT
- P2 EPOXY PAINT
- T1 TILE

BASE & TRIM

- WD1 4" WOOD TRIM
- RB1 4" TOP-SET RUBBER
- RB2 6" TOP-SET RUBBER
- RS RUBBER STRINGERS
- TB1 4" PORCELAIN TILE BASE
- WT WOOD TRIM

CEILING

- RE REFLECTED CEILING PLANS


\*FOR ANY CELL / FIELD IN THE SCHEDULE THAT IS EITHER LEFT **BLANK** OR THAT INCLUDES ONLY A **DASH**, THE ASSOCIATED FINISH FOR THAT COMPONENT IS TO MATCH THE FINISH NOTED AS **TYPICAL**.

finish floor plan legend

NOTE: FLOOR FINISH PATTERNS ARE SYMBOLIC OF MATERIAL. THE PATTERNS SHOWN DO NOT INDICATE DESIRED PATTERN OF ACTUAL FLOOR MATERIALS. REFER TO SPECIFICATIONS AND FLOOR FINISH DETAILS FOR ACTUAL PATTERNS.

REFER TO ENLARGED PLAN CALLOUTS FOR ANY INTERIOR ELEVATION MARKERS NOT SHOWN ON OVERALL FINISH PLANS

- HWD - HARDWOOD FLOORING
- LVT1 - LUXURY VINYL TILE
- PT1 - PORCELAIN TILE
- SC - SEALED CONCRETE
- WC - WATERPROOF DECK COATING

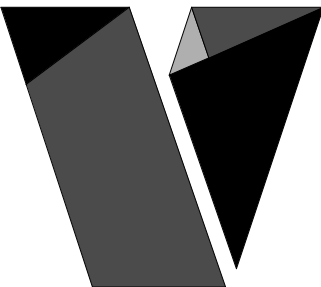

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FOR REVIEW

SHIRAZ TOWNHOMES

603, 605, & 607 W. 49th ST. KANSAS CITY, MO 64112

REVISIONS

No.	Description	Date
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sheet issue date:  
09.27.2024

project no.:  
20.32

sheet contents:  
FINISH FLOOR PLAN -  
GARAGE LEVEL

sheet no.:

A700





## general finish notes

- ALL SHELVING TO HAVE BLOCKING IN WALL OR BRACKETS @3' O.C. MINIMUM U.N.O.

## room finish schedule legend

FLOORS	
CPT1	CARPET 1
CPT2	CARPET 2
HWD	HARDWOOD FLOORING
LVT1	LUXURY VINYL TILE
PT1	PORCELAIN TILE
SC	SEALED CONCRETE
VP	VAPOR RETARDER MEMBRANE

WALLS	
EC	EXPOSED CONCRETE (TEXTURE OR PATTERN FINISH)
GL	GLASS
P1	LATEX ENAMEL PAINT
P2	EPOXY PAINT
T1	TILE

BASE & TRIM	
WD1	4" WOOD TRIM
RB1	4" TOP-SET RUBBER
RB2	6" TOP-SET RUBBER
RS	RUBBER STRINGERS
TB1	4" PORCELAIN TILE BASE
WT	WOOD TRIM

CEILINGS	
RE	REFLECTED CEILING PLANS


\*FOR ANY CELL / FIELD IN THE SCHEDULE THAT IS EITHER LEFT BLANK OR THAT INCLUDES ONLY A DASH, THE ASSOCIATED FINISH FOR THAT COMPONENT IS TO MATCH THE FINISH NOTED AS TYPICAL.

## finish floor plan legend

NOTE: FLOOR FINISH PATTERNS ARE SYMBOLIC OF MATERIAL. THE PATTERNS SHOWN DO NOT INDICATE DESIRED PATTERN OF ACTUAL FLOOR MATERIALS. REFER TO SPECIFICATIONS AND FLOOR FINISH DETAILS FOR ACTUAL PATTERNS.

REFER TO ENLARGED PLAN CALLOUTS FOR ANY INTERIOR ELEVATION MARKERS NOT SHOWN ON OVERALL FINISH PLANS

	HWD - HARDWOOD FLOORING
	LVT1 - LUXURY VINYL TILE
	PT1 - PORCELAIN TILE
	SC - SEALED CONCRETE
	WC - WATERPROOF DECK COATING

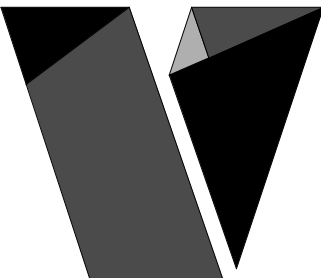

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REVISIONS		
No.	Description	Date

sheet issue date:  
09.27.2024

project no.:  
20.32

sheet contents:  
FINISH FLOOR PLAN -  
MAIN LEVEL

sheet no.:

A701





1 architectural finish plan - second level  
1/4" = 1'-0"

### general finish notes

- ALL SHELVING TO HAVE BLOCKING IN WALL OR BRACKETS @3' O.C. MINIMUM U.N.O.

### room finish schedule legend

#### FLOORS

- CPT1 CARPET 1  
CPT2 CARPET 2  
HND HARDWOOD FLOORING  
LVT1 LUXURY VINYL TILE  
PT1 PORCELAIN TILE  
SC SEALED CONCRETE  
VP VAPOR RETARDER MEMBRANE

#### WALLS

- EC EXPOSED CONCRETE (TEXTURE OR PATTERN FINISH)  
GL GLASS  
P1 LATEX ENAMEL PAINT  
P2 EPOXY PAINT  
T1 TILE

#### BASE & TRIM

- WD1 4" WOOD TRIM  
RB1 4" TOP-SET RUBBER  
RB2 6" TOP-SET RUBBER  
RS RUBBER STRINGERS  
TB1 4" PORCELAIN TILE BASE  
WT WOOD TRIM

#### CEILINGS

- RE REFLECTED CEILING PLANS


\*FOR ANY CELL / FIELD IN THE SCHEDULE THAT IS EITHER LEFT BLANK OR THAT INCLUDES ONLY A DASH, THE ASSOCIATED FINISH FOR THAT COMPONENT IS TO MATCH THE FINISH NOTED AS TYPICAL.

### finish floor plan legend

NOTE: FLOOR FINISH PATTERNS ARE SYMBOLIC OF MATERIAL. THE PATTERNS SHOWN DO NOT INDICATE DESIRED PATTERN OF ACTUAL FLOOR MATERIALS. REFER TO SPECIFICATIONS AND FLOOR FINISH DETAILS FOR ACTUAL PATTERNS.

REFER TO ENLARGED PLAN CALLOUTS FOR ANY INTERIOR ELEVATION MARKERS NOT SHOWN ON OVERALL FINISH PLANS

- HND - HARDWOOD FLOORING  
LVT1 - LUXURY VINYL TILE  
PT1 - PORCELAIN TILE  
SC - SEALED CONCRETE  
WC - WATERPROOF DECK COATINGS

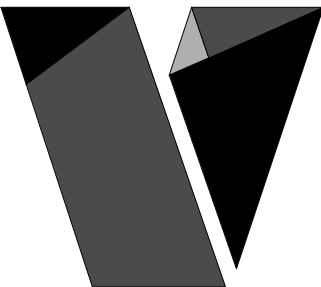

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REVISIONS  
No. Description Date

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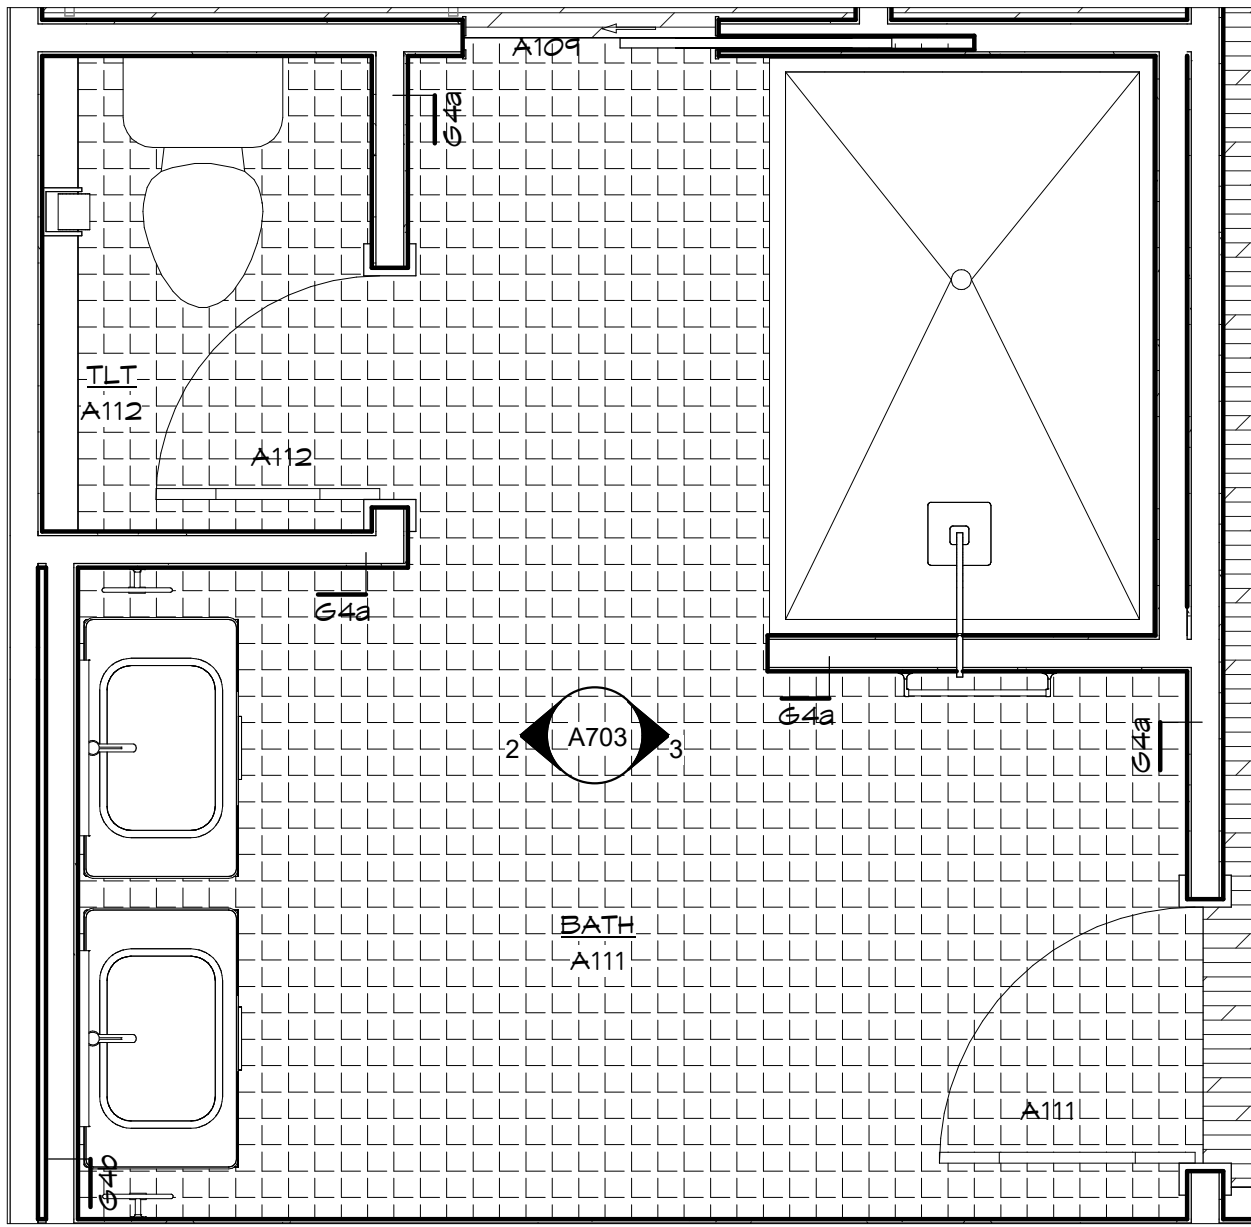
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20.32

sheet contents:  
FINISH FLOOR PLAN -  
UPPER LEVEL


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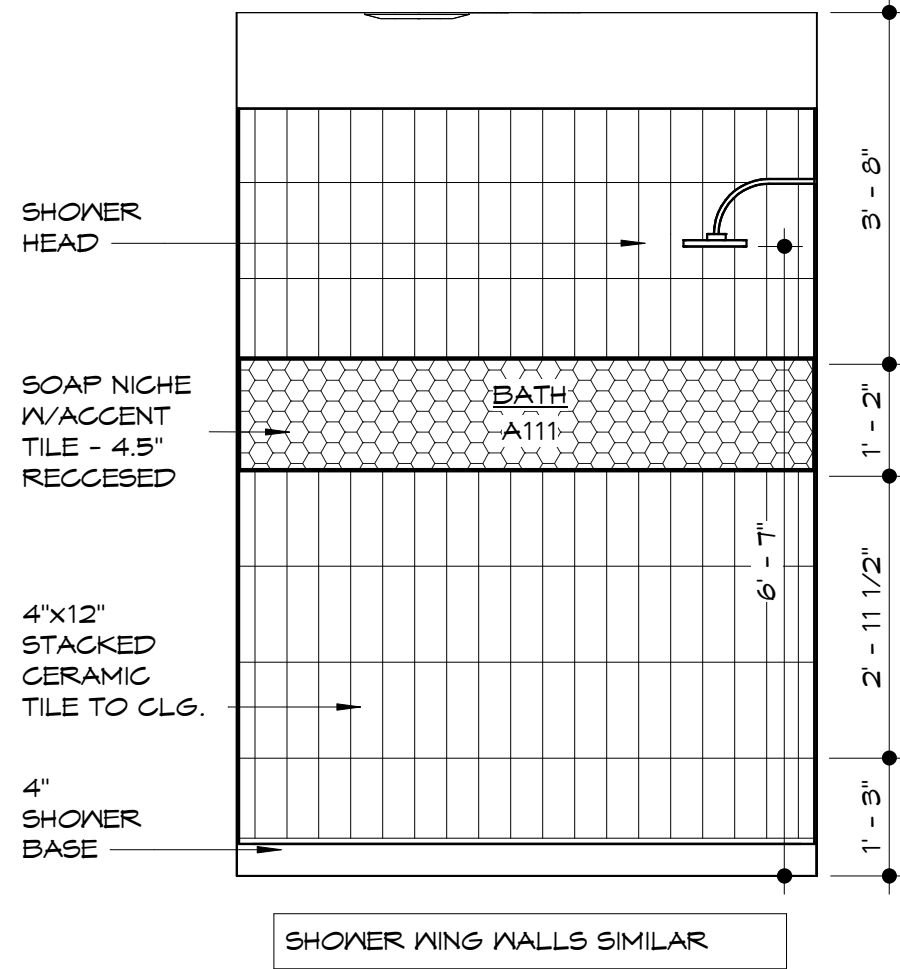





1 enlarged plan - main level bath  
1/2" = 1'-0"




2 main level bath - vanity elevation  
1/2" = 1'-0"

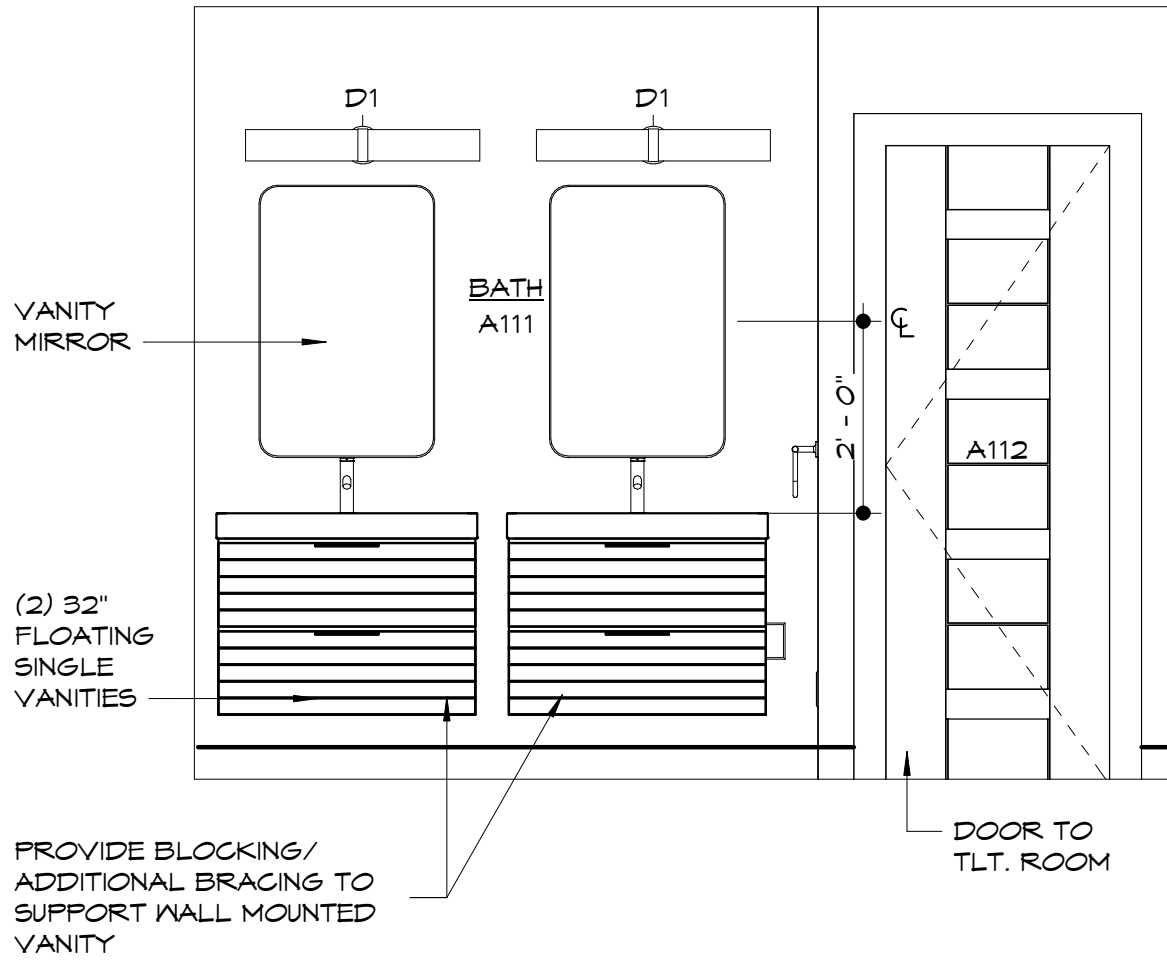


3 main level bath - shower elevation  
1/2" = 1'-0"

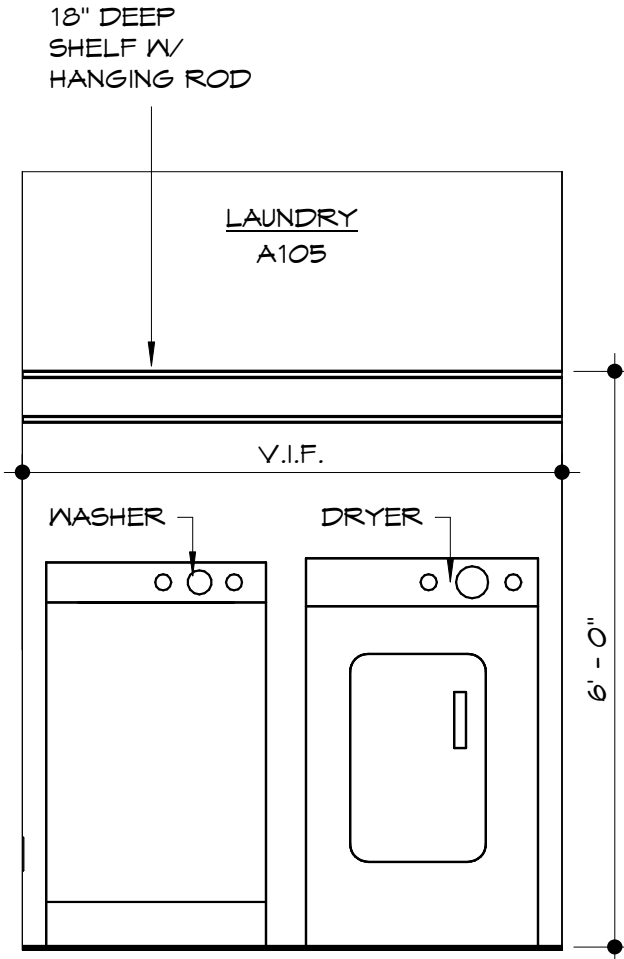


4 laundry elevation  
1/2" = 1'-0"

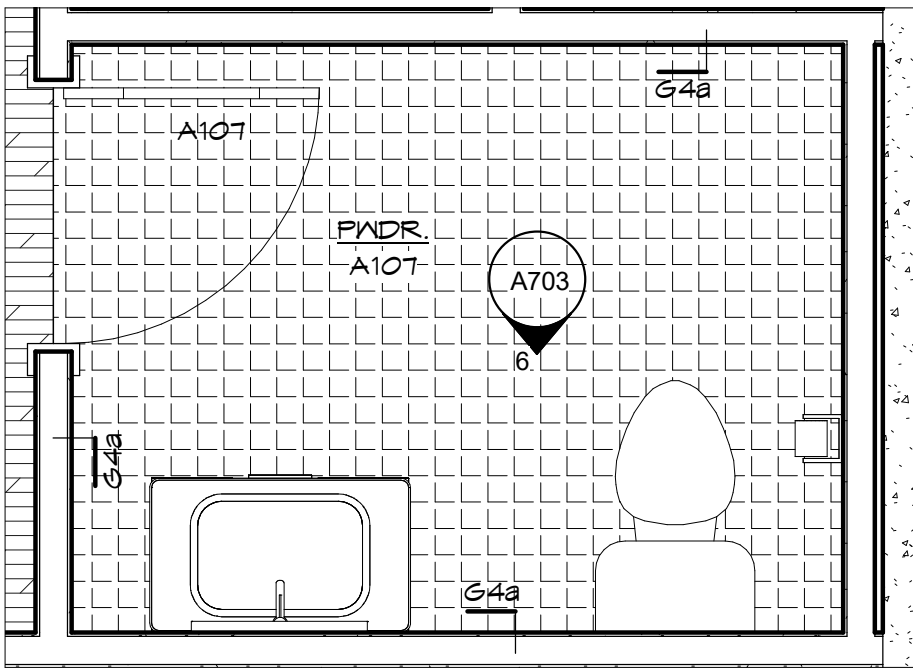


5 enlarged plan- powder  
1/2" = 1'-0"

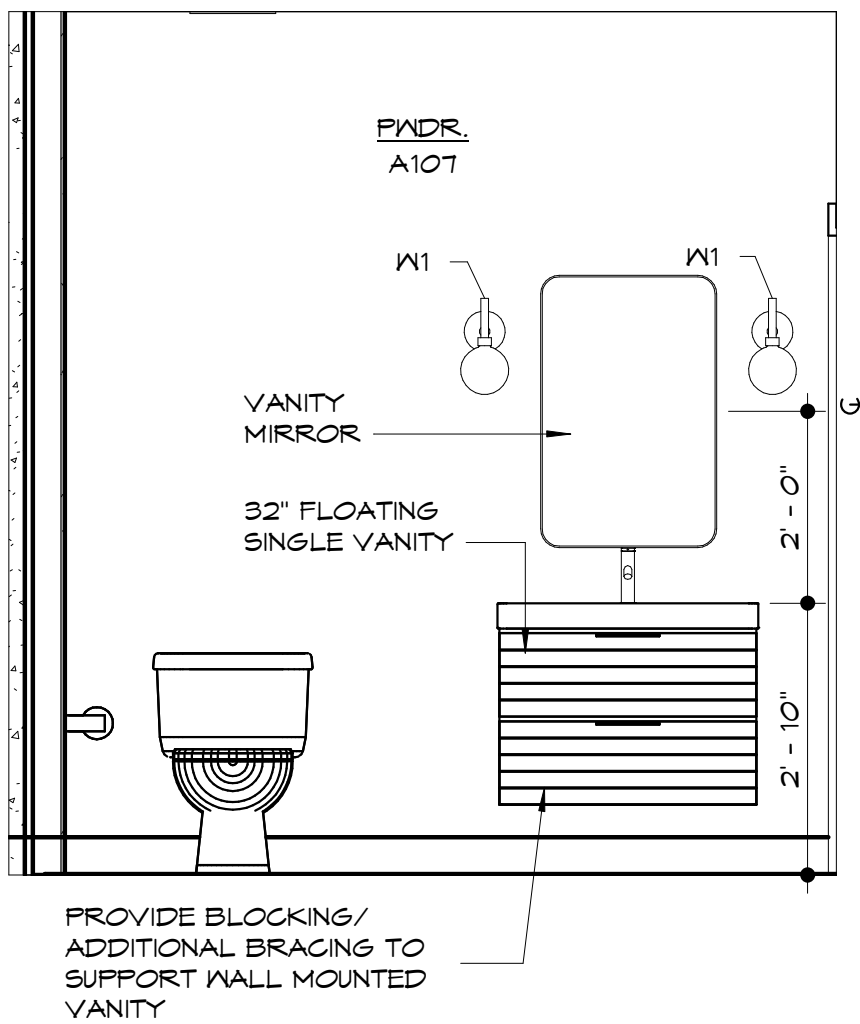


6 powder elevation  
1/2" = 1'-0"

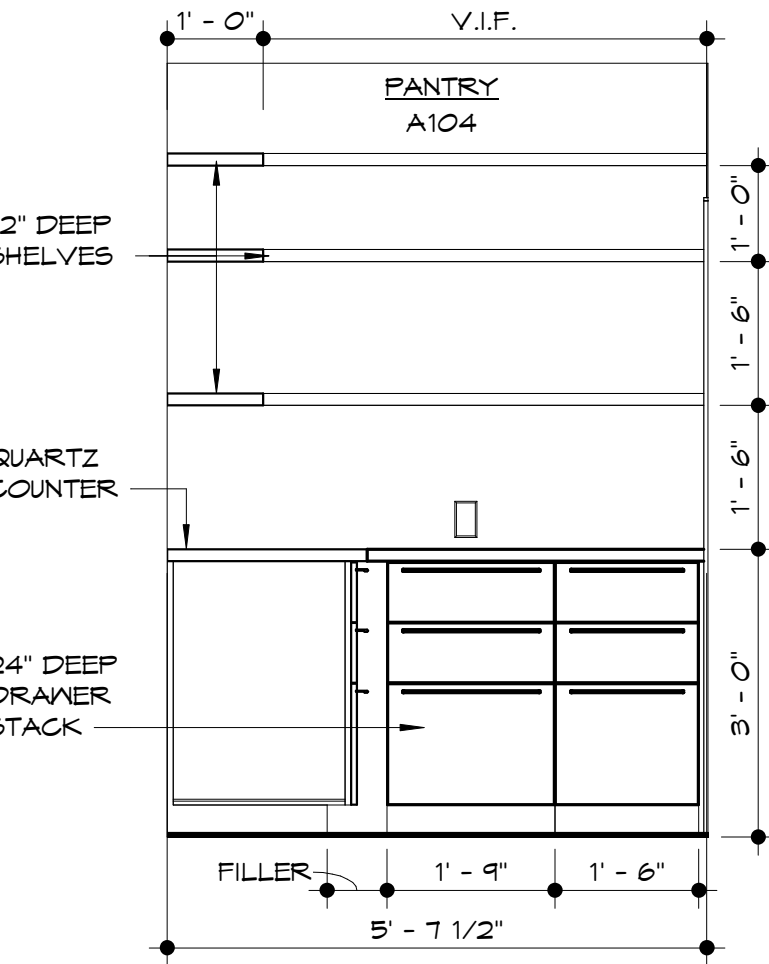


7 pantry - side elevation  
1/2" = 1'-0"

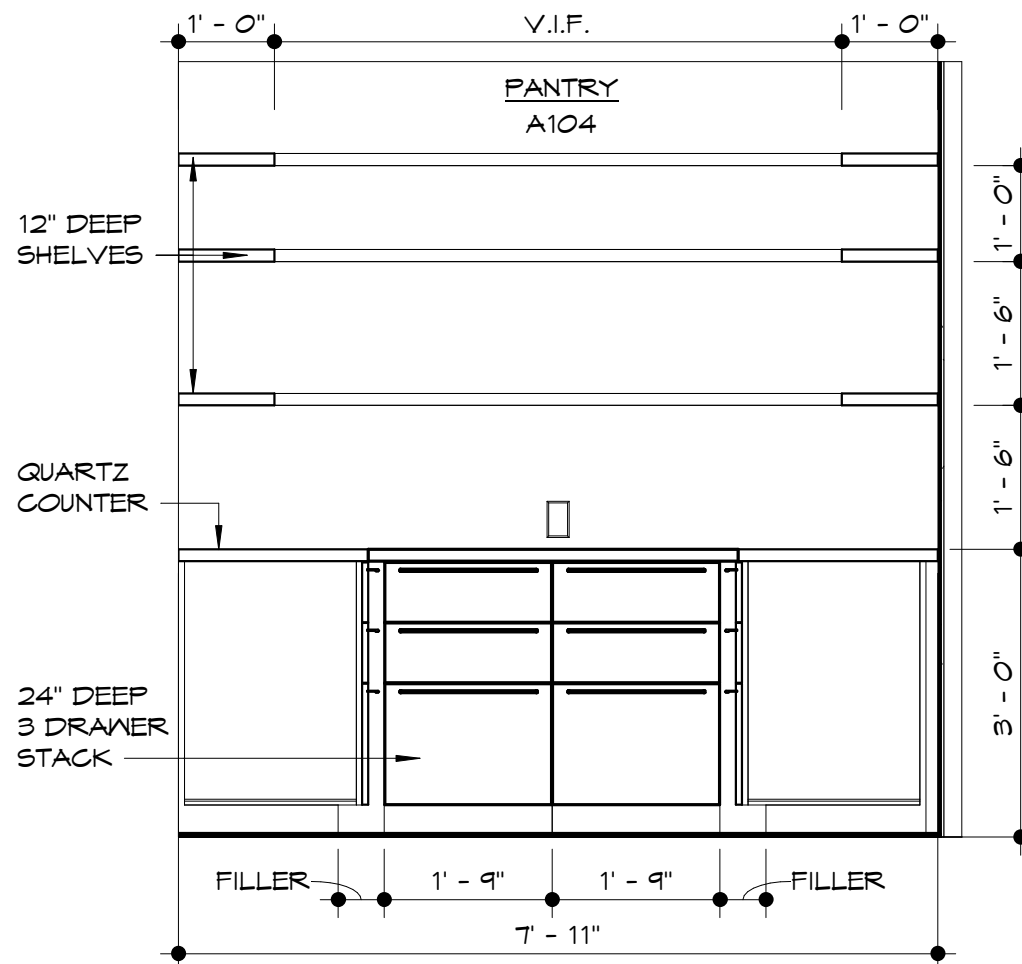


8 pantry - rear elevation  
1/2" = 1'-0"

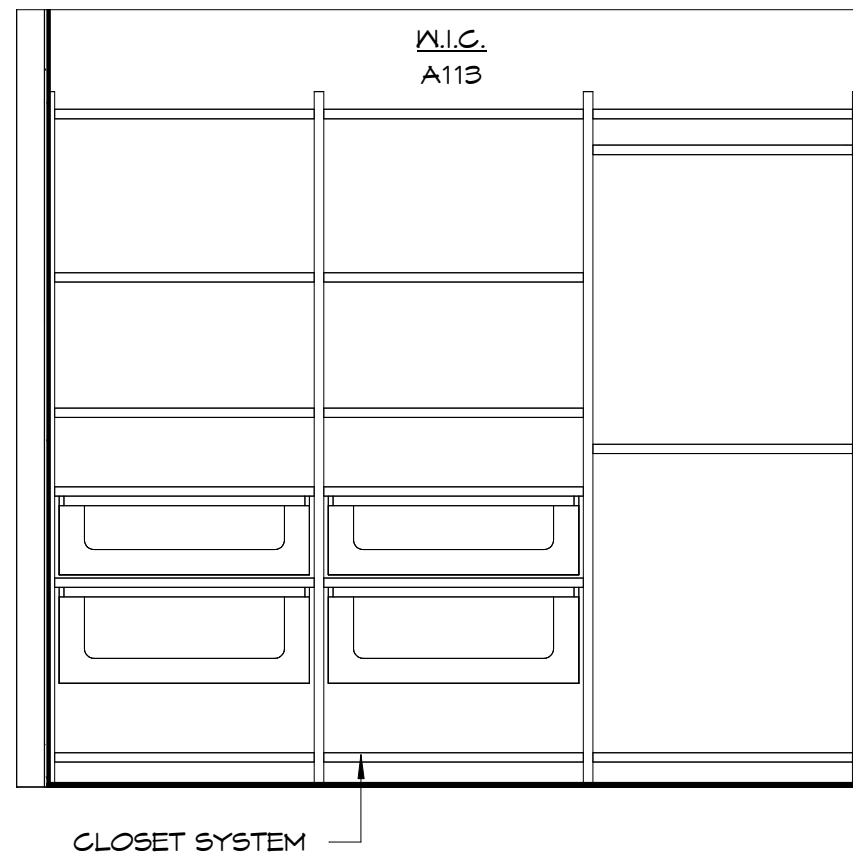


9 closet elevation  
1/2" = 1'-0"

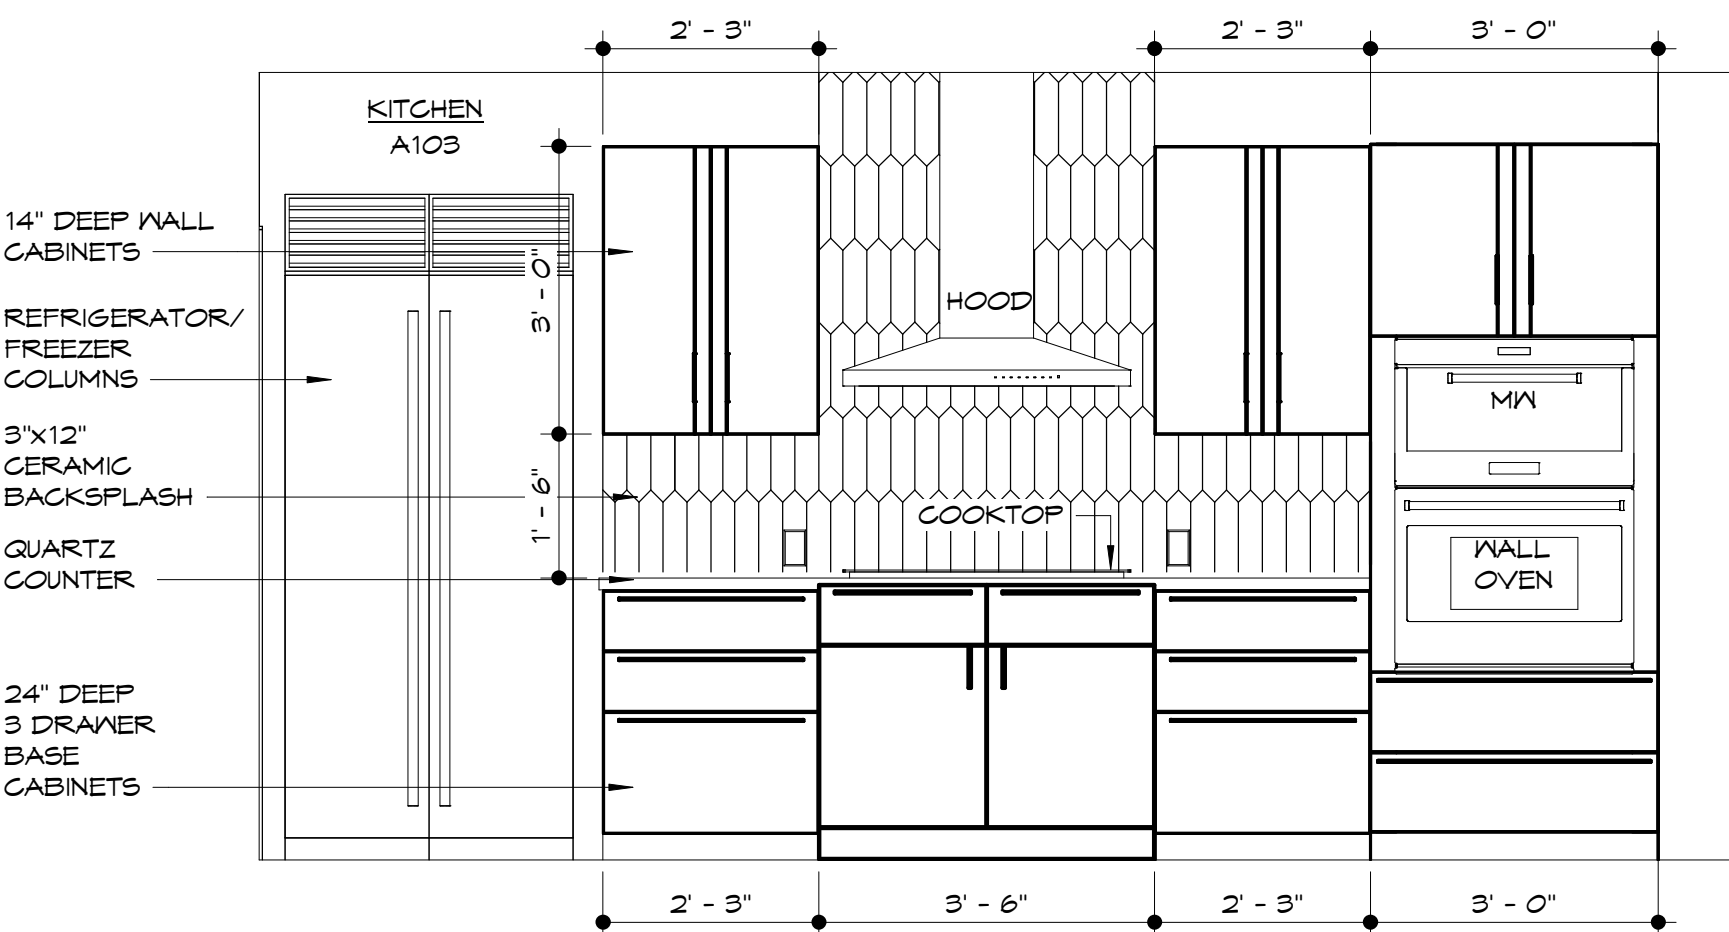


10 kitchen elevation  
1/2" = 1'-0"

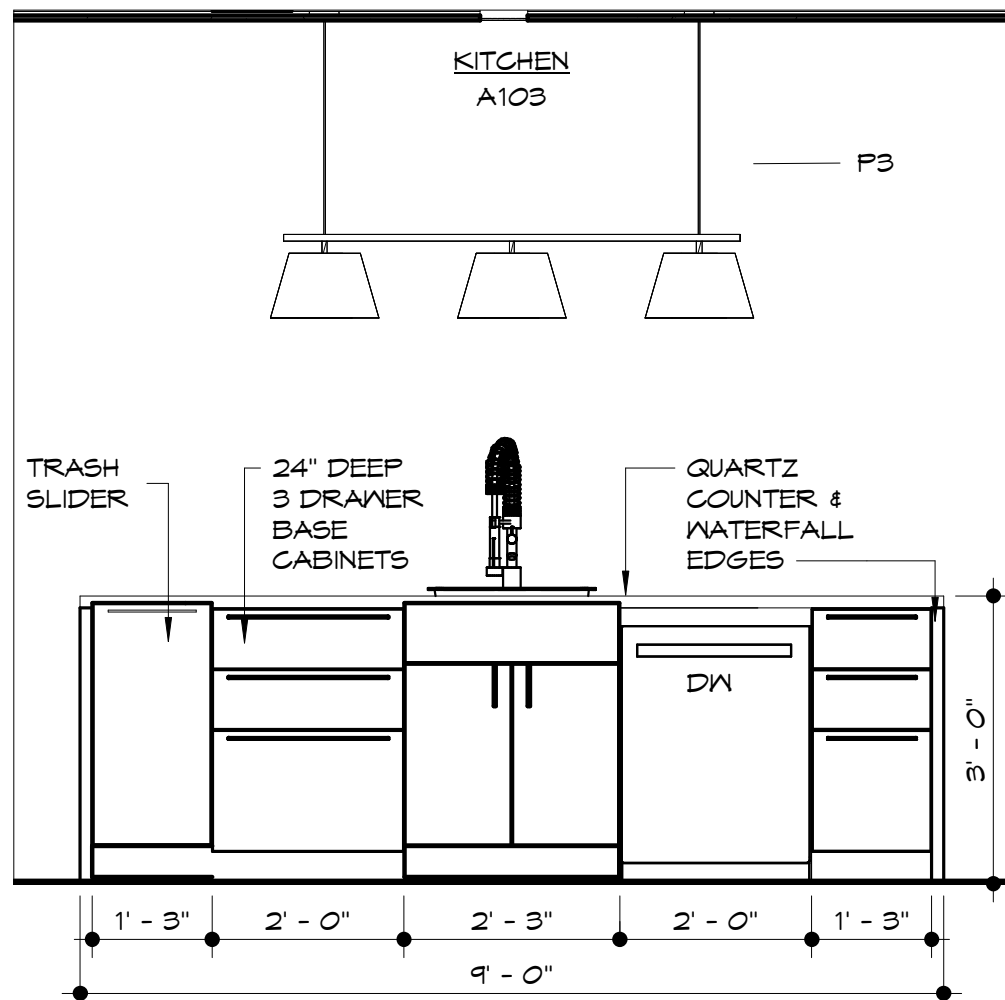

11 kitchen island - interior side elevation  
1/2" = 1'-0"

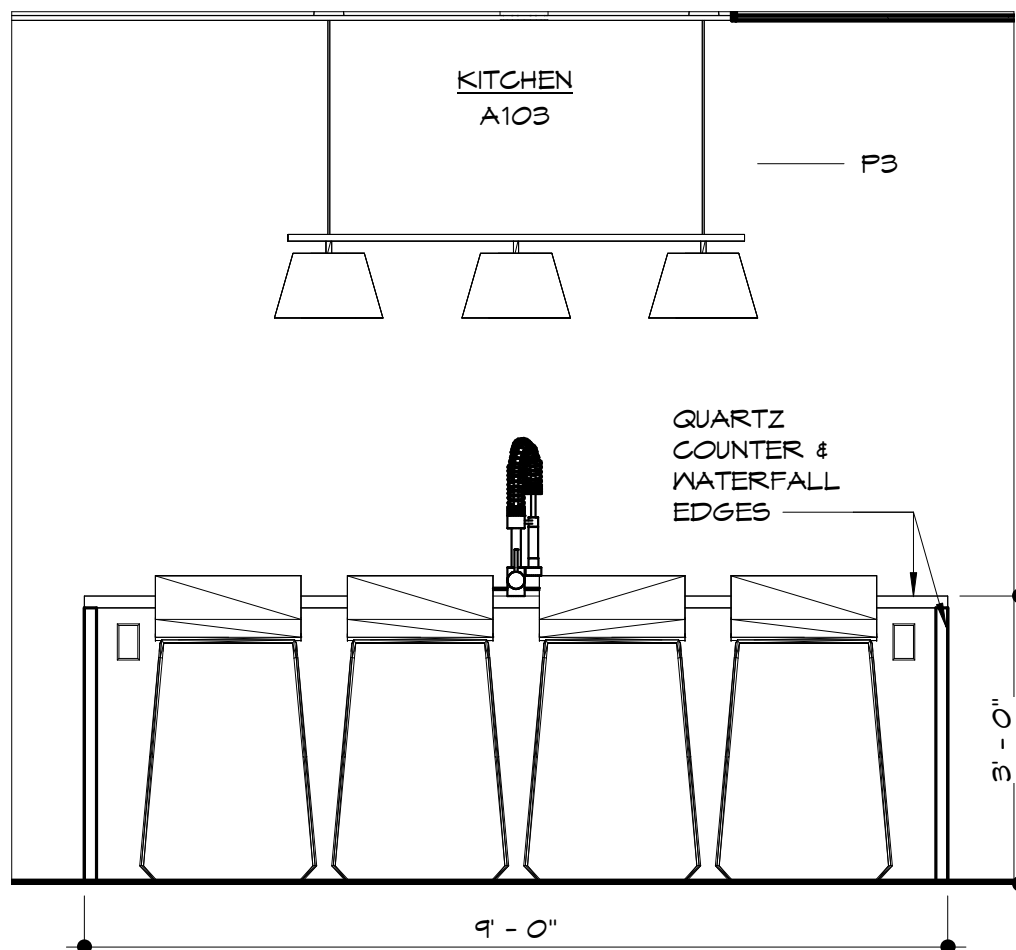

12 kitchen island - exterior side elevation  
1/2" = 1'-0"

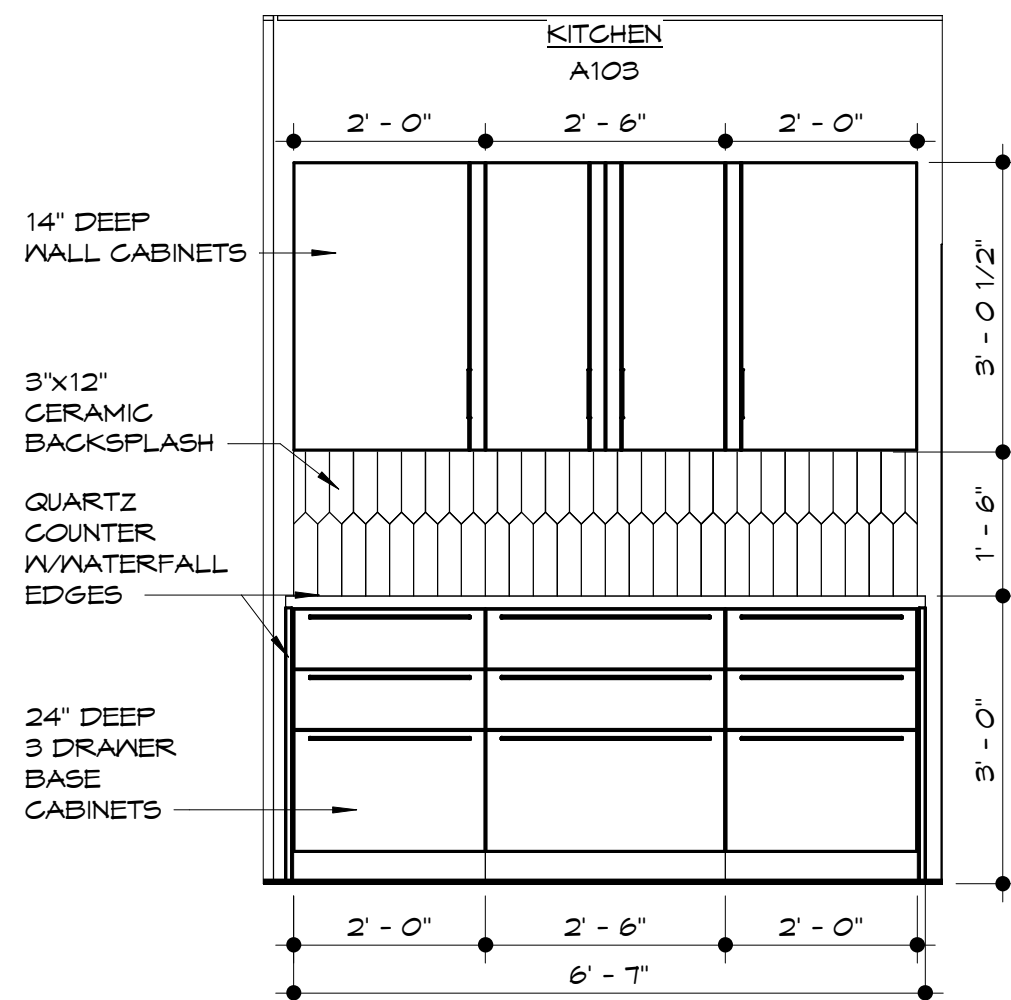

13 kitchen storage elevation  
1/2" = 1'-0"

## general finish notes

- ALL SHELVING TO HAVE BLOCKING IN WALL OR BRACKETS @ 3' O.C. MINIMUM U.N.O.

## room finish schedule legend

### FLOORS

- CPT1 CARPET 1
- CPT2 CARPET 2
- HWD HARDWOOD FLOORING
- LVT1 LUXURY VINYL TILE
- PT1 PORCELAIN TILE
- SC SEALED CONCRETE
- VP VAPOR RETARDER MEMBRANE

### WALLS

- EC EXPOSED CONCRETE (TEXTURE OR PATTERN FINISH)
- GL GLASS
- P1 LATEX ENAMEL PAINT
- P2 EPOXY PAINT
- T1 TILE

### BASE & TRIM

- WD1 4" WOOD TRIM
- RB1 4" TOP-SET RUBBER
- RB2 6" TOP-SET RUBBER
- RS RUBBER STRINGERS
- TB1 4" PORCELAIN TILE BASE
- WT WOOD TRIM

### CEILINGS

- RE REFLECTED CEILING PLANS

\*FOR ANY CELL / FIELD IN THE SCHEDULE THAT IS EITHER LEFT BLANK OR THAT INCLUDES ONLY A DASH, THE ASSOCIATED FINISH FOR THAT COMPONENT IS TO MATCH THE FINISH NOTED AS TYPICAL.

## finish floor plan legend


NOTE: FLOOR FINISH PATTERNS ARE SYMBOLIC OF MATERIAL. THE PATTERNS SHOWN DO NOT INDICATE DESIRED PATTERN OF ACTUAL FLOOR MATERIALS. REFER TO SPECIFICATIONS AND FLOOR FINISH DETAILS FOR ACTUAL PATTERNS.

REFER TO ENLARGED PLAN CALLOUTS FOR ANY INTERIOR ELEVATION MARKERS NOT SHOWN ON OVERALL FINISH PLANS


- HWD - HARDWOOD FLOORING
- LVT1 - LUXURY VINYL TILE
- PT1 - PORCELAIN TILE
- SC - SEALED CONCRETE
- WC - WATERPROOF DECK COATING



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1 main level - living / entry elevation  
1/2" = 1'-0"

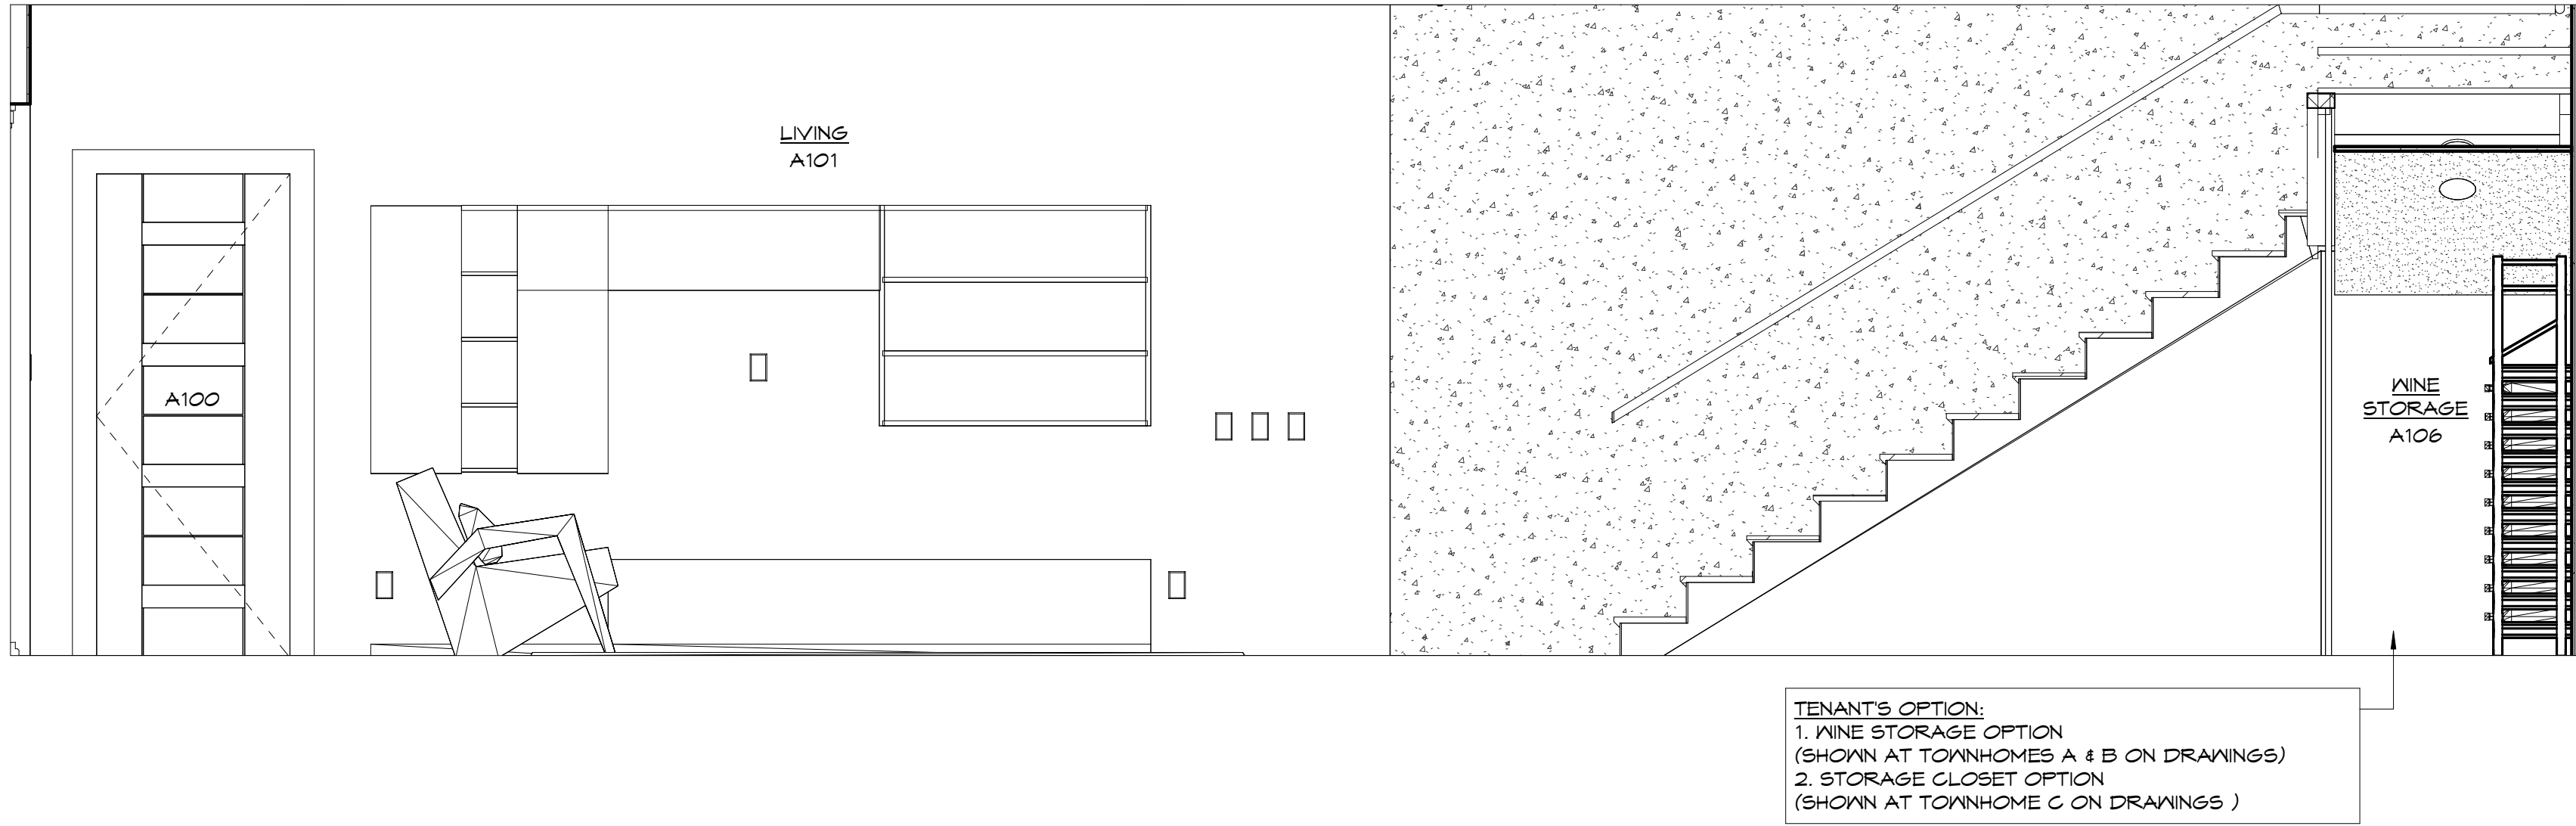

2 wine storage  
1/2" = 1'-0"

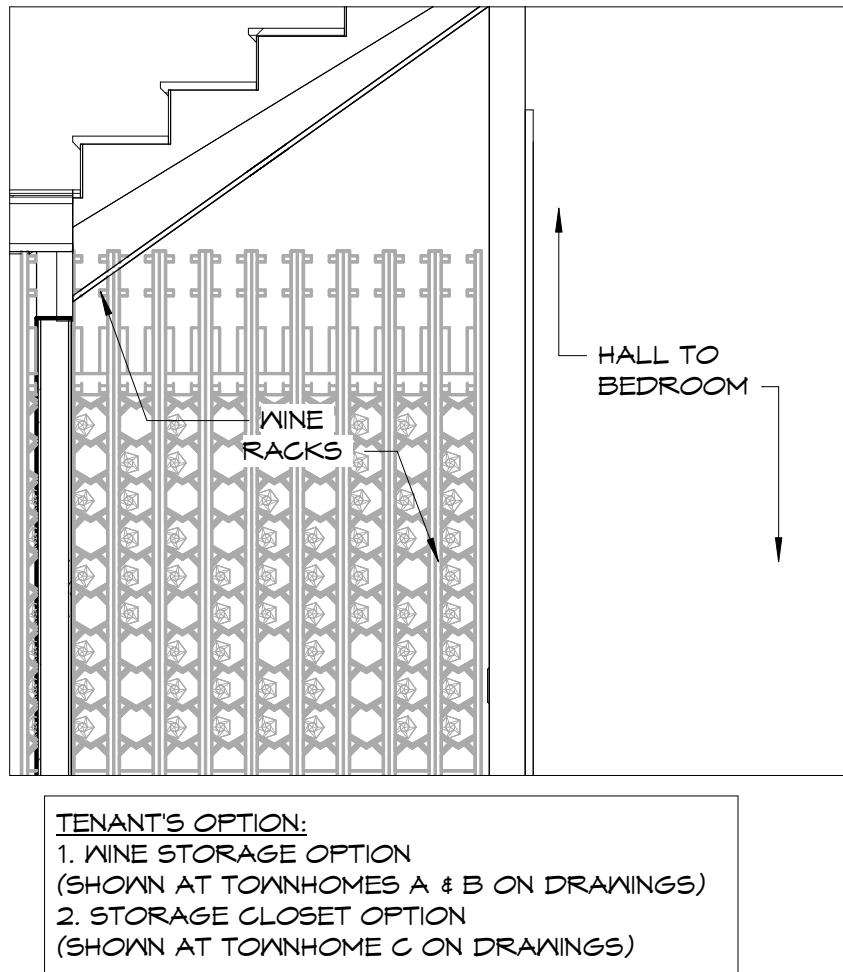general finish notes

1. ALL SHELVING TO HAVE BLOCKING IN WALL OR BRACKETS @3' O.C. MINIMUM U.N.O.

room finish schedule legend

FLOORS	
CPT1	CARPET 1
CPT2	CARPET 2
HWD	HARDWOOD FLOORING
LVT1	LUXURY VINYL TILE
PT1	PORCELAIN TILE
SC	SEALED CONCRETE
VP	VAPOR RETARDER MEMBRANE

WALLS	
EC	EXPOSED CONCRETE (TEXTURE OR PATTERN FINISH)
GL	GLASS
P1	LATEX ENAMEL PAINT
P2	EPOXY PAINT
T1	TILE

BASE & TRIM	
WD1	4" WOOD TRIM
RB1	4" TOP-SET RUBBER
RB2	6" TOP-SET RUBBER
RS	RUBBER STRINGERS
TB1	4" PORCELAIN TILE BASE
WT	WOOD TRIM

CEILINGS	
RE	REFLECTED CEILING PLANS


\*FOR ANY CELL / FIELD IN THE SCHEDULE THAT IS EITHER LEFT BLANK OR THAT INCLUDES ONLY A DASH, THE ASSOCIATED FINISH FOR THAT COMPONENT IS TO MATCH THE FINISH NOTED AS TYPICAL.

finish floor plan legend


NOTE: FLOOR FINISH PATTERNS ARE SYMBOLIC OF MATERIAL. THE PATTERNS SHOWN DO NOT INDICATE DESIRED PATTERN OF ACTUAL FLOOR MATERIALS. REFER TO SPECIFICATIONS AND FLOOR FINISH DETAILS FOR ACTUAL PATTERNS.

REFER TO ENLARGED PLAN CALLOUTS FOR ANY INTERIOR ELEVATION MARKERS NOT SHOWN ON OVERALL FINISH PLANS


	HWD - HARDWOOD FLOORING
	LVT1 - LUXURY VINYL TILE
	PT1 - PORCELAIN TILE
	SC - SEALED CONCRETE
	WC - WATERPROOF DECK COATING

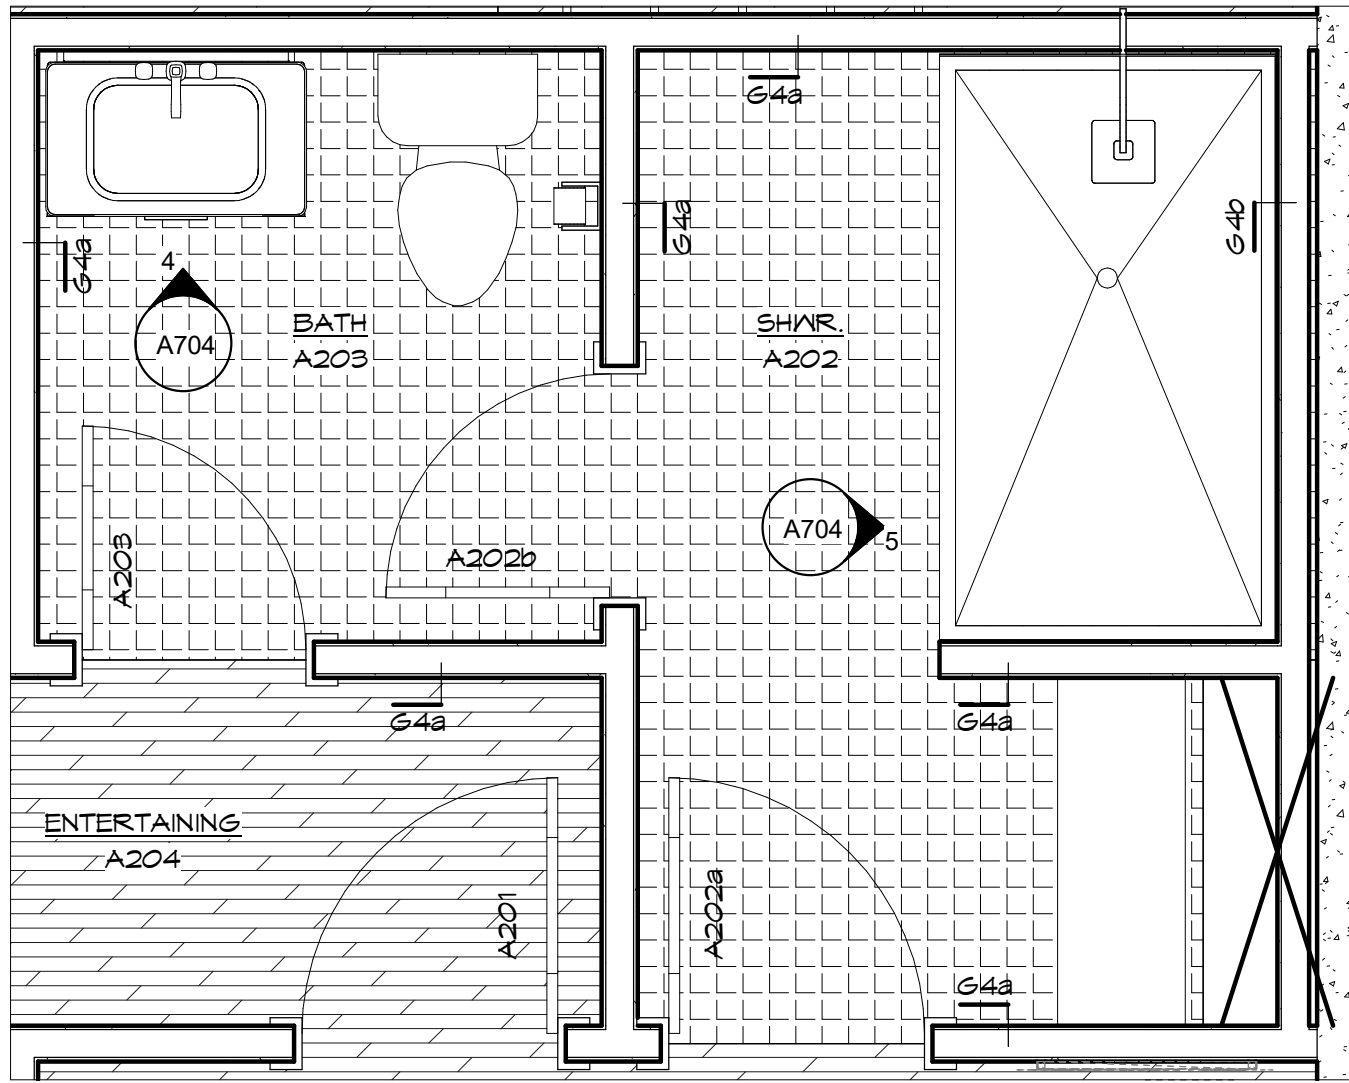


3 enlarged plan - second level - bath  
1/2" = 1'-0"

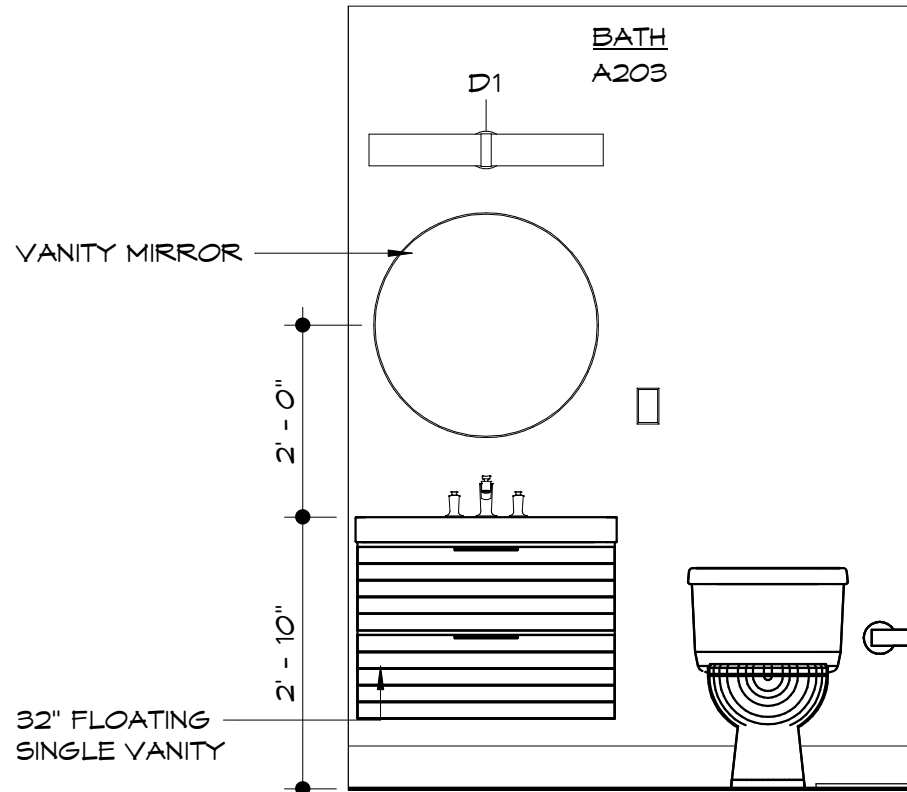


4 second level bath - vanity elevation  
1/2" = 1'-0"

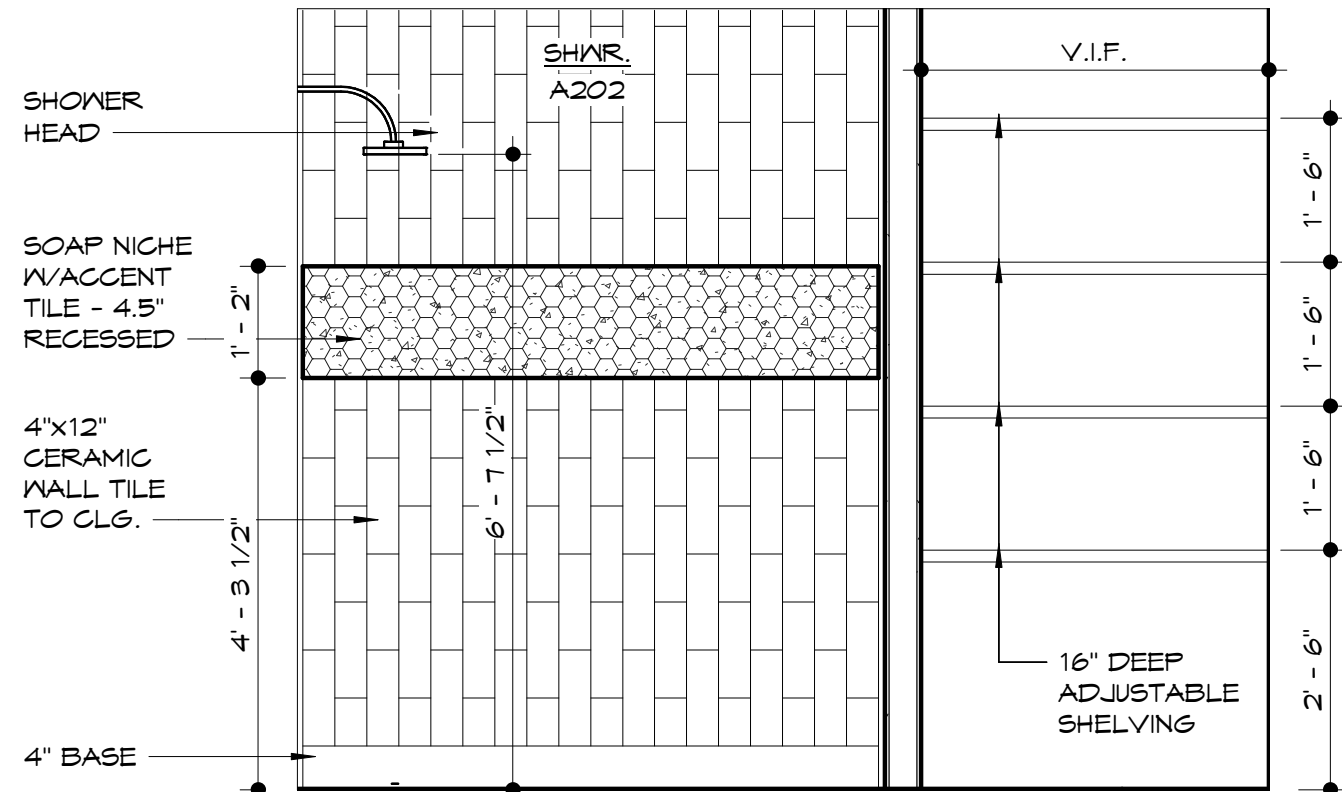

5 second level shower elevation  
1/2" = 1'-0"

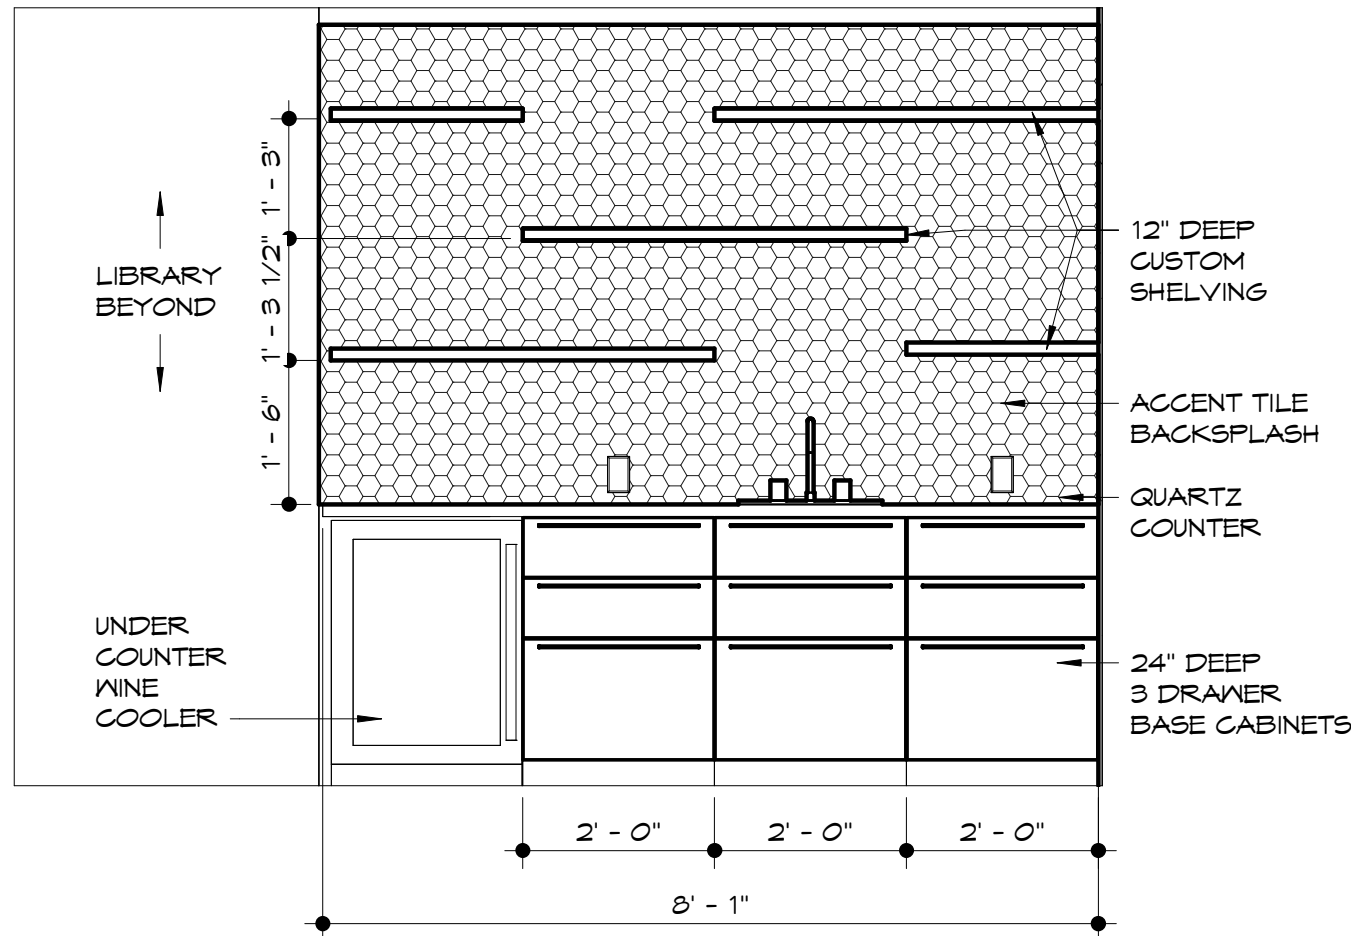


6 entertaining elevation  
1/2" = 1'-0"

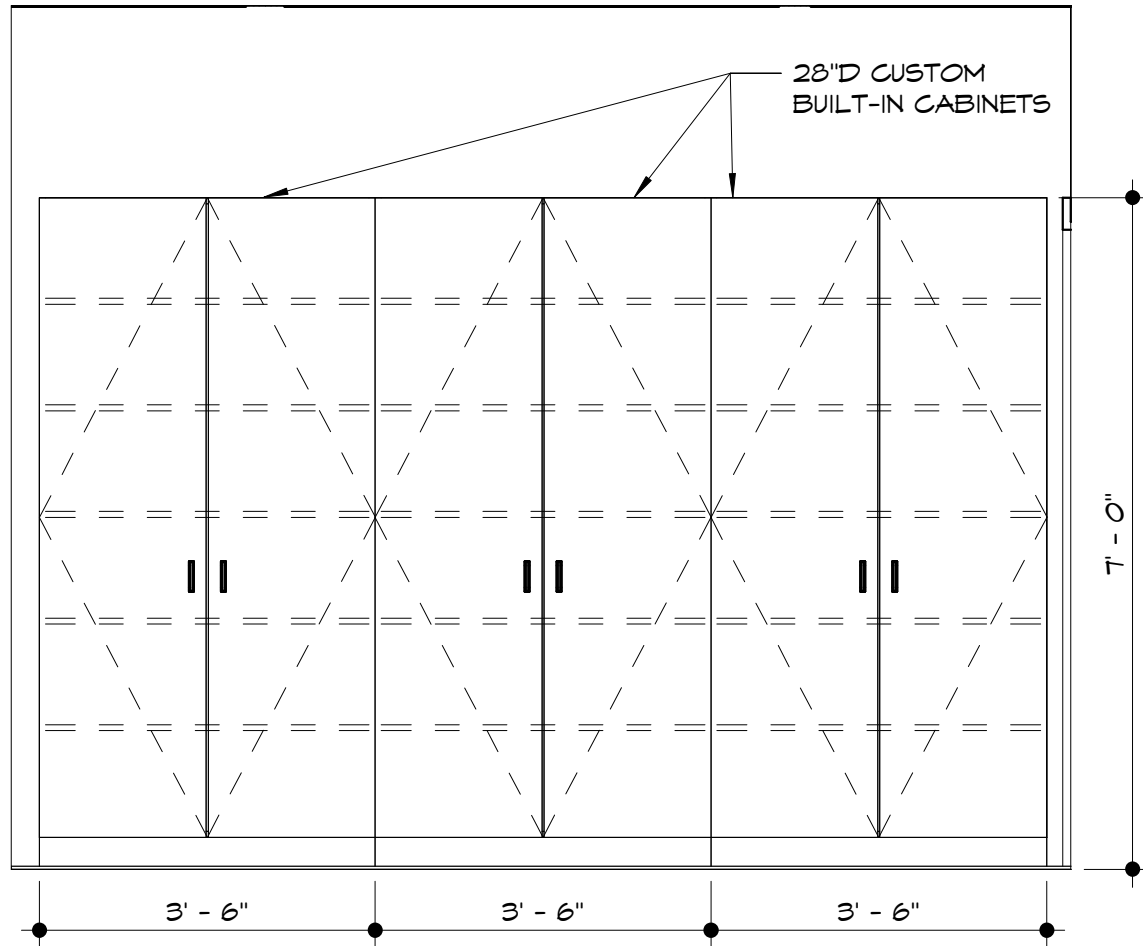


7 second level bedroom elevation  
1/2" = 1'-0"




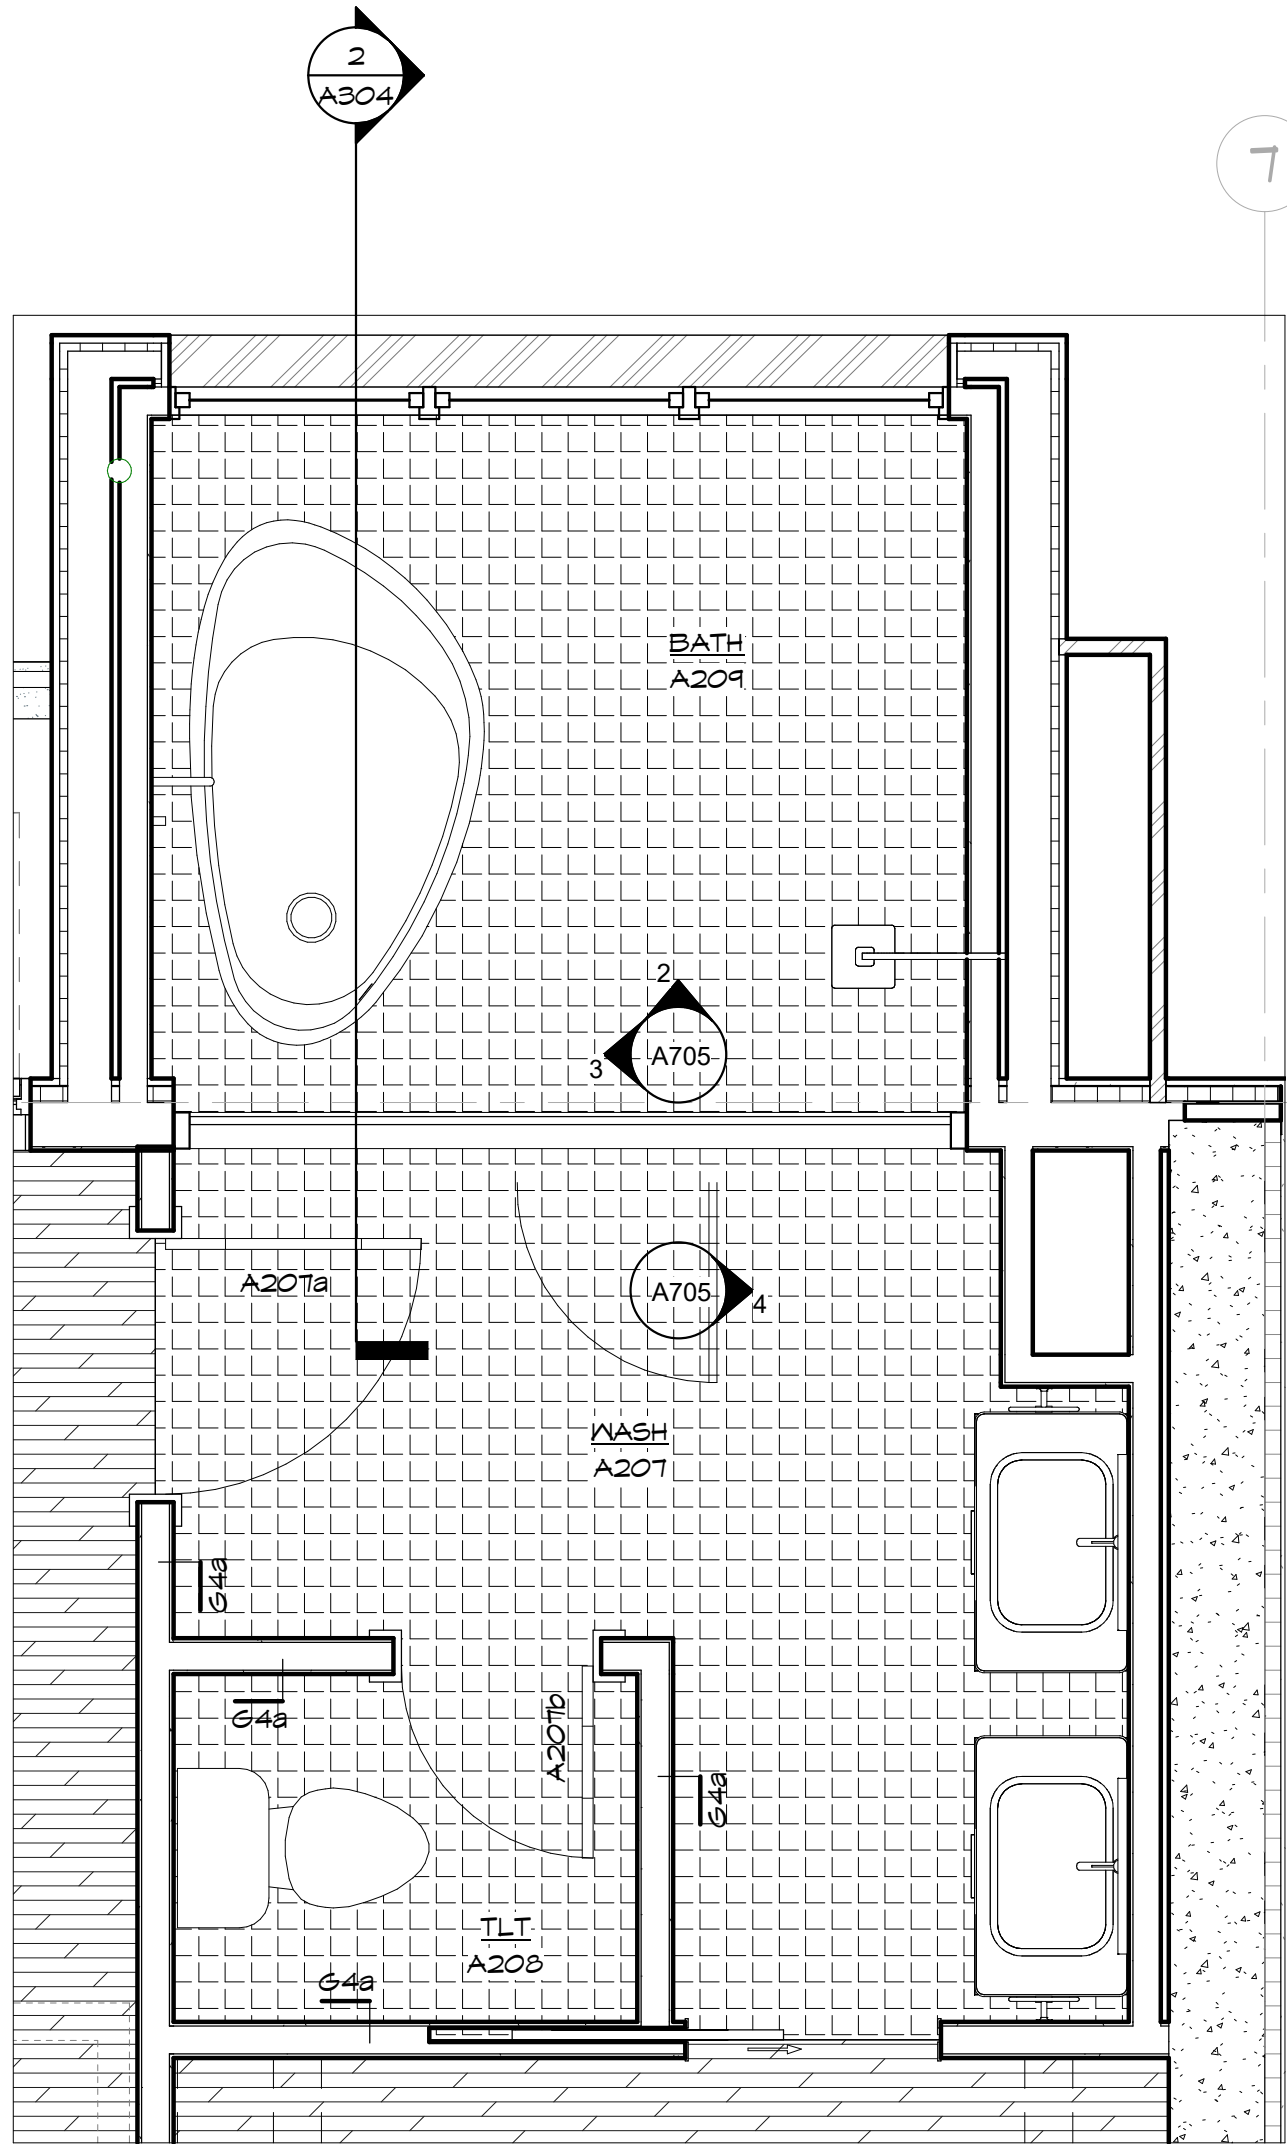


1 enlarged floor plan - primary bath  
1/2" = 1'-0"

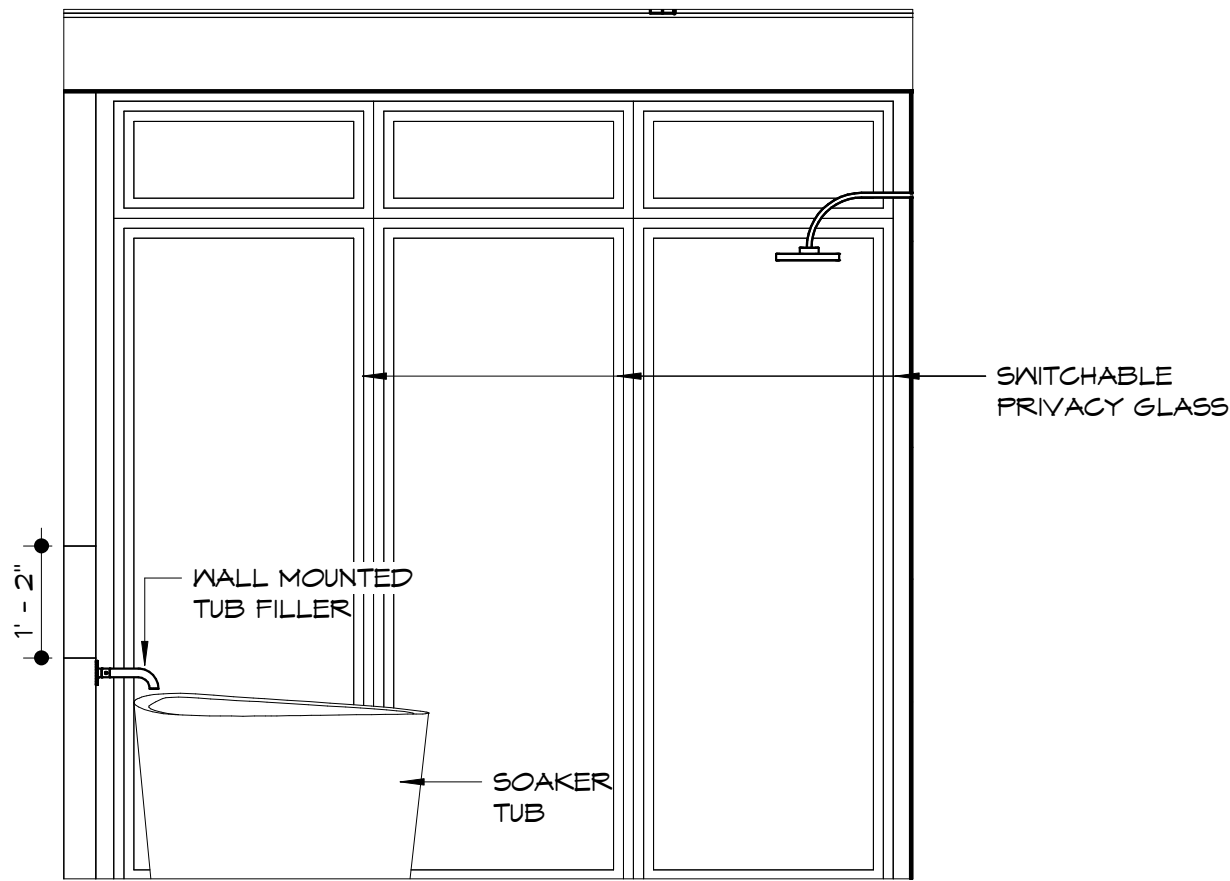

2 primary bath - exterior wall elevation  
1/2" = 1'-0"

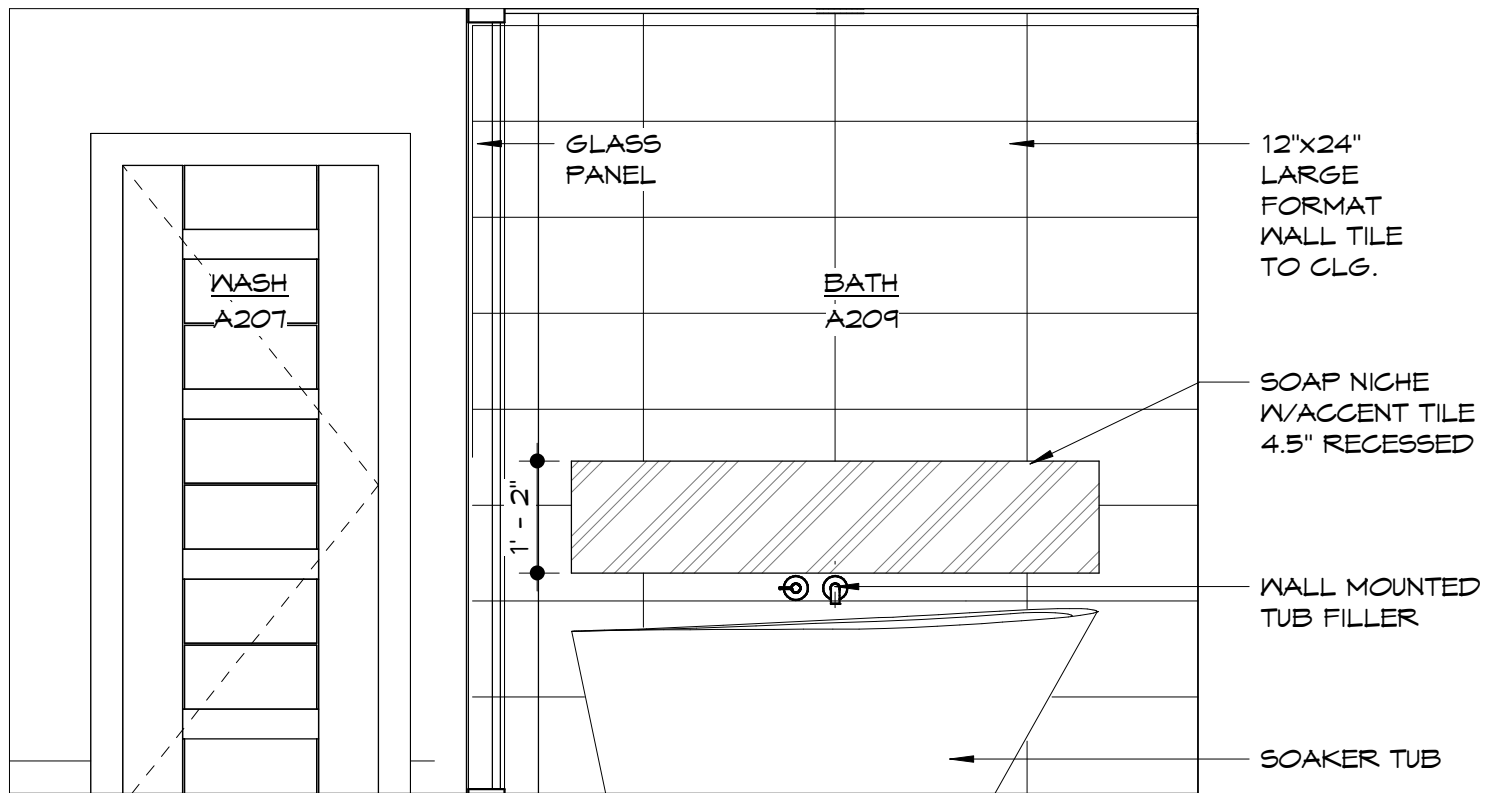

3 primary bath - tub elevation  
1/2" = 1'-0"

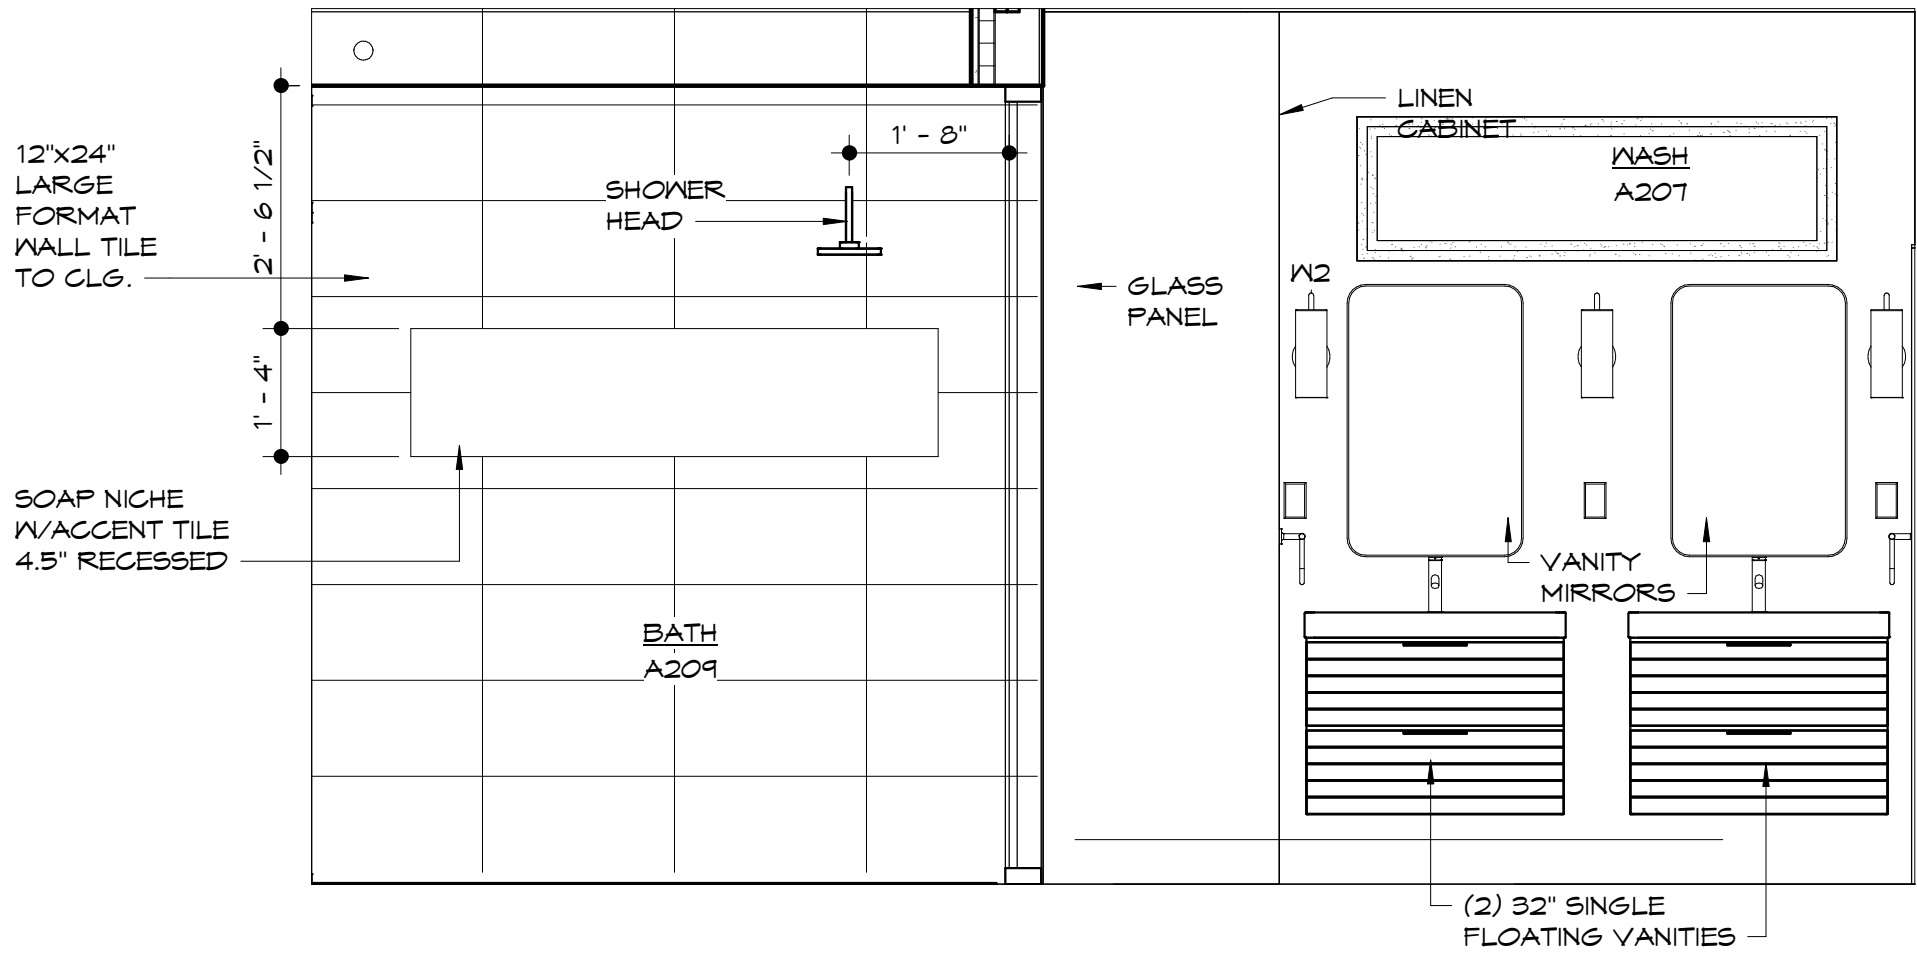

4 primary bath - vanity elevation  
1/2" = 1'-0"

ROOM FINISH SCHEDULE								
ROOM INFO		FLOORS	BASE	WALLS				NOTES
#	NAME			NORTH (or TYP.)	EAST	SOUTH	WEST	
LOWER LEVEL								
A004	STORAGE	SC	-	EC	EC	EC	EC	
B004	STORAGE	SC	-	EC	EC	EC	EC	
C004	STORAGE	SC	-	EC	EC	EC	EC	
TOWNHOME A								
A001	GARAGE	SC	-	EC	P1	EC	EC	
A002	ENTRY	SC	WD1	EC	EC	P1	P1	
A003	STORAGE	SC	WD1	P1	EC	EC	P1	
TOWNHOME B								
B001	GARAGE	SC	-	EC	P1	EC	EC	
B002	ENTRY	SC	WD1	EC	EC	P1	P1	
B003	STORAGE	SC	WD1	P1	EC	EC	P1	
TOWNHOME C								
C001	GARAGE	SC	-	EC	EC	EC	P1	
C002	ENTRY	SC	WD1	EC	P1	P1	P1	
C003	STORAGE	SC	WD1	P1	P1	EC	P1	

MAIN LEVEL								
TOWNHOME A								
A100	MECH	HWD	WD1	P1	EC	P1	P1	
A101	LIVING	HWD	WD1	P1	P1/EC	-	P1	
A102	DINING	HWD	WD1	P1	P1	-	P1	
A103	KITCHEN	HWD	WD1	P1	-	T2 / P1	T2 / P1	
A104	PANTRY	HWD	WD1	P1	P1	-	-	
A105	LAUNDRY	HWD	WD1	P1	-	P1	P1	
A106	WINE STORAGE	HWD	WD1	GL	P1	P1	P1	
A107	PYDR.	PT1	TB1	P2	P2	P2	P2	
A108	FURNACE	HWD	WD1	P1	P1	P1	P1	
A110	BEDROOM	HWD	WD1	P1	EC	-	-	
A111	BATH	PT1	TB1	T1 / P2	T1 / P2	T1 / P2	T1 / P2	
A112	TLT	PT1	TB1	T1 / P2	T1 / P2	T1 / P2	T1 / P2	
A113	W.I.C.	HWD	WD1	P1	P1	P1	P1	
A114	HALL	HWD	WD1	-	P1	P1	P1	
TOWNHOME B								
B100	MECH	HWD	WD1	P1	P1	P1	P1	
B101	LIVING	HWD	WD1	P1	P1	-	P1	
B102	DINING	HWD	WD1	P1	-	-	P1	
B103	KITCHEN	HWD	WD1	P1	-	-	T2 / P1	
B104	PANTRY	HWD	WD1	P1	P1	P1	P1	
B105	LAUNDRY	HWD	WD1	P1	P1	P1	P1	
B106	WINE STORAGE	HWD	WD1	GL	P1	P1	P1	
B107	PYDR.	PT1	TB1	P2	-	-	P2	
B108	FURNACE	HWD	WD1	P1	-	-	P1	
B110	BEDROOM	HWD	WD1	P1	P1	-	-	
B111	BATH	PT1	TB1	T1 / P2	T1 / P2	T1 / P2	T1 / P2	
B112	TLT	PT1	TB1	T1 / P2	T1 / P2	T1 / P2	T1 / P2	
B113	W.I.C.	HWD	WD1	P1	P1	P1	P1	
B114	HALL	HWD	WD1	-	P1	P1	P1	
TOWNHOME C								
C100	MECH	HWD	WD1	P1	P1	P1	P1	
C101	LIVING	HWD	WD1	P1	P1	-	-	
C102	DINING	HWD	WD1	P1	P1	P1	P1	
C103	KITCHEN	HWD	WD1	P1	T2 / P1	-	-	
C104	PANTRY	HWD	WD1	P1	P1	P1	P1	
C105	LAUNDRY	HWD	WD1	P1	P1	P1	P1	
C106	CL.	HWD	WD1	P1	P1	P1	P1	
C107	PYDR.	PT1	TB1	P2	T1 / P2	T1 / P2	T1 / P2	
C108	FURNACE	HWD	WD1	P1	P1	P1	P1	
C110	BEDROOM	HWD	WD1	P1	P1	P1	P1	
C111	BATH	PT1	TB1	T1 / P2	T1 / P2	P2	T1 / P2	
C112	TLT	PT1	TB1	T1 / P2	T1 / P2	T1 / P2	T1 / P2	
C113	W.I.C.	HWD	WD1	P1	P1	P1	P1	
C114	HALL	HWD	WD1	-	P1	P1	P1	

SECOND LEVEL								
TOWNHOME A								
A201	BEDROOM	HWD	WD1	P1	EC	P1	P1	
A202	SHWR.	PT1	TB1	T1 / P2	T1 / P2	P2	P2	
A203	BATH	PT1	TB1	T1 / P2	T1 / P2	T1 / P2	T1 / P2	
A204	ENTERTAINING	HWD	WD1	P1	P1	GL	P1	
A205	LIBRARY	HWD	WD1	P1	EC	P1	P1	
A206	BEDROOM	HWD	WD1	P1 / GL	P1	P1	P1	
A207	WASH	PT1	TB1	T1 / P2	T1 / P2	P2	T1 / P2	
A208	TLT	PT1	TB1	T1 / P2	T1 / P2	T1 / P2	T1 / P2	
A209	BATH	PT1	TB1	T1 / P2	T1 / P2	P2	T1 / P2	
A210	W.I.C.	HWD	WD1	P1	EC	P1	P1	
TOWNHOME B								
B201	BEDROOM	HWD	WD1	P1	P1	P1	P1	
B202	SHWR.	PT1	TB1	T1 / P2	T1 / P2	P2	P2	
B203	BATH	PT1	TB1	T1 / P2	T1 / P2	T1 / P2	T1 / P2	
B204	ENTERTAINING	HWD	WD1	P1	P1	P1	P1	
B205	LIBRARY	HWD	WD1	P1	P1	P1	P1	
B206	BEDROOM	HWD	WD1	P1	P1	P1	P1	
B207	WASH	PT1	TB1	T1 / P2	T1 / P2	T1 / P2	T1 / P2	
B208	TLT	PT1	TB1	P2	T1 / P2	T1 / P2	T1 / P2	
B209	BATH	PT1	TB1	T1 / P2	T1 / P2	P2	T1 / P2	
B210	W.I.C.	HWD	WD1	P1	P1	P1	P1	
TOWNHOME C								
C201	BEDROOM	HWD	WD1	P1	P1	P1	P1	
C202	SHWR.	PT1	TB1	T1 / P2	T1 / P2	P2	P2	
C203	BATH	PT1	TB1	P2	T1 / P2	T1 / P2	T1 / P2	
C204	ENTERTAINING	HWD	WD1	P1	P1	P1	P1	
C205	LIBRARY	HWD	WD1	P1	P1	P1	P1	
C206	BEDROOM	HWD	WD1	P1	P1	P1	P1	
C207	WASH	PT1	TB1	T1 / P2	T1 / P2	P2	T1 / P2	
C208	TLT	PT1	TB1	T1 / P2	T1 / P2	T1 / P2	T1 / P2	
C209	BATH	PT1	TB1	T1 / P2	T1 / P2	P2	T1 / P2	
C210	W.I.C.	HWD	WD1	P1	P1	P1	P1	

## general finish notes

1. ALL SHELVING TO HAVE BLOCKING IN WALL OR BRACKETS @3' O.C. MINIMUM U.N.O.

## room finish schedule legend

### FLOORS

- CPT1 CARPET 1  
CPT2 CARPET 2  
HWD HARDWOOD FLOORING  
LVT1 LUXURY VINYL TILE  
PT1 PORCELAIN TILE  
SC SEALED CONCRETE  
VP VAPOR RETARDER MEMBRANE

### WALLS

- EC EXPOSED CONCRETE (TEXTURE OR PATTERN FINISH)  
GL GLASS  
P1 LATEX ENAMEL PAINT  
P2 EPOXY PAINT  
T1 TILE

### BASE & TRIM

- WD1 4" WOOD TRIM  
RB1 4" TOP-SET RUBBER  
RB2 6" TOP-SET RUBBER  
RS RUBBER STRINGERS  
TB1 4" PORCELAIN TILE BASE  
WT WOOD TRIM

### CEILING

- RE: REFLECTED CEILING PLANS

\*FOR ANY CELL / FIELD IN THE SCHEDULE THAT IS EITHER LEFT BLANK OR THAT INCLUDES ONLY A DASH, THE ASSOCIATED FINISH FOR THAT COMPONENT IS TO MATCH THE FINISH NOTED AS TYPICAL.

## finish floor plan legend

NOTE: FLOOR FINISH PATTERNS ARE SYMBOLIC OF MATERIAL. THE PATTERNS SHOWN DO NOT INDICATE DESIRED PATTERN OF ACTUAL FLOOR MATERIALS. REFER TO SPECIFICATIONS AND FLOOR FINISH DETAILS FOR ACTUAL PATTERNS.


REFER TO ENLARGED PLAN CALLOUTS FOR ANY INTERIOR ELEVATION MARKERS NOT SHOWN ON OVERALL FINISH PLANS



HWD - HARDWOOD FLOORING



LVT1 - LUXURY VINYL TILE

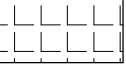

PT1 - PORCELAIN TILE



SC - SEALED CONCRETE



WC - WATERPROOF DECK COATING

NOTE: REFER TO STRUCTURAL DRAWINGS FOR REINF. STEEL IN EXTERIOR WALLS AND CONCRETE NOT SHOWN

NOTE: REFER TO ALL DETAILS (DETAILS LOCATED ON THIS SHEET, PRECEDING SHEETS AND FOLLOWING SHEETS) FOR APPLICABLE NOTES NOT SHOWN

NOTE: REFER TO ALL SECTIONS (SECTIONS LOCATED ON THIS SHEET, PRECEDING SHEETS AND FOLLOWING SHEETS) FOR APPLICABLE NOTES NOT SHOWN

## REVISIONS

No.	Description	Date
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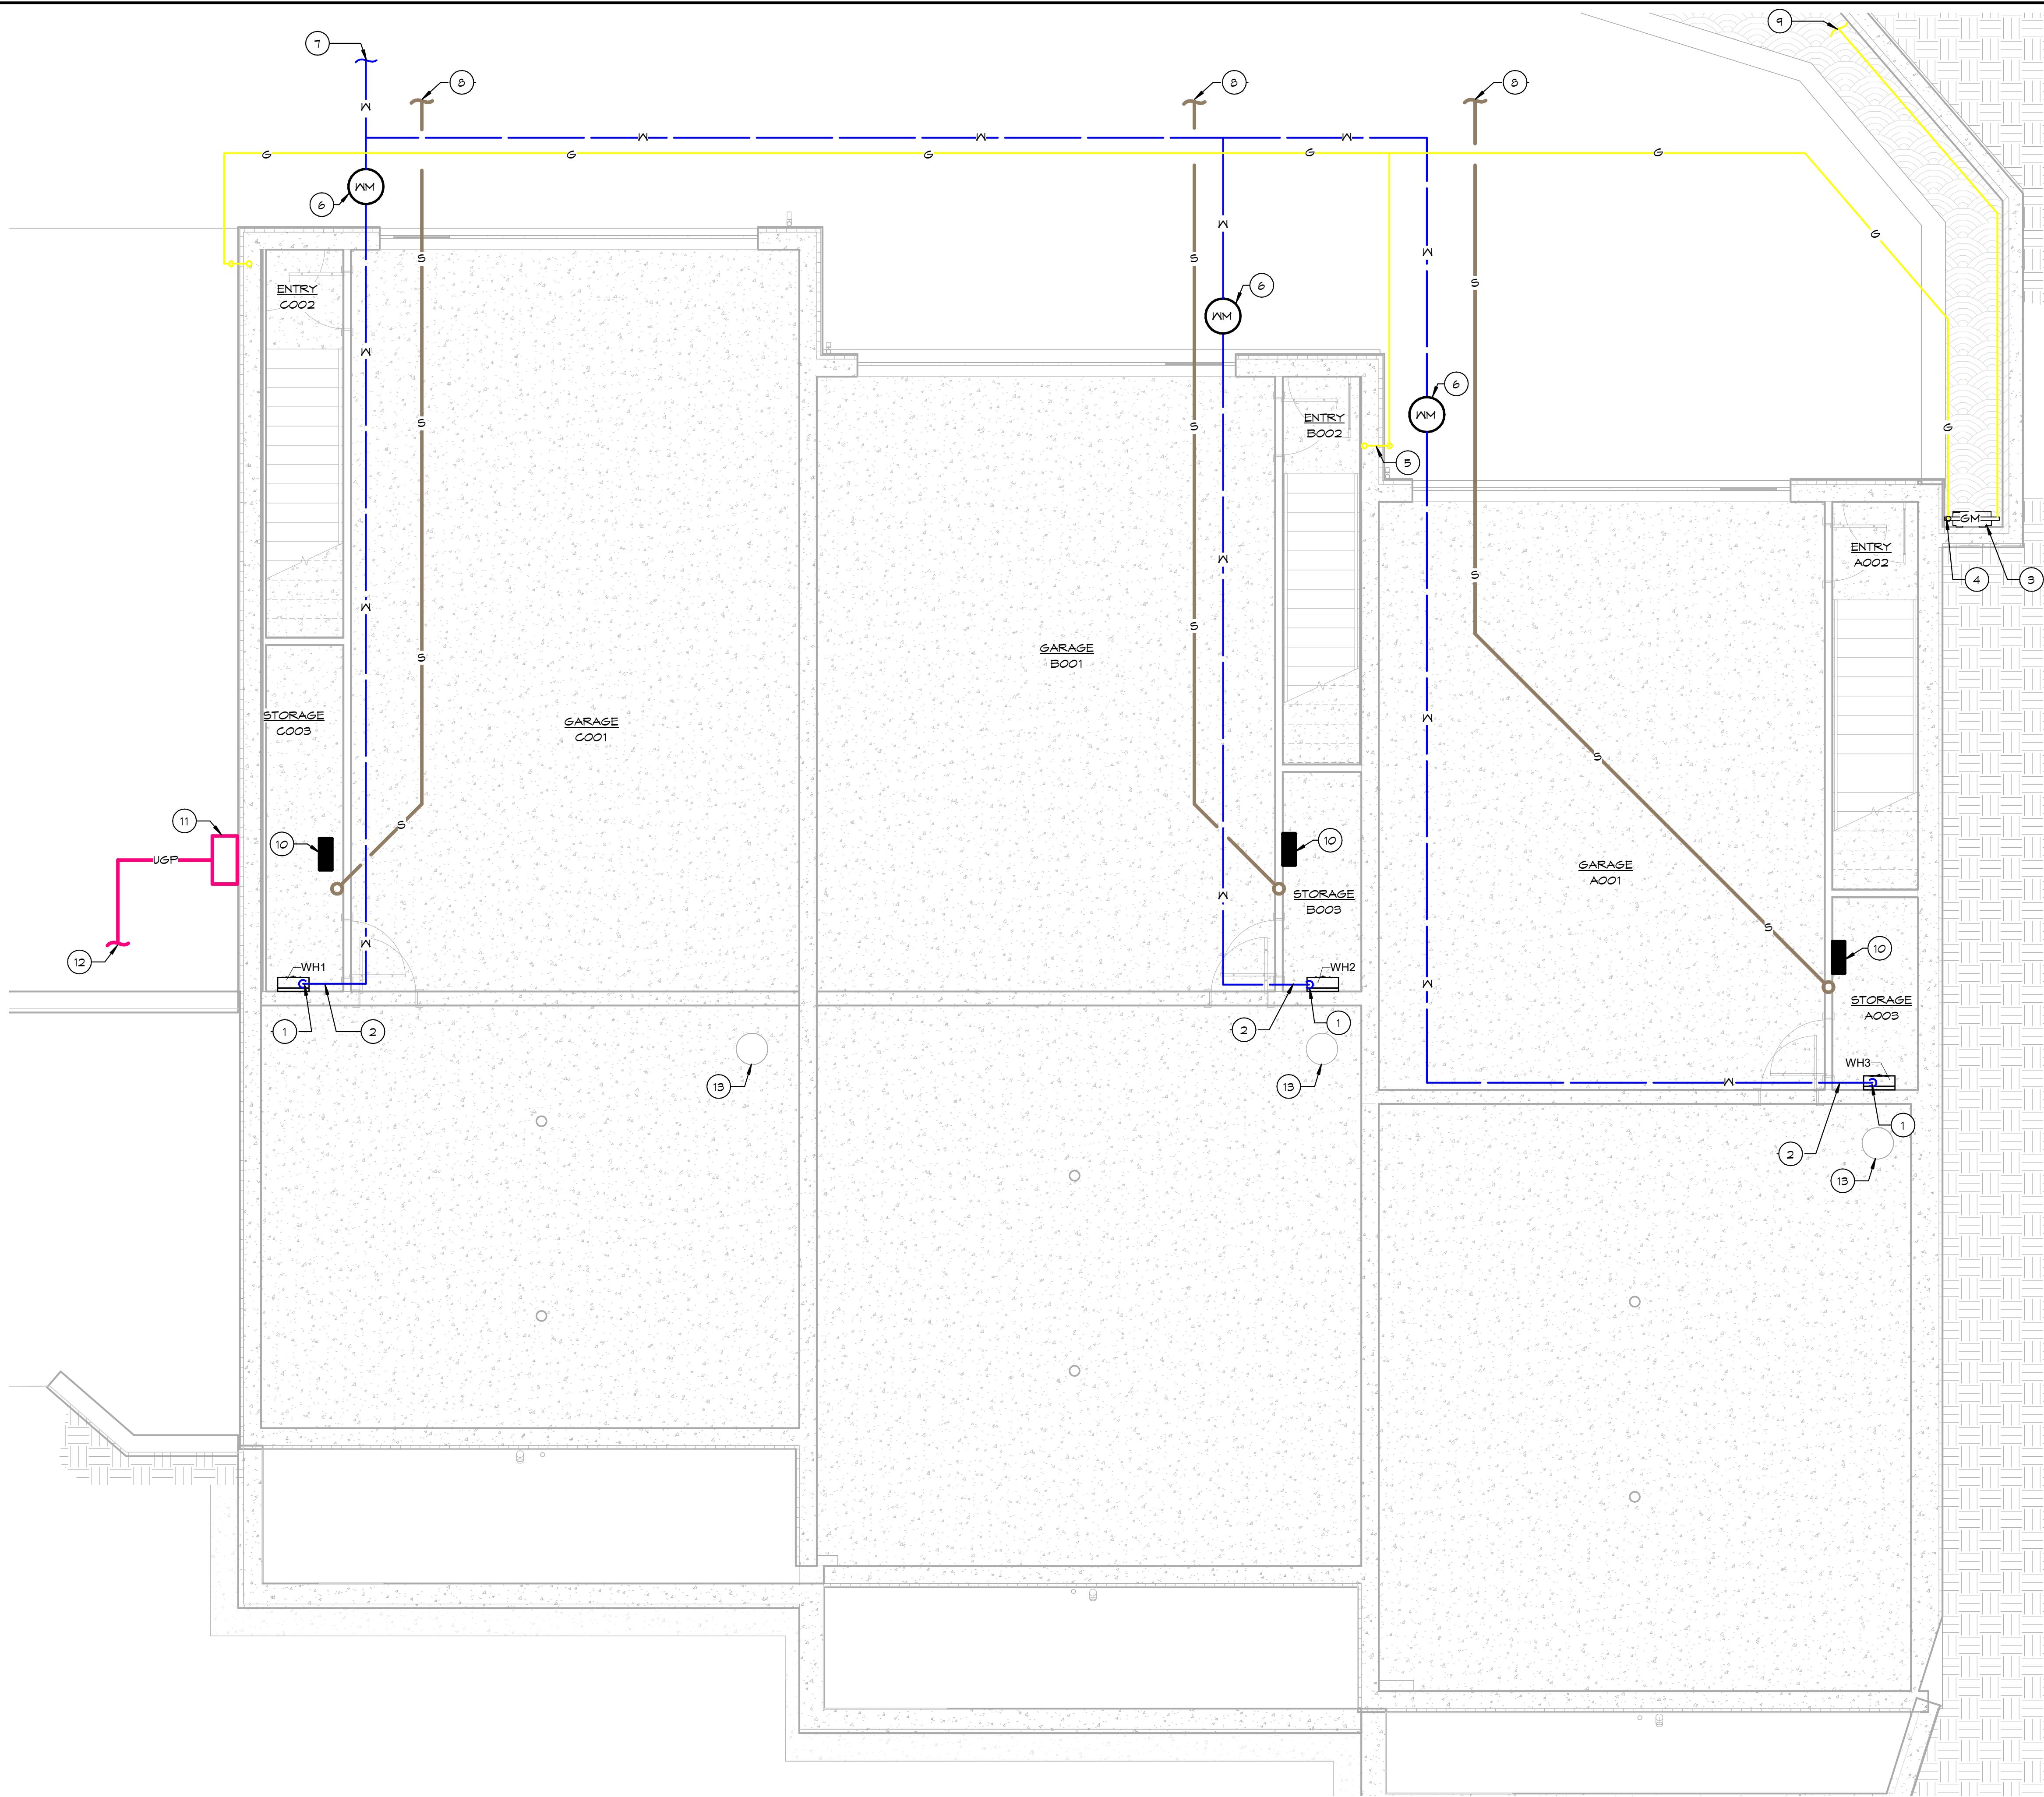
project no.:  
20.32

sheet contents:  
INTERIOR ELEVATIONS  
& FINISH SCHEDULE

sheet no.:



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1 schematic mechanical plan - lower level  
1/4" = 1'-0"

general mechanical notes

- COORDINATE WORK SHOWN WITH STRUCTURAL, DRAWINGS, REF. FE SHEET(S) FOR EQUIP. COORDINATION.
- ALL SECOND FLOOR SUPPLY PIPING TO BE LOCATED ABOVE CEILING.


mechanical plan keynotes

NUMBER	NOTE TEXT
1	PROVIDE WHOLE-UNIT SHUT-OFF IN CLOSET
2	RPZ BACKFLOW PREVENTER- INSTALL PRIOR TO ANY BRANCH LINES- REFER TO DETAIL ON THIS SHEET
3	GAS METER BANK (3)
4	GAS LINE UP AND TO ENTER EAST UNIT IN MECH ROOM OF MAIN LEVEL
5	PROVIDE FIRE CALKING FOR GAS LINE PENETRATION THRU SEPERATION WALL
6	NBA 1 1/2" WATER METER. ASSOCIATED BIT BY CONTRACTOR.
7	REFER TO CIVIL FOR CONTINUATION OF WATER LINE TO CITY MAIN
8	REFER TO CIVIL FOR CONTINUATION OF SANITARY SEWER.
9	REFER TO CIVIL FOR CONTINUATION OF GAS LINE.
10	200A ELECTRICAL PANEL
11	ELECTRIC METER BANK (3)
12	REFER TO CIVIL FOR CONTINUATION OF UNDERGROUND POWER.
13	SUMP PUMP PIT

utility legend

EM	ELECTRIC METER	○	UTILITY POLE
FH	FIRE HYDRANT	●	UTILITY POLE LIGHT
GM	GAS METER	○	WATER VALVE
GRGS	GAS REGULATOR	○	UNDERGROUND GAS LINE MARKER
WV	WATER VALVE	○	SANITARY SEWER MANHOLE
S	SEWER LINE (8" VITRIFIED CLAY PIPE)	○	CLEANOUT
W	WATER LINE	~	PIPE CONTINUES, OUTLET OR SOURCE NOT YET FOUND OR SURVEYED
G	GAS LINE		
UGP	UNDERGROUND POWER LINE		

Mechanical Equipment Schedule			
MARK	DESCRIPTION	MANUF	MODEL
F1	ULTRA-EFFICIENT GAS-FIRED FURNACE		
F2	ULTRA-EFFICIENT GAS-FIRED FURNACE		
F3	ULTRA-EFFICIENT GAS-FIRED FURNACE		
F4	ULTRA-EFFICIENT GAS-FIRED FURNACE		
F5	ULTRA-EFFICIENT GAS-FIRED FURNACE		
F6	ULTRA-EFFICIENT GAS-FIRED FURNACE		
MS4	MINI-SPLIT A/C UNIT		
MS5	MINI-SPLIT A/C UNIT		
MS6	MINI-SPLIT A/C UNIT		
WH1	GAS-FIRED TANKLESS WATER HEATER		
WH2	GAS-FIRED TANKLESS WATER HEATER		
WH3	GAS-FIRED TANKLESS WATER HEATER		

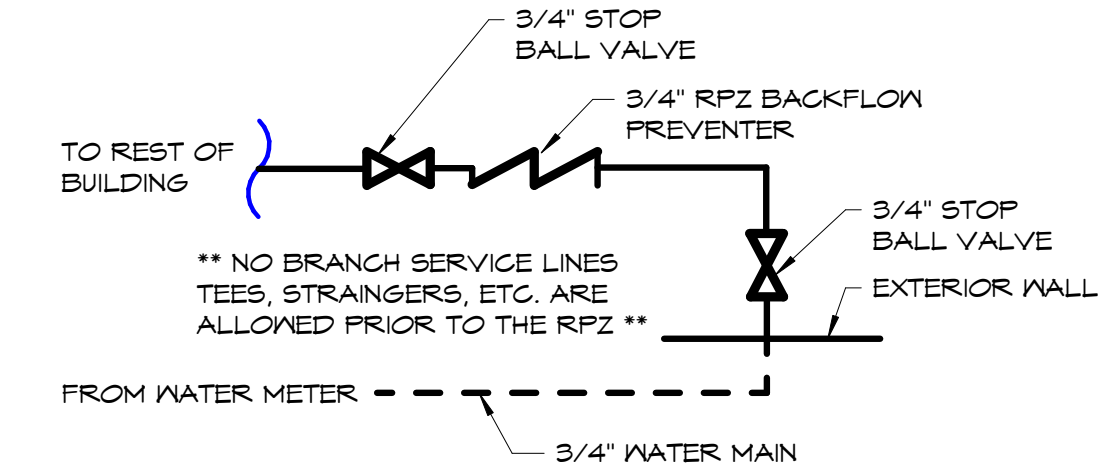

2 rpz diagram  
NOT TO SCALE



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consulting engineer.

FOR REVIEW

SHIRAZ TOWNHOMES  
603, 605, & 607 W. 49th ST. KANSAS CITY, MO 64112

REVISIONS		
No.	Description	Date

sheet issue date:  
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project no.:  
20.32

sheet contents:  
UTILITY INFORMATION  
- GARAGE LEVEL

sheet no.:


A800



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1 mechanical plan - main level

1/4" = 1'-0"

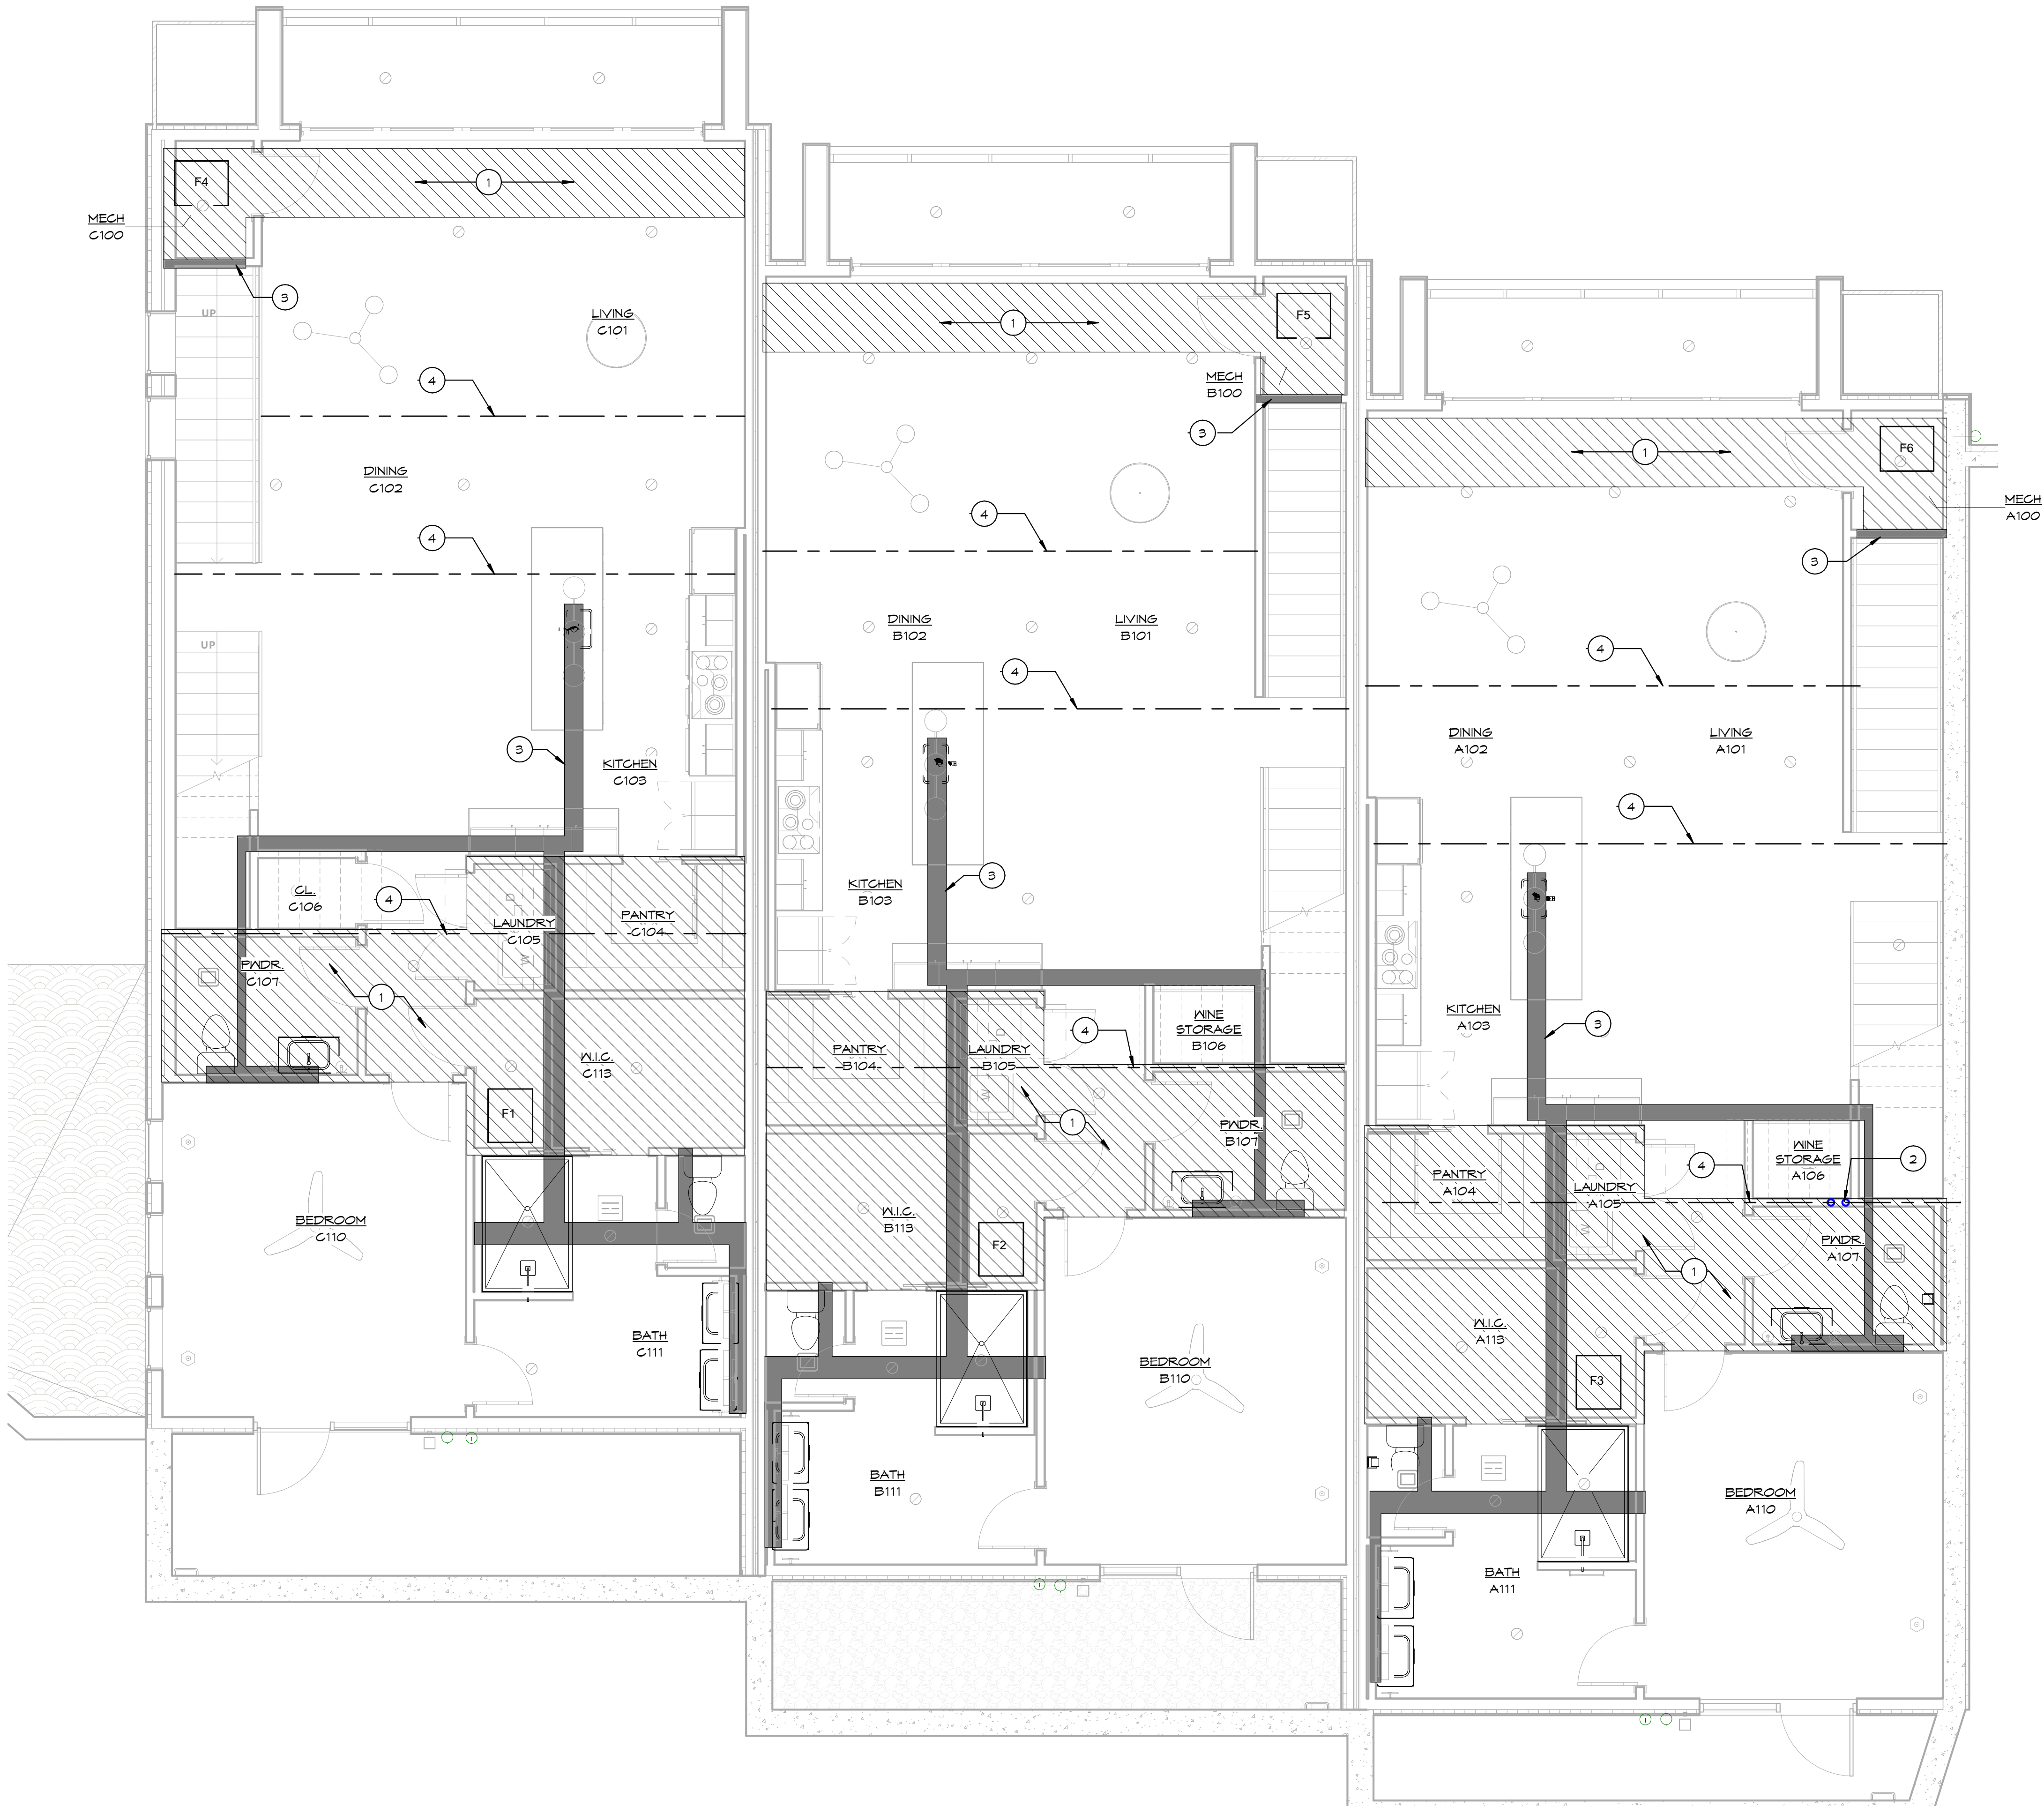

general mechanical notes

- COORDINATE WORK SHOWN WITH STRUCTURAL, DRAWINGS, REF. FE SHEET(S) FOR EQUIP. COORDINATION.
- ALL SECOND FLOOR SUPPLY PIPING TO BE LOCATED ABOVE CEILING.

mechanical plan keynotes

- | NUMBER | NOTE TEXT  |
|--------|--|
| 1      | HATCHED AREA REPRESENTS PLANNED AREA FOR DUCT RUNS, LOWER CEILING AND/OR CONSTRUCT SOFFIT AS REQUIRED. |
| 2      | H/C WATER UP FROM CLOSET BELOW   |
| 3      | SHADED AREA REPRESENTS POTENTIAL ZONE OF PLUMBING ROUTES.  |
| 4      | STEEL BEAM (MAIN LEVEL CEILING), REF. STRUCTURAL.  |

Mechanical Equipment Schedule			
MARK	DESCRIPTION	MANUF	MODEL
F1	ULTRA-EFFICIENT GAS-FIRED FURNACE		
F2	ULTRA-EFFICIENT GAS-FIRED FURNACE		
F3	ULTRA-EFFICIENT GAS-FIRED FURNACE		
F4	ULTRA-EFFICIENT GAS-FIRED FURNACE		
F5	ULTRA-EFFICIENT GAS-FIRED FURNACE		
F6	ULTRA-EFFICIENT GAS-FIRED FURNACE		
MS4	MINI-SPLIT A/C UNIT		
MS5	MINI-SPLIT A/C UNIT		
MS6	MINI-SPLIT A/C UNIT		
WH1	GAS-FIRED TANKLESS WATER HEATER		
WH2	GAS-FIRED TANKLESS WATER HEATER		
WH3	GAS-FIRED TANKLESS WATER HEATER		



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REVISIONS		
No.	Description	Date
sheet issue date: 09.27.2024		
project no.: 20.32		
sheet contents: UTILITY INFORMATION - MAIN LEVEL		
sheet no.: A801		



- general mechanical notes
- COORDINATE WORK SHOWN WITH STRUCTURAL, DRAWINGS, REF. FE SHEET(S) FOR EQUIP. COORDINATION.
  - ALL SECOND FLOOR SUPPLY PIPING TO BE LOCATED ABOVE CEILING.

- mechanical plan keynotes
- | NUMBER | NOTE TEXT  |
|--------|--|
| 1      | HVAC SUPPLY UP FROM BELOW  |
| 2      | HATCHED AREA REPRESENTS PLANNED AREA FOR DUCT RUNS, LOWER CEILING AND/OR CONSTRUCT SOFFIT AS REQUIRED. |
| 3      | SHADED AREA REPRESENTS POTENTIAL ZONE OF PLUMBING ROUTES.  |
| 4      | STEEL BEAM (UPPER LEVEL CEILING), REF. STRUCTURAL.   |

Mechanical Equipment Schedule			
MARK	DESCRIPTION	MANUF	MODEL
F1	ULTRA-EFFICIENT GAS-FIRED FURNACE		
F2	ULTRA-EFFICIENT GAS-FIRED FURNACE		
F3	ULTRA-EFFICIENT GAS-FIRED FURNACE		
F4	ULTRA-EFFICIENT GAS-FIRED FURNACE		
F5	ULTRA-EFFICIENT GAS-FIRED FURNACE		
F6	ULTRA-EFFICIENT GAS-FIRED FURNACE		
MS4	MINI-SPLIT A/C UNIT		
MS5	MINI-SPLIT A/C UNIT		
MS6	MINI-SPLIT A/C UNIT		
WH1	GAS-FIRED TANKLESS WATER HEATER		
WH2	GAS-FIRED TANKLESS WATER HEATER		
WH3	GAS-FIRED TANKLESS WATER HEATER		

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FOR REVIEW

SHIRAZ TOWNHOMES

603, 605, & 607 W. 49th ST. KANSAS CITY, MO 64112

REVISIONS		
No.	Description	Date

sheet issue date:  
09.27.2024

project no.:  
20.32

sheet contents:  
UTILITY INFORMATION  
- UPPER LEVEL

sheet no.:

A802



1 mechanical plan - upper level

1/4" = 1'-0"

