# BODHI SITE DEVELOPMENT PLAN

Case No. CD-CPC-2020-00100



## City Council Approved Subject to Conditions

by Passing Ordinance

Secretary of the City Plan Commission

3840 JACKSON AVENUE, KANSAS CITY, JACKSON COUNTY, MISSOURI 64117 NE \( \frac{1}{4} \), SECTION 22, TOWNSHIP 49N, RANGE 33W

### GENERAL NOTES

- 4. THE CONTRACTOR SHALL BE REQUIRED TO DEMOLISH, REMOVE AND DISPOSE OF ALL EXISTING STRUCTURES, PAVEMENTS, AND FEATURES NECESSARY TO CONSTRUCT THE IMPROVEMENTS SHOWN HEREON. ANY WASTE MATERIALS GENERATED DURING CONSTRUCTION SHALL BE REMOVED FROM THE SITE BY THE CONTRACTOR AND DISPOSED OF IN ACCORDANCE WITH ALL LOCAL, STATE, AND FEDERAL REGULATIONS GOVERNING SUCH DISPOSAL.
- CONSTRUCTION. IN THE EVENT OF DAMAGE TO ADJACENT PROPERTY, STRUCTURES, OR IMPROVEMENTS, THE CONTRACTOR SHALL REPAIR OR REPLACE SUCH
- 7. CONTRACTORS AT THE SITE SHALL BE SOLELY RESPONSIBLE FOR JOBSITE SAFETY FOR ALL ASPECTS OF WORK SHOWN HEREON.

- 10. CONTRACTOR SHALL BE RESPONSIBLE FOR CONTACTING ALL UTILITY COMPANIES FOR FIELD LOCATIONS OF UNDERGROUND UTILITIES AFFECTED BY THE CONTRACT. ALL EXISTING UTILITIES INDICATED ON THESE PLANS ARE ACCORDING TO THE BEST INFORMATION AVAILABLE TO THE ENGINEER; HOWEVER, ALL UTILITIES ACTUALLY EXISTING MAY NOT BE SHOWN. UTILITIES DAMAGED THROUGH THE NEGLIGENCE OF THE CONTRACTOR TO OBTAIN THE LOCATION OF
- 13. UNLESS SPECIFIED OTHERWISE, ALL CONSTRUCTION SHALL MEET THE REQUIREMENTS OF THE MISSOURI DEPARTMENT OF TRANSPORTATION (MODOT) STANDARD SPECIFICATIONS, EXCEPT AS MODIFIED BY THESE PLANS.

### **AS-BUILT STATEMENT**

THE POLICY OF THE PLAN PREPARATION CRITERIA AND PROCEDURE (PLANS CRITERIA) AND POLICY DOCUMENT NO. 880544 AS BUILT DRAWINGS FOR SEWER BUILT BY PERMIT STIPULATE THE FOLLOWING REGARDING AS BUILT DRAWINGS: 1. DRAWINGS ARE TO BE PROVIDED WITHIN THIRTY (30) CALENDAR DAYS AFTER THE DATE THE REQUEST FOR AS BUILTS LETTER IS ISSUED BY THE CITY TO THE PERMITTEE/CONTRACTOR.

2. DRAWINGS MUST BE ACCEPTED BY THE CITY BEFORE ANY SERVICE CONNECTIONS WILL BE ALLOWED. 3. DRAWINGS ARE PART OF THE PERMIT OBLIGATIONS MAKING THEM THE RESPONSIBILITY OF THE PERMITTEE. 4. THE COST OF PREPARING AS BUILT DRAWINGS SHALL BE INCLUDED IN THE PERFORMANCE BOND.

### SHOP DRAWING NOTE

PRIOR TO ORDERING PRE-CAST STRUCTURES, SHOP DRAWINGS ARE TO BE SUBMITTED TO THE DESIGN ENGINEER FOR APPROVAL. THE DESIGN ENGINEER SHALL INDICATE APPROVAL OF THE SHOP DRAWINGS AND ADD THE PERMIT TYPE AND NUMBER ON THEM AND THEN SUBMIT THEM TO THE CITY PLANNING & DEVELOPMENT DEPT., LAND DEVELOPMENT DIVISION, DEVELOPMENT SERVICES ON THE 5TH FLOOR OF CITY HALL, 414 E.







SHEET INDEX				
SHEET NUMBER	SHEET TITLE			
CVR	COVER SHEET			
<i>S1</i>	ALTA SURVEY			
C1.0	EXISTING SITE CONDITIONS			
C2.0	SITE PLAN			
C3.0	GRADING PLAN			
C4.0	UTILITY PLAN			
L1	LANDSCAPE PLAN			
A101	BUILDING A OVERALL FIRST FLOOR			
A102	BUILDING B OVERALL FIRST FLOOR			
A103	BUILDING C—G FIRST FLOOR			
A104	BUILDING A-G SECOND FLOOR			
A105	BUILDING A—G THIRD FLOOR PLAN			
A107	BUILDING SIGNAGE			
A108	BUILDING SIGNAGE			
A201	BUILDING A ELEVATIONS			
A202	BUILDING B ELEVATIONS			
A202	BUILDING C-G ELEVATIONS			

### UTILITY CONTACTS

KCMO WATER SERVICES MELANIE JOLLETT PHONE (816) 513-0154 MELANIÈ. JOLLETT@KCMO. ORG

ANDY ALEXANDER PHONE (816) 245-3775 ANDREW.ALÉXANDER@EVERGY.COM

JOSE ARELLANO PHONE (314) 399-2981 JOSE.ARELLÁNO@SPIREENERGY.COM

RON GIPFERT PHONE (816) 772-0318 RG7910@ATT.COM

KCMO WATER SERVICES KARINE PAPIKIAN PHONE (816) 513-0154 KARINE. PAPIKIAN@KCMO. ORG

<u>STORM SEWER</u> KCMO WATER SERVICES ROBERT DAVIS PHONE (816) 513-0573 ROBERT.DA VIS@KCMO.ORG <u>STREETS & TRAFFIC</u> KCMO PUBLIC WORKS

PHONE (816) 513-9869

CITY PLANNING

AND DEVELOPMENT

**City Plan Commission Approved Subject to Conditions** On 10/19/2021

Joseph Rexwinkle, AICP

Secretary of the Commission

### LEGAL DESCRIPTION

LOTS 26 THROUGH 36, INCLUSIVE, LAURELHURST, A SUBDIVISION IN KANSAS CITY, JACKSON COUNTY, MISSOURI, ACCORDING TO THE RECORDED PLAT THEREOF.

LOTS 1 THROUGH 10, INCLUSIVE, LAURELHURST, A SUBDIVISION IN KANSAS CITY, JACKSON COUNTY, MISSOURI, ACCORDING TO THE RECORDED PLAT THEREOF.

THE EAST ONE HUNDRED THIRTY FIVE (135) FEET OF LOT SEVEN (7), DAVENPORT (JAMES) ESTATE SUBDIVISION, AN ADDITION IN AND TO KANSAS CITY, JACKSON COUNTY, MISSOURI, ACCORDING TO THE RECORDED PLAT THEREOF, AND THAT PART OF THE SOUTHEAST QUARTER OF THE NORTHEAST QUARTER OF SECTION 22, TOWNSHIP 49, RANGE 33, OF JACKSON COUNTY, MISSOURI, DESCRIBED AS FOLLOWS: BEGINNING ON THE SOUTHEAST CORNER OF THE SOUTHEAST QUARTER OF THE NORTHEAST QUARTER; THENCE WEST 165 FEET; THENCE NORTH TO THE SOUTH LINE OF SAID LOT 7; THENCE NORTHEASTERLY ALONG SAID SOUTH LINE TO THE EAST LINE OF SAID QUARTER QUARTER SECTION ; THENCE SOUTH 280.5 FEET TO THE POINT OF BEGINNING, EXCEPT THOSE PARTS IN STREETS)

ALL OF LOTS 11 AND 12, EXCEPT THE EAST 30 FEET AND THE WEST 5 FEET OF LOT 13, ALL OF LOT 14 AND THE EAST 5 FEET OF LOT 15 AND THE WEST 30 FEET OF LOT 15 AND ALL OF LOT 16, LAURELHURST, A SUBDIVISION IN KANSAS

THE EAST 30 FEET OF LOTS 11, 12, AND 13, INCLUSIVE, LAURELHURST, A SUBDIVISION IN KANSAS CITY, JACKSON COUNTY, MISSOURI, ACCORDING TO THE

CITY, JACKSON COUNTY, MISSOURI, ACCORDING TO THE RECORDED PLAT THEREOF.

### WATERSHED

THIS PROJECT SITE LIES WITHIN THE BLUE RIVER WATERSHED.

### FEMA INFORMATION

THIS SITE IS LOCATED WITHIN ZONE X PER FEMA FIRM MAP 29095C0266G: EFFECTIVE DATE OF JANUARY 20, 2017. NO LETTERS OF MAP AMENDMENT OR REVISIONS ARE BEING PROPOSED.

### **BENCHMARKS**

CP 10037 N: 1051702.1721' E: 2779021.4426' Z: 868.899' (NAVD 88) N: 1052373.3738' E: 2778979.6564'

Z: 843.717' (NAVD 88)

### DISTURBED AREA

2.09 AC

### **ARCHITECT**

<u>VECINO DESIGN GROUP</u> 305 W. COMMERCIAL ST SPRINGFIELD MO, 65803

CONTACT: MATT MCLAUGHLIN, AIA, NCARB PHONE: (417) 720-1577 EMAIL: MCMATT@VECINOGROUP.COM

### **OWNER & DEVELOPER**

THE VECINO GROUP LLC 3800 NORTON AVE KANSAS CITY, MO 64128

THE VECINO GROUP

305 W. COMMERCIAL ST. SPRINGFIELD MO, 65803

CONTACT: DONNELL MCGHEE PHONE: (417) 720-1577 EMAIL: DMCGHEE@VECINOGROUP.COM

I HAVE REVIEWED THESE PLANS AND UNDERSTAND WHAT IS PROPOSED.

ANY INCIDENTAL WORK NOT SPECIFICALLY PERMITTED (I.E. FINAL CLEANUP) WILL BE COMPLETED BY THE OWNER.

### CIVIL ENGINEER

TREVOR A. FOX, P.E. ANDERSON ENGINEERING, INC. 941 W 141ST TERRACE KANSAS CITY, MISSOURI 64145 TFOX@AE-INC.COM (816) 777-0400

"I CERTIFY THAT THIS PROJECT HAS BEEN DESIGNED AND THESE PLANS PREPARED, TO MEET OR EXCEED THE DESIGN CRITERIA OF KANSAS CITY, MISSOURI IN CURRENT USAGE, EXCEPT AS INDICATED BELOW. EXCEPTIONS: NONE

I HAVE NOT BEEN RETAINED TO PROVIDE "AS-BUILT" DRAWINGS FOR THIS PROJECT."



SHEET NUMBER

# J

- TA/NSPS LAND TITLE SURVENVE PART OF LAURELHURST SUBDIVISION, PART OF JAMES DAVENPORT'S ESTATE, & PART OF NE 1/4 SEC. 22, TWN 49, RNG 33 KANSAS CITY, JACKSON COUNTY, MISSOURI



# SURVEYOR'S GENERAL NOTES & TABLE A NOTES

THIS SURVEY MEETS OR EXCEEDS THE ACC MISSOURI STANDARDS FOR PROPERTY BO

THE TITLE REPORT WAS FURNISHED BY (COMMONWEALTH LAND TITLE INSURANCE COMPANY) COMMITMENT NO. 20SP2901, DATE JANUARY 12, 2021 @ 12:00 A.M. TITLE IS CURRENTLY INVESTED IN: LEGACY BANK AND TRUST. AND COMMONWEALTH LAND TITLE INSURANCE COMPANY

THIS COMPANY ASSUMES NO RESPONSIBILITY IN THE LOCATION OF EXISTING UTILITIES WITHIN THE SUBJECT PREMISES. THIS IS AN ABOVE-GROUND SURVEY. THE UNDERGROUND UTILITIES, IF SHOWN, ARE BASED ON INFORMATION PROVIDED BY THE VARIOUS UTILITY COMPANIES AND THESE LOCATIONS SHOULD BE CONSIDERED APPROXIMATE. THERE MAY BE ADDITIONAL UNDERGROUND UTILITIES NOT SHOWN ON THIS DRAWING.

SUBSURFACE AND ENVIRONMENTAL CONDITIONS WERE NOT SURVEYED OR EXAMINED OR CONSIDERED AS A PART OF THIS SURVEY. NO EVIDENCE OR STATEMENT IS MADE CONCERNING THE EXISTENCE OR UNDERGROUND OR OVERHEAD CONDITIONS, CONTAINERS OR FACILITIES THAT MAY AFFECT THE USE OR DEVELOPMENT OF THIS PROPERTY. NO ATTEMPT HAS BEEN MADE TO OBTAIN OR SHOW DATA CONCERNING EXISTENCE, SIZE, DEPTH, CONDITIONS, CAPACITY OR LOCATION OF ANY UTILITY EXISTING ON THE SITE, WHETHER PRIVATE, MUNICIPAL OR PUBLIC OWNED.

WITH THIS SURVEY, ANDERSON ENGINEERING, INC., AND THIS LAND SURVEYOR DOES NOT GUARANTEE THAT OWN! THE SURVEY LINES DEPICTED HEREON. THIS SURVEY IS A GRAPHIC REPRESENTATION OF THE OPINION OF SAID SITHE OPINION OF SAID ANDERSON ENGINEERING, INC., AS TO THE LOCATION OF THE RECORD DESCRIPTION(S). NO THE VALIDITY OF THE TITLE IS GIVEN OR IMPLIED.

IERS ARE TO BE MONI

FLOOD ZONE IS CLASSIFIED AS X, AREA OF MINIMAL FLOOD HAZARD. 29095C0266G, AFFECTIVE DATE JANUARY 20, 2017 LAND AREAS IS 22

DATUM:

TIAL 2.5 AND "B1-1" NEIG RCEL AS OF THE DATE C

GS EXISTING ON THE SURVEYED PARCEL

IBLE ON TH

NOTE TO THE CLIENT, INSURER, AND LENDER - WITH REGARD TO TABLE A, ITEM 11, SOURCE MARKINGS WILL BE COMBINED WITH OBSERVED EVIDENCE OF UTILITIES PURSUANT TO SECTUNDERGROUND UTILITIES. HOWEVER, LACKING EXCAVATION, THE EXACT LOCATION OF UNITACCURATELY, COMPLETELY, AND RELIABLY DEPICTED. IN ADDITION, IN SOME JURISDICTION LOCATE REQUESTS FROM SURVEYORS MAY BE IGNORED OR RESULT IN AN INCOMPLETE RESURVEYOR SHALL NOTE ON THE PLAT OR MAP HOW THIS AFFECTED THE SURVEYOR'S ASSEUTILITIES. WHERE ADDITIONAL OR MORE DETAILED INFORMATION IS REQUIRED, THE CLIENT A PRIVATE UTILITY LOCATE REQUEST MAY BE NECESSARY.

# NACKSOŅ AVE CLEAVELAND AVE (2) O IB\_E O IBALC\_ © FH ▼ G • MS ■ MS □ PP □ STMH □ STMH ANGÉS AVE PROSPECT AVE

# TITLE INSURANCE ONWEALTH LAND

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LOTS 1 THROUGH 10, INCLU RECORDED PLAT THEREOF

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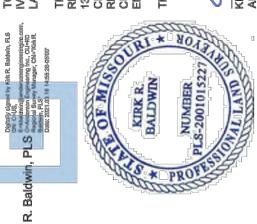
THE EAST 30 FEET OF LOTS 11, 12, AND 13, INCI ACCORDING TO THE RECORDED PLAT THEREO

NOTES CORRESPONDING TO SCHEDULE B, PART II (EXCEPTIONS)

EASEMENTS, SETBACK REQUIREMENTS, AND RESTRICTIONS WHICH ARE SHOWN ON THE PLAT OF SAID PROPERTY FILED IN BOOK 20 AT PAGE 69, RECORDER'S OFFICE, JACKSON COUNTY, MISSOURI. (AFFECTS SUBJECT TRACT, SHOWN HEREON) BUILDING SETBACK LINES AND EASEMENTS WHICH ARE DEPICTED ON THE PLAT OF SAID PROPERTY FILED IN BOOK 20 AT PAGE 69, RECORDER'S OFFICE, JACKSON COUNTY, MISSOURI. (AFFECTS SUBJECT TRACT, SHOWN HEREON)

TO: LEGACY BANK AND TRUST, HOUSTON ENTERPRISES OF KC, A LIMITED LIABILITY CORPORATION (TRACT I), HOUSTON ENTERPRISES OF KC, LLC (TRACT III AND V), LAND TRUST OF JACKSON COUNTY, MISSOURI (OWNING PART OF TRACT IV), AND COMMONWEALTH LAND TITLE INSURANCE COMPANY, LLC., THE VECINO GROUP

THIS IS TO CERTIFY THAT THIS MAP OR PLAT AND THE SURVEY ON WHICH IT IS BASED WERE MADE IN ACCORDANCE WITH THE "2021 MINIMUM STANDARD DETA REQUIREMENTS FOR ALTANSPS LAND THE SURVEYS" JOINTLY ESTABLISHED AND ADOPTED BY ALTA AND NSPS, AND INCLUDES ITEMS 1, 2, 3, 4, 5, 6, 7(a), 8, 9, 13, 14, AND 16 OF TABLE "A" THEREOF. PURSUANT TO THE ACCURACY STANDARDS AS ADOPTED BY ALTA AND NSPS, AND INCLUDES ITEMS 1, 2, 3, 4, 5, 6, 7(a), 8, 9, 13, 14, AND 16 OF TABLE "A" THEREOF. PURSUANT TO THE ACCURACY STANDARDS AS ADOPTED BY ALTA AND NSPS, AND IN THE STATE OF MISSOURI, THE RELATIVE POSITIONAL ACCURACY OF THIS SURVEY DOES NOT EXCEED THAT WHICH IS SPECIFIED THEREIN, AND THAT SAID SURVEY MEETS OR EXCEEDS THE CURRENT MISSOURI STANDARDS FOR PROPERTY BOUNDARY SURVEYS AS ESTABLISHED BY THE MISSOURI BOARD FOR ARCHITECTS, PROFESSIONAL LAND SURVEYORS AND LANDSCAPE ARCHITECTS, AND THE MISSOURI DEPARTMENT OF AGRICULTURE LAND SURVEY PROGRAM.



_						ENGINEERS	941 W 141ST TERRA	A LICENSED MIS
DATE: U3/16/2021	DRAWING INFO.	MJE	####		2021-03-11			
-62	WASIG	DRAWN BY:	CHECK BY:	LICENSE NO.	DATE:	FIELD BOOK:	JOB NUMBER:	
KIRK R. BALDWIN, PLS 2001015227 ANDERSON ENGINEERING INC. LC		DATE						21
BALDWIN SON ENG		ВҰ						3, INC. 203
KIRK R. ANDER		•						ON ENGINEERING, INC. 2021

ANDERSON ENGINEERING EMPLOYEE OWNED

0 - 2 & 4 w

ALTA/NSPS LAND TITLE SURVEY


SHEET NUMBER

OF

AURELHURST SUBDIVISION, JAMES DAVENPO. & PART OF NE 1/4 SEC. 22, TWN 49, RNG 33 KANSAS CITY, JACKSON COUNTY, MISSOURI





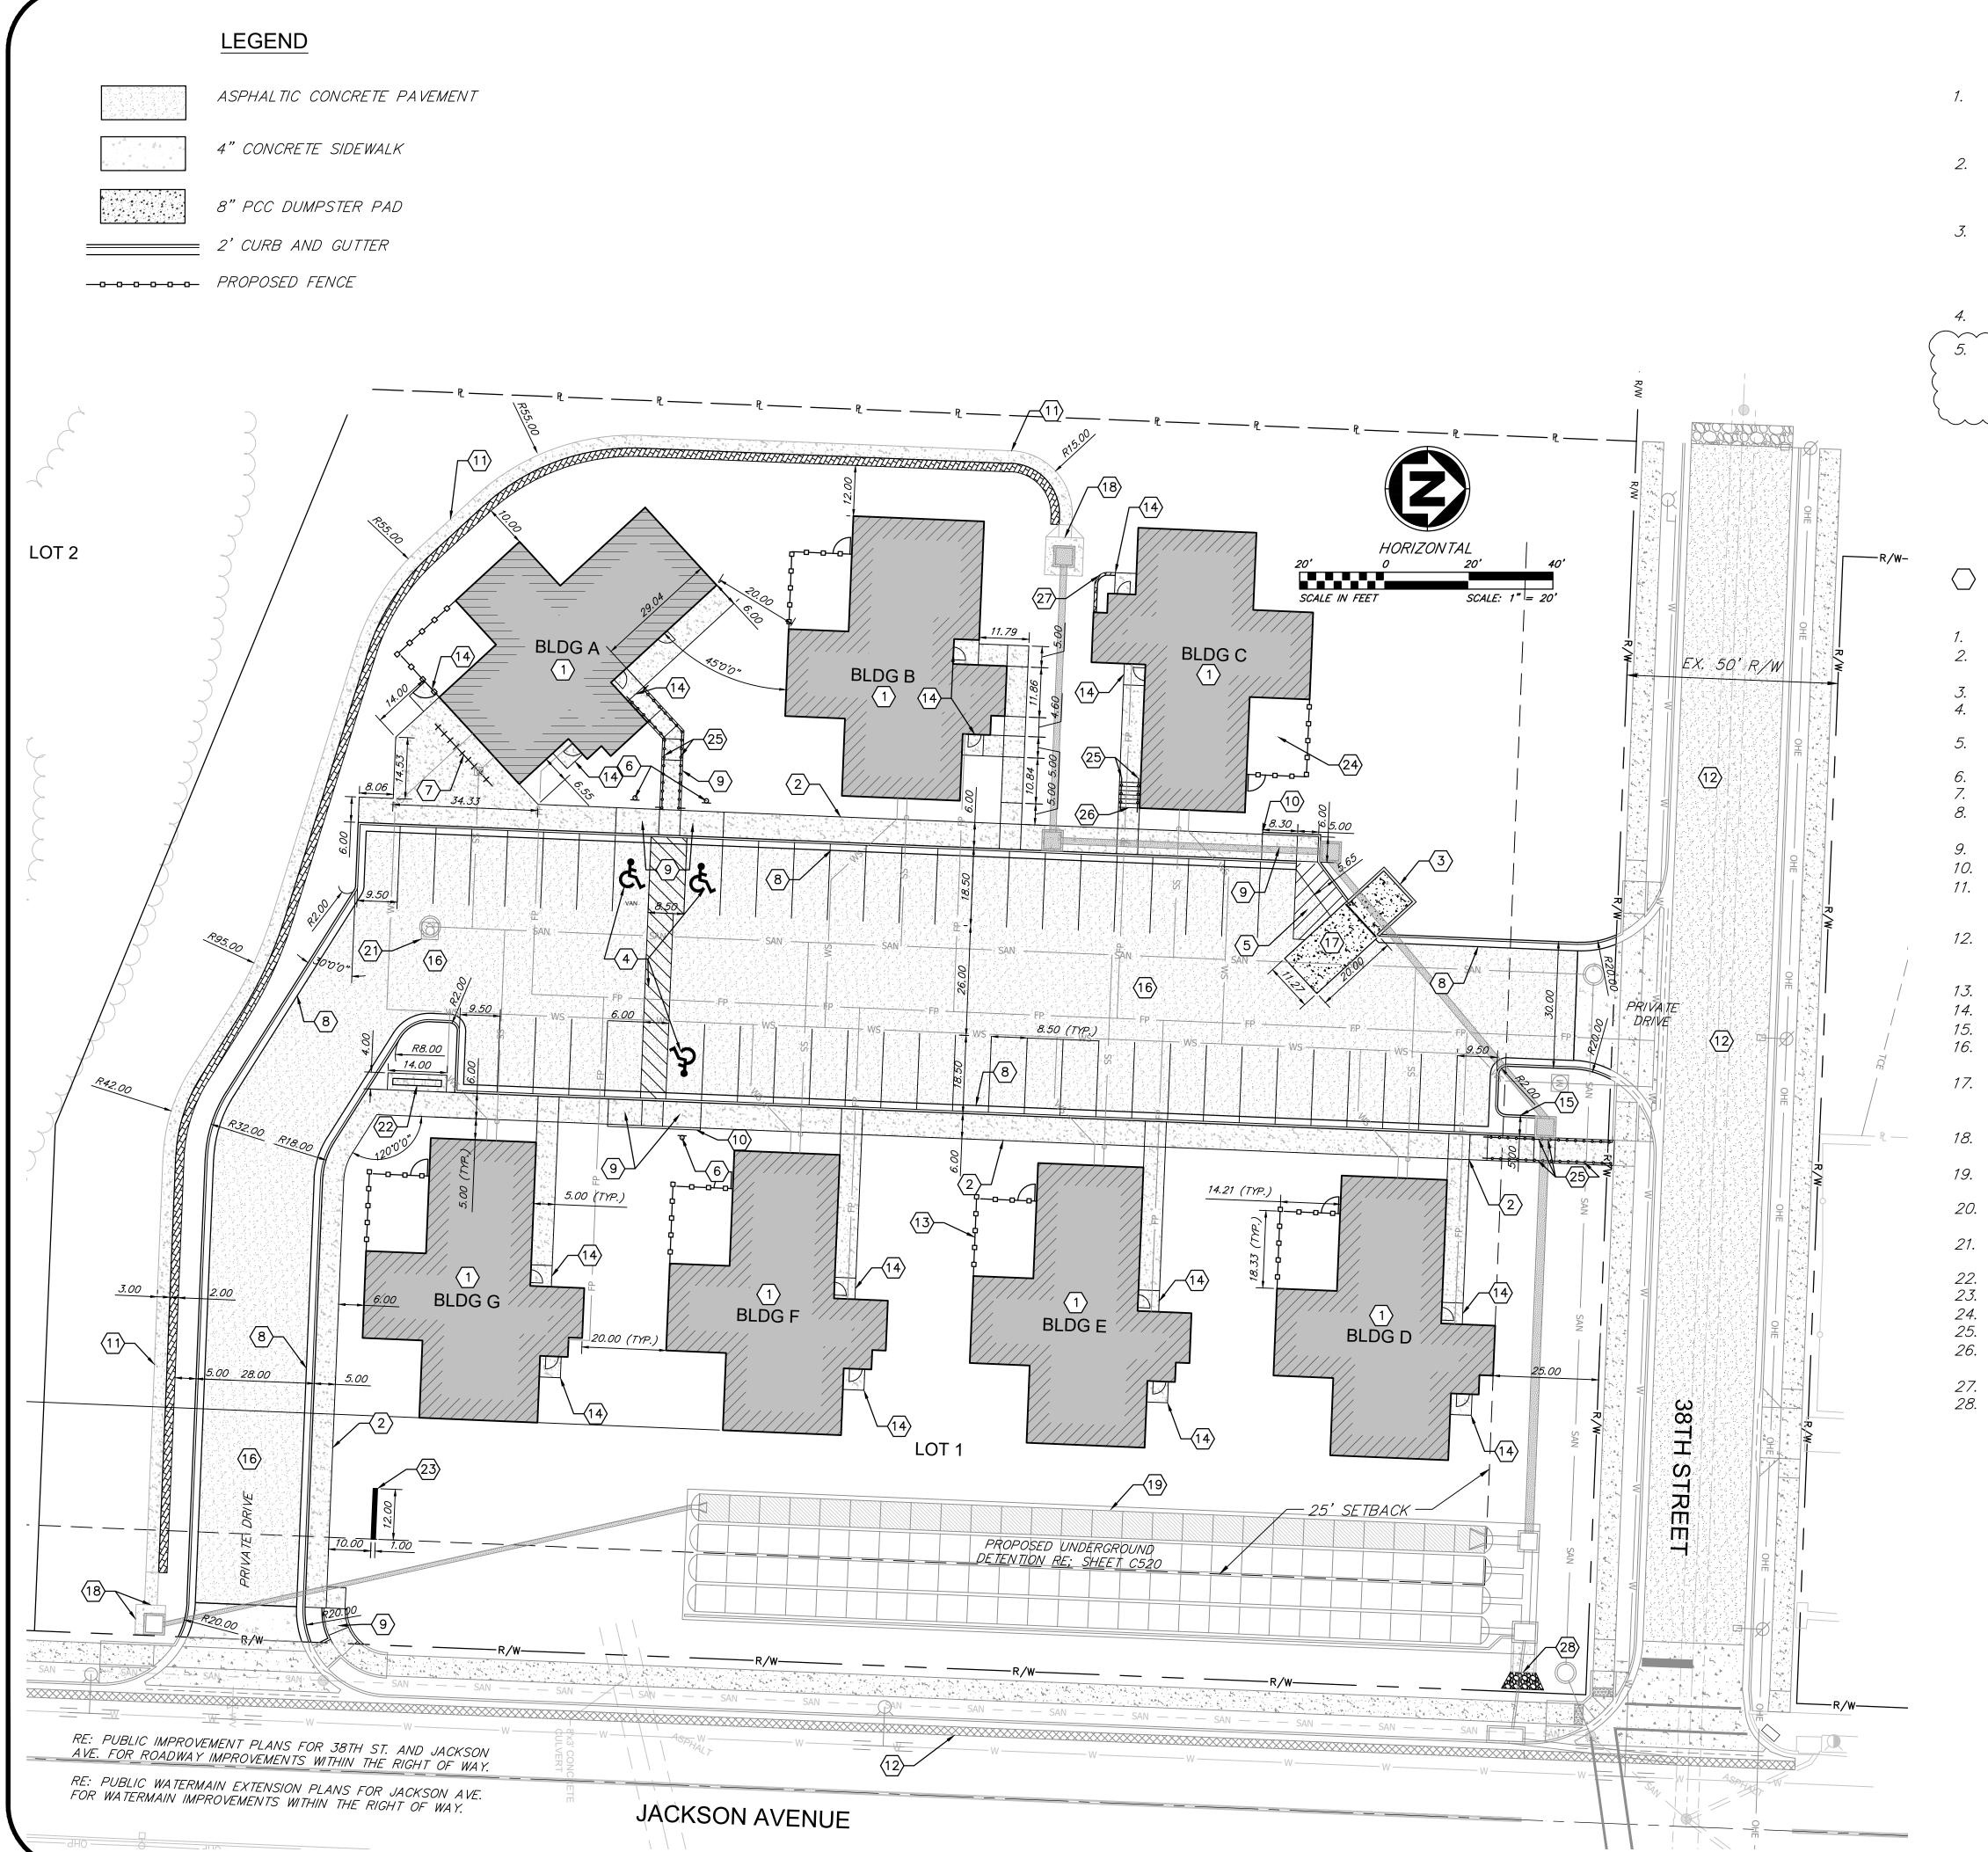

### GENERAL NOTES

- REFER TO ANDERSON ENGINEERING, INC. GEOTECHNICAL REPORT WO #21J030009, DATED MARCH 1ST, 2021 FOR SUBGRADE PREPARATION.
- ALL BUILDINGS ARE SHOWN AS A REFERENCE ONLY. ALL BUILDINGS SHALL BE LOCATED AND CONSTRUCTED PER THE ARCHITECTURAL DRAWINGS PREPARED BY OTHERS.
- ALL SIGNAGE SHALL COMPLY WITH SECTION 88-445 OF THE KANSAS CITY, MISSOURI ZONING AND DEVELOPMENT CODE. THE OWNER SHALL RECEIVE APPROVAL OF A SIGN PERMIT PRIOR TO INSTALLATION.
- ALL STRIPING SHALL BE PAINTED LINES OR SYMBOLS.
- THE DEVELOPER ELECTS TO PAY THE CITY OF KANSAS CITY,
  MISSOURI A SUM OF \$\_\_\_\_\_ IN LIEU OF REQUIRED PARKLAND
  DEDICATING FOR 53 DWELLING UNITS PURSUANT TO SECTION
  88-408-C OF THE ZONING AND DEVELOPMENT CODE.

### CONSTRUCTION NOTES

PROPOSED BUILDING. RE: ARCH PLANS. CONSTRUCT 4" PORTLAND CEMENT CONCRETE SIDEWALK. RE: DETAIL ON SHEET C601. (5818 SF)

CONSTRUCT DUMPSTER ENCLOSURE. RE: ARCH PLANS.
STRIPE ADA PARKING STALLS AND CROSSWALK PER DETAIL ON

SHEET C601. STRIPE OUT AREA BETWEEN PARKING STALL AND DUMPSTER PAD PER DETAIL ON SHEET C601.

INSTALL ADA PARKING SIGNS PER DETAIL ON SHEET C601. BICYCLE PARKING AREA. RE: ARCH PLANS.

2' CURB AND GUTTER (TYPE CG-1). RE: DETAIL ON SHEET C600. (924 LF)

CONSTRUCT ADA RAMP. RE: SHEET C401 SPOT GRADING PLAN.
CONSTRUCT 6" CURB WALL AROUND ADA RAMP AND LANDING.
PROPOSED MSE RETAINING WALL WITH 3' WIDE CONCRETE FLUME
ON TOP OF WALL. RE: BODHI RETAINING WALL PLANS U.S.C FOR
MORE DETAIL.

PROPOSED PUBLIC IMPROVEMENTS TO 38TH STREET AND JACKSON AVE. RE: PUBLIC IMPROVEMENT PLANS FOR 38TH ST. AND JACKSON AVE.

PROPOSED FENCE (TYP.). RE: ARCH PLANS.

PROPOSED 5'x5' CONCRETE STOOP. RE: DETAIL ON SHEET C601.
5' WIDE CONCRETE FLUME TO STORM INLET.

CONSTRUCT ASPHALTIC CONCRETE PAVEMENT SECTION. RE: DETAIL ON SHEET C600. (18,840 SF)

DETAIL ON SHEET C600. (18,840 SF)
CONSTRUCT HEAVY DUTY PORTLAND CEMENT CONCRETE
DUMPSTER PAD PAVEMENT SECTION. RE: DETAIL ON SHEET C600.

DUMPSTER PAD PAVEMENT SECTION. RE: DETAIL ON SHEET C600.
(339 SF)

CONSTRUCT 2' WIDE CONCRETE APRON ON EACH OPEN SIDE OF

EACH FIELD INLET AS SHOWN. RE: DETAIL ON SHEET C602.

CONSTRUCT 7'x5' CONCRETE APRON ON EAST SIDE OF THE

OUTLET CONTROL STRUCTURE. RE: DETAIL ON SHEET C603.

PROPOSED UNDERGROUND DETENTION. RE SHEET C520 FOR MORE

DETAIL.

CONSTRUCT 4'x4' CONCRETE COLLAR AROUND SANITARY SEWER MANHOLE.

PROPOSED MAILBOX PAD. RE: ARCH PLANS FOR MAILBOX DETAIL. CONSTRUCT MONUMENT SIGN. RE: ARCH PLANS FOR SIGN DETAIL. PROPOSED A/C CONDENSER LOCATION (TYP.) RE: MEP PLANS. PROPOSED HANDRAIL. RE: ARCH PLANS FOR HANDRAIL DETAIL. PROPOSED 6" STAIRS. RE ARCH/STRUCTUREAL PLANS FOR STAIR DETAIL AND SHEET C401 FOR SPOT GRADES.

2' LANDSCAPE WALL. RE: SHEET C401 FOR WALL ELEVATIONS. INSTALL RIPRAP PER DETAIL ON SHEET C603.

LE
QUANTITY
R 2-5 & B 1-1
MULTI-UNIT HOUSING
53
44261 SF
164075 SF (3.77 AC.)
37509 SF (0.86 AC.)
43488 SF (1.00 AC.)
5979 SF (0.14 AC.)
53 STALLS
53 STALLS
3 STALLS (1 VAN)
3 STALLS (1 VAN)
5 SPACES
5 SPACES
17 SPACES
20 SPACES
3 STORY (35.0 FT)
0.64 AC




JDB	TAF		3/31/2022	ISSUED FOR: CITY REVIEW	21KC10015	·	
DATE DRAWN BY:	JDB 10-1-2021 CHECK BY:	JDB 2-11-2022 LICENSE NO.	DATE:	ISSUED FOR:	JOB NUMBER: 21KC10015		
DATE	10-1-2021	2-11-2022	JDB 3-31-2022 DATE:				
ВУ	JDB	BOL	BOL			2021	
DESCRIPTION	CITY COMMENTS	CITY COMMENTS	CITY COMMENTS			© COPYRIGHT ANDERSON ENGINEERING, INC. 2021	
NO.	_	2	3				

SITE PLAN


SHEET NUMBER

C2.0
4 OF 17

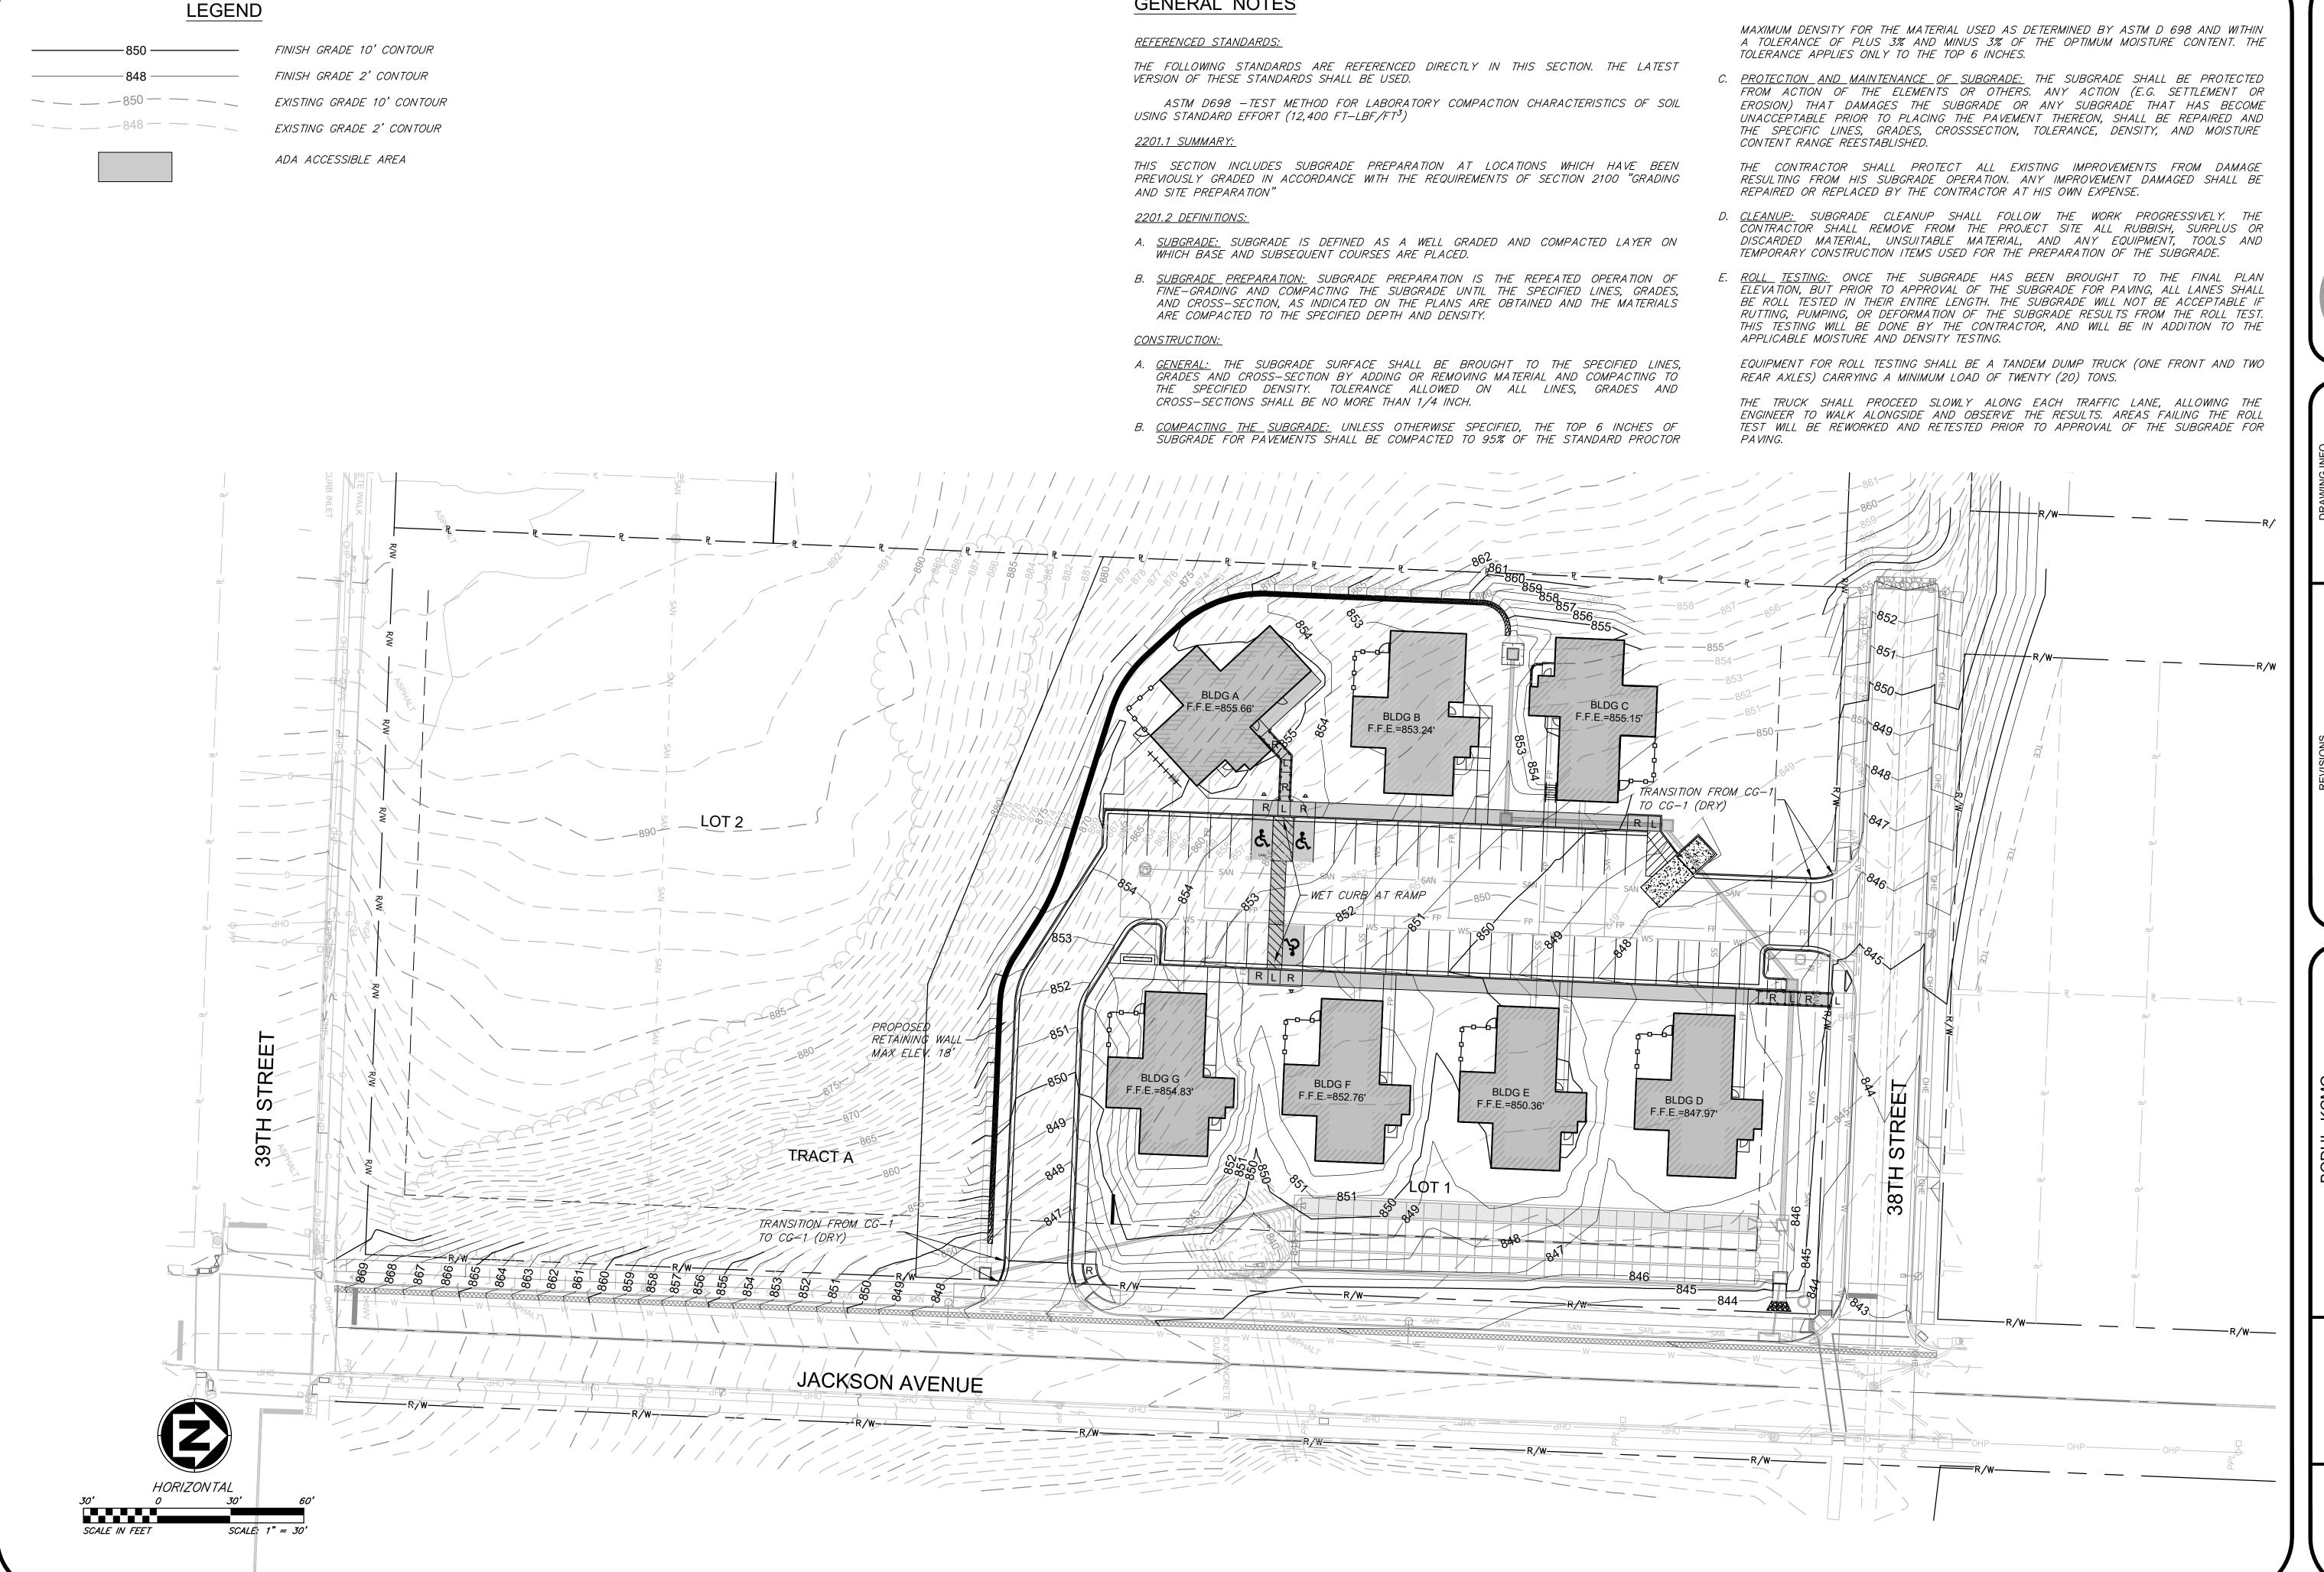

GENERAL NOTES

1			I		
	REVISIONS			DR	DRAWING INFO.
NO.	DESCRIPTION	ВУ	DATE	DATE DRAWN BY:	JDB
_	CITY COMMENTS	JDB	10-1-2021	JDB 10-1-2021 CHECK BY:	ТАЕ
2	CITY COMMENTS	JDB	2-11-2022	JDB 2-11-2022 LICENSE NO.	
3	CITY COMMENTS	JDB	JDB 3-31-2022 DATE:	DATE:	3/31/2022
				ISSUED FOR: CITY REVIEW	CITY REVIEW
				JOB NUMBER: 21KC10015	21KC10015
	© COPYRIGHT ANDERSON ENGINEERING, INC. 2021	2021			

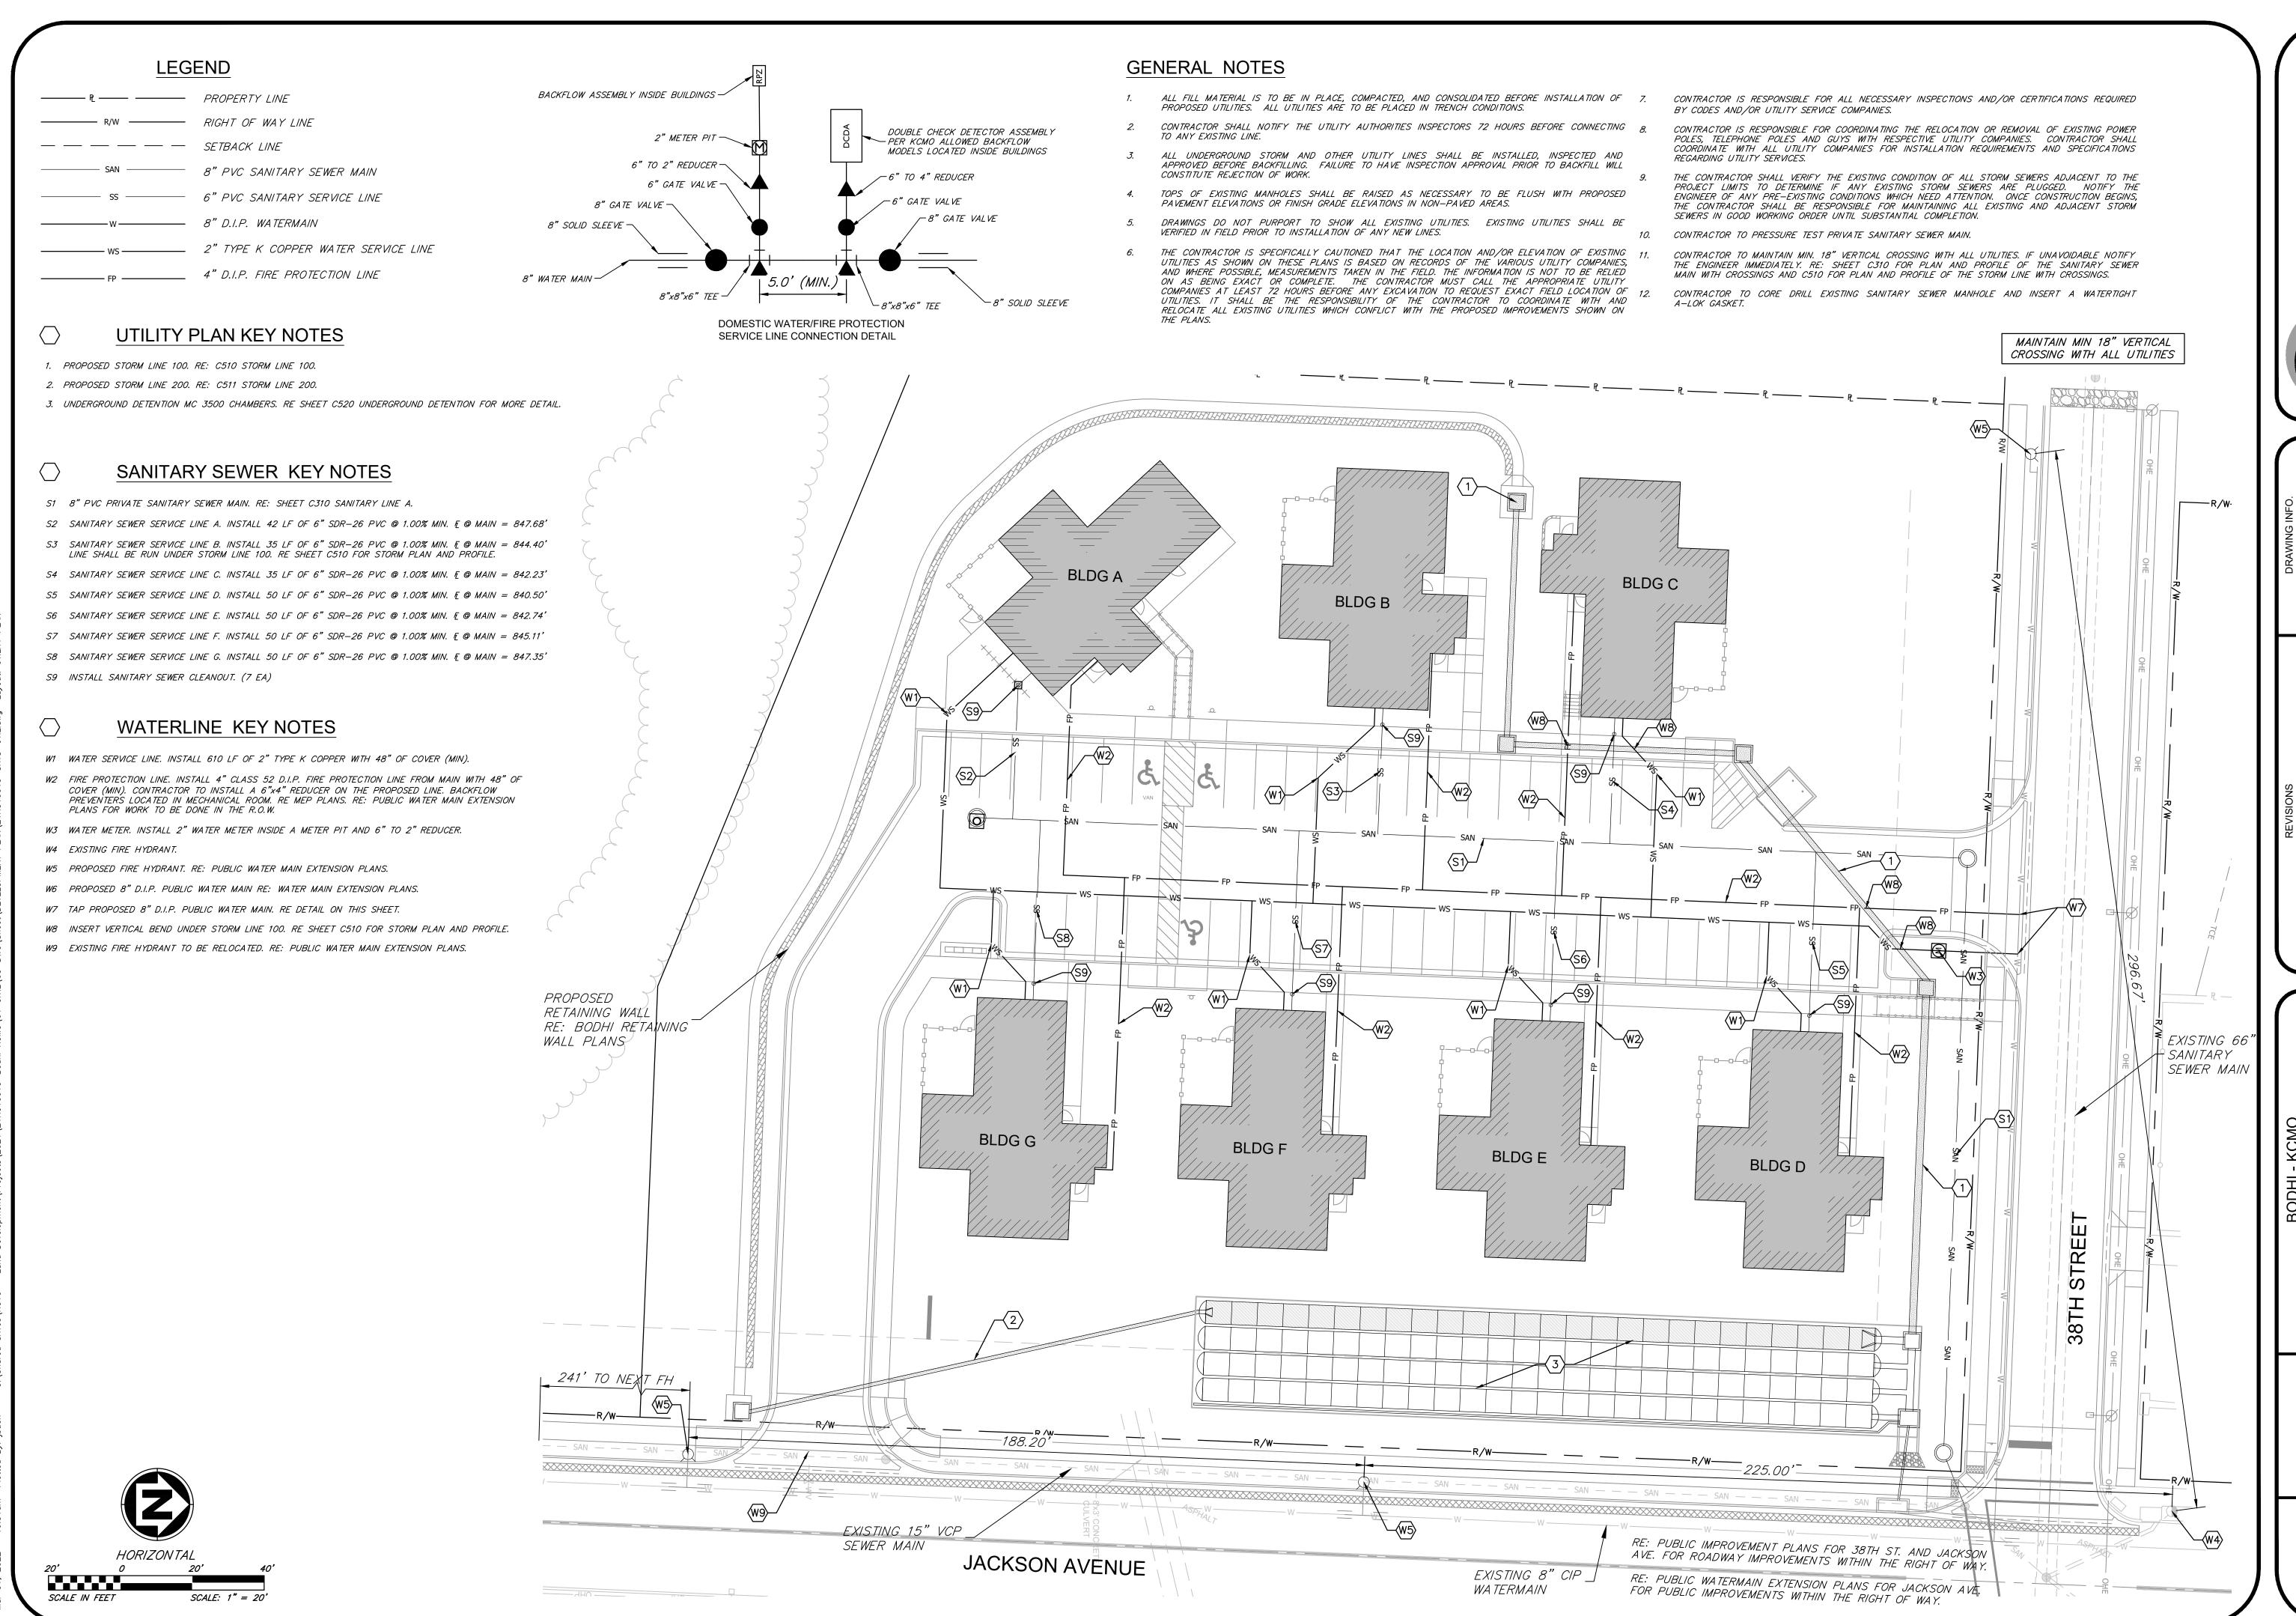

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INGINEE OWNED
YORS -LABORATORIES - DRILLING

EMPI ENGINEERS • SURVEYORS

 DESCRIPTION
 BY
 DATE
 DRAWN BY:
 JDB

 CITY COMMENTS
 JDB
 10-1-2021
 CHECK BY:
 TAF

 CITY COMMENTS
 JDB
 2-11-2022
 LICENSE NO.

 CITY COMMENTS
 JDB
 3-31-2022
 DATE:
 3/31/2022

 CITY COMMENTS
 JDB
 3-31-2022
 CITY REVIEW

 COPYRIGHT ANDERSON ENGINEERING, INC. 2021
 JOB NUMBER:
 21KC10015

UTILITY PLAN

SHEET NUMBER

C4.0
6 OF 17

## Planting Notes Location of all existing utilities needs to done before commencing work. The planting plan graphically illustrates overall plant massings. Each plant species massing shall be placed in the field to utilize the greatest coverage of ground plane. The following applies for individual plantings: a. Creeping groundcover shall be a minimum of 6" from paving edge. b. All trees shall be a minimum of 3' from paving edge. c. All plants of the same species shall be equally spaced apart and placed for best aesthetic viewing. d. All shrubs shall be a minimum of 2' from paved edge. 3. Mulch all planting bed areas to a minimum depth of 3". Mulch individual trees to a minimum depth of 4". 4. Note: If plants are not labeled - they are existing and shall remain. 1. Plant material shall be healthy, vigorous, and free of disease and insects as per 2. Shredded bark mulch installed at trees shall be finely chipped and shredded hardwood chips, consisting of pure wood products and free of all other foreign substances. Pine bark compost mulch installed at planting bed areas shall be free of all other foreign substances. Installation: 1. All planting beds shall be amended with 1 cubic yard of peat moss per 1,000 square feet. Till peat moss into soil to a 6" depth. A 10-10-10 fertilizer shall be spread over all planting areas prior to planting, at a rate of 50 pounds per 2,000 2. After plants have been installed, all planting beds shall be treated with Dacthal pre-emergent herbicide prior to mulch application. 3. Plant pit backfill for trees and shrubs shall be 50% peat or well composted manure and 50% topsoil. 4. Plant material shall be maintained and guaranteed for a period of one year after Owner's acceptance of finished job. All dead or damaged plant material shall be replaced at Landscape Contractor's expense. 6. Landscape contractor shall maintain all plant material until final acceptance, at which point the one year guarantee begins. Landscape Schedule EVERGREEN TREE ORNAMENTAL TRE DECIDUOUS SHRUBS/GRASSES EXISTING EXISTING TREES LANDSCAPE PLAN SCALE: 1"=30'-0"

### Landscape Requirements/Calculations

Common Name Min.Root Min.Size Caliper

Pacific Sunset Maple

Swamp White Oak

Eastern Redbud

Cloud 9 Dogwood

Little Quick Fire Hydrangea

Bloomerang Purple Lilac

One street tree is required for each 30 feet of street frontage. Requirement Met.

2" 6' min. clear., ground to canopy

2" 6' min. clear., ground to canopy 2" 6' min. clear., ground to canopy

2" 6' min. clear., ground to canopy

symmetrical pyramidal form

Plant @ 18" O.C. Plant @ 3' O.C.

Plant @ 4' O.C.

Plant @ 4' 0.C. Plant @ 4' O.C.

Plant @ 24" O.C.

Plant @ 5' 0.C.

1.5"

2' ht.

88-425-LANDSCAPE SCHEDULE	Required	Proposed	Approved
88-425-03 Street Trees	30' o.c.	30' o.c.	
88-425-04 General	n/a		
88-425-05 Perimeter Vehicular Use Area	n/a		
Adjacent to streets	n/a		
Buffer Width	n/a		
Trees	n/a		
Shrub/Wall/Berm	n/a		
Adjacent to Residential Zones	n/a		
Buffer Width	n/a		
Shrub/Wall/Berm	n/a		
88-425-06 Interior Vehicular Use Area	n/a		
Buffer Width	n/a		
Trees (1 per 5 spaces)	11	11	
Shrubs (1 per 1 space)	53	53	
88-425-07 Parking Garage Screening	n/a		
88-425-08 Mech./Utility Equip. Screening	Screening pro	ovided per re	quirements.
88-425-09 Outdoor Use Screening	n/a		

### LANDSCAPE ARCHITECTURE 15245 Metcalf Ave. Overland Park, KS 66223 913.787.2817




CLIENT

The Vecino Group 305 W Commercial St. Springfield, MO 65803

### **PROJECT**

Bodhi Kansas City 3840 Jackson Ave. Kansas City, MO 64128

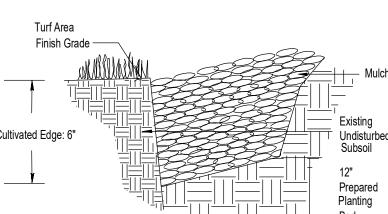

Acer x truncatum 'Warrenred'

Gleditsia triacanthas 'Skyline'

Juniperus chinensis 'Keteleeri'

Cornus florida 'Cloud Nine'


Festuca ovina glauca

Acer griseum

Cercis canadensis

# 2 CULTIVATED EDGE DETAIL SCALE: NTS

TREE PLANTING NOTES:  1) DO NOT HEAVILY PRUNE THE TREE, PRUNE ONLY CROSSOVER LIMBS, CO-DOMINANT	GALV, 12-GAUGE ON PERENNIAL	BED OF MULCH PLANT BED,	
LEADERS, & BROKEN OR DEAD BRANCHES. SOME INTERIOR TWIGS & LATERAL BRANCHES MAY BE PRUNED. DO NOT REMOVE THE TERMINAL BUDS OF BRANCHES THAT	DO NOT COVER  2) TIGHTEN WIRE / CABLE ONLY ENOUGH TO KEEP FROM 3) BREAK UP E) 3 BREAK UP E)	Y MIX PEAT IN	DO NOT PRUNE LEADER
EXTEND TO THE EDGE OF THE CROWN  2) MARK THE NORTH SIDE OF THE TREE IN THE NURSERY, AND ROTATE	SLIPPING, ALLOW FOR SOME TRUNK MOVEMENT PLASTIC HOSE SHALL BE LONG  3) BREAK UP E) TO A DEPTH OF	24" W TOPSOIL	PRUNE DAMAGED OR DEAD WOOD IMMEDIATELY PRIOR TO PLANTING. NEVER LEAVE
TREE TO FACE NORTH AT THE SITE WHENEVER POSSIBLE  3) SET TOP OF ROOT BALL 1-2 INCHES	OD CONTAINED	AT SAME DEPTH REW IN THE FIELD	LEAVE "V" CROTCHES OR DOUBLE LEADER.  TREE TIE SYSTEM, SEE STAKING REQUIREMENTS
HIGHER THAN SURROUNDING GRADE  4) APPLY 4"THK WOOD MULCH, DO NOT PLACE MULCH IN DIRECT CONTACT	3) STAKES SHALL BE 2"X 2" HARDWOOD OR EQUAL IN ACCORDANC HORTICULTURA	I & SHAPE SHRUBS E w/ STANDARD	3 METAL STAKES. PLACE NEXT TO ROOT BALL AS SHOWN. SPACE EQUIDISTANT AROUND TREE.
w/ TREE TRUNK  5) EACH TREE MUST BE PLANTED	WH COI	FIAL WATERING: EN BACKFILL IS 2/3 MPLETE, WATER	4" MIN. SPECIFIED MULCH PLANT ROOT BALL 2" HIGHER THAN GRADE
SUCH THE TRUNK FLARE IS VISIBLE AT THE TOP OF THE ROOT BALL. TREES WHERE THE FLARE IS NOT VISIBLE SHALL BE REJECTED.  MULCH RING MIN 6' DIA	THC MO	DROUGHLY UNTIL NO.	AT WHICH TREE GREW.  INSTALL WEED CONTROL FABRIC IF TREE IS IN LANDSCAPE BED
DO NOT COVER THE TOP OF THE ROOT BALL W/ SOIL  6) REMOVE ALL TWINE, ROPE, WIRE AND BURLAP FROM THE UPPER 1/3 OF			CONTINUOUS SAUCER, RIM FOR WATER & MULCH CUT & REMOVE BURLAP FROM TOP 1/3 OF BALL. SPECIFIED BACKFILL MIXTURE
ROOT BALL (REMOVE WIRE BASKETS)  7) PLACE ALL ROOT BALLS ON UN- EXCAVATED OR TAMPED SOIL, TYP	BACKFILL W/ SUITABLE TOPSOIL, TYP	ROOT BALL 1/2	EXISTING UNDISTURBED SUBSOIL  DIAMOF BALL
PLANTING INSTALLATION DETAIL	S	NOOT BALL \$ 1/2	DIANUI DALL
JOALL. NIJ			

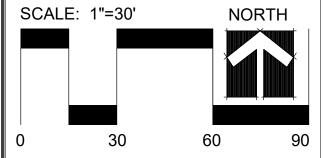

Date: 1.4.2022 Project #: 824 Landscape Plan

1) 1ST FLOOR - BLDG A - COMMUNITY SPACE

### **GENERAL NOTES**

- 1. PROVIDE SOLID 2X8 WALL BLOCKING / REINFORCING AT TOILETS AND SHOWERS IN ALL UNITS PER SHEETS G-002 AND G-003. GRAB BARS ARE TO BE INSTALLED AT TOILET AND TUB/SHOWER LOCATIONS IN "TYPE A" UNITS ONLY.
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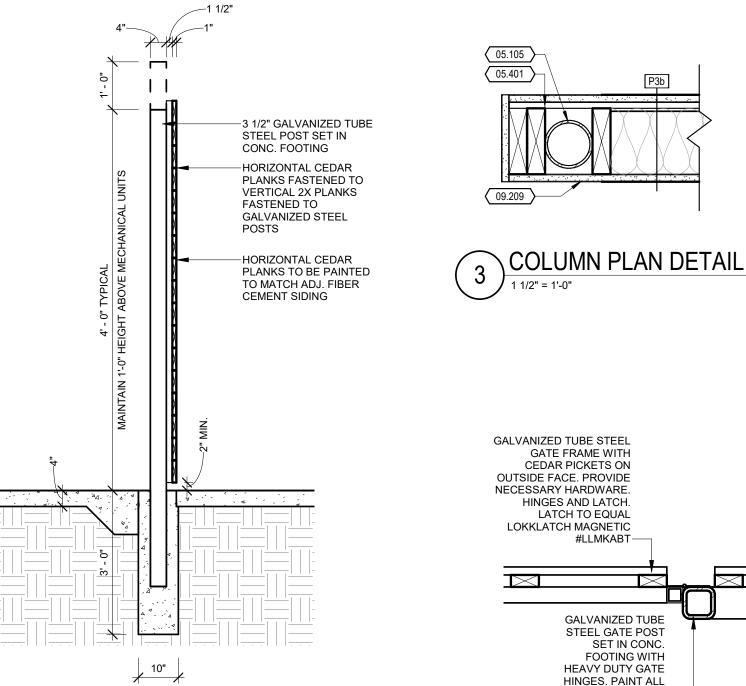
- ALIGN FINISHED FACES. 05.105 PIPE COLUMN PER STRUCTURAL.
- 05.401 1/2" RESILIENT CHANNEL
- ALUMINUM DOWNSPOUTS. SEE ROOF PLAN FOR LOCATIONS AND SIZES. COLOR TO MATCH ADJACENT 07.702 WALL SURFACE COLOR. SPLASHBLOCKS ARE TO BE PROVIDED AT ALL DOWNSPOUT LOCATIONS.
- 09.209 5/8" GYPSUM BOARD
- 21.001 SURFACE-MOUNTED FIRE DEPARTMENT KNOX BOX. MOUNT TOP OF KNOX BOX 6'-0" MAX. ABOVE FINISHED GRADE / WALKING SURFACE.
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### FIRE RATING / EGRESS LEGEND

EGRESS ROUTE ACCESSIBILITY ROUTE 1 HOUR FIRE RATED WALL 2 HOUR RATED WALL

FIRE EXTINGUISHER



SCREENWALL SECTION - STEEL FRAME

1/2" = 1'-0"

PLAN NORTH TRUE NORTH

SCREENWALL GATE JAMB DTL

STEEL BLACK.—

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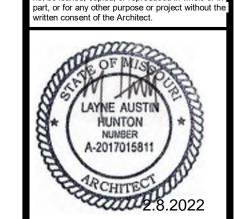
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CONTACT: NAOMI FISHER

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BUILDING A OVERAL FIRST FLOOR

\1ST FLOOR - BLDG B

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FIRE EXTINGUISHER

EGRESS ROUTE ACCESSIBILITY ROUTE 1 HOUR FIRE RATED WALL

2 HOUR RATED WALL

PLAN NORTH

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ROJECT NUMBER: 20460

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FIRST FLOOR

**BUILDING B OVERALI** 

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PLAN NORTH

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DATE: 2/4/2022 ROJECT NUMBER: 20460

DPYRIGHT: © 2022 VECINO DESIGN **BUILDING C-G FIRST** 

FLOOR

1) 1ST FLOOR - BLDG C-G

TYPICAL 2ND FLOOR - BLDG A-G

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- RATED ASSEMBLIES. 3. U.L. CLASSIFIED GLASS FIBER BATT INSULATION MAY BE SUBSTITUTED WITH MINERAL WOOL BATT INSULATION (SAME 'R' VALUE). REFER
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- 6. THE BUILDING ENVELOPE AND INTERIOR DWELLING UNIT DEMISING / CORRIDOR WALLS MUST BE THOROUGHLY SEALED TO PASS AIR INFILTRATION TESTING AS REQUIRED UNDER THE EARTHCRAFT CERTIFICATION PROCESS. INSTALL WATER-BASED ELASTOMERIC SPRAY SEALANT EQUAL TO GREAT STUFF PRO GASKET BY DOW TO SEAL INTERIOR TOP AND BOTTOM PLATE AND ALL DOOR AND WINDOW PERIMETER OPENINGS (INSTALL PER MANUFACTURE REQUIREMENTS), GREAT STUFF PRO GASKET MUST BE INSTALLED BY TRAINED APPLICATORS. INSTALL FULL STRIPS OF SILL SEAL FOAM GASKET ALONG TOP PLATES AND BOTTOM PLATES INTERIOR AND EXTERIOR. CAULK ALL DUCT WALL PENETRATIONS, ELECTRICAL CONDUIT / BOX WALL PENETRATIONS, AND LIGHT FIXTURE BOX PENETRATIONS. CONTRACTOR TO CONSULT WITH PROJECT'S EARTHCRAFT RATER REGARDING APPLICATION AREAS, BEST PRACTICES, AND METHODS PRIOR TO PROCEEDING WITH INSTALLATION.
- 7. ALL WALL AND PARTITION ASSEMBLIES (FIRE-RATED AND NON-RATED), THROUGH WALL PENETRATIONS (PLUMBING, HVAC, ELECTRICAL), WINDOW AND DOOR OPENINGS, AND ROOF ASSEMBLY PENETRATIONS SHALL HAVE HIGH-GRADE, LOW / NO VOC PERIMETER SEALANT INSTALLED (USE FIRESTOP SEALANT WHERE REQUIRED) TO FORM AN AIR-TIGHT ENVELOPE. COORDINATE FRAMERS, PLUMBERS, HVAC INSTALLERS, INSULATORS, AND DRYWALL TRADES TO MÍNIMIZE UNCONTROLLED AIR LEAKAGE PATHWAYS BETWEEN RESIDENTIAL UNITS BY SEALING ALL PENETRATIONS IN WALLS, CEILINGS, AND FLOORS IN THE UNITS.
- NOTE: DIMENSIONS ARE TO FACE OF STUD UNLESS NOTED OTHERWISE. REFER TO ENLARGED UNIT PLANS FOR ADDITIONAL DETAILS.

### **KEYNOTE LEGEND**

- 07.702 ALUMINUM DOWNSPOUTS. SEE ROOF PLAN FOR LOCATIONS AND SIZES. COLOR TO MATCH ADJACENT WALL SURFACE COLOR. SPLASHBLOCKS ARE TO BE PROVIDED AT ALL DOWNSPOUT LOCATIONS.
- WALL MOUNTED FIRE EXTINGUISHER

### FIRE RATING / EGRESS LEGEND



PLAN NORTH

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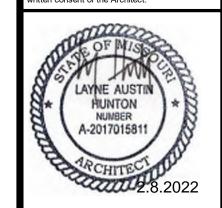
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SECOND FLOOR

TYPICAL 3RD FLOOR - BLDG A-G

### **GENERAL NOTES**

- 1. PROVIDE SOLID 2X8 WALL BLOCKING / REINFORCING AT TOILETS AND SHOWERS IN ALL UNITS PER SHEETS G-002 AND G-003. GRAB BARS ARE TO BE INSTALLED AT TOILET AND TUB/SHOWER LOCATIONS IN "TYPE A" UNITS ONLY.
- 2. REFER TO OVERALL PLANS FOR "TYPE A" UNIT LOCATIONS 3. ALLOW INSPECTION OF WALL INSULATION, INCLUDING FRAMING, PRE-DRYWALL INSTALLATION AND POST-DRYWALL CONSTRUCTION.
- NOTIFY RESPONSIBLE PARTY PRIOR TO ENCLOSING WALL INSULATION IN AREAS DESIGNATED FOR INSPECTIONS. 4. THE DWELLING UNITS SHALL BE TESTED AND VERIFIED AS HAVING AN AIR LEAKAGE RATE OF LESS THAN 0.3 CFM PER SQUARE FOOT OF THE ENCLOSURE BOUNDING THE APARTMENT AT AN INDUCED PRESSURE DIFFERENCE OF 50 PASCALS. TESTING MAY BE PERFORMED IN ACCORDANCE WITH EITHER ASTM E779 OR ASTM E1827. TESTING WILL BE PERFORMED BY OWNER'S REPRESENTATIVE AT ANY TIME AFTER

THE CREATION OF ALL PENETRATIONS WITHIN THE APARTMENT AIR BARRIER. SAMPLING REQUIREMENTS AS PER THE ENERGY STAR

MULTIFAMILY HIGH RISE PROGRAM. 5. CONFIRM EXTERIOR WALL TAGS MATCH EXTERIOR ELEVATIONS. WHEN THERE IS A CONFLICT, THE INTENT FROM THE EXTERIOR ELEVATIONS SHALL TAKE PRECEDENT.

### GENERAL WALL AND PARTITION NOTES

- CONTRACTOR SHALL REFERENCE SPECIFIED U.L. ASSEMBLIES ON G-SERIES SHEETS OR IN SPECIFICATIONS FOR ALLOWABLE PRODUCTS
  / MATERIALS AND THEIR RESPECTIVE INSTALLATION REQUIREMENTS.

   INSTALL MOISTURE-RESISTANT GYPSUM BOARD AT BATHROOM WALL FACES. GYPSUM BOARD SHALL BE U.L. CLASSIFIED AT
- 3. U.L. CLASSIFIED GLASS FIBER BATT INSULATION MAY BE SUBSTITUTED WITH MINERAL WOOL BATT INSULATION (SAME 'R' VALUE). REFER
- TO U.L. ASSEMBLIES FOR INSTALLATION REQUIREMENTS. 4. UNIT DEMISING WALLS AND CORRIDOR WALLS SHALL HAVE A 50 STC RATING (MINIMUM). PROVIDE LEVEL 03 GYPSUM BOARD FINISH WITH ORANGE PEEL TEXTURE / FINISH (TYPÍCAL AT INTERIOR WALL SURFACES). PRIME AND
- 6. THE BUILDING ENVELOPE AND INTERIOR DWELLING UNIT DEMISING / CORRIDOR WALLS MUST BE THOROUGHLY SEALED TO PASS AIR INFILTRATION TESTING AS REQUIRED UNDER THE EARTHCRAFT CERTIFICATION PROCESS. INSTALL WATER-BASED ELASTOMERIC SPRAY SEALANT EQUAL TO GREAT STUFF PRO GASKET BY DOW TO SEAL INTERIOR TOP AND BOTTOM PLATE AND ALL DOOR AND WINDOW PERIMETER OPENINGS (INSTALL PER MANUFACTURE REQUIREMENTS), GREAT STUFF PRO GASKET MUST BE INSTALLED BY TRAINED APPLICATORS. INSTALL FULL STRIPS OF SILL SEAL FOAM GASKET ALONG TOP PLATES AND BOTTOM PLATES INTERIOR AND EXTERIOR. CAULK ALL DUCT WALL PENETRATIONS, ELECTRICAL CONDUIT / BOX WALL PENETRATIONS, AND LIGHT FIXTURE BOX PENETRATIONS. CONTRACTOR TO CONSULT WITH PROJECT'S EARTHCRAFT RATER REGARDING APPLICATION AREAS, BEST PRACTICES, AND METHODS
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  INSTALLED (USE FIRESTOP SEALANT WHERE REQUIRED) TO FORM AN AIR-TIGHT ENVELOPE. COORDINATE FRAMERS, PLUMBERS, HVAC INSTALLERS, INSULATORS, AND DRYWALL TRADES TO MINIMIZE UNCONTROLLED AIR LEAKAGE PATHWAYS BETWEEN RESIDENTIAL UNITS
- BY SEALING ALL PENETRATIONS IN WALLS, CEILINGS, AND FLOORS IN THE UNITS. 8. NOTE: DIMENSIONS ARE TO FACE OF STUD UNLESS NOTED OTHERWISE.
- 9. REFER TO ENLARGED UNIT PLANS FOR ADDITIONAL DETAILS.

### **KEYNOTE LEGEND**

- 07.702 ALUMINUM DOWNSPOUTS. SEE ROOF PLAN FOR LOCATIONS AND SIZES. COLOR TO MATCH ADJACENT WALL SURFACE COLOR. SPLASHBLOCKS ARE TO BE PROVIDED AT ALL DOWNSPOUT LOCATIONS.
- WALL MOUNTED FIRE EXTINGUISHER

### FIRE RATING / EGRESS LEGEND

EGRESS ROUTE ACCESSIBILITY ROUTE

2 HOUR RATED WALL

PLAN NORTH

FIRE EXTINGUISHER

\_\_\_\_ 1 HOUR FIRE RATED WALL

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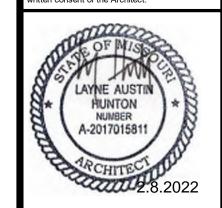
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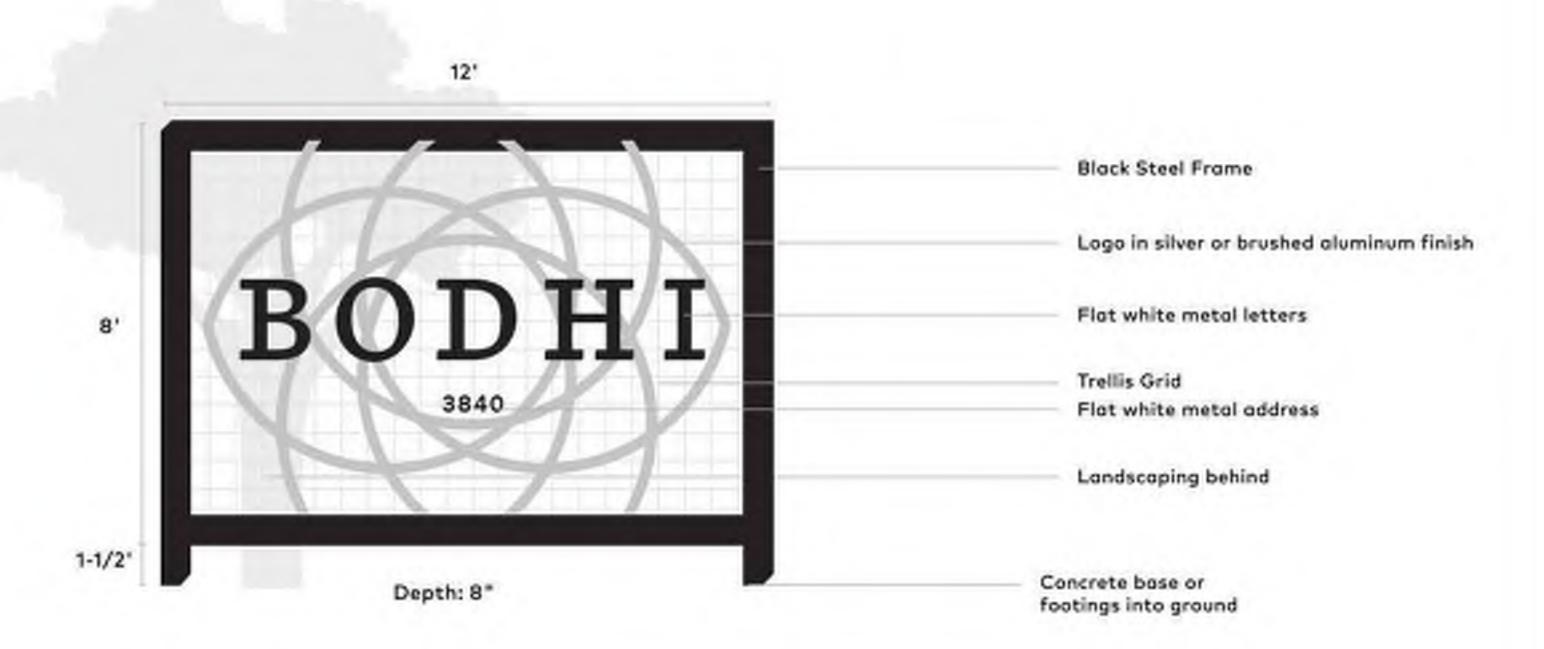
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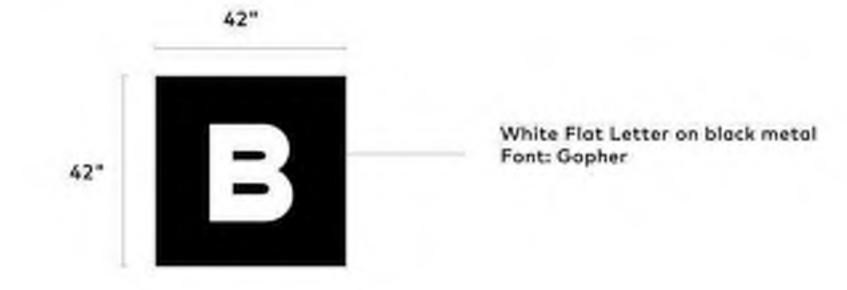
FLOOR PLAN

**BUILDING A-G THIRD** 




Illumination: Ground lights CREATIVE WILL PROVIDE DESIGN FILES

ADDRESS SIGNS PER BUILDING



Letters B, C, D, E, F, G to be produced

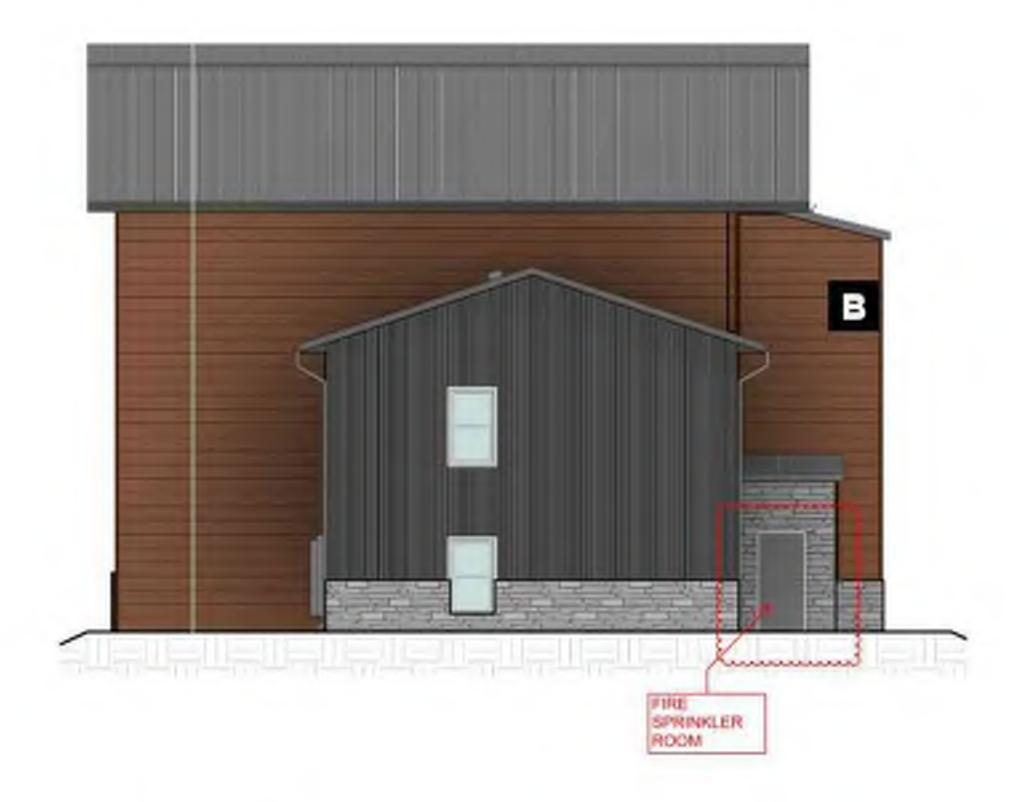

SIGNAGE PLACEMENT: BUILDING B



SIGNAGE PLACEMENT: BUILDING C-G

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**BUILDING SIGNAGE** 

### SIGNAGE PLACEMENTS





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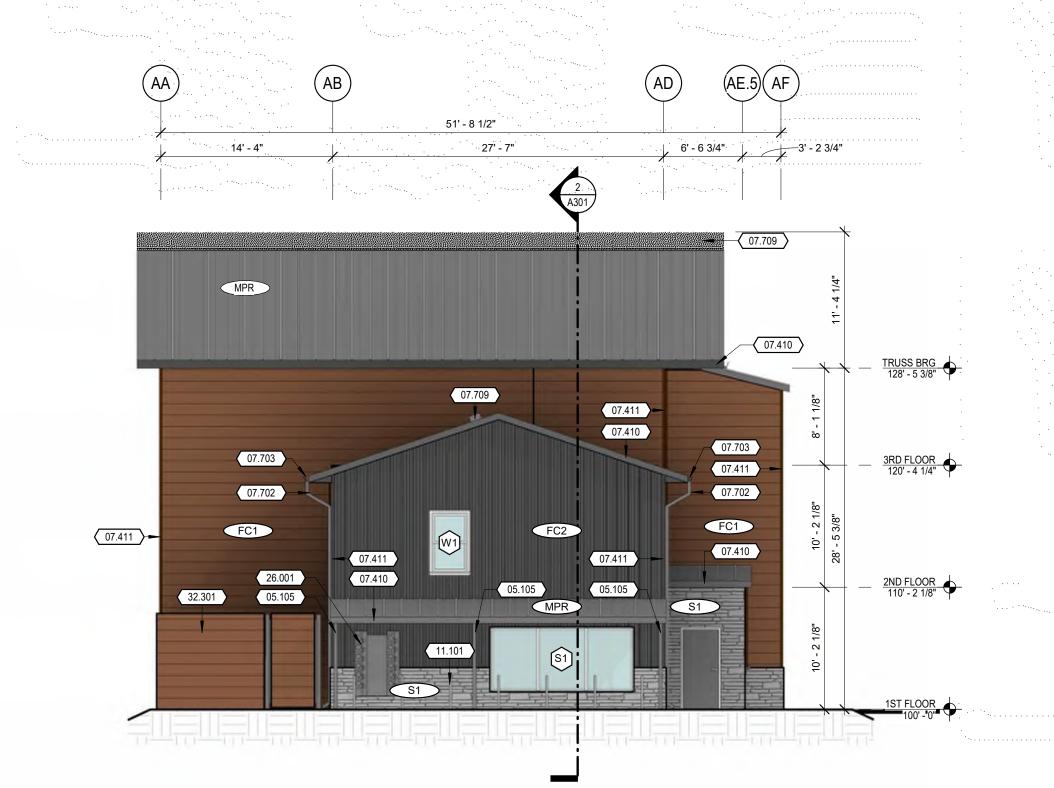
NORTH ELEVATION - BLDG A - COMMUNITY BUILDING

07.411

27' - 3"


07.703

07.411



WEST ELEVATION - BLDG A - COMMUNITY BUILDING

SOUTH ELEVATION - BLDG A - COMMUNITY BUILDING

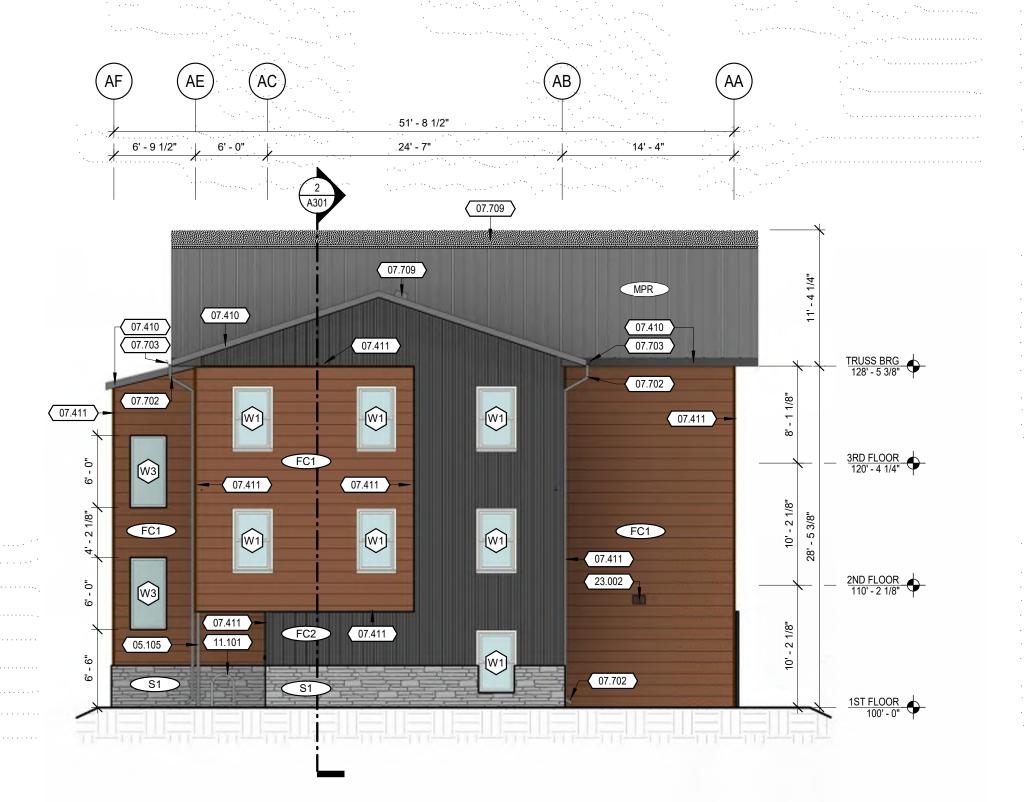

65' - 11"

23.002

20' - 5 1/2"

FC1

07.411

18' - 2 1/2"

FC2

26.001 11.101

> EAST ELEVATION - BLDG A - COMMUNITY BUILDING

### **KEYNOTE LEGEND**

05.105 PIPE COLUMN PER STRUCTURAL. 07.410

FIBER CEMENT FASCIA

FIBER CEMENT TRIM. SLOPE WITH ROOF WHERE APPLICABLE.

07.411 ALUMINUM DOWNSPOUTS. SEE ROOF PLAN FOR LOCATIONS AND SIZES. COLOR TO MATCH ADJACENT WALL SURFACE COLOR. SPLASHBLOCKS ARE TO BE PROVIDED AT ALL DOWNSPOUT LOCATIONS. INSTALL 4" PRE-FINISHED METAL GUTTER WITH BOX STYLE PROFILE. CONNECT GUTTER TO WALL DOWNSPOUT AT BUILDING. GUTTER AND DOWNSPOUT FINISH TO MATCH FACIA.

ROOF VENT. PLACE PER MANUFACTURER RECOMMENDATIONS \*U-RACK BICYCLE RACK - SURFACE MOUNTED INTO CONCRETE SIDEWALK

SURFACE-MOUNTED FIRE DEPARTMENT KNOX BOX. MOUNT TOP OF KNOX BOX 6'-0" MAX. ABOVE

FINISHED GRADE / WALKING SURFACE. FIRE DEPARTMENT CONNECTION (FDC) INSTALLED IN ACCORDANCE WITH NFPA SYSTEM REQUIREMENTS. REFER TO PLUMBING DRAWINGS FOR ADDITIONAL INFORMATION. INSTALL KNOX FIRE DEPARTMENT SECURITY CAPS ON EACH FIRE DEPARTMENT CONNECTION PER THE FIRE MARSHAL AND LOCAL

FURNISH AND INSTALL EXTERIOR-GRADE METAL SIGN AT EACH FIRE DEPARTMENT CONNECTION. SIGN SHALL CONSIST OF 1 INCH TALL (MINIMUM) RAISED LETTERS ON A CONTRASTING COLOR BACKGROUND THAT READ: FIRE DEPARTMENT CONNECTION OR FIRE HOSE CONNECTION OR FIRE DEPARTMENT SPRINKLER CONNECTION OR A COMBINATION THEREOF AS APPLICABLE.

WALL VENT. COLOR MATCH TO ADJ. FIBER CEMENT PANELS: ELECTRIC METER BANK, DISCONNECT, AND PULL BOX: CONTRACTOR TO COORDINATE ELECTRIC SERVICE, LOCATIONS, AND INSTALLATION. REFER TO ELECTRICAL DRAWINGS AND LOCAL ELECTRIC

SERVICE REQUIREMENTS MANUAL FOR ADDITIONAL INFORMATION. CEDAR PICKET FENCE WITH STEEL GATE FRAME. REFER TO SHEET A101 FOR DETAILS.

### MATERIAL LEGEND

FIBER CEMENT BOARD & BATTEN SIDING

THIN STONE VENEER

**ASPHALT SHINGLE ROOF** 

**METAL STANDING SEAM ROOF** 

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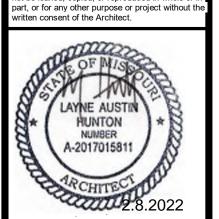
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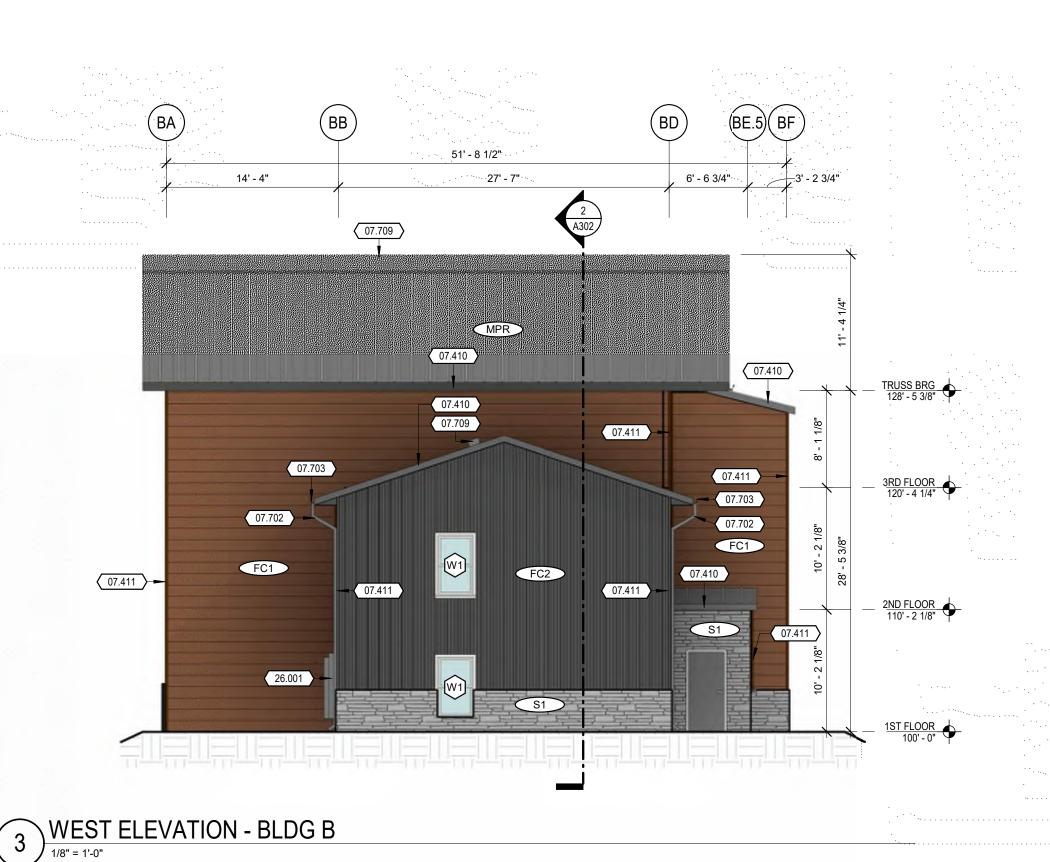
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**ELEVATIONS** 

BUILDING A



07.411



**KEYNOTE LEGEND** 

07.410 FIBER CEMENT FASCIA

FIBER CEMENT TRIM. SLOPE WITH ROOF WHERE APPLICABLE.

. 07.411 ALUMINUM DOWNSPOUTS. SEE ROOF PLAN FOR LOCATIONS AND SIZES. COLOR TO MATCH ADJACENT WALL SURFACE COLOR. SPLASHBLOCKS ARE TO BE PROVIDED AT ALL DOWNSPOUT

INSTALL 4" PRE-FINISHED METAL GUTTER WITH BOX STYLE PROFILE. CONNECT GUTTER TO WALL DOWNSPOUT AT BUILDING. GUTTER AND DOWNSPOUT FINISH TO MATCH FACIA.

ROOF VENT. PLACE PER MANUFACTURER RECOMMENDATIONS SURFACE-MOUNTED FIRE DEPARTMENT KNOX BOX. MOUNT TOP OF KNOX BOX 6'-0" MAX. ABOVE

FINISHED GRADE / WALKING SURFACE. FIRE DEPARTMENT CONNECTION (FDC) INSTALLED IN ACCORDANCE WITH NFPA SYSTEM REQUIREMENTS. REFER TO PLUMBING DRAWINGS FOR ADDITIONAL INFORMATION. INSTALL KNOX FIRE DEPARTMENT SECURITY CAPS ON EACH FIRE DEPARTMENT CONNECTION PER THE FIRE

MARSHAL AND LOCAL ORDINANCES. FURNISH AND INSTALL EXTERIOR-GRADE METAL SIGN AT EACH FIRE DEPARTMENT CONNECTION. SIGN SHALL CONSIST OF 1 INCH TALL (MINIMUM) RAISED LETTERS ON A CONTRASTING COLOR BACKGROUND THAT READ: FIRE DEPARTMENT CONNECTION OR FIRE HOSE CONNECTION OR FIRE DEPARTMENT SPRINKLER CONNECTION OR A COMBINATION THEREOF AS APPLICABLE.

WALL VENT. COLOR MATCH TO ADJ. FIBER CEMENT PANELS. ELECTRIC METER BANK, DISCONNECT, AND PULL BOX. CONTRACTOR TO COORDINATE ELECTRIC SERVICE, LOCATIONS, AND INSTALLATION. REFER TO ELECTRICAL DRAWINGS AND LOCAL ELECTRIC SERVICE REQUIREMENTS MANUAL FOR ADDITIONAL INFORMATION.

CEDAR PICKET FENCE WITH STEEL GATE FRAME. REFER TO SHEET A101 FOR DETAILS.

### MATERIAL LEGEND











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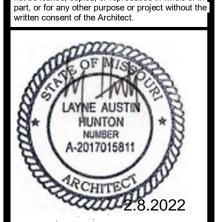
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CONTACT: NAOMI FISHER

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**ELEVATIONS** 

SOUTH ELEVATION - BLDG C-G

WEST ELEVATION - BLDG C-G

NORTH ELEVATION - BLDG C-G

27' - 3"


FC2


32.301

07.703

07.411

07.702

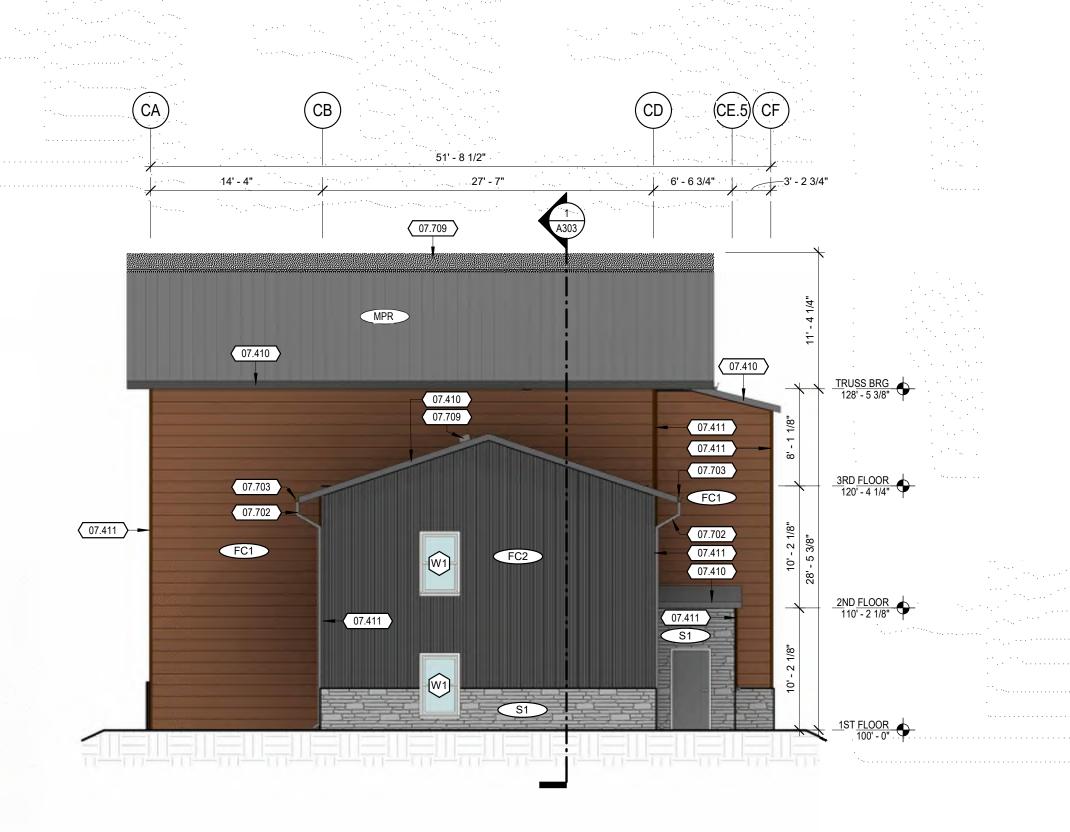

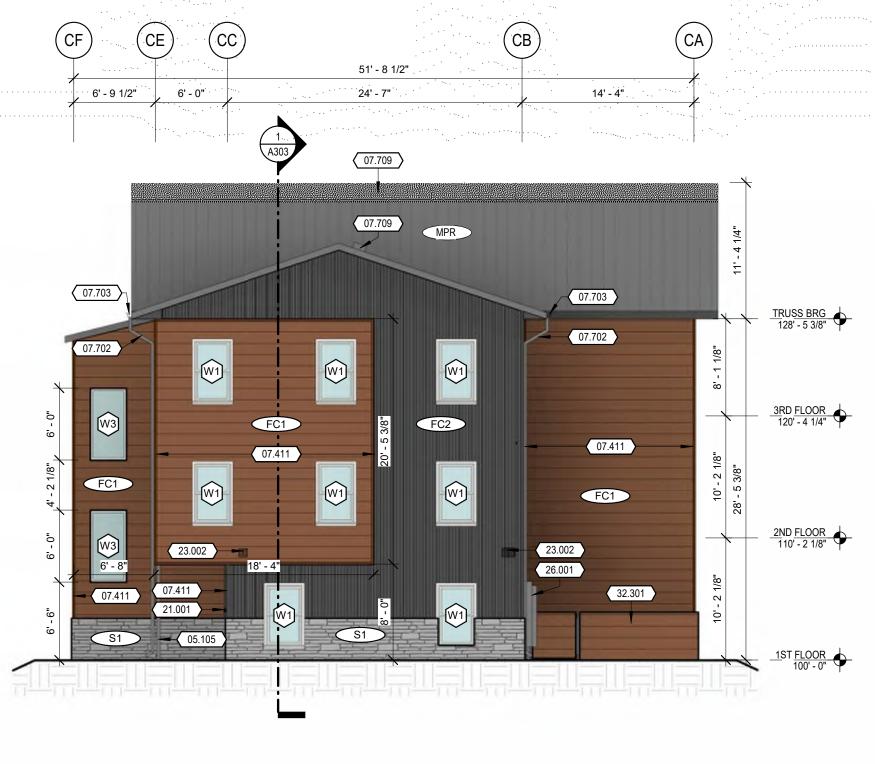

65' - 11"

07.411

20' - 5 1/2"

18' - 2 1/2"

FC2

S1

KEYNOTE LEGEND

PIPE COLUMN PER STRUCTURAL. 05.105 07.410

FIBER CEMENT FASCIA 07.411

FIBER CEMENT TRIM. SLOPE WITH ROOF WHERE APPLICABLE.

ALUMINUM DOWNSPOUTS. SEE ROOF PLAN FOR LOCATIONS AND SIZES. COLOR TO MATCH ADJACENT WALL SURFACE COLOR. SPLASHBLOCKS ARE TO BE PROVIDED AT ALL DOWNSPOUT LOCATIONS. INSTALL 4" PRE-FINISHED METAL GUTTER WITH BOX STYLE PROFILE. CONNECT GUTTER TO WALL

DOWNSPOUT AT BUILDING. GUTTER AND DOWNSPOUT FINISH TO MATCH FACIA. ROOF VENT. PLACE PER MANUFACTURER RECOMMENDATIONS 07.709 SURFACE-MOUNTED FIRE DEPARTMENT KNOX BOX. MOUNT TOP OF KNOX BOX 6'-0" MAX. ABOVE 21.001

FINISHED GRADE / WALKING SURFACE. FIRE DEPARTMENT CONNECTION (FDC) INSTALLED IN ACCORDANCE WITH NFPA SYSTEM REQUIREMENTS REFER TO PLUMBING DRAWINGS FOR ADDITIONAL INFORMATION. INSTALL KNOX FIRE DEPARTMENT SECURITY CAPS ON EACH FIRE DEPARTMENT CONNECTION PER THE FIRE MARSHAL AND LOCAL

FURNISH AND INSTALL EXTERIOR-GRADE METAL SIGN AT EACH FIRE DEPARTMENT CONNECTION. SIGN SHALL CONSIST OF 1 INCH TALL (MINIMUM) RAISED LETTERS ON A CONTRASTING COLOR BACKGROUND THAT READ: FIRE DEPARTMENT CONNECTION OR FIRE HOSE CONNECTION OR FIRE DEPARTMENT SPRINKLER CONNECTION OR A COMBINATION THEREOF AS APPLICABLE.

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CEDAR PICKET FENCE WITH STEEL GATE FRAME. REFER TO SHEET A101 FOR DETAILS.

### MATERIAL LEGEND

FC1 FIBER CEMENT LAP SIDING

FIBER CEMENT BOARD & BATTEN SIDING

THIN STONE VENEER

ASPHALT SHINGLE ROOF

METAL STANDING SEAM ROOF

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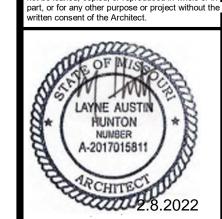
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**ELEVATIONS** 

EAST ELEVATION - BLDG C-G