

CITY PLAN COMMISSION STAFF REPORT

City of Kansas City, Missouri
City Planning & Development Department
www.kcmo.gov/cpc

August 16, 2022

Project Name Express Oil Change on N Oak

Docket #3

Request

CD-CPC-2022-00119 Development Plan (non-residential)

Applicant

Haiden O'Keefe Olsson 7301 133rd St W Unit 200 Overland Park, KS 66213

Owner

Grey Oaks Inc 20304 W 92nd St Lenexa, KS 66220

Location 7841 N Oak Trfy Area About 1 acre

Zoning B3-2 Council District 1st County Clay

School District Kansas City MO 250

Surrounding Land Uses

North: commercial uses, zoned B3-2. B1-1 South: commercial uses, zoned B3-2 East: residential uses, zoned R-5 West: residential uses, zoned R-7.5

Major Street Plan

North Oak is identified on the City's Major Street Plan as a Thoroughfare.

Land Use Plan

The Gahsland/Nashua Area Plan recommends Mixed Use Neighborhood for this location.

APPROVAL PROCESS



PROJECT TIMELINE

The application for the subject request was filed on 6/27/2022. No scheduling deviations from 2022 Cycle P have occurred.

NEIGHBORHOOD AND CIVIC ORGANIZATIONS NOTIFIED

There are no registered neighborhood or homes associations tied to the subject site.

REQUIRED PUBLIC ENGAGEMENT

Public engagement as required by 88-505-12 does apply to this request. Applicant hosted a meeting on 8/28/2022. A summary of the meeting is attached to the staff report, see Attachment #3.

EXISTING CONDITIONS

The subject site is currently an undeveloped parcel within a previously approved development plan area. The plan includes the Casey's to the north and the multi-tenant commercial building to the south of the subject site.

SUMMARY OF REQUEST + KEY POINTS

The applicant is seeking approval of a major amendment to a previously approved development plan to allow construction of 5,664 square foot Express Oil Change and Tire Engineers facility on about 1.07 acres generally located at 7841 N Oak Trfy.

CONTROLLING + RELATED CASES

6378-P-5 – Ordinance No. 940245 – Amending chapter 65, Revised Ordinances of Kansas City, Missouri, 1956, commonly known as the Zoning Ordinance, by adding a new Section as 65.010A2513, rezoning an area of approximately 4.9 acres generally located at the southeast corner of NE 79th Terrace and N Oak Trafficway from District R-4 (Low Apartments) to District C-2-p (Local Retail Business – Limited District), and approving a preliminary plan for the same. **Approved**

PROFESSIONAL STAFF RECOMMENDATION

Docket #3 Approval with Conditions

PLAN REVIEW

The proposed plan consists of a 5,664 square foot oil change facility. This proposed use and building is a major amendment to the previously approved plan because the previously approved use for this parcel was a drive-through restaurant.

Access to the site will come from the north and south adjacent parcels. There will be no new curb cut for this parcel off of N Oak Trfy. There are cross access easements on the north and south parcels to access the subject site. Parking will be located in the front and rear of the building.

The parking areas will be screened with a continuous line of shrubs and trees. Additionally, there is an open area on the east side of the property, abutting nearby residences. Staff requested the applicant provide native grasses rather than turf grass needing to be mowed to create a natural buffer between the proposed commercial use and the existing residential use. In addition to providing native grasses, other species listed on the plans for this project include Juniper, Boxwood, Switchgrass, Elm, and Oak,

Proposed elevations show the use of CMU, Quik-Brik, and accent paint colors.

PLAN ANALYSIS

Commercial Lot and Building (88-120), Use-Specific (88-300), and Development Standards (88-400) *indicates adjustment/deviation

Standards	Applicability	Meets	More Information
Lot and Building Standards (88-120)	Yes	Yes	
Accessory or Use- Specific Standards (88-305 – 385)	No	N/A	
Boulevard and Parkway Standards (88-323)	No	N/A	
Parkland Dedication (88-408)	No	N/A	
Parking and Loading Standards (88-420)	Yes	Yes	13 spaces required, 24 spaces proposed
Landscape and Screening Standards (88-425)	Yes	Yes	
Outdoor Lighting Standards (88-430)	Yes	Yes	Subject to conditions
Sign Standards (88-445)	Yes	Yes	Subject to conditions
Pedestrian Standards (88-450)	Yes	Yes	

SPECIFIC REVIEW CRITERIA

Development Plans, Project Plan, or Site Plan (88-516-05)

In order to be approved, a development plan, project plan, or site plan must comply with all of the following criteria:

A. The plan must comply with all standards of the Zoning and Development Code and all other applicable city ordinances and policies;

The proposed development complies with all applicable standards in the Zoning and Development Code and Area Plan.

- B. The proposed use must be allowed in the district in which it is located;
 - The proposed motor vehicle repair, limited use is permitted in the B3-2 zoning district. The subject site is also located within a planned district under the previous Zoning Code, thus requiring this major amendment, otherwise the use would be permitted by right at this location.
- C. Vehicular ingress and egress to and from the site, and circulation within the site must provide for safe, efficient, and convenient movement of traffic not only within the site but on adjacent roadways; Vehicular ingress and egress to the site is based on the previously approved development plan. This parcel was always planned to have cross access from the parcels to the north and south. The proposed site layout will provide enough space for efficient circulation.
- D. The plan must provide for safe, efficient, and convenient non-motorized travel opportunities, being pedestrian and bicycle movement, on the subject site;
 - The site plan shows a pedestrian connection from the existing sidewalk on N Oak Trfy. There are sidewalks around the building for safe pedestrian connectivity. Striping for the crosswalk across the parking lot is proposed for visibility to the pedestrian crossing. Four short-term bicycle parking spaces are provided per the Code requirement.
- E. The plan must provide for adequate utilities based on City standards for the particular development proposed.
 - Adequate existing utilities will service the subject property.
- F. The location, orientation, and architectural features, including design and material, of buildings and other structures on the site must be designed to be compatible with adjacent properties.

 The proposed building materials will be compatible with the surrounding commercial uses. The proposed red quik-brik will have a similar appearance to Casey's, north of the subject site.
- G. Landscaping, berms, fences, and/or walls must be provided to buffer the site from undesirable views, noises, lighting, or other off-site negative influences and to buffer adjacent properties from negative influences that may be created by the plan.
 - Landscaping is shown to screen all vehicular parking areas in compliance with the Code. Vegetative seed mix is shown on the plans for the type of seeding for the natural buffer area on the east side of the property.
- H. The design of streets, drives, and parking areas within the project should result in a minimum of area devoted to asphalt or other impervious surfaces consistent with the needs of the project and city code requirements.
 - The plans indicate the building will cover 13 percent of the site, but do not indicate how much of the site will be impervious surface. This site was always planned to have a commercial use, which is often results in predominantly impervious surface.
- The plan must identify trees to be removed and trees to be preserved during the development of the subject property with the goal of saving trees that are not required to be removed for the development of the property.
 - There appears to be only two trees on the site, and they will be removed to construct this development.

ATTACHMENTS

- 1. Conditions Report
- 2. Applicants Submittal
- 3. Public Engagement Materials
- 4. Additional documents, if applicable

PROFESSIONAL STAFF RECOMMENDATION

City staff recommends **Approval with Conditions** as stated in the conditions report.

Respectfully Submitted,

Henrin Klin

Genevieve Kohn

Plan Conditions ANSAS CITY

Planning & Dev

Report Date: August 10, 2022

Case Number: CD-CPC-2022-00119

Project: Express Oil Change on North Oak

Condition(s) by City Planning and Development Department. Contact Genevieve Kohn at (816) 513-8808 / Genevieve.Kohn@kcmo.org with questions.

- 1. That the developer shall submit an affidavit, prepared by an engineer licensed in the State of Missouri, verifying that all outdoor lighting has been installed in accordance with approved plans and that lighting levels do not exceed that shown on the approved lighting plan at the property lines prior to Certificate of Occupancy.
- 2. The developer shall submit an affidavit, completed by a landscape architect licensed in the State of Missouri, verifying that all landscaping required of the approved plan has been installed in accordance with the plan and is healthy prior to Certificate of Occupancy.
- 3. That all signage shall conform to 88-445 and shall require a sign permit prior to installation.
- 4. The developer shall submit an affidavit, completed by a landscape architect licensed in the State of Missouri, verifying that street trees have been installed in accordance with the approved street tree planting plan and are healthy prior to Certificate of Occupancy.
- 5. The developer shall submit an affidavit, completed by a landscape architect licensed in the State of Missouri, verifying that all landscaping required of the approved plan has been installed in accordance with the plan and is healthy prior to Certificate of Occupancy.
- 6. All roof and ground mounted mechanical/utility equipment must be screened in accordance with Section 88-425-08

Condition(s) by City Planning and Development Department. Contact Lucas Kaspar at (816) 513-2558 / Lucas.Kaspar@kcmo.org with questions.

- 7. The developer shall submit a storm drainage analysis from a Missouri-licensed civil engineer to the Land Development Division, in accordance with adopted standards, including a BMP level of service analysis prior to approval and issuance of any building permits, and that the developer secure permits to construct any improvements as required by the Land Development Division prior to issuance of any certificate of occupancy.
- 8. The developer must obtain the executed and recorded city approved grading, temporary construction, drainage/sewer, or any other necessary easements from the abutting property owner(s) that may be required prior to submitting any public improvements crossing properties not controlled by the developer and include said document(s) within the public improvement applications submitted for permitting
- 9. The owner/developer must submit plans for grading, siltation, and erosion control to Land Development Division for review and acceptance, and secure a Site Disturbance permit for any proposed disturbance area equal to one acre or more prior to beginning any construction activities.
- 10. The developer must grant a BMP Easement to the City as required by the Land Development Division, prior to recording the plat or issuance of any building permits.
- 11. The developer must pay impact fees as required by Chapter 39 of the City's Code of ordinances as required by the Land Development Division.

Condition(s) by Fire Department. Contact Michael Schroeder at (816) 513-4604 / michael.schroeder@kcmo.org with questions.

- 12. The project shall meet the fire flow requirements as set forth in Appendix B of the International Fire Code 2018. (IFC-2018 § 507.1)
- 13. Fire hydrant distribution shall follow IFC-2018 Table C102.1

Fire hydrants shall be installed and operable prior to the arrival of any combustible building materials onto the site. (IFC-2018 § 501.4 and 3312.1; NFPA -2013 § 8.7.2)

Condition(s) by Water Services Department. Contact Courtney Hawkins at / courtney.hawkins@kcmo.org with questions.

- 14. Prior to issuance of any building permits, provide storm sewer plan/profile and detail sheets, include 1% and 10% HGL in profiles, also show the 1% overland flow path where not conveyed in the pipe network as applicable
- 15. Prior to issuance of any building permits, provide drainage map (showing drainage areas and improved storm drainage systems) and storm drainage design calculations table in plan set
- 16. Manage stormwater runoff quality with BMPs, do not increase pollutant discharges that could potentially violate City's MS4 permit. Follow MARC BMP Manual.

Condition(s) by Water Services Department. Contact Heather Massey at (816) 513-2111 / heather.massey@kcmo.org with questions.

- 17. The developer shall ensure that water and fire service lines should meet current Water Services Department Rules and Regulations. Prior to C of O. https://www.kcwater.us/wp-content/uploads/2022/05/2022-Rules-and-Regulations-for-Water-Service-Lines-Final.pdf
- 18. The developer shall have a water flow test done to ensure there is adequate water pressure to serve the development. South of River contact Sean Allen 816-513-0318 North of River contact - Todd Hawes – 816-513-0296

Condition(s) by Water Services Department. Contact Jerald Windsor at (816) 513-0413 / Jerald.Windsor@kcmo.org with questions.

- 19. Please note the 8" water main in N. Oak Trfwy. Is slated for replacement in the next year or two. No anticipated issues or concerns. Contact Daniel Luna at KC Water for more information about the project
- 20. Please label the 8" & 16" mains along N. Oak Trfwy.
- 21. Please confirm the correct location of Sewer Manhole # N-113 located near the SE corner of the property.

EXPRESS OIL CHANGE AND TIRE ENGINEERS 7841 NORTH OAK TRAFFICWAY DEVELOPMENT PLANS

A PART OF THE NORTHEAST 1/4, SECTION 14, TOWNSHIP 51 NORTH, RANGE 33 WEST IN THE CITY OF KANSAS CITY, CLAY COUNTY, MISSOURI

ARCHITECT

CONTACT: LARRY MILLES
AHO, ARCHITECTS, LLC
9 SUNNEN DRIVE #110
ST. LOUIS, MO 63143

<u>OWNER</u>

314.884.7170

GREY OAKS INC. 20304 W 92ND STREET LENEXA, KS 66220 618.307.0398

ENGINEERING CONTACT: RYAN KUBERT, PE


OLSSON, INC
7301 W 133RD STREET
SUITE 200
OVERLAND PARK, KS 66213
913.381.1170

PROPERTY DESCRIPTION:

All that part of Tract B, of the Certificate of Survey of Lot 2, GREY OAKS COMMONS, a subdivison in Kansas City, Clay County, Missouri, recorded June 28, 2004, as Document No. S-79425 in Survey Cabinet F, at Sleeve 129; EXCEPT that part thereof replatted as CASEY'S GENERAL STORES, a subdivision, recorded December 14, 2012, as Document No. 2012048579 in Plat Cabinet H in Sleeve 50.



LOCATION MAP

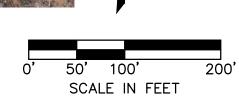

ВУ						
REVISIONS DESCRIPTION	CITY DEVELOPMENT REVIEW COMMENTS				REVISIONS	
DATE	2022 07 29					
EV NO	_					

Sheet List Table

COVER SHEET

GRADING PLAN

LANDSCAPE PLAN

DUMPSTER ELEVATIONS

EXTERIOR ELEVATION —
FRONT

EXTERIOR ELEVATION - REAR

EXTERIOR ELEVATION -

EXTERIOR ELEVATION - RIGHT

UTILITY PLAN

SITE PLAN -

PHOTOMETRICS
SIGN PLANS
SIGN PLANS

SITE PLAN

DEVELOPMENT PLAN

Sheet Number | Sheet Title


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A203

DEVELOPMENT PLAN
COVER SHEET
ESS OIL CHANGE & TIRE ENGINEEI
7841 N OAK TRAFFICWAY

drawn by: HMC
checked by: approved by:
QA/QC by:
project no.: 022-02484
drawing no.:

SHEET C0.0

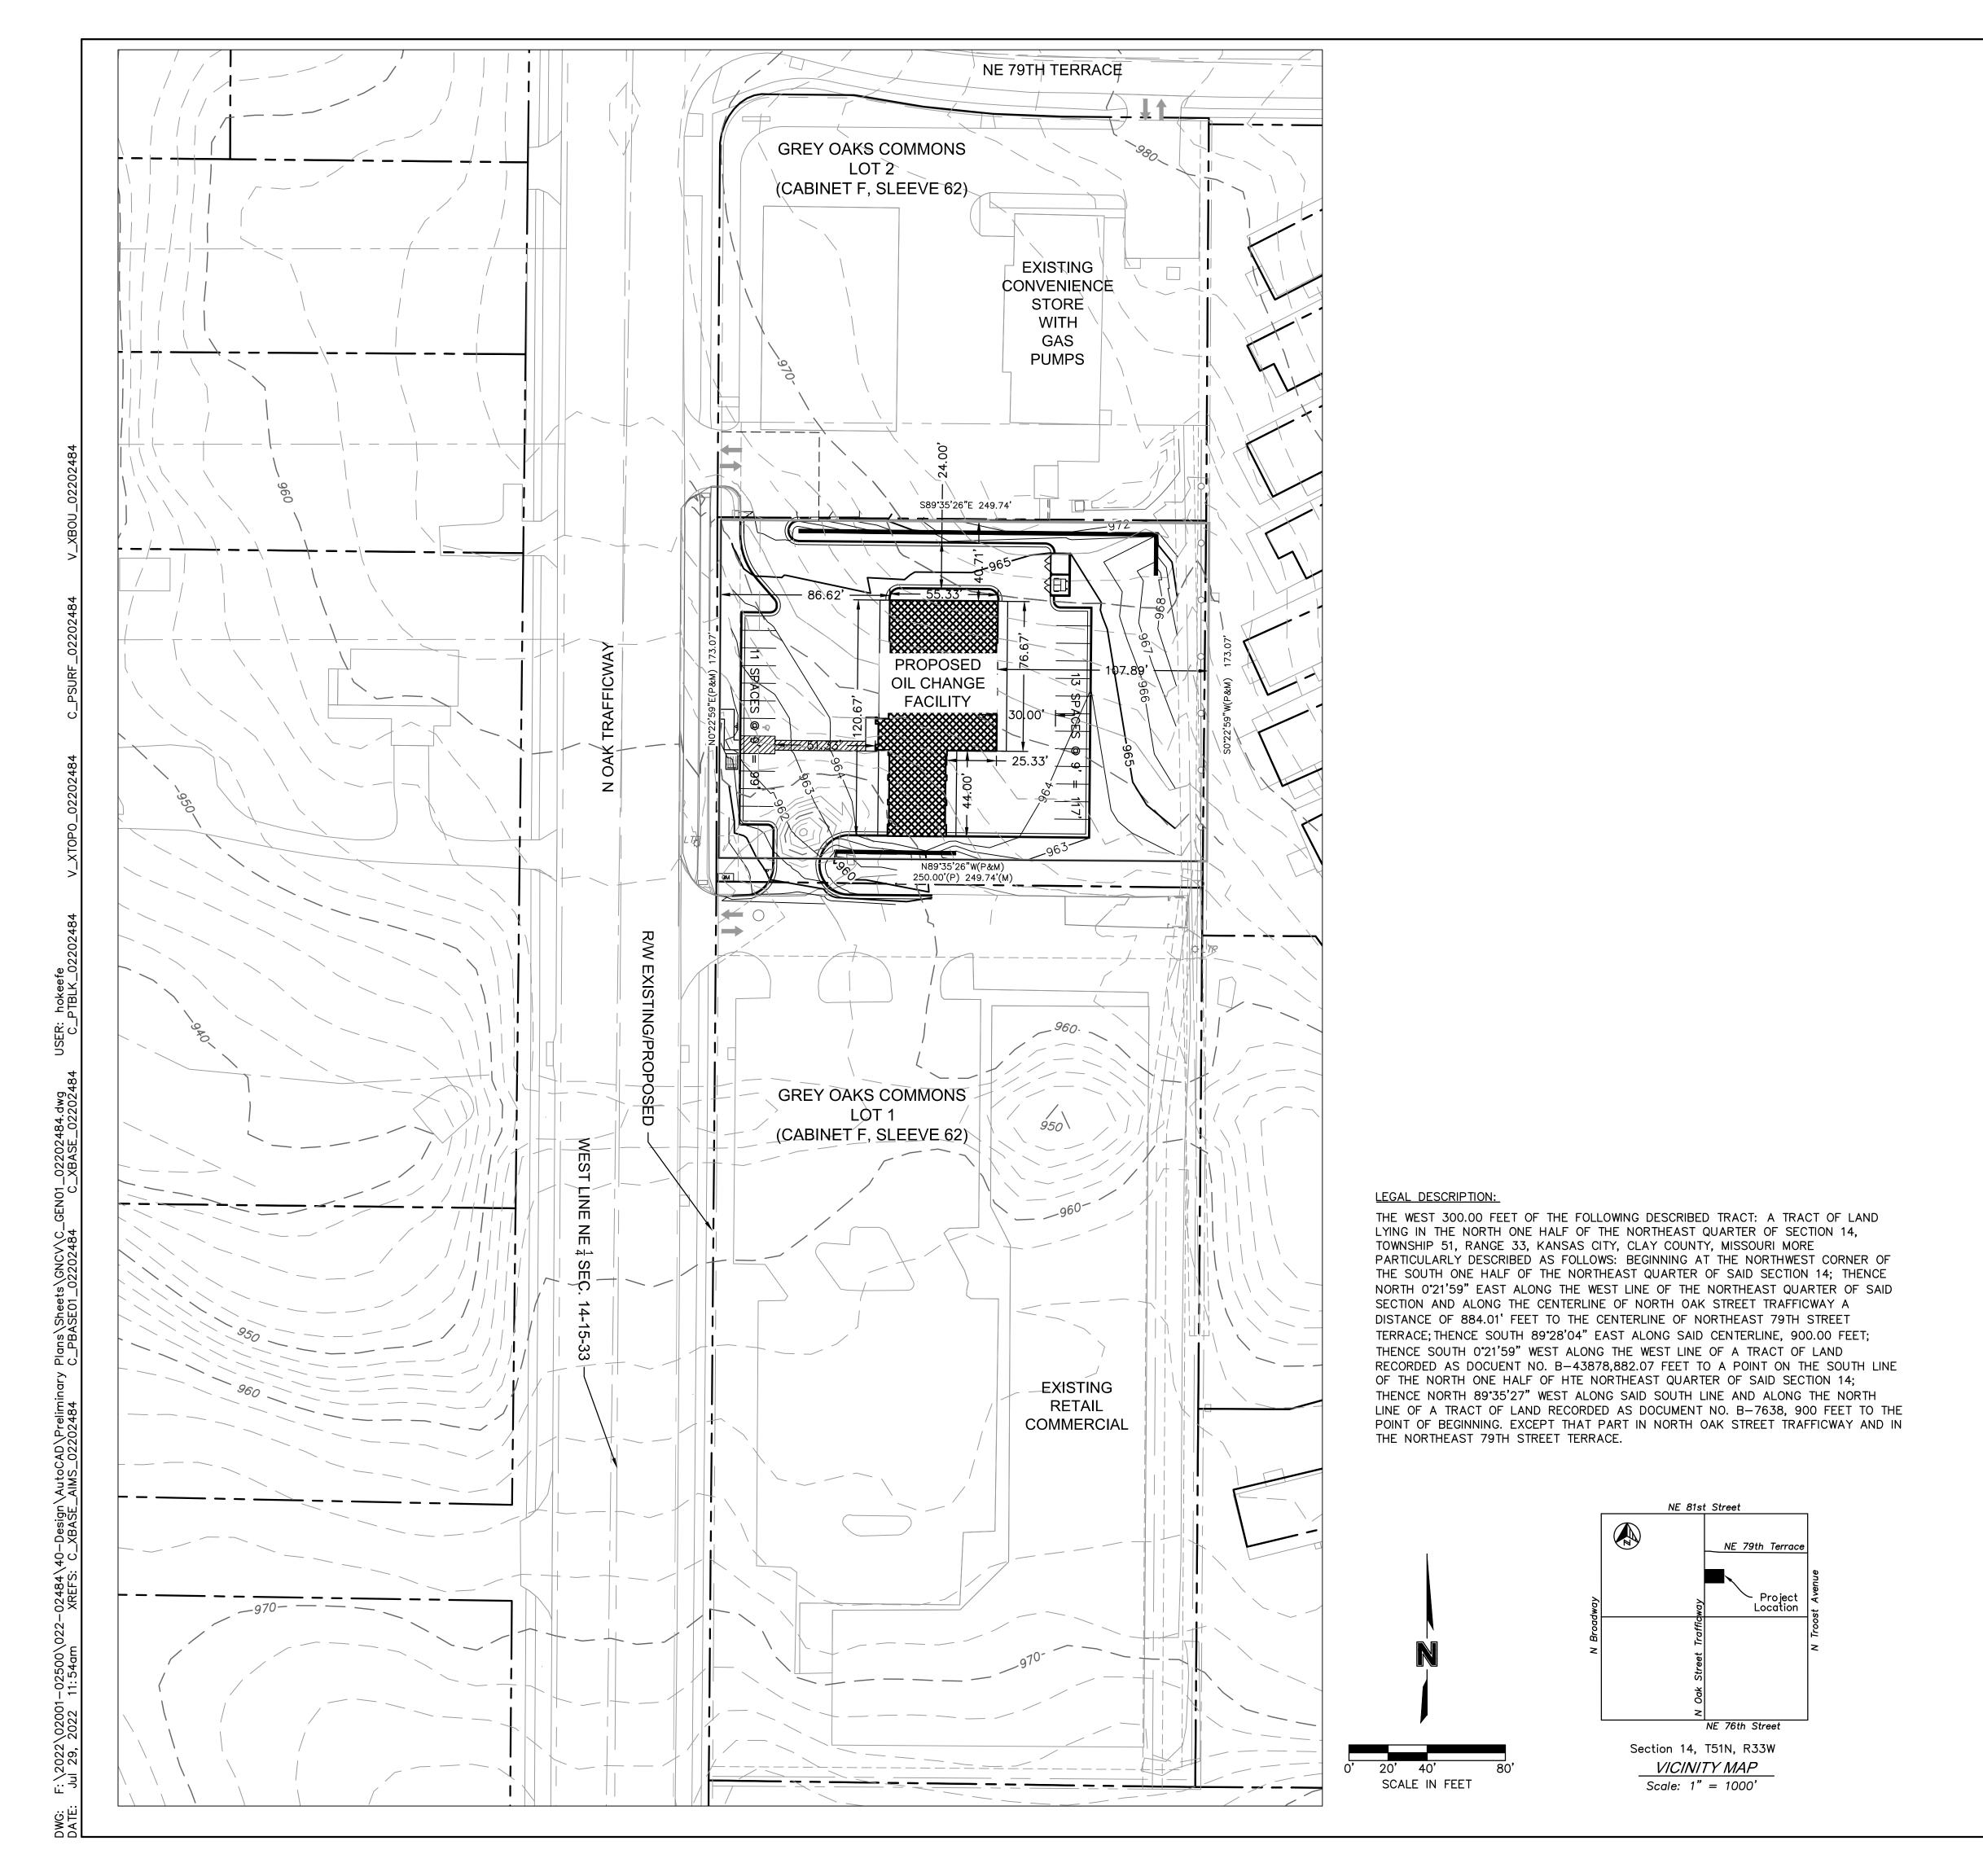

OAK CREEK

REZONING AND DEVELOPMENT PLAN

FO

 $N\frac{1}{2}$ OF THE NE $\frac{1}{4}$ OF SEC. 14-51-33 KANSAS CITY, CLAY COUNTY, MISSOURI

NOTES:

CASE NO. 6378-P

PRELIMINARY PLAN FOR DISTRICT CP-2

- 1. THIS PLAN IS DRAWN AT A SCALE OF ONE (1) INCH EQUALS FORTY (40) FEET.
- 2. PROPERTY LINES ARE SHOWN AS: -----
- EXISTING AND PROPOSED RIGHTS—OF—WAY ARE IDENTIFIED ON THE PLAN FOR NORTH OAK STREET TRAFFICWAY & NE 79TH TERRACE.
- 4. PROPOSED RIGHTS—OF—WAY FOR NORTH OAK STREET TRAFFICWAY & NE 79TH TERRACE ARE AS SHOWN. NEW EASEMENTS WILL BE DEVELOPED & PREPARED DURING THE FINAL SITE PLAN & FINAL PLATTING PROCESS.
- 5. PROPOSED BUILDINGS ARE SHOWN AS:

EXISTING BUILDINGS ARE SHOWN AS:

A TEN (10) FOOT SETBACK LINE IS PLANNED FROM NORTH OAK, FIFTEEN (15) FOOT SETBACK FROM 79TH TERRACE & A TWENTY (20) FOOT SETBACK FROM THE EAST AND SOUTH PROPERTY LINES.

ALL BUILDINGS WILL BE ONE STORY.

6 AND 7. PROPOSED USES ARE AS FOLLOWS:

<u>USE</u>	BLDG SQ. FT.	<u>PARKING</u>
CONVENIENCE STORE CAR WASH	5,000 960	12 PLUS 5 STORAGE SPACES FOR CAR WASH
OIL CHANGE FACILITY	5,664	24 PLUS 6 STORAGE SPACES FOR SERVICE BAYS
RETAIL COMMERCIAL	30,000	136

- 8. FREE STANDING SIGNS ARE SHOWN: OR OR
- 9. INGRESS & EGRESS ARE SHOWN AS:

10 AND 11. SEE NOTES 6 & 7 ABOVE FOR FLOOR AREAS OF EXISTING AND PROPOSED BUILDINGS.

12. PHASES OF DEVELOPMENT

(A) PHASE 1

RETAIL COMMERCIAL
(B) PHASE 2
CONVENIENCE STORE

(C) PHASE 3
OIL CHANGE FACILITY

PHASING OF THE PROJECT AS SHOWN ABOVE, HOWEVER, THE DEVELOPER RESERVES THE RIGHT TO CHANGE PHASES IF ECONOMIC CONDITION IS WARRANTED.

REV. DATE REVISIONS DESCRIPTION

1 2022.07.29 CITY DEVELOPMENT REVIEW COMMENTS

PY,

REVISIONS

REVISIONS DESCRIPTION

1 2022.07.29 CITY DEVELOPMENT REVIEW COMMENTS

REVISIONS


OAK CREEK
E NE \(\frac{1}{4}\) OF SEC. 14-51-33, KANSAS CIT
MISSOURI

drawn by: HMO
checked by: RK
approved by:
QA/QC by:
project no.: 022-02484
drawing no.:

717

SHEET

2022.06.27

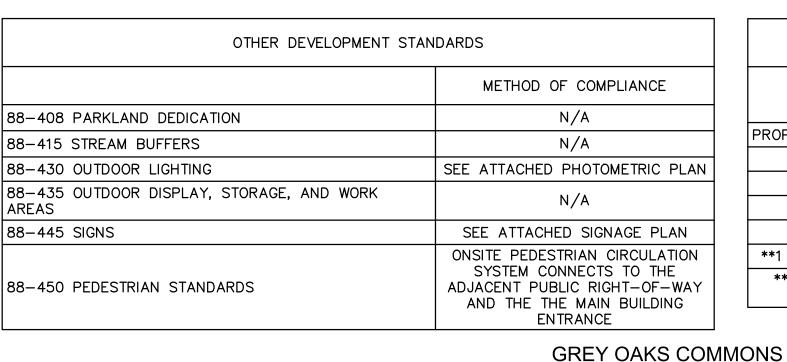

86.62' -

SECONDARY

ACCESS DOOR

DRIVE-IN

DOOR (TYP.)

DRIVE-IN

DOOR (TYP.)

ENTRANCE/ -

— 24.00**'** –

RETAINING WALL

MAX HEIGHT: 5'

MATERIAL: KEYSTONE

MIN ELEVATION: 958.00

MAX ELEVATION: 964.00

FOR MORE DETAIL

REFERENCE GRADING PLAN

COMPAC SERIES III TRI-PLANE

NORTH OAK I (WIDTH VARIES

PROPOSED BIKE

STORAGE SPACE

5.00' [>]

EXISTING

SIDEWALK

LOT 2

(CABINET F, SLEEVE 62)

OWNER INFORMATION:

CASEY'S MARKETING CO

STORE #3241

PO BOX 54288

LEXINGTON, KY 40555

PROPOSED

EXPRESS OIL

CHANGE & TIRE

ENGINEERS

55' X 120'

5,664 SQ. FT.

FFE: 965.00

ONE-STORY BUILDING

N89°35'26"W(P&M)

GREY OAKS COMMONS LOT 1

(CABINET F, SLEEVE 62)

OWNER INFORMATION:

PATRO BROTHERS LLC

21192 W 113TH PL

OLATHE, KS 66061

250.00'(P) 249.74'(M)

PARKING DATA							
	VEHICLE	SPACES	BIKE SI	PACES	ALTERNATIVES PROPOSED?		
PROPOSED USES	REQUIRED	PROPOSED	REQUIRED	PROPOSED			
VEHICLE	12*	23	4***	4	NO		
ADA	1**	1	4***	4	NO		
TOTAL	13	24	4	4			
*2 SP	*2 SPACES PER SERVICE BAY X 6 SERVICE BAYS = 12 SPACES REQUIRED						
**1 ADA SPACE IS	REQUIRED W	HEN 1-25 TOT	AL OFF-STRE	ET SPACES	ARE PROPOSED		
***3 SHORT TER	M SPACES OR	10% OF PROF	OSED OFF-S	TREET PARKI	NG, WHICHEVER		

RETAINING WALL - -

SERIES III TRI-PLANE

MIN ELEVATION: 965.50 MAX ELEVATION: 972.00

REFERENCE GRADING PLAN

SECONDARY

ACCESS DOOR

13

18.00' (TYP.)

— 107.89' ·

√30.00' →

DRIVE-IN

DOOR (TYP_)_

DRIVE-IN

DOOR (TYP.)


MAX HEIGHT: 5.7'

FOR MORE DETAIL


MATERIAL: KEYSTONE COMPAC

IS GREATER, AND ONE LONG TERM SPACE

10.00 SS/E

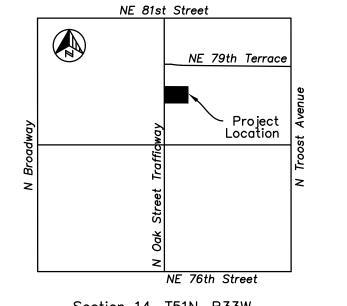

Section 14, T51N, R33W VICINITY MAP Scale: 1" = 1000'

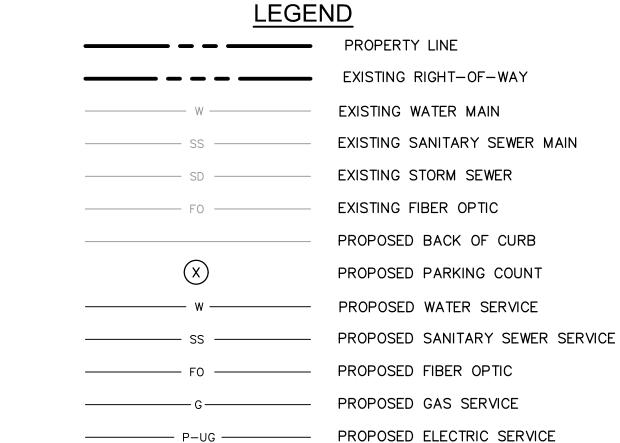

TEMPORARY CONSTRUCTION EASEMENT

PROPOSED CONCRETE PAVEMENT

SITE DATA

PROPOSED CONCRETE SIDEWALK

NO

NO

NO

NO

NO

		1: 4	• • • •	,
1.		.*' •	1	
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PROPOSED ADA PATH

		EXIS	TING	PROP	OSED	DEVIATION REQUESTED?	APPROVED
40.00	ZONING	CP	-2	CP.	-2	NO	
10.00' SS/E	GROSS LAND AREA	43,221 SQ. FT.	0.99 AC.	43,221 SQ. FT.	0.99 AC.	NO	
10.00'	RIGHT-OF-WAY DEDICATION	0 SQ. FT.	O AC.	0 SQ. FT.	0 AC.	NO	
_ 10.00' TCE	NET LAND AREA	43,221 SQ. FT.	0.99 AC.	43,221 SQ. FT.	0.99 AC.	NO	
	BUILDING AREA	0 SQ). FT.	5,664	SQ. FT.	NO	
	FLOOR AREA RATIO	0.0	00	0.	13	NO	
	RESIDENTIAL USE INFO	N,	/A	N,	′ A	NO	
	TOTAL DWELLING UNITS	()	C)	NO	
GREY OAKS	DETACHED HOUSE	()	C)	NO	
LOT 1	ZERO LOT LINE HOUSE	C)	C)	NO	
OWNER INFORMATION:	COTTAGE HOUSE	()	C)	NO	
GREY OAKS HOME ASSOC INC	SEMI-ATTACHED HOUSE	C)	C)	NO	
20304 W 92ND ST	TOWNHOUSE	C)	C)	NO	
LENEXA, KS 66220	TWO-UNIT HOUSE	()	C)	NO	
	MULTI-UNIT HOUSE	()	C)	NO	
	COLONNADE	C)	C)	NO	
	MULTIPLEX)	C)	NO	
	MULTI-UNIT BUILDING	()	C)	NO	
	TOTAL LOTS	•	1	1		NO	
						1	

BUILDING DATA						
	REQUIRED	PROPOSED	DEVIATION REQUESTED?	APPROVED		
REAR SETBACK	30'	107.89'	NO			
FRONT SETBACK	NONE	86.62'	NO			
SIDE SETBACK	NONE	11.69'	NO			
SIDE SETBACK (ABUTTING STREET)	NONE	40.71'	NO			
HEIGHT	<55'	35.77	NO			

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LEGAL DESCRIPTION:

RESIDENTIAL

PUBLIC/CIVIC

COMMERCIAL


INDUSTRIAL

OTHER

All that part of Tract B, of the Certificate of Survey of Lot 2, GREY OAKS COMMONS, a subdivison in Kansas City, Clay County, Missouri, recorded June 28, 2004, as Document No. S-79425 in Survey Cabinet F, at Sleeve 129; EXCEPT that part thereof replatted as CASEY'S GENERAL STORES, a subdivision, recorded December 14, 2012, as Document No. 2012048579 in Plat Cabinet H in Sleeve 50.

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0' 10' 20' 40'	drawn by: checked by: approved by: QA/QC by: project no.: drawing no.: date:
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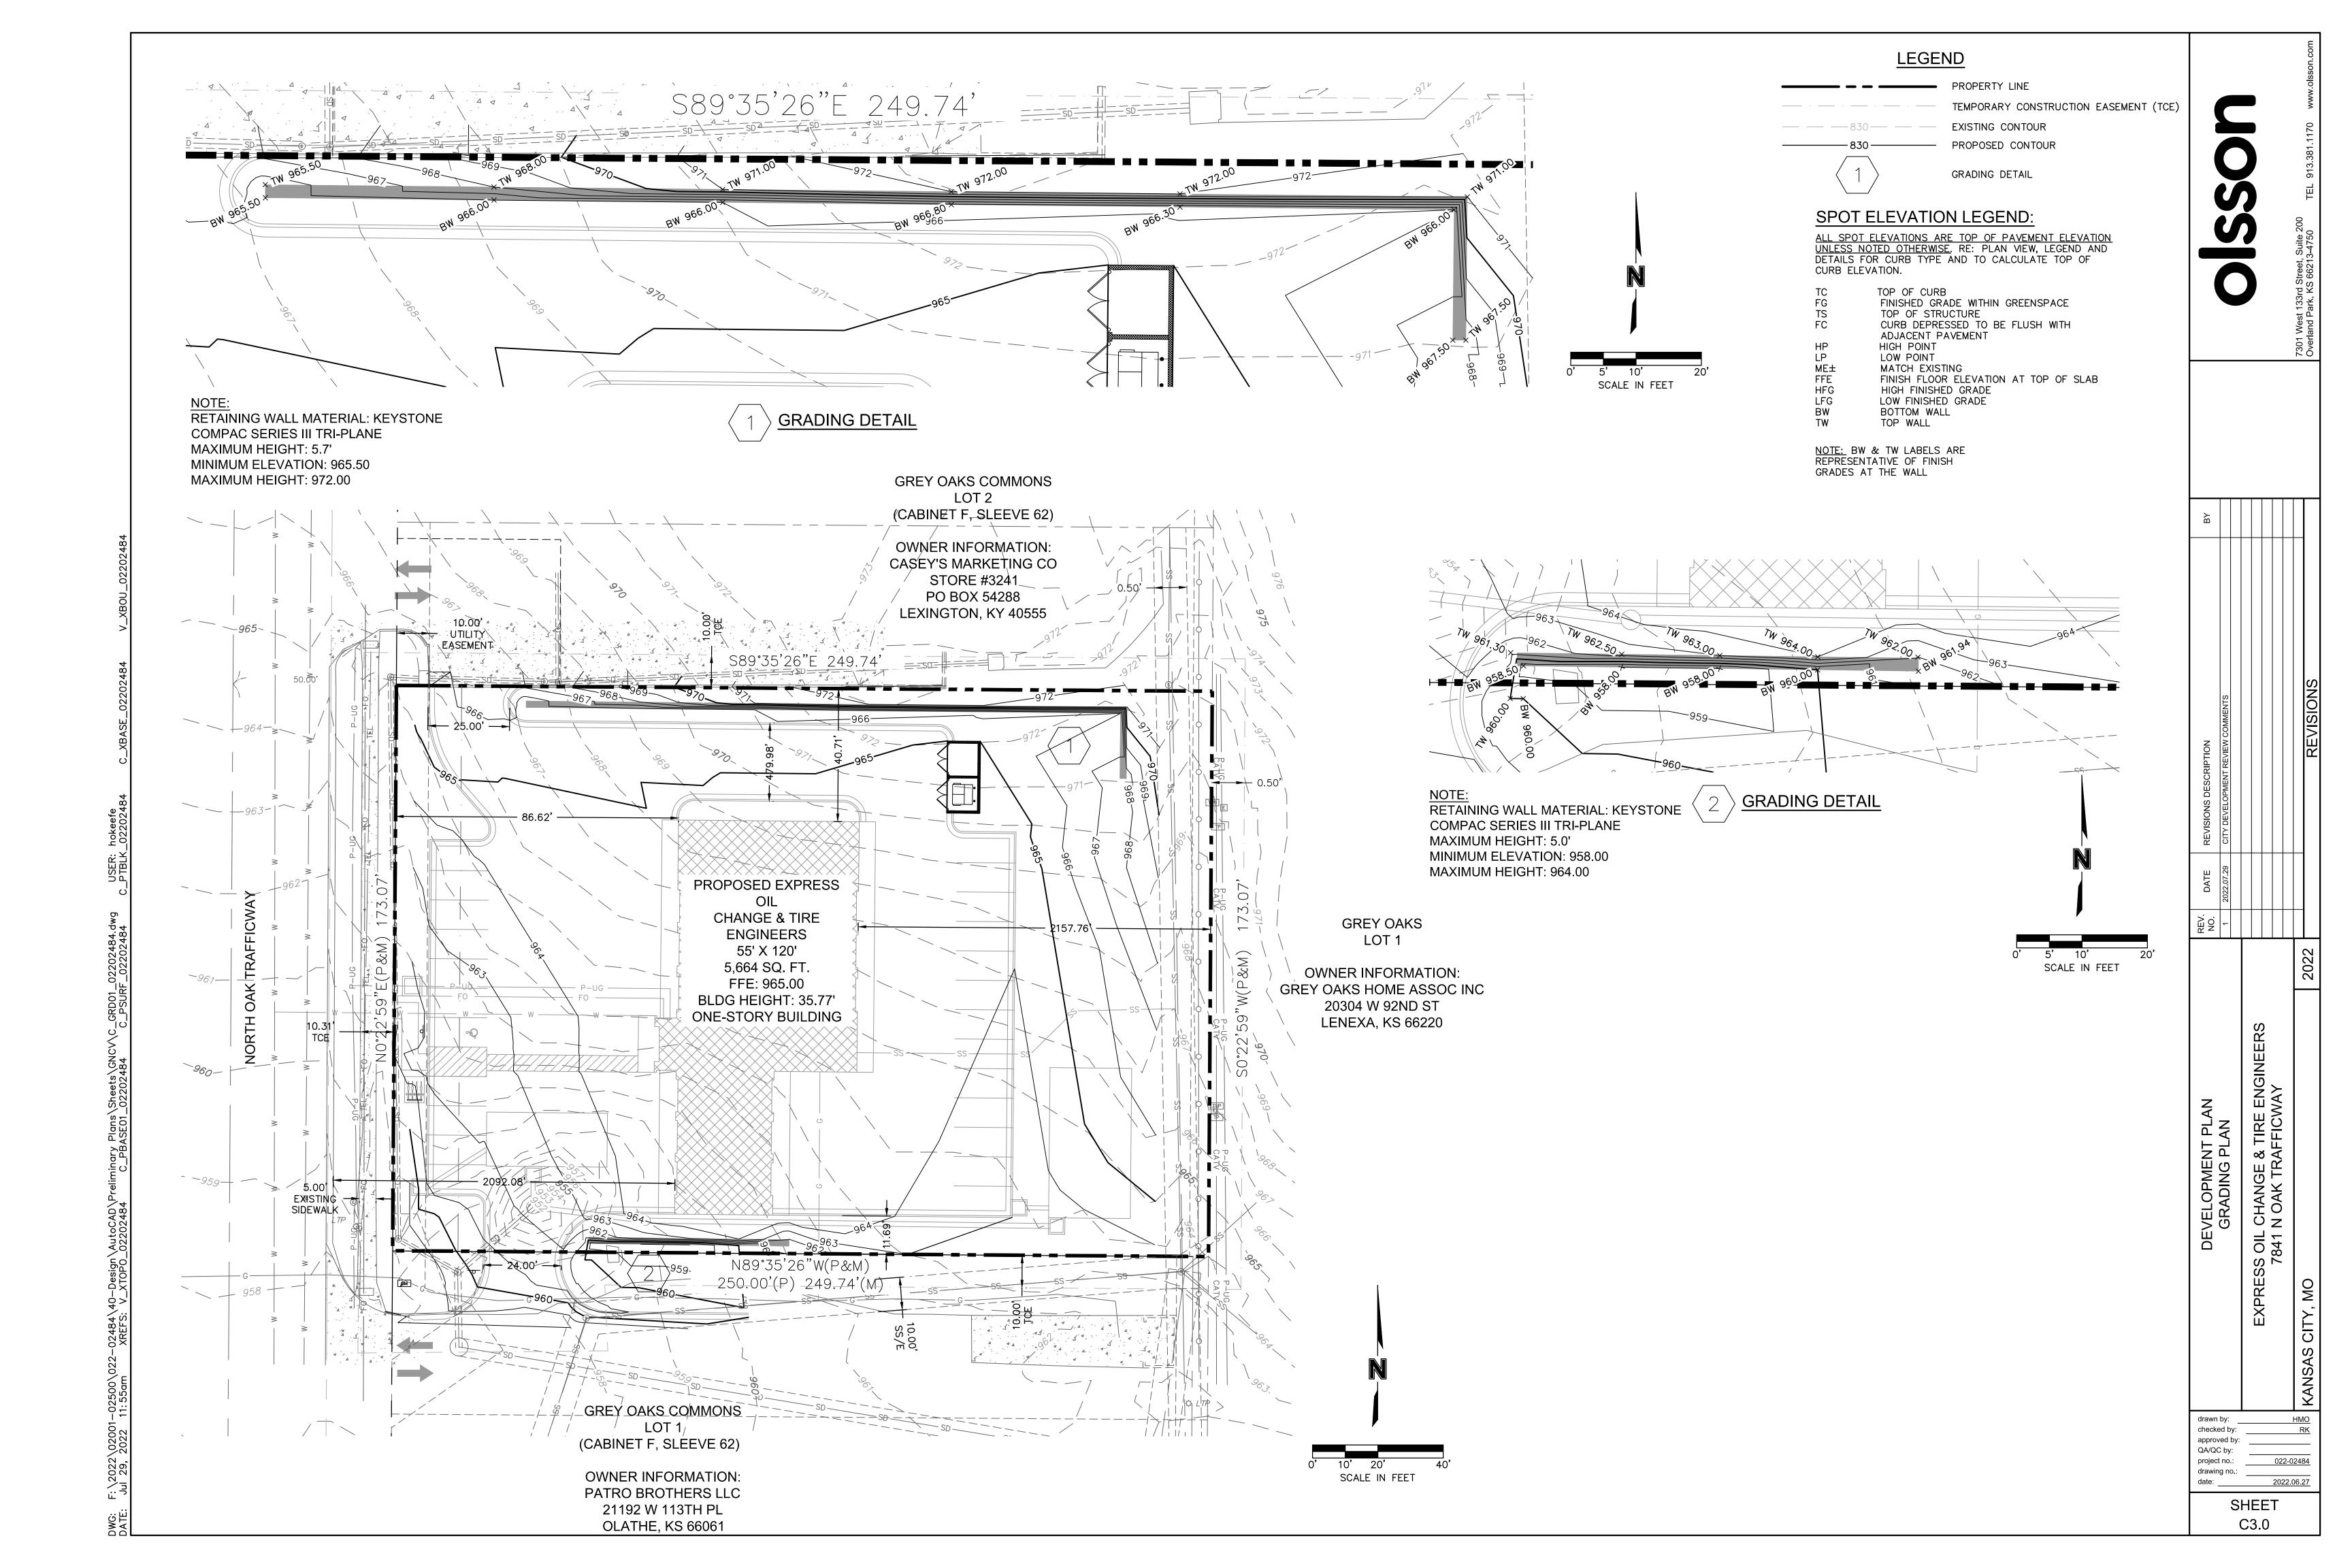
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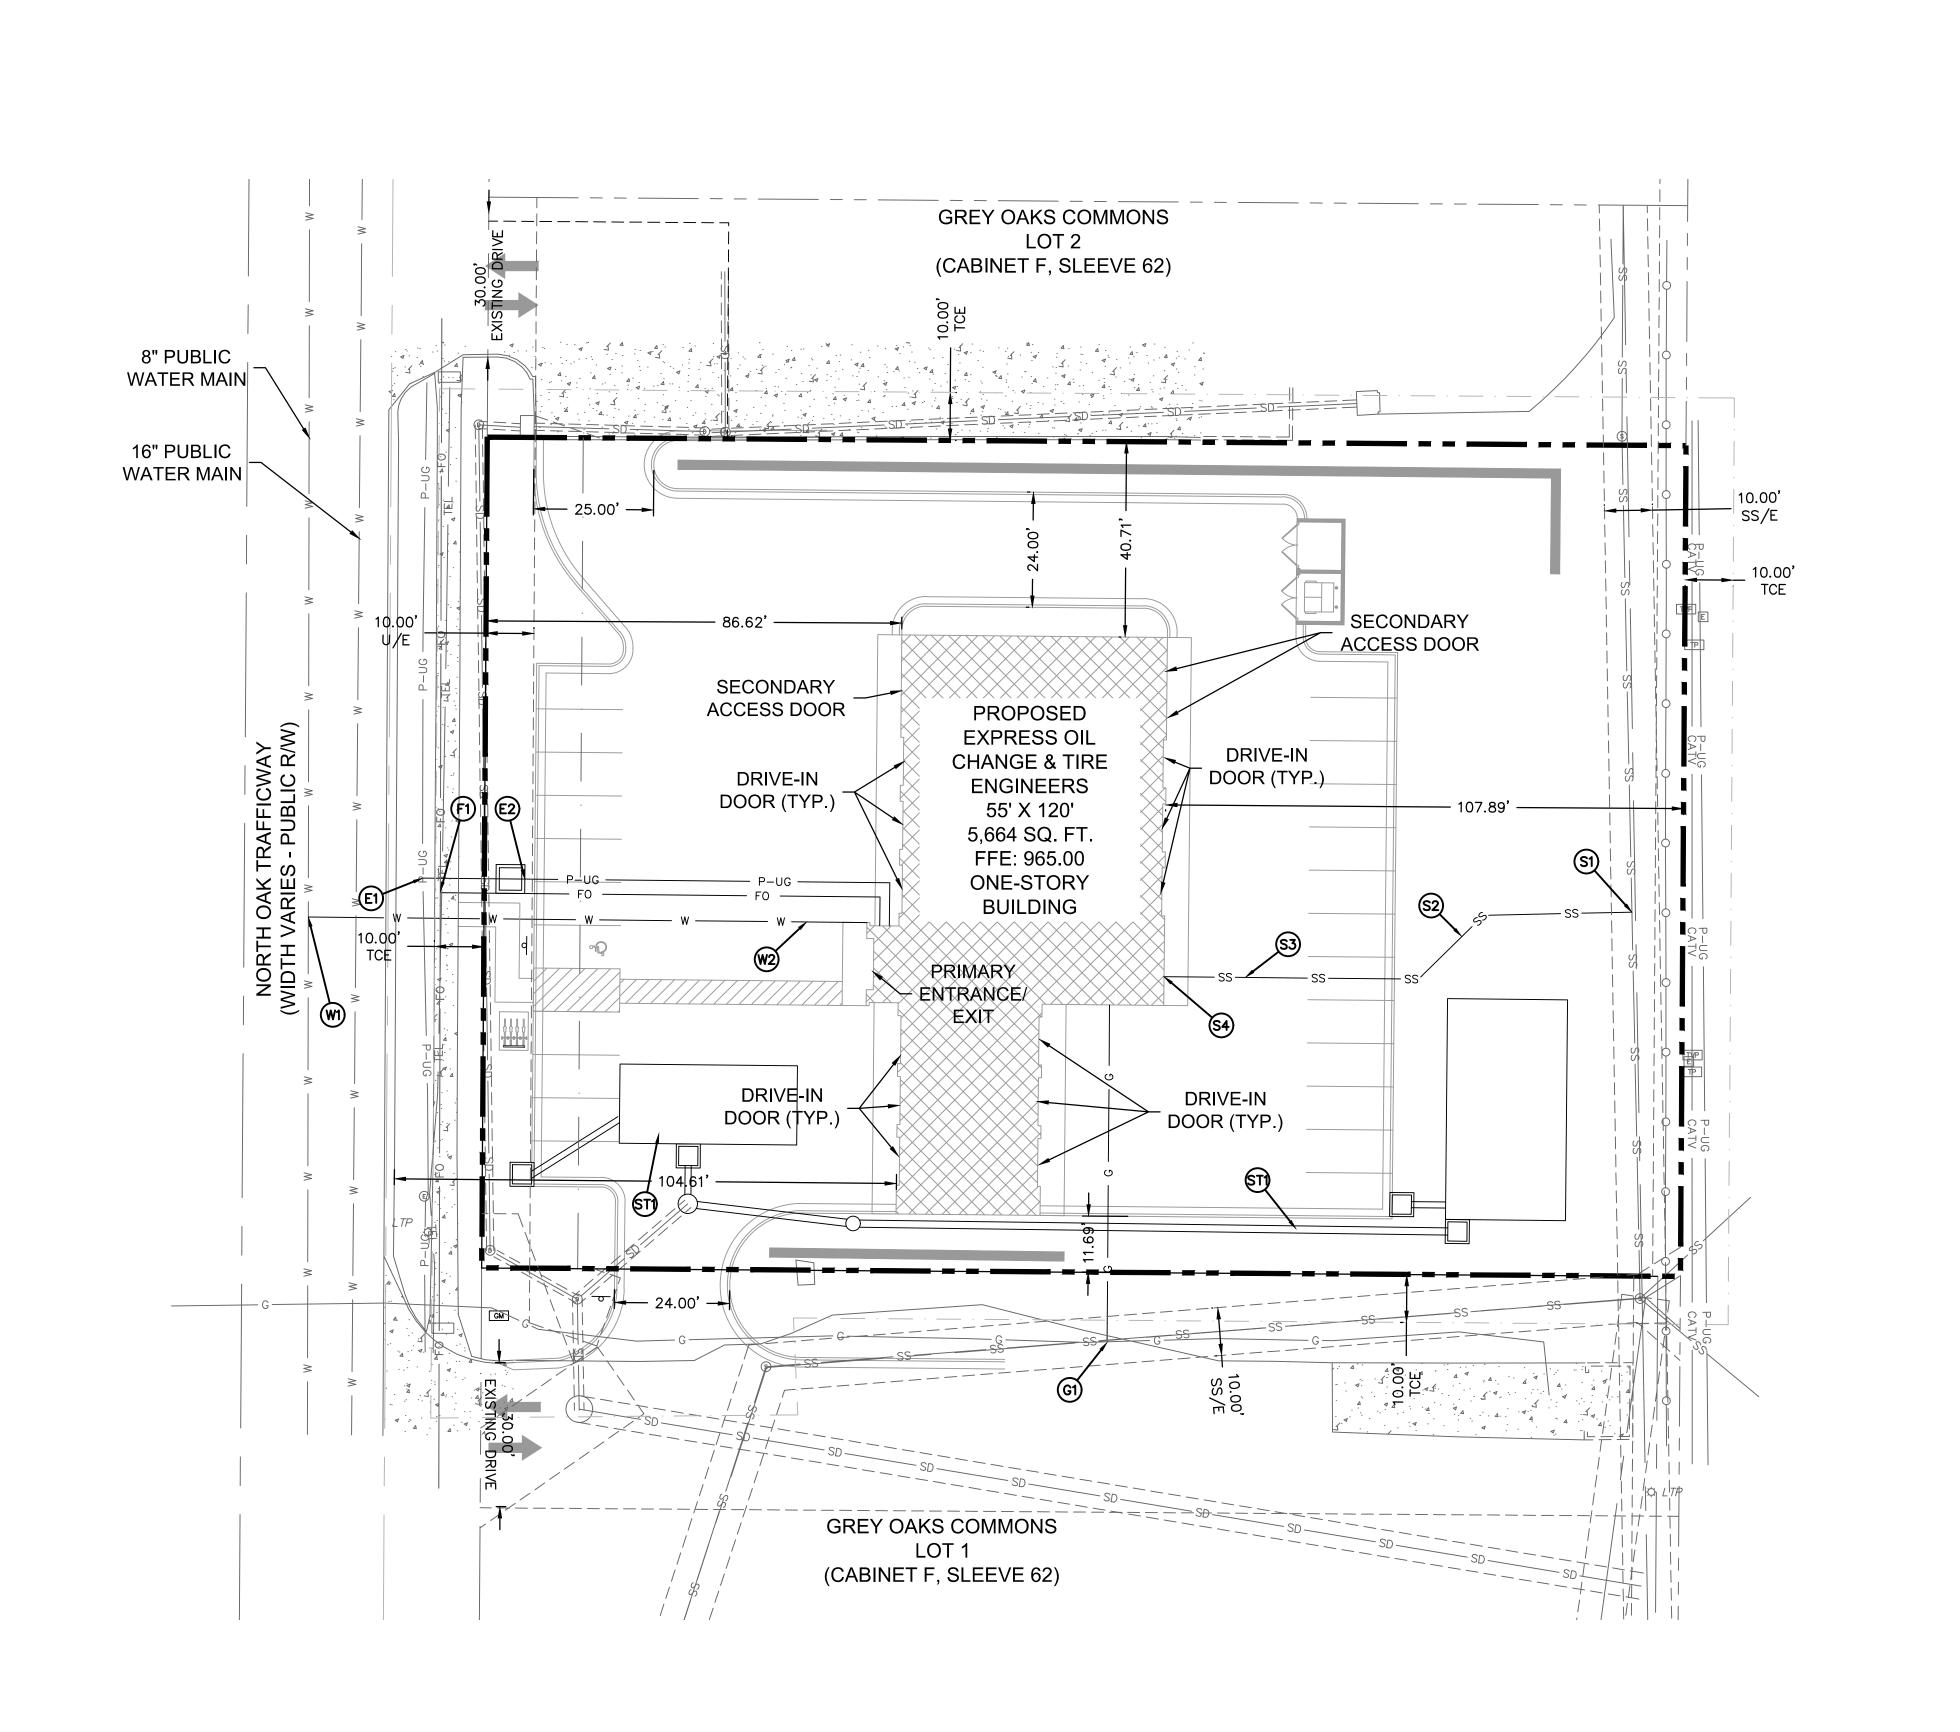
2022.06.27 SHEET C2.0

022-02484

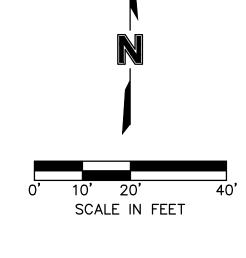SS OIL CHANGE & TIRE ENGINEERS 7841 N OAK TRAFFICWAY

DEVELOPMENT PLAN SITE PLAN





<u>LEGEND</u>

PROPERTY LINE

EXISTING OVERHEAD POWER

EXISTING FIBER OPTIC

EXISTING TELEPHONE SERVICE

EXISTING NATURAL GAS SERVICE

EXISTING CABLE TELEVISION

EXISTING WATER SERVICE

EXISTING SANITARY SEWER

EXISTING STORM SEWER

PROPOSED STORM SEWER

PROPOSED DOMESTIC WATER

PROPOSED POWER SERVICE

PROPOSED GAS SERVICE

PROPOSED GAS SERVICE

PROPOSED COMM SERVICE

TEMPORARY CONSTRUCTION EASEMENT

NOTES:

POWER
E1. CONNECT TO EXISTING POWER LINE ALONG NORTH OAK
TRAFFICWAY AND INSTALL ± 18 L.F. OF PRIMARY CONDUIT PER
CITY OF KANSAS CITY, MO (KCMO) STANDARDS AND CONNECT
TO TRANSFORMER

E2. INSTALL \pm 88 L.F. OF SECONDARY CONDUIT PER KCMO STANDARDS ROUTE TO PROPOSED OFFICE LOCATION

 ${\it GAS} \over {\it G1.}$ CONNECT TO EXISTING GAS LINE AND INSTALL \pm 70 L.F. OF CONDUIT PER KCMO STANDARDS ROUTE TO PROPOSED BUILDING

 $rac{ extsf{FIBER}}{ extsf{F1}}$ F1. CONNECT TO EXISTING COMM LINE AND INSTALL \pm 98 L.F. OF CONDUIT PER KCMO STANDARDS ROUTE TO PROPOSED OFFICE LOCATION

<u>STORM</u> ST1. INSTALL PRIVATE SITE STORM SYSTEM

ANITARY SEWER

S1. TEE INTO EXISTING 8" SANITARY SEWER MAIN

S2. INSTALL 103 LF OF 4" PVC (SDR-26) W/ PUSH ON JOINTS

S3. INSERT CLEANOUT PRIOR TO ENTERING THE BUILDING

S4. FERNCO STRONGBACK FOR DISSIMILAR PIPE CONNECTION AT BUILDING

<u>VATER</u>

W1. TEE IN TO EXISTING 8" DISTRIBUTION LINE LOCATED BENEATH NORTH OAK DRIVE

W2. INSTALL 116 L.F. OF 1" DOMESTIC WATER SERVICE TO PROPOSED BUILDING OFFICE. MAINTAIN 42" MINIMUM DEPTH

NOTE: OFF SITE UTILITIES ARE BASED ON PROVIDED UTILITY MAPS AND HAVE NOT BEEN SURVEYED.


10' 20' SCALE IN FEET

drawn by: HMO
checked by: RK
approved by: QA/QC by: project no.: 022-02484
drawing no.: date: 2022.06.27

S OIL CHANGE & TIRE ENGINEERS 7841 N OAK TRAFFICWAY

DEVELOPMENT PLAN UTILITY PLAN

> SHEET C4.0

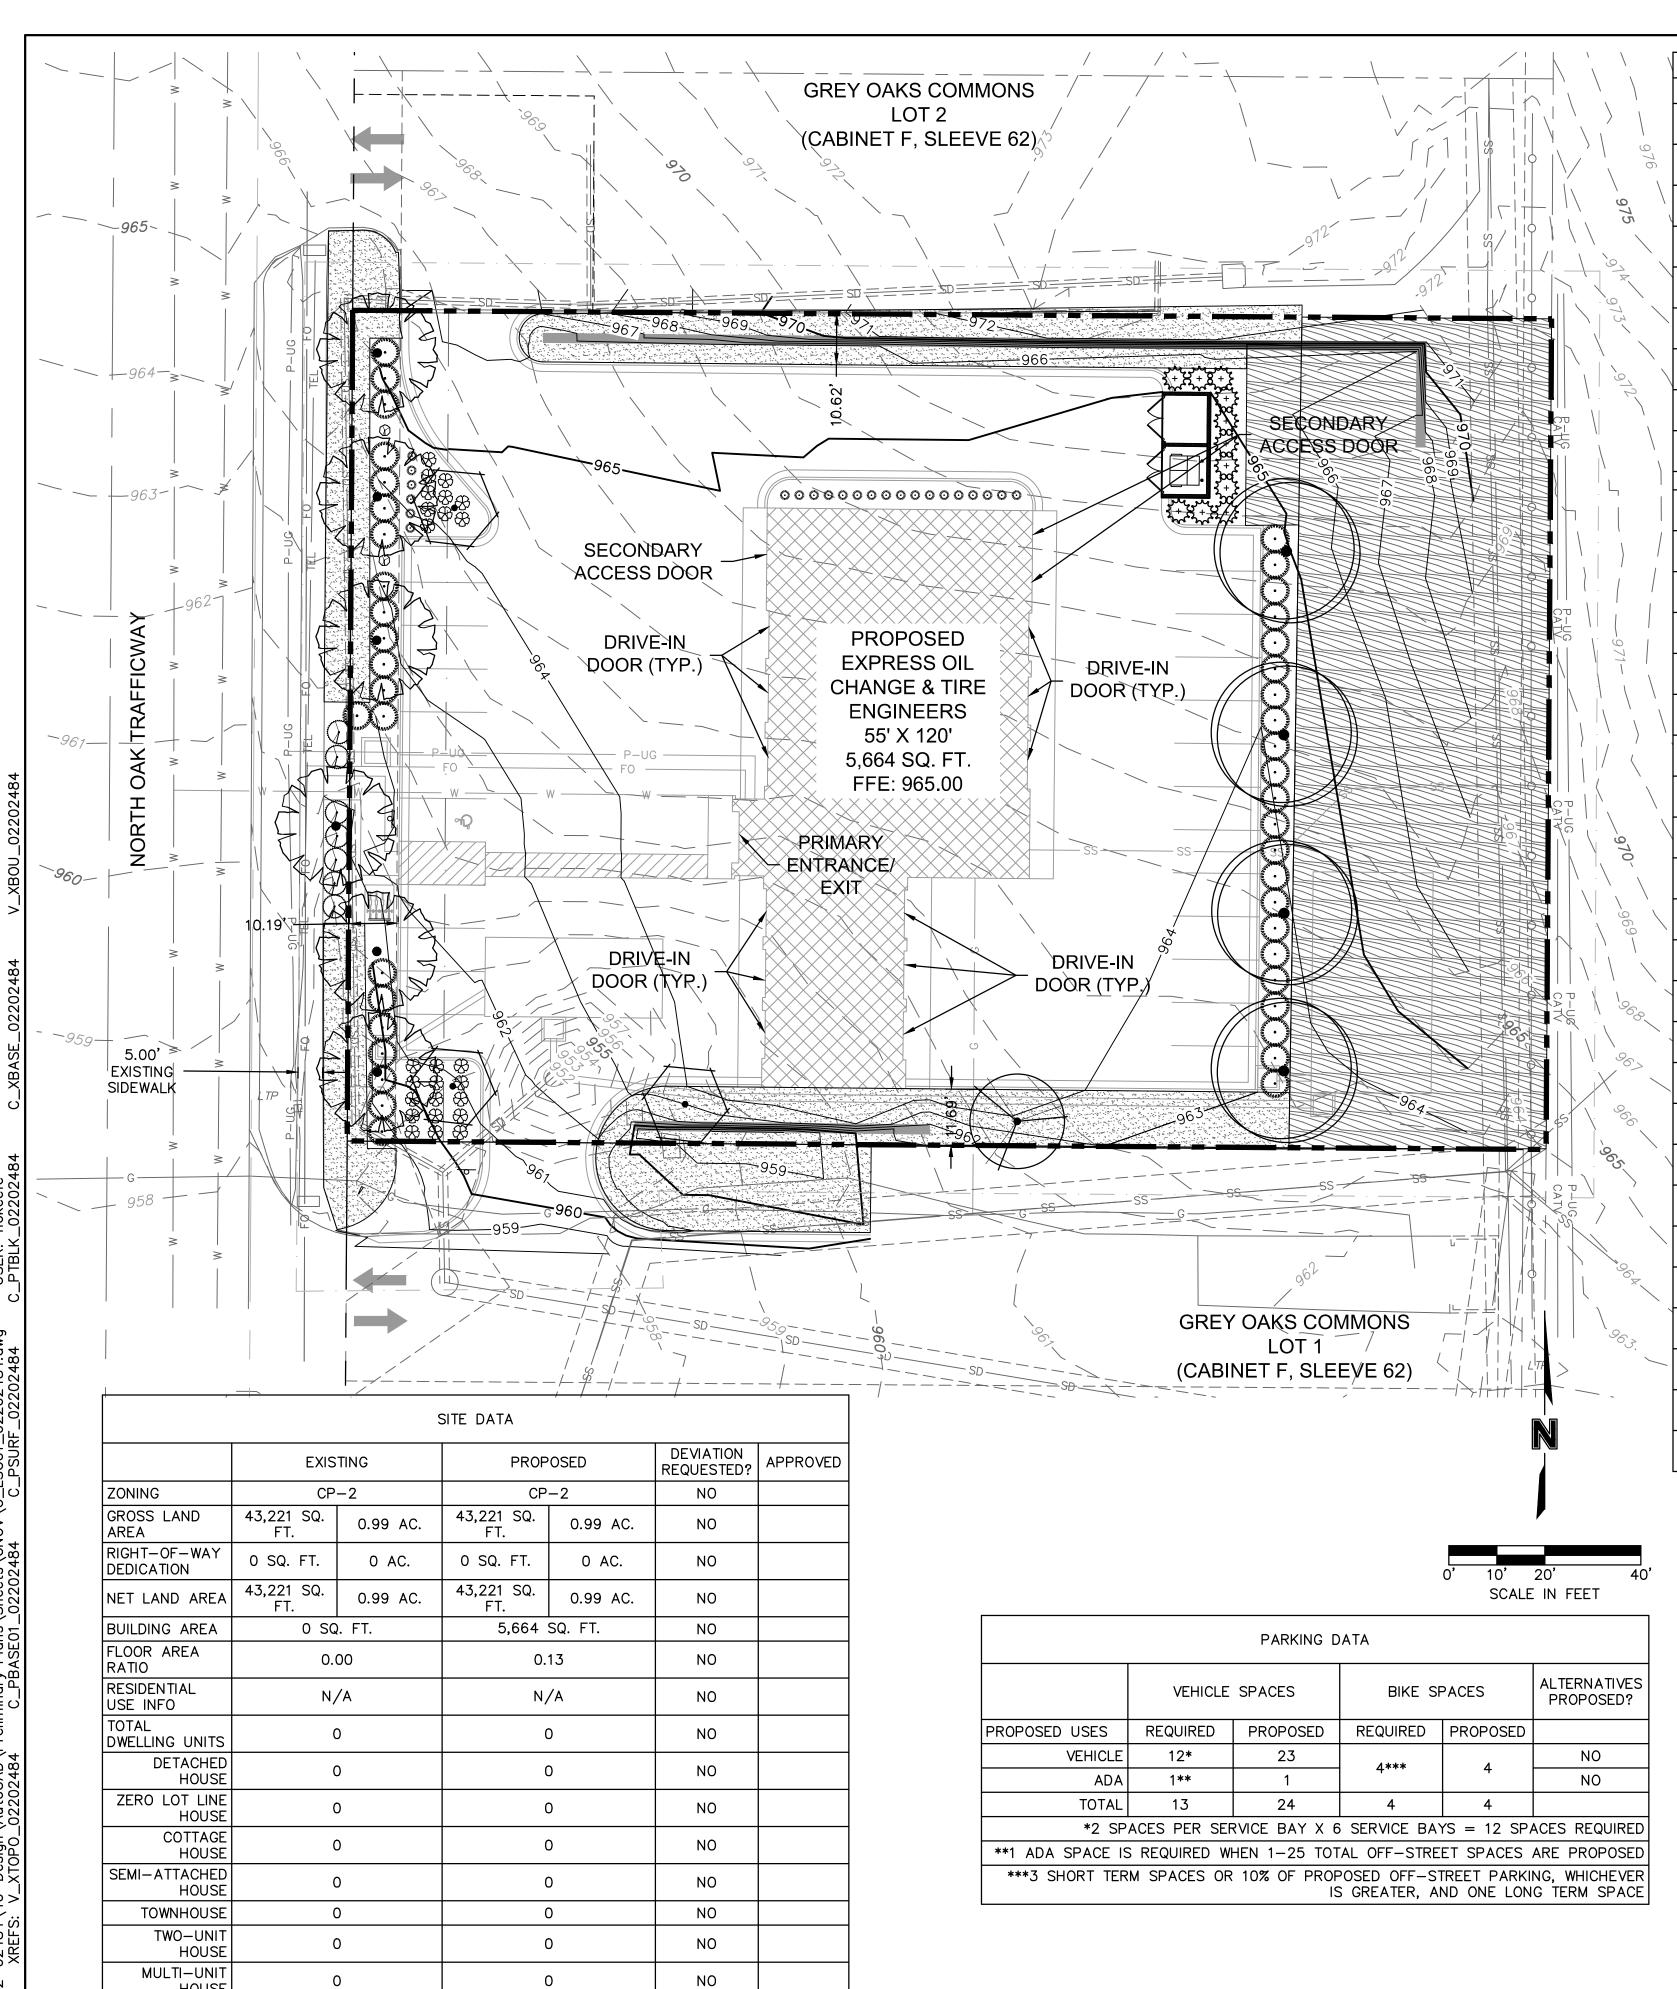

HOUSE COLONNADE

MULTIPLEX

BUILDING

MULTI-UNIT

RESIDENTIAL

PUBLIC/CIVIC

COMMERCIAL

INDUSTRIAL

OTHER

TOTAL LOTS

0

0

1

0

0

0

0

0

0

0

0

NO

NO

BIG BLUESTEM (KAW) ANDROPOGON GERARDII	2
CANADA WILDRYE ELYMUS CANADENSIS	10
INDIANGRASS (OSAGE) SORGHASTRUM NUTANS	2
LITTLE BLUESTEM (ALDOUS) SCHIZACHYRIUM SCOPARIUM	2
SIDEOATS GRAMA (EL RENO) BOUTELOUA CURTIPENDULA	6.3
STERILE WHEATGRASS REGREEN/QUICK GUARD	10
SWITCHGRASS (BLACKWELL) PANICUM VIRGATUM	0.7
TALL DROPSEED SPOROBOLUS COMPOSITUS	0.5
WESTERN WHEATGRASS (BARTON) PASCOPYRUM SMITHII	4
BUTTERFLY MILKWEED ASCLEPIAS TUBEROSA	0.3
COMMON MILKWEED ASCLEPIAS SYRIACA	0.3
BLACK EYED SUSAN RUDBECKIA HIRTA	0.3
BLANKET FLOWER GAILLARDIA X GRANDIFLORA	0.5
FALSE SUNFLOWER HELIOPSIS HELIANTHOIDES	0.5
LANCE-LEAF COREOPSIS COREOPSIS LANCEOLATA	0.5
MAXIMILIAN SUNFLOWER HELIANTHUS MAXIMILIANI	0.2
NEW ENGLAND ASTER ASTER NOVAE—ANGLIAE	0.1
PINNATE PRAIRIE CONEFLOWER RATIBIDA PINNATA	0.2
PLAINS COREOPSIS COREOPSIS TINCTORIA	0.2
PURPLE CONEFLOWER ECHINACEA PURPUREA	0.3
UPRIGHT PRAIRIE CONEFLOWER RATIBIDA COLUMNIFERA	0.3
DAMES ROCKET HESPERIS MATRONALIS	0.3
LEMON MINT MONARDA CITRIODORA	0.3
PITCHER SAGE SALVIA AZUREA	0.2
WLD BERGAMOT MONARDA FISTULOSA	0.2
ILLINOIS BUNDLEFLOWER DESMANTHUS ILLINOENSIS	1
COMMON EVENING PRIMROSE OENOTHERA BIENNIS	0.2
HOARY VERBENA VERBENA STRICTA	0.1
PURPLE PRAIRIE CLOVER DALEA PURPUREA	0.8
ROUNDHEAD LESPEDEZA LESPEDEZA CAPITATA	0.3
SHOWY PARTRIDGE PEA CHAMAECRISTA FASCICULATA	3.0
WHITE PRAIRIE CLOVER DALEA CANDIDA	0.2
TOTALS:	47.8

NATIVE VEGETATION SEED MIX

PLS RATE: LBS./AC

COMMON/ SCIENTIFIC NAME

BIG BLUESTEM (KAW)

*A COVER CROP OF ANNUAL RYE SHALL BE SEEDED AT A RATE OF 120 LBS/ACRE IN ALL NATIVE SEEDED AREAS. THE COVER CROP SHALL BE SEEDED SEPARATELY FROM THE NATIVE SEED.
*USE 80 LBS./AC. OF FERTILIZER (15-30-15)


88-425 LANDSCAPE REQUIREMENTS					
	REQUIRED	PROPOSED			
88–425–03 STREET TREES N. OAK TRAFFICWAY	1 TREE PER 30' OF STREET FRONTAGE (197 LF)	6 TREES			
88-425-04 GENERAL	1 TREE PER 5,000 SF OF BUILDING FOOTPRINT	1 PROPOSED TREES			
88-425-05 PERIMETER VEHICULAR USE AREA ADJACENT TO STREETS BUFFER WIDTH TREES SHRUBS/WALL/BERM		10' WIDE 3 TREES 32 EVERGREEN SHRUB			
88-425-05 PERIMETER VEHICULAR USE AREA ADJACENT RESIDENTIAL					
BUFFER WIDTH SHRUBS/WALL/BERM		41' WIDE 21 EVERGREEN SHRUB			
88–425–06 INTERIOR VEHICULAR USE AREA					
INTERIOR AREA TREES SHRUBS	35 SF PER EACH SPACE 1 PER 5 SPACES 1 PER SPACE	BUFFER WIDTH 4 TREES 21 SHRUBS			
88-425-09 MECHANICAL/UTILITY EQUIPMENT SCREENING	SCREENED FROM PUBLIC VIEW	SEE PLAN			

PLANT_SCHEDULE					
88-425-03 STREET TREES	BOTANICAL / COMMON NAME	SIZE	CALIPER		QTY
E. S.	ULMUS PROPINQUA 'EMERALD SUNSHINE' EMERALD SUNSHINE ELM	В & В	2'' CAL		6
88-425-04 GENERAL	BOTANICAL / COMMON NAME	SIZE	CALIPER		QTY
	NYSSA SYLVATICA 'WILDFIRE' WILDFIRE TUPELO	В & В	2" CAL		1
88-425-05 VEHICULAR USE ADJACENT TO STREET	BOTANICAL / COMMON NAME	SIZE	CALIPER		QTY
•	ZELKOVA SERRATA 'MUSASHINO' SAWLEAF ZELKOVA	В & В	2'' CAL		3
AND STANAMEN	JUNIPERUS CHINENSIS 'SEA GREEN' SEA GREEN JUNIPER	36" HT.			21
	BUXUS SEMPERVIRENS 'DERUNK' AMERICAN BOXWOOD	5 GAL			2
88-425-05 VEHICULAR USE ADJACENT TO RES.	BOTANICAL / COMMON NAME	SIZE	CALIPER		QTY
MANAGE ENGLANDS	JUNIPERUS CHINENSIS 'SEA GREEN' SEA GREEN JUNIPER	36'' HT.			22
88-425-06 INTERIOR VEHICULAR USE	BOTANICAL / COMMON NAME	SIZE	CALIPER		QTY
$\overline{}$	QUERCOUS BICOLOR SWAMP WHITE OAK	В & В	2" CAL		4
\\$	DIERVILLA RIVULARIS 'KODIAK ORANGE' KODIAK ORANGE BUSH-HONEYSUCKLE	5 GAL			25
one of the second	PANICUM VIRGATUM 'NORTH WIND' NORTHWIND SWITCH GRASS	1 GAL			23
88-425-08 SCREENING	BOTANICAL / COMMON NAME	SIZE	CALIPER		QTY
2 + C	JUNIPERUS CHINENSIS 'SPARTAN' SPARTAN JUNIPER	B&B 5-6' HT.			11
\bigcirc	JUNIPERUS CHINENSIS 'GOLD LACE' GOLD LACE JUNIPER	36" HT.			7
GROUND COVERS	BOTANICAL / COMMON NAME	CONT		SPACING	
	FESTUCA TURF TYPE TALL FESCUE BLEND	SOD			10,221 SF
NATIVE VEGETATION SEED MIX	BOTANICAL / COMMON NAME	CONT		SPACING	
	NATIVE VEGETATION SEE NATIVE VEGETATION MIX NOTES	SEED			9,561 SF

DEVELOPMENT PLAN LANDSCAPE PLAN SS OIL CHANGE & TIRE ENGINEERS 7841 N OAK TRAFFICWAY	DESCRIPTION PMENT REVIEW COMMENTS	
<u><</u> -	REVISIONS	

date: 2022.06.27

SHEET

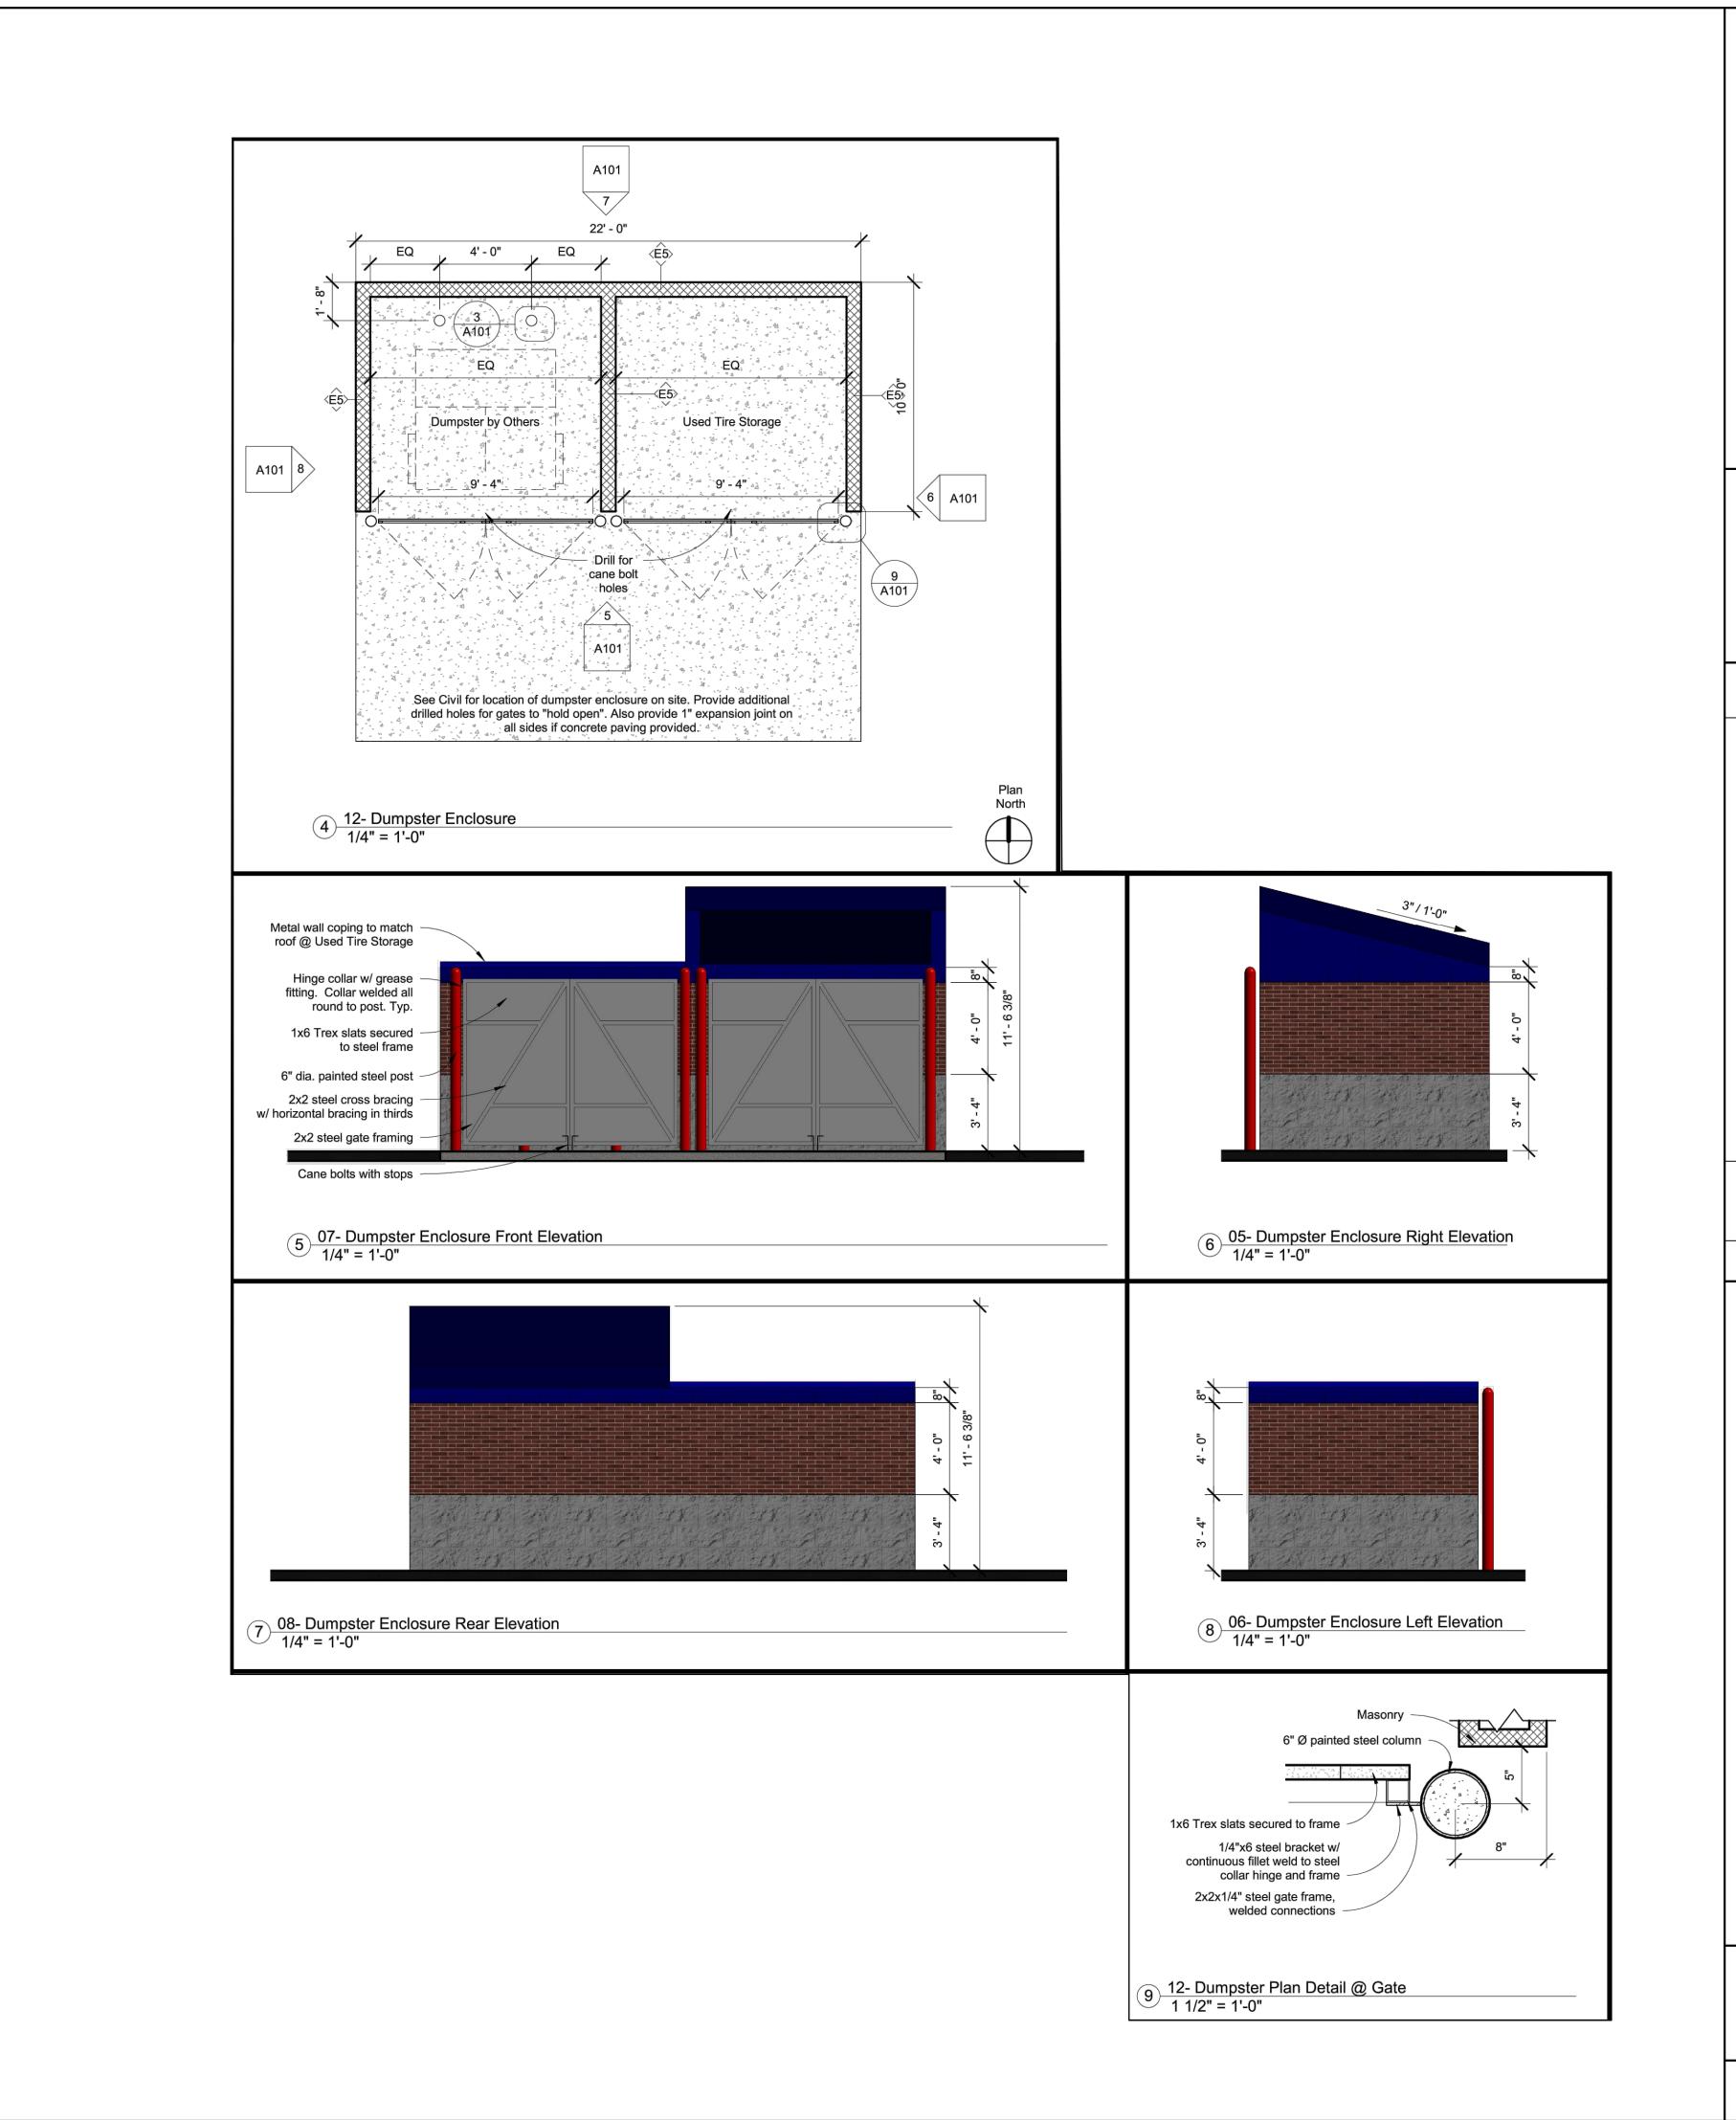

EXPRESS OIL CHANGE & TIRE ENGINEERS 7841 N OAK TRAFFICWAY DEVELOPMENT PLAN DUMPSTER ELEVATIONS

drawn by: checked by: approved by: QA/QC by: project no.: 022-02484
drawing no.: 0222.06.27

SHEET A101



AHO ARCHITECTS, LLC

www.ahoarch.com

NOT FOR CONSTRUCTION

Express Oil Change & Tire Engineers
Single Building - Right Hand Oil Change w / Side Tire Storage

CONCEPTUAL				
No.	Description	Date		
	022 Aba Arabita	ete II		


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Exterior Elevation - Front

Project number	TB
Date	06/02/202
Drawn by	AR
Checked by	TA

A200

As indicated

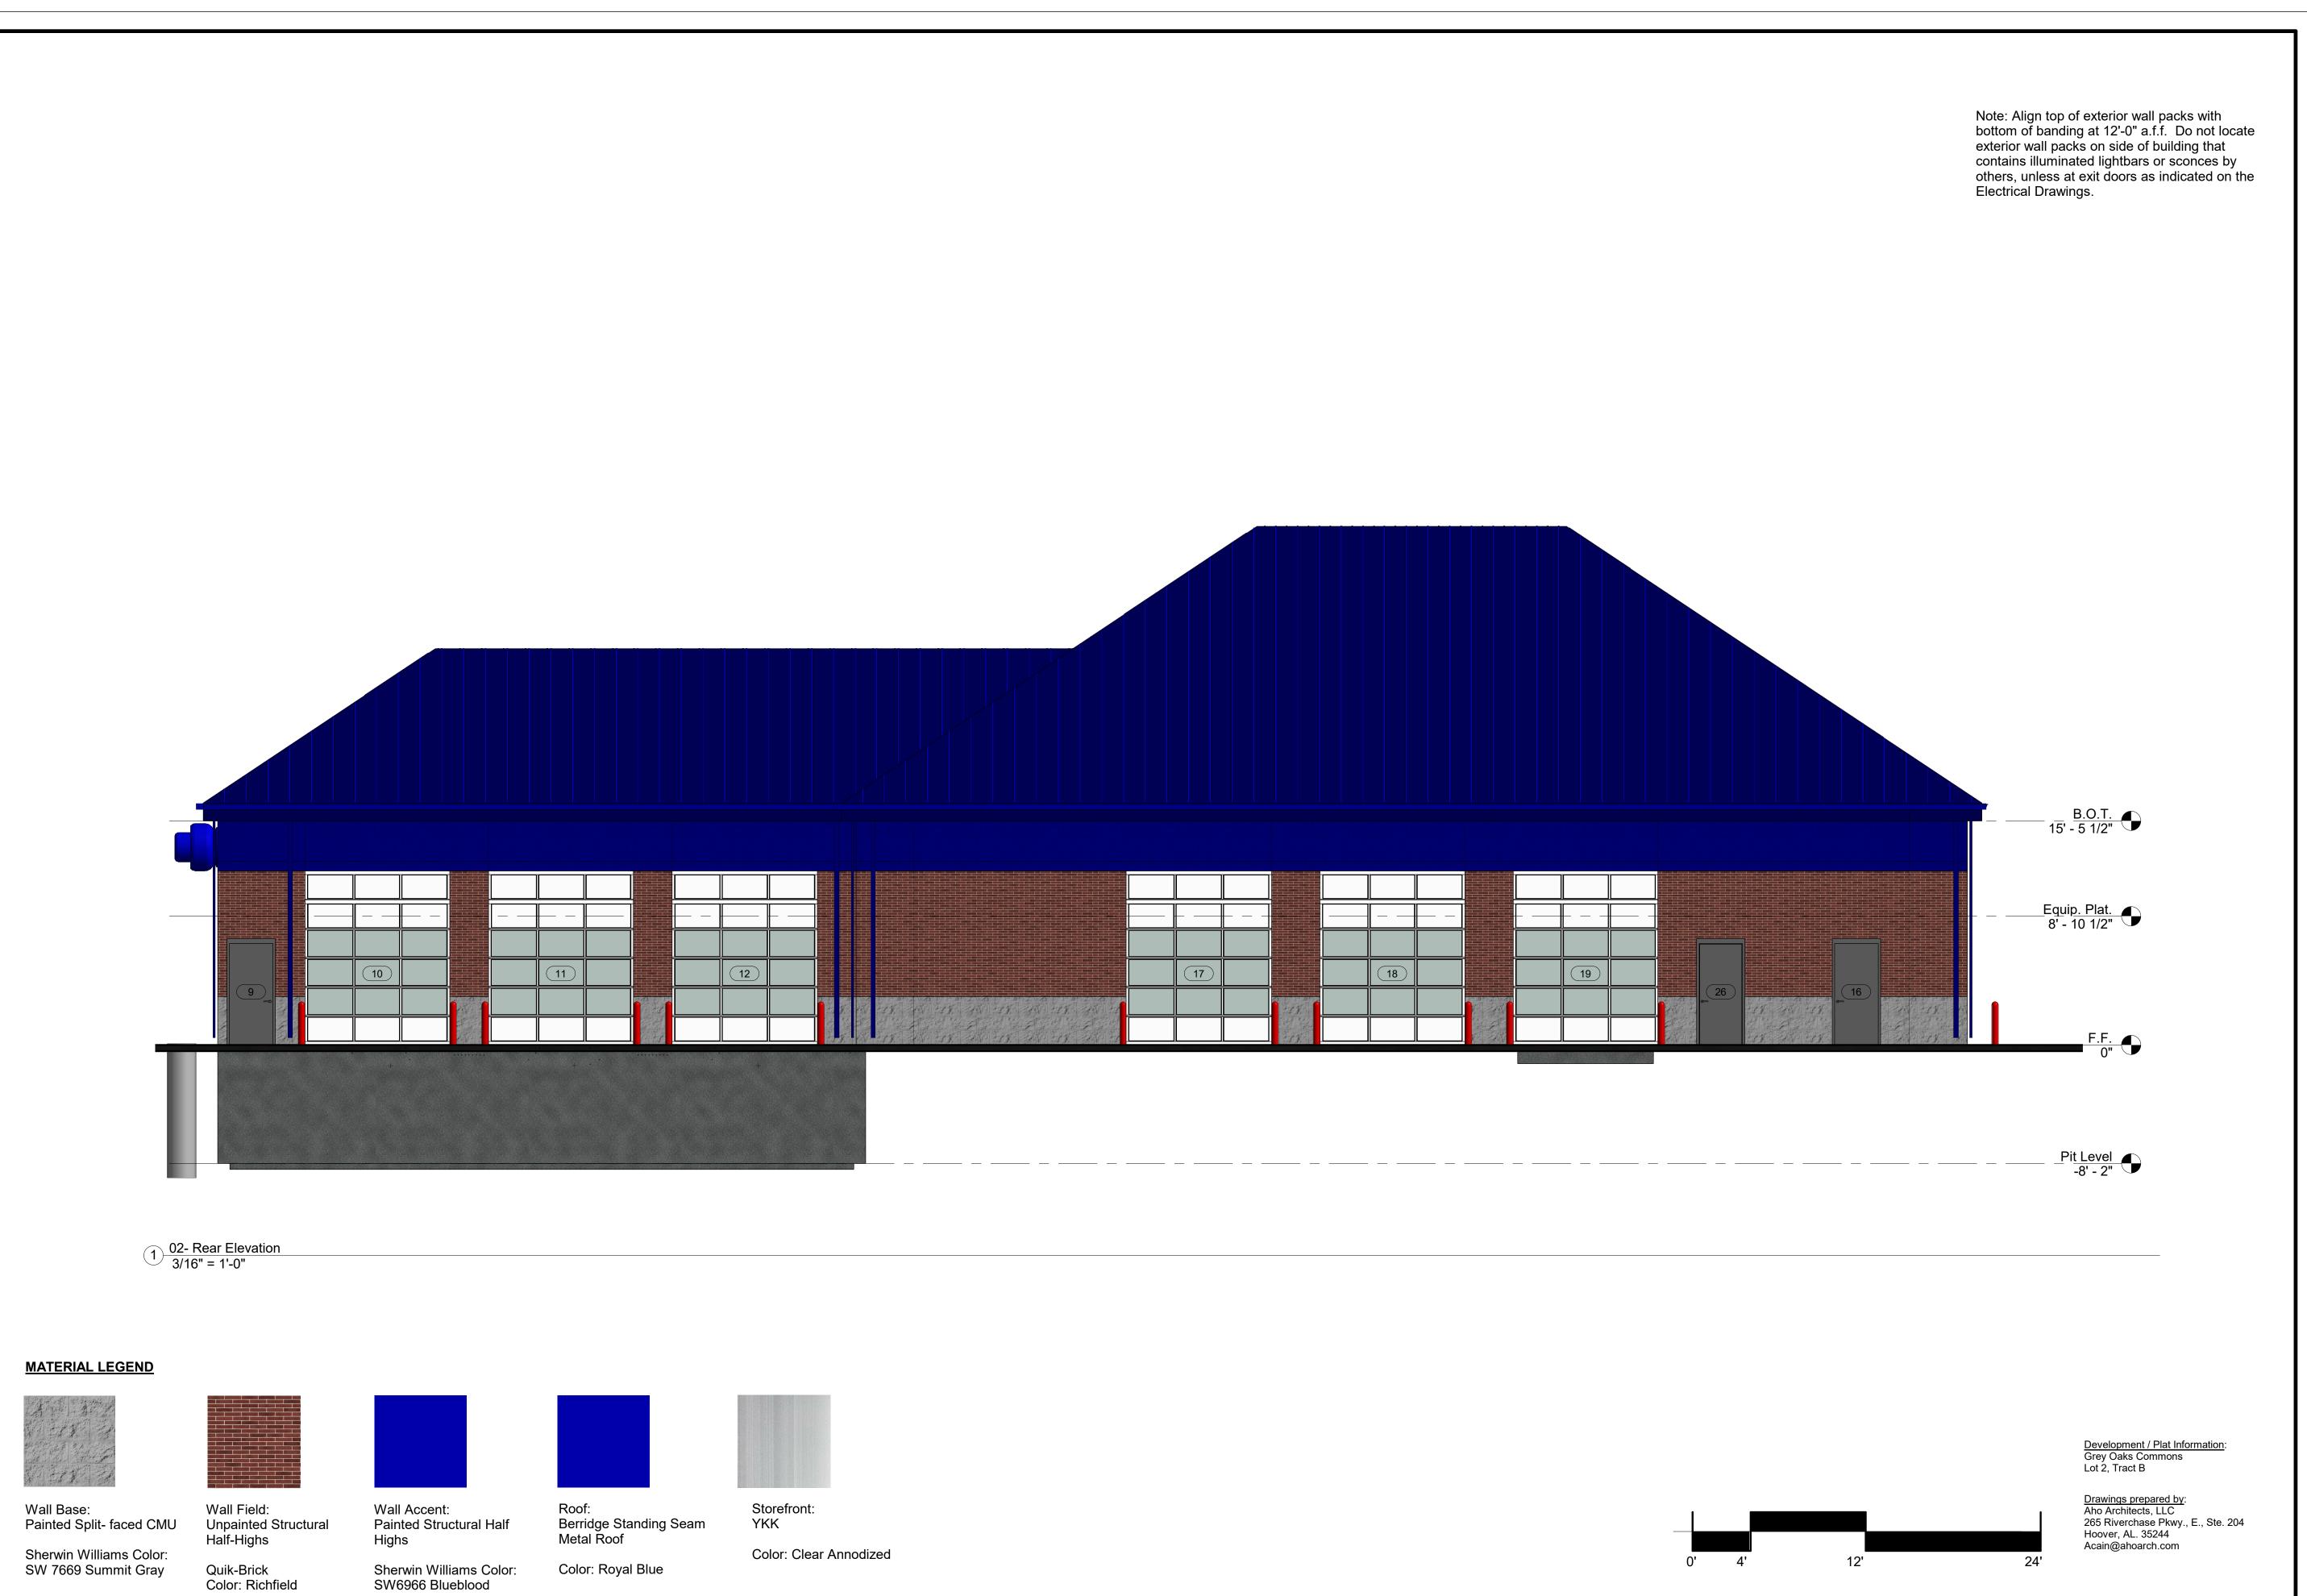

AHO ARCHITECTS, LLC

www.ahoarch.com

NOT FOR CONSTRUCTION

Express Oil Change & Tire Engineers Single Building - Right Hand Oil Change w / Side Tire Storage

CONCEPTUAL

Description

O. Description Da

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Exterior Elevation - Rear

Project number TBD

Date 06/02/2022

Drawn by ARC

Checked by
A201

A201

cale As indicated

ARC
TAA
dicated

Note: Align top of exterior wall packs with bottom of banding at 12'-0" a.f.f. Do not locate exterior wall packs on side of building that contains illuminated lightbars or sconces by others, unless at exit doors as indicated on the Electrical Drawings. AHO ARCHITECTS, LLC www.ahoarch.com Engineers Side Oil Change B.O.T. 15' - 5 1/2" ∞ Change Hand Equip. Plat. 8' - 10 1/2" Ö Express Building CONCEPTUAL Description 1 04- Left Elevation 3/16" = 1'-0" © 2022 Aho Architects, LLC. All Rights Reserved. **MATERIAL LEGEND** Exterior Elevation -Left <u>Development / Plat Information</u>: Grey Oaks Commons Lot 2, Tract B

Storefront:

Color: Clear Annodized

YKK

Berridge Standing Seam Metal Roof

Color: Royal Blue

Wall Field:

Haİf-Highs

Quik-Brick

Color: Richfield

Unpainted Structural

Wall Accent:

Painted Structural Half

Sherwin Williams Color:

SW6966 Blueblood

Wall Base:

Painted Split- faced CMU

Sherwin Williams Color:

SW 7669 Summit Gray

06/02/2022
ARC
TAA

12

As indicated

TBD

Project number

Drawn by

Checked by

Drawings prepared by:
Aho Architects, LLC
265 Riverchase Pkwy., E., Ste. 204
Hoover, AL. 35244
Acain@ahoarch.com

Note: Align top of exterior wall packs with bottom of banding at 12'-0" a.f.f. Do not locate exterior wall packs on side of building that contains illuminated lightbars or sconces by others, unless at exit doors as indicated on the Electrical Drawings. 15' - 5 1/2" 1 03- Right Elevation 3/16" = 1'-0" MATERIAL LEGEND <u>Development / Plat Information</u>: Grey Oaks Commons Lot 2, Tract B

Wall Field:

Half-Highs

Quik-Brick

Color: Richfield

Unpainted Structural

Wall Accent:

Painted Structural Half

Sherwin Williams Color:

SW6966 Blueblood

Storefront:

Color: Clear Annodized

YKK

Berridge Standing Seam

Metal Roof

Color: Royal Blue

Wall Base:

Painted Split- faced CMU

Sherwin Williams Color:

SW 7669 Summit Gray

AHO ARCHITECTS, LLC

www.ahoarch.com

Engineers ∞ Change Ö Express

Oil Change

Hand

Building

CONCEPTUAL

Description


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Exterior Elevation -Right

TBD Project number 06/02/2022 Drawn by Checked by


Drawings prepared by:
Aho Architects, LLC
265 Riverchase Pkwy., E., Ste. 204
Hoover, AL. 35244
Acain@ahoarch.com

As indicated

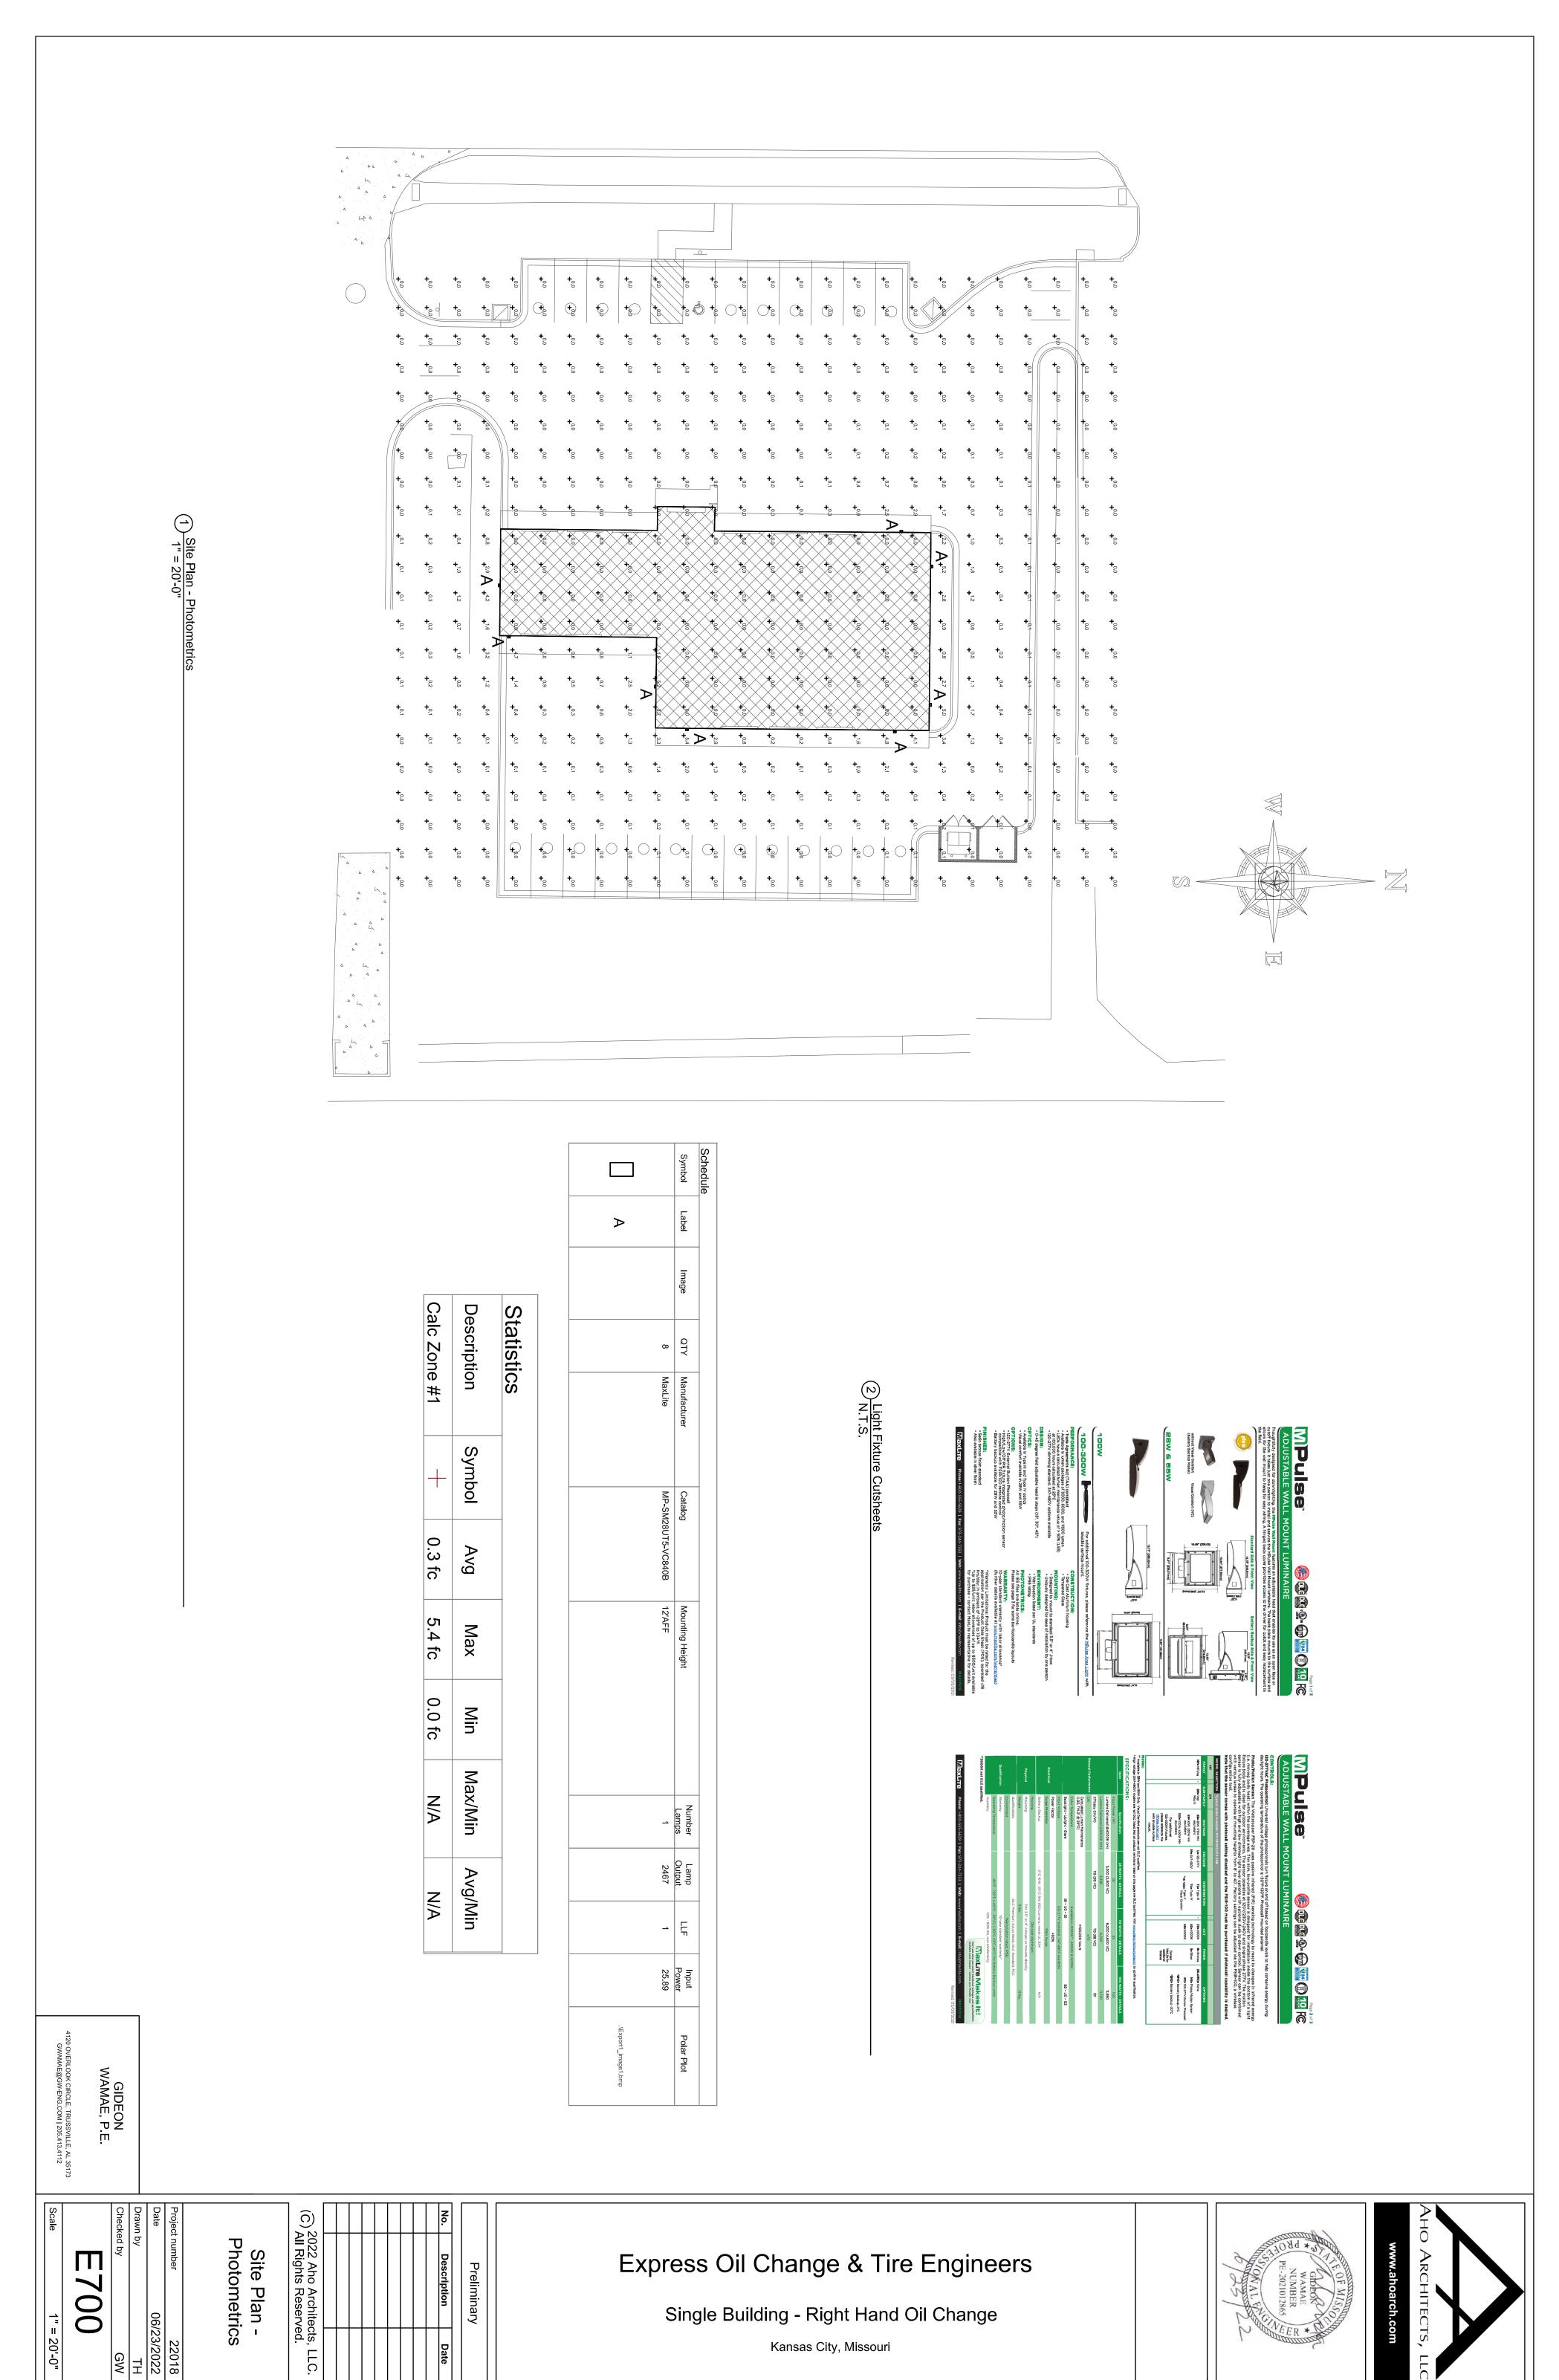

6/4/2022 12:03:16 AM

Oak Road - Kansas City, MO

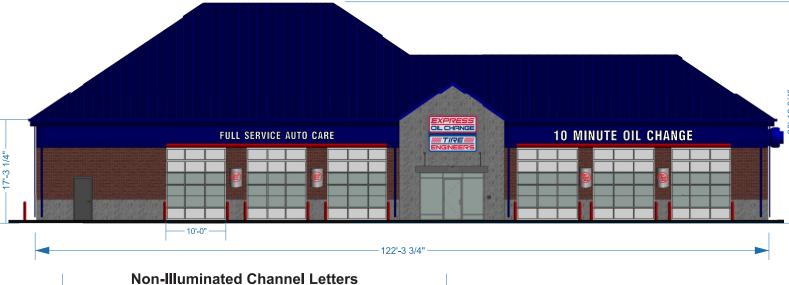

SERVICE AUTO

Decorative Wall Pack



Scale 1/16"=1' Raceways to match Blue



6'x8' Building sign



SCALE

1/16"=1"

ELEVATION

19

Page

1 of

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Complete Sign

85–6/82SALES REP: John Reynolds
DESIGN BY: Larry

Building 6-14-22.cdr

Oak Road - Kansas City, MO

01- Rear Elevation 1/16" = 1'-0"



SCALE

Ш

1/16"=1"

LOCATION: Kansas City, MO
DATE: 06-14-2022

SALES REP: John Reynolds
DESIGN BY: Larry

Complete Sign 11-285-5732Fabrication, Installation & Service

Building 6-14-22.cdr

Page 2 of 3

INSTALLATION ENGINEERING DRAWINGS PER INSTALLATION



Complete Sign

Fabrication,

Installation ß

THIS DRAWING IS DESIGN CREATED BY NOT TO BE REP POWER TO ANYON WHOLE OR IN PART WHOLE OR THE OWNER IT SUCHACTIONS MAY BE SUCHACTIONS MAY BE COURTOF LAW. Building

6-14-22.cdr

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CAL Ш Ш 1/1 ြ ရ

LED Box Cabinet Sign Can

1. LED Sign Cabinet/Can

Threaded Bolts W/ Flare Tip

Anchors and Fender Washers 3. Disconnect Switch on Cabinet 5. 120 VAC - 4-5 AMP LED Driver(s)

LOCATION: DATE:

Kansas City, MO 06-14-2022


SALES REP: John Reynolds
DESIGN BY: Larry

ELEVATION

19

NON-ILLUMINATED CHANNEL LETTERS (5)- I. JEWELLITE TRIMCAP
 SILCOME SEM. TYPICAL
 I. MITERIOR PRINTED UNITE
 I. OST ALUMINUM BACK
 SYMP PLEK FACE
 IN TEEP HOLES WITH BAFFLES AS REQUIRED
 I. ALUMINUM FACE SIT THE PANTED TO
 I. ALUMINUM FACE SIT THE PANTED TO
 COLLARED DO DONCRETE PIN ATTACHMENT
 HARDWARE PER CONDITIONS (4)

- 1" Trimcap/Jewlite Retainers Silicone Seal
- Interior White for Illumination .063 Aluminum Back 3/16" Acrylic Faces
- Weep Holes for draining .040 Baked Enamel Aluminum Returns Aluminum 1"x1" Sq. Tube
- Painted To Match Building Color Collared Concrete Pin Attachment Hardware Per Conditions

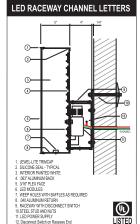


- 1. 1" Gold Trimcap/Jewlite Retainers
- Baked Enamel Aluminum Returns
- Interior White for Illumination .063 Aluminum Back 3/16" Acrylic Faces
- LED's Weep Holes for draining
- .040 Baked Enamel Aluminum Returns Aluminum Raceways Painted To Match Building
- Color 10. Steel Studs, Washers & Nuts Attachment Hardware Per



O MINUTE OIL GHANGE SERVICE AUTO



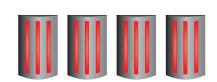

Oak Road - Kansas City, MO





Public Meeting Summary Form

Project Case # CD-CPC-2022-00119

Meeting Date: July 28, 2022

Meeting Location: Gashland Presbyterian Church (8029 N Oak Trafficway)

Meeting Time (include start and end time): 6:00pm-7:00pm

Additional Comments (optional):

- -zero opposition from the neighbors; happy to have this type of business as their neighbor
- -questioned the types of proposed trees and associated diseases
- -confirmed that Express Oil will help maintain the white fence to the east of the property
- -questioned the height of the building but ultimately were not concerned
- -asked about traffic patterns at the north entrance/exit of the adjacent Casey's
- -asked about underground detention feature for explanation on its function
- -asked about building floor elevation relative to Casey's
- -asked about the distance and buffer from the parking lot to the east property line
- -asked about signage and lighting on the building
- -asked to confirm that existing north and south access would be the only access for Express Oil

Meeting Sign-In Sheet

Project Name and Address

Express Oil Change & Tire Engineers; 7841 N Oak Trafficway

Express Oil Change & Tire Engineers; 7841 N Oak Trafficway

Name	Address	Phone	Email
Barbara Owens	7908 N. Locust St.	(816) 321-2532	
Barbara Shortess	7907 N. Locust St.	(816) 454-7867	
Barbara Wilson	7910 N. Locust St.	(816) 436-6489	
Ray & Clara Hoffman	7906 N. Locust St.	(816) 436-4755	
Larry Wickham	7912 N. Cherry St.	(816) 420-0554	
Joe Blankenship	7911 N. Locust St.	(314) 406-5077	