

# CITY PLAN COMMISSION STAFF REPORT

City of Kansas City, Missouri
City Planning & Development Department
<a href="https://www.kcmo.gov/cpc">www.kcmo.gov/cpc</a>

October 18, 2022

#### **Project Name**

The Depot on Old Santa Fe

#### Docket #10

#### Request

CD-CPC-2022-00161 Rezoning to UR/MPD (Residential Development Plan) & Preliminary Plat

#### **Applicant**

Emma McClung Kittle Property Group

#### Owner

Kittle Property Group

Location 9100 Old Santa Fe Road

Area About 32 acres

Zoning UR Council District 5<sup>th</sup>

County Jackson

School District Hickman Mills 140

## **Surrounding Land Uses**

North: Institutional, zoned R-7.5

**South:** Residential, zoned R-1.5, R-5, R-7.5

**East:** Residential, zoned R-7.5 **West:** Commercial, zoned UR

#### **Major Street Plan**

Old Santa Fe and E. 93<sup>rd</sup> Street are not identified on the City's Major Street Plan.

#### **Land Use Plan**

The Hickman Mills Area Plan recommends office/residential for the land use.

#### APPROVAL PROCESS



#### **PROJECT TIMELINE**

The application for the subject request was filed on 08/29/2022. No Scheduling deviations from 2022 Cycle T have occurred.

#### REQUIRED PUBLIC ENGAGEMENT

Public engagement as required by 88-505-12 does apply to this request. The applicant hosted a meeting on 09/14/2022. A summary of the meeting is attached to the staff report, see Attachment #3.

#### **EXISTING CONDITIONS**

The subject property is undeveloped, heavily wooded and has several steep slopes making it a very challenging site to develop.

## **SUMMARY OF REQUEST**

A request to approve a UR Development Plan and Preliminary Plat for 252 residential units on about 32 acres generally located at E. 93rd Street and Old Santa Fe Road.

#### **CONTROLLING + RELATED CASES**

The City Plan Commission meeting on November 6, 2007 recommended approval of **Case No. 6720-URD-14** to rezone to UR and the approval of a development plan for a commercial and residential development.

#### PROFESSIONAL STAFF RECOMMENDATION

Docket # Recommendation

10 Approval with Conditions

#### **PLAN REVIEW**

Prior to 2007, before the parcel was rezoned to UR (Urban Redevelopment) it was previously zoned R-1a which permitted single detached dwelling units. The UR plan (Case No. 6720-URD-14) proposed a multi-purpose practice field at this location when it was thought that the Kansas City Wizards (now Sporting KC) were going to build their stadium where Bannister Mall was once located. The applicant is required to rezone from UR to UR because they are proposing to construct seven (7) multi-unit buildings for a total of 252 dwelling units. The proposed location for this development is filled with old-growth trees and severe slopes which makes this a very challenging site for any type of development. Due to the challenging terrain the applicant has been conditioned to coordinate with Public Works and the Land Development Division of City Planning and Development to create a deferral agreement pertaining to the half street improvements required by 88-405 of the Zoning and Development Code. The applicant is continuing discussions with Parks and Recreation to determine the final amount that will be due required by 88-408 (Parkland Dedication). Three important elements staff considered when reviewing this project were how many trees would be preserved, pedestrian safety and circulation and compatibility of the proposed use with the surrounding area. Staff has worked with the applicant to ensure that the City and surrounding area will benefit from this private investment while making sure that the proposed plan complies with the Zoning and Development Code.

### **PLAN ANALYSIS**

The applicant is proposing to construct seven (7) multi-unit buildings for a total of 252 dwelling units on roughly 32 acres of undeveloped land with steep slopes and old growth vegetation. The proposed density of 8.4 units per acre is supported by staff and complements the density found within the immediate area. The site will require major grading, utility extensions and retaining walls due to the existing conditions. For this difficult site to be developed within a feasible budget the applicant is asking if the City will accept a deferral agreement prior to the recording of the final plat. The deferral agreement will allow the applicant to establish an agreement between Public Works, Land Development Division and the City Law Department related to the half street improvements along Old Santa Fe Road and E. 93rd Street that section 88-405 requires. The applicant is seeking a waiver from constructing half street improvement to E. 91st Street since it only serves as an access road for Kansas City Southern Railway. City staff supports the waiver to E. 91st Street since it does not function as a public street and dead ends at the Kansas City Southern railroad tracks.

The proposed parcel not only has a challenging topography but a regulatory stream running through the north-central area of the parcel to be developed, therefore the applicant must provide a stream buffer plan. The applicant will continue to work with KC Water to ensure that their stream buffer plan complies with City Code and KC Water's rules and regulations pertaining to stream buffer plans. Related to the stream buffer and this site never being developed there is a tremendous amount of existing vegetation and large diameter trees. City staff would like to applied the applicant for providing a meaningful tree removal plan; the tree removal plan specifically calls out which trees the applicant intends to preserve and shows how existing trees are incorporated into the overall landscape plan for the entire site. The applicant stated that they plan to preserve at least 45% of the trees found on site and the overall landscape plan also notes that the developer intends to "save and protect all existing mature and healthy trees 12" + caliper along E. 93rd Street" and "save and protect all existing mature and healthy trees 6" + caliper along Old Santa Fe Road."

Staff appreciates that the applicant has complied with 88-450 (Pedestrian Standards) of the Zoning and Development Code to construct raised pedestrian crossings where feasible and will provide embossed or textured sidewalks where raised pedestrian crossings do not allow for proper stormwater drainage. The applicant did ensure that the raised crossings are located in high traffic areas near the entrance and amenity area.

The applicant is continuing to coordinate with Parks and Recreation regarding the parkland dedication requirement pursuant to 88-408 of the Zoning and Development Code. Due to the amount of private and public infrastructure required to develop this site the applicant is seeking to provide a combination of parkland dedication and payment in lieu to comply with the requirements of 88-408. The final agreement must be determined prior to the final plat being recorded or any certificate of occupancy being issued.

The general design and materials of the proposed seven (7) buildings complies with the Hickman Mills Area Plan, except that staff has asked the applicant to replace the proposed vinyl with a higher quality building material. Although vinyl is not outright prohibited in the Zoning and Development Code staff generally discourages this proposed material for any project which sets a poor precedent. The Hickman Mills area plan explicitly calls for materials that include brick, wood, metal, glass, concrete, stone, stucco, cast stone, terracotta, tile and masonry. The applicant has agreed to work with Development Management staff to remove the proposed vinyl and incorporate higher quality building materials.

#### \*indicates adjustment/deviation

Standards	Applicability	Meets	More Information
Subdivision Design and Improvements Standards (88-405)*	Yes	Yes, subject to conditions	Staff supports a waiver to ½ street improvements to E. 91st Street.
Pedestrian Standards (88-450)	Yes	Yes	The applicant worked with staff to establish safer pedestrian circulation.
Parkland Dedication (88-408)	Yes	Yes, subject to conditions	The applicant has stated they will make a payment in lieu and dedicate an undetermined amount of parkland.
Parking and Loading	Yes	Yes	Affordable housing only
Standards (88-420)			requires $\frac{1}{2}$ the required parking.
Landscape and Screening Standards (88-425)	Yes	Yes, subject to conditions	Staff will require the UR Final Plan to include more information related to fence and dumpster materials, including additional landscaping around utility equipment.
Outdoor Lighting Standards (88-430)	Yes	Yes, subject to conditions	

Sign Standards (88-445)	Yes	Yes, subject to conditions	
Pedestrian Standards (88-450)	Yes	Yes	The proposed plan complies with 88-450.

#### SPECIFIC REVIEW CRITERIA

#### Zoning and Development Code Map Amendments, Rezonings (88-515-08)

In reviewing and making decisions on proposed zoning map amendments, the City Planning and Development Director, City Plan Commission, and City Council must consider at least the following factors:

#### A. Conformance with adopted plans and planning policies;

The Hickman Mills Area Plan recommends office and residential for this parcel, therefore the proposed project is in conformance with the adopted area plan.

#### B. Zoning and use of nearby property;

The existing zoning districts that are adjacent to this property are UR (Urban Redevelopment) on the west, institutional to the north, and residentially zoned to the south and east.

#### C. Physical character of the area in which the subject property is located;

The proposed development is situated on roughly 20 acres. The project site is undeveloped and is covered with old-growth trees and severe changes in slope.

# D. Whether public facilities (infrastructure) and services will be adequate to serve development allowed by the requested zoning map amendment;

Public infrastructure and services are within proximity to serve the proposed development. The applicant shall meet all City standards related to extending any infrastructure to the proposed site.

# E. Suitability of the subject property for the use to which it has been restricted under the existing zoning regulations;

The existing zoning is UR but does not permit the proposed development. Without rezoning, the desired use for this property is not possible.

# F. Length of time the subject property has remained vacant as zoned;

The subject property has never been developed.

#### G. The extent to which approving the rezoning will detrimentally affect nearby properties; and

The proposed rezoning would not detrimentally affect nearby properties; the proposed change in the zoning district would allow for the proposed residential development.

# H. The gain, if any, to the public health, safety, and welfare due to denial of the application, as compared to the hardship imposed upon the landowner, if any, as a result of denial of the application.

Denial of the rezoning would inhibit the use of the existing property.

#### Development Plans, Project Plan, or Site Plan (88-516-05)

In order to be approved, a development plan, project plan, or site plan must comply with all of the following criteria:

A. The plan must comply with all standards of the Zoning and Development Code and all other applicable city ordinances and policies;

The proposed plan complies with the Zoning and Development Code and all other applicable City ordinances and policies expect for one item. The applicant is seeking a waiver from 88-405-10-K which requires the construction of half street improvements to E. 91st Street. The applicant is also collaborating with Public Works and the Land Development Division of City Planning and Development to create a deferral agreement that must be submitted to the City prior to the recording of the final plat.

- B. The proposed use must be allowed in the district in which it is located;
  - The current approved plan does not permit the proposed project. Rezoning from UR to UR is required to allow for the proposed development.
- C. Vehicular ingress and egress to and from the site, and circulation within the site must provide for safe, efficient, and convenient movement of traffic not only within the site but on adjacent roadways;

  The proposed plan provides safe, efficient and convenient movement of traffic along E. 93rd Street and Old Santa Fe Road internally and within the development.
- D. The plan must provide for safe, efficient, and convenient non-motorized travel opportunities, being pedestrian and bicycle movement, on the subject site;

The applicant worked with City staff to provide raised pedestrians crossings where feasible. The applicant will also provide embossed or textured sidewalks where raised pedestrian crossings are not feasible.

E. The plan must provide for adequate utilities based on City standards for the particular development proposed.

The plan generally provides adequate utilities based on City standards.

F. The location, orientation, and architectural features, including design and material, of buildings and other structures on the site must be designed to be compatible with adjacent properties.

Staff originally asked for the building to be located along the southern perimeter of the site, unfortunately due to the topography and required grading the building could not be located along E. 93rd Street. Staff believes the general design and layout of the seven buildings is in general compliance of the Zoning and Development but has requested that the applicant substitute fiber cement siding for the proposed vinyl. The applicant will work with staff to make architectural improvements prior to the approval of a UR Final Plan which is required prior to obtaining a building permit.

G. Landscaping, berms, fences, and/or walls must be provided to buffer the site from undesirable views, noises, lighting, or other off-site negative influences and to buffer adjacent properties from negative influences that may be created by the plan.

The preliminary landscape plan generally complies with 88-425 of the Zoning and Development Code. Due to the site being elevated because of the grading that will need to occur staff believes that the proposed use and development will be buffered from adjacent properties. The applicant is proposing to maintain many of the existing trees that are located along the perimeter of E. 93<sup>rd</sup> Street and Old Santa Fe Road. The applicant has provided a meaningful and useful tree removal plan that illustrates how the old-growth trees can provide a natural buffer from adjacent properties. Staff has asked that the applicant provide details related to the fence material and height, dumpster material and additional screening of mechanical and utility equipment to be shown on the UR Final Plan prior to receiving a building permit.

H. The design of streets, drives, and parking areas within the project should result in a minimum of area devoted to asphalt or other impervious surfaces consistent with the needs of the project and city code requirements.

The applicant is proposing a mixture of surface and garage parking, totaling 455 stalls to serve 252 dwelling units. Staff does not believe the parking is excessive as there are no public streets nearby to allow for on-street parking which would alleviate parking constraints. Also, over half of the total dwelling units will be two and three bedroom units. No rapid transit is within walking distance and the proximity to Interstate 435 and US 71/ Interstate 49 prove the area that the existing neighborhood is an auto oriented area of Kansas City which can justify the dedicated parking area. A majority of the dwelling units will be two-bedroom and it is understandable that many of the residents may have two vehicles especially if they are roommates, domestic partners, etc.

 The plan must identify trees to be removed and trees to be preserved during the development of the subject property with the goal of saving trees that are not required to be removed for the development of the property.

The applicant has proposed to preserve 45% of the existing trees located on this property. The applicants plan also states that the owners intend to "save and protect all existing mature and healthy trees 12" + caliper along E. 93rd Street." and "save and protect all existing mature and healthy trees 6" + caliper along Old Santa Fe Road." Staff applauds the applicant for taking this section of the Code seriously and working diligently to provide a meaningful tree removal plan.

# **ATTACHMENTS**

- 1. Conditions Report
- 2. Applicants Submittal
- 3. Public Engagement Materials

### PROFESSIONAL STAFF RECOMMENDATION

City staff recommends **APPROVAL WITH CONDITIONS** as stated in the conditions report.

Respectfully Submitted,

Andrew Clarke Staff Planner

# KANSAS CITY Planning & Dev

## **Plan Conditions**

Report Date: October 13, 2022 Case Number: CD-CPC-2022-00161

Project: The Depot

Condition(s) by City Planning and Development Department. Contact Andrew Clarke at (816) 513-8821 / Andrew.Clarke@kcmo.org with questions.

1. The developer shall submit an affidavit, completed by a landscape architect licensed in the State of Missouri, verifying that all landscaping required of the approved plan has been installed in accordance with the plan and is healthy prior to Certificate of Occupancy.

- 2. All dumpsters, utility and mechanical equipment shall be screened pursuant to 88-425-08.
- 3. The developer shall submit an affidavit, completed by a landscape architect licensed in the State of Missouri, verifying that street trees have been installed in accordance with the approved street tree planting plan and are healthy prior to Certificate of Occupancy.
- 4. That the developer shall submit an affidavit, prepared by an engineer licensed in the State of Missouri, verifying that all outdoor lighting has been installed in accordance with approved plans and that lighting levels do not exceed that shown on the approved lighting plan at the property lines prior to Certificate of Occupancy.
- 5. The developer shall construct half street improvements that meet City standards and requirements along East 93rd Street and Old Santa Fe Road.
- 6. The developer shall secure approval of a UR final plan from Development Management Division staff prior to building permit.
- 7. The applicant shall work with Development Management staff to replace the proposed vertical 2x6 vinyl board with a higher quality building material prior to approval of the UR Final Plan.
- 8. A lighting plan that complies with 88-430 shall be submitted with the UR Final Plan prior to receiving any building permit.
- 9. The applicant shall resolve KC Water's correction pertaining to the preliminary steam buffer plan prior to receiving any building permit.
- 10. The applicant shall resolve KC Water's correction pertaining to the labeling of public and private water mains on the utility plan prior to receiving any building permit.
- 11. The developer shall include fence material and height on revised landscape plan before receiving any building permit.
- 12. The developer shall seek a waiver, to be listed on the preliminary plat sheet to section 88-405-10-K Half Streets.
- 13. The developer shall coordinate with Land Development Division and Public Works to develop a deferral agreement related to half street improvements prior to the recording of a final plat.

Condition(s) by City Planning and Development Department. Contact Terry Thomas at / Terry.A.Thomas@kcmo.org with questions.

- 14. The developer shall submit a Preliminary Stream Buffer plan prior to approval of the [Special Use /Development/Rezoning] plan in accordance with the Section 88-415 requirements.
- 15. The developer must submit covenants, conditions and restrictions to the Land Development Division for review by the Law Department for approval and enter into covenant agreements for the maintenance of any private open space tracts with stream buffer zones or stormwater detention area tracts, prior to recording the plat.
- 16. The developer must integrate into the existing street light system any relocated existing street lights within the street right-of-way impacted by the new drive or approach entrances as required by the Land Development Division, and the relocated lights must comply with all adopted lighting standards.

Condition(s) by City Planning and Development Department. Contact Terry Thomas at / Terry.A.Thomas@kcmo.org with questions.

- 17. The developer shall submit a storm drainage analysis from a Missouri-licensed civil engineer to the Land Development Division, in accordance with adopted standards, including a BMP level of service analysis prior to approval and issuance of any building permits, and that the developer secure permits to construct any improvements as required by the Land Development Division prior to issuance of any certificate of occupancy.
- 18. The developer must grant on City approved forms, a STREAM BUFFER Easement to the City or show and label the final stream buffer zones on the subdivision plat within a private open space tract, as required by Chapter 88 and Land Development Division, prior to issuance of any stream buffer permits.
- 19. The developer shall submit construction plans in compliance with adopted standards for all improvements required by the traffic study approved by the Public Works Department, and shall secure permits for those improvements as required by the Land Development Division, prior to recording the plat.
- 20. The owner/developer must submit plans for grading, siltation, and erosion control to Land Development Division for review and acceptance, and secure a Site Disturbance permit for any proposed disturbance area equal to one acre or more prior to beginning any construction activities.
- 21. The developer shall submit verification of vertical and horizontal sight distance for the drive connection to public right-of-way to the Land Development Division and make improvements to ensure local jurisdiction and/or minimum AASHTO adequate sight distance standards are met, prior to issuance of any certificate of occupancy.
- 22. The developer must submit a plan for approval and permitting by the Land Development Division prior to beginning construction of the improvements in the public right of way, and construct ADA compliant ramps at all required locations where new private drives are being added, or where existing sidewalks are modified or repaired.
- 23. The developer shall submit a letter to the Land Development Division from a Licensed Civil Engineer, Licensed Architect, or Licensed Landscape Architect, who is registered in the State of Missouri, that identifies sidewalks, curbs, and gutters in disrepair as defined by Public Works Department's "OUT OF REPAIR CRITERIA FOR SIDEWALK, DRIVEWAY AND CURB revised 11/5/2013" and based on compliance with Chapters 56 and 64 of the Code of Ordinances for the sidewalks, curbs, and gutters where said letter shall identify the quantity and location of sidewalks, curbs, gutters that need to be constructed, repaired, or reconstructed to remedy deficiencies and/or to remove existing approaches no longer needed by this project. The developer shall secure permits to repair or reconstruct the identified sidewalks, curbs, and gutters as necessary along all development street frontages as required by the Land Development Division and prior to issuance of any certificate of occupancy permits including temporary certificate occupancy permits.
- 24. The developer shall submit a final stream buffer plan to the Land Development Division for approval prior to issuance of any building permits and obtain permits for the Stream Buffer prior to removal of any mature riparian species within the buffer zones due to construction activities on the site, in accordance with the Section 88-415 requirements.
- 25. The developer shall submit an analysis to verify adequate capacity of the existing sewer system as required by the Land Development Division prior to issuance of a building permit to connect private system to the public sewer main and depending on adequacy of the receiving system, make other improvements may be required.
- 26. The developer shall cause the area to be platted and processed in accordance with Chapter 88, Code of Ordinances of the City of Kansas City, Missouri, as amended, commonly known as the Development Regulations.
- 27. The developer must pay impact fees as required by Chapter 39 of the City's Code of ordinances as required by the Land Development Division.

Condition(s) by Fire Department. Contact Michael Schroeder at (816) 513-4604 / michael.schroeder@kcmo.org with questions.

- 28. New buildings shall have approved radio coverage for emergency responders within the building based on the existing coverage levels of the public safety communication systems utilized by the jurisdiction, measured at the exterior of the building. This section shall not require improvement of the existing public safety communication systems. (IFC 2018 510.1) and (NFPA1221)
- 29. The project shall meet the fire flow requirements as set forth in Appendix B of the International Fire Code 2018. (IFC-2018 § 507.1)
- 30. Buildings equipped with a fire standpipe system shall have an operable fire hydrant within 100 feet of the Fire Department Connection (FDC). (IFC2018 § 507.5.1.1)

Condition(s) by Fire Department. Contact Michael Schroeder at (816) 513-4604 / michael.schroeder@kcmo.org with questions.

- 31. Fire hydrant distribution shall follow IFC-2018 Table C102.1

  Fire hydrants shall be installed and operable prior to the arrival of any combustible building materials onto the site. (IFC-2018 § 501.4 and 3312.1; NFPA -2013 § 8.7.2)
- 32. All required fire department access roads shall be an all weather surface. (IFC-2012: § 503.2.3) and Fire Department access roads shall be provided prior to construction/demolition projects begin. (IFC-2018 § 501.4 and 3310.1; NFPA 241-2013 § 7.5.5) All required fire department access roads shall designed to support a fire apparatus with gross axle weight of 85,000 pounds. (IFC-2018: § 503.2.3)
- 33. Multi-family residential developments greater than 200 dwelling units shall have at least two separate and approved fire apparatus access roads (IFC-2018 § D106.2) There needs to be an access on the west end from 93rd. Where two fire apparatus access roads are required, they shall be placed a distance apart equal to not less than one half of the length of the maximum overall diagonal dimension of the lot or area to be served, measured in a straight line between accesses. (IFC-2018: § D104.3)
- 34. Aerial Fire Apparatus access roads shall be provided for any building that is 30 feet in height or greater. Aerial Fire Apparatus Roads are a minimum 26 feet wide, at least 15 feet away from the building but not more than 30 feet from the structure. (IFC-2018 § D105).
- 35. The turning radius for fire department access roads shall be 30 feet inside and 50 feet outside radius. (IFC-2018: § 503.2.4)

Condition(s) by Parks & Recreation. Contact Justin Peterson at (816) 513-7599 / Justin.Peterson@kcmo.org with questions.

- 36. The developer is responsible for dedication of parkland, private open space in lieu of parkland, or payment of cash-in-lieu of either form of dedication, or any combination thereof in accordance with 88-408. Should the developer choose to pay cash-in-lieu of dedicating all or a portion of the required area, the amount due shall be based upon the (2022) acquisition rate of (\$64,220.18) per acre. Should the developer elect to dedicate private open space, said space shall be platted into private open space tract(s). This requirement shall be satisfied prior to recording the final plat or certificate of occupancy (whichever comes first).
- 37. The developer shall submit a streetscape plan with street tree planting plan per 88-425-03 identifying trees to remain for approval by the Parks & Recreation Department's Forestry Division prior to building permit.

Condition(s) by Water Services Department. Contact Courtney Hawkins at /courtney.hawkins@kcmo.org with questions.

38. The developer must [grant on City approved forms, a STREAM BUFFER Easement to the City] or [show and label the final stream buffer zones on the subdivision plat within a private open space tract], as required by Chapter 88 and Land Development Division, prior to issuance of any stream buffer permits.

Condition(s) by Water Services Department. Contact Heather Massey at (816) 513-2111 / heather.massey@kcmo.org with questions.

- 39. A full flow fire meter will be required when the fire protection service line serves more than one building, or combination service lines 6 inches and larger, or that have private fire hydrants connected to them.
- 40. No water service line will be less than 1-1/2" in diameter where three or more units or Commercial building will be served by one domestic service line and meter.
- 41. Branch service lines one-and-one-half inches and larger in diameter for domestic water services or fire protection lines shall be connected to the main by cutting in a minimum 6" branch service tee, installing three gate valves, and two solid sleeves on the main. Line valves on the main shall be the same nominal size as the main.
- 42. The developer shall ensure that water and fire service lines should meet current Water Services Department Rules and Regulations. Prior to C of O. https://www.kcwater.us/wp-content/uploads/2022/05/2022-Rules-and-Regulations-for-Water-Service-Lines-Final.pdf
- 43. The developer shall have a water flow test done to ensure there is adequate water pressure to serve the development. South of River contact Sean Allen 816-513-0318

  North of River contact Todd Hawes 816-513-0296

Condition(s) by Water Services Department. Contact Jerald Windsor at (816) 513-0413 / Jerald.Windsor@kcmo.org with questions.

44. The developer must submit Water Main Extension plans prepared by a registered professional Engineer in Missouri to the main extension desk for review, acceptance and contracts of all proposed public main extensions per the KC Water Rules and Regulations for Water main extensions and Relocations.

# THE DEPOT ON OLD SANTA FE



# **DEVELOPER**

KITTLE PROPERTY GROUP 310 E 96th St, Suite 400 Indianapolis, IN 46240

Contact: Brenda Haddad Email: BHaddad@kittleproperties.com

# **ARCHITECT**

KITTLE PROPERTY GROUP 310 E 96th St, Suite 400 Indianapolis, IN 46240

Contact: Elizabeth Eby, AIA Email: EEby@kittleproperties.com

# **CONTRACTOR**

KITTLE PROPERTY GROUP 310 E 96th St, Suite 400 Indianapolis, IN 46240

Contact: Jay Kellogg Email: JKellogg@kittleproperties.com

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G-000	COVER SHEET
C-100	PRELIMINARY PLAT
C-200	SITE PLAN
C-300	UTILITY PLAN
C-400	PRELIM STREAM BUFFER PLAN
C-500	LIGHTING PLAN
L100	OVERALL LANDSCAPE PLAN
L101	LANDSCAPE PLAN
L102	LANDSCAPE PLAN
L103	LANDSCAPE PLAN
L200	TREE REMOVAL PLAN

# MAIL KIOSK ASP-2

ASP-3	DUMPSTER ENCLOSURE
ASP-5	ENTERTAINMENT PAVILION
ASP-6	MONUMENT SIGN
ASP-7	SITE LIGHTING
ASP-8	SITE LIGHTING
A-200	1BR12+2BR12+3BR12 ELEVATIO
A-201	1BR12+2BR16+3BR6 ELEVATION
AC-200	CLUBHOUSE ELEVATIONS
AG-100	TYPE A GARAGE ELEVATIONS
AG-101	TYPE B GARAGE ELEVATIONS

MAINTENANCE BUILDING ELEVATIONS

BUILDING DATA	Required	Proposed	Deviation Requested?	Approved
Rear Setback		48 FEET		
Front Setback		30 FEET		
Side Setback				
Side Setback (abutting street)		25 FEET		
Height		MAX. 50' TOP OF RIDGE		

88-420 – PARKING	Vehicle Spaces		Bike Spaces		Alternatives Proposed? (See
	Required	Proposed	Required	Proposed	88-420-16)
Proposed Use(s) Residential, Multifamily, Affordable Parking Ratio of .5/DU	126	413 SURFACE 42 GARAGES	21 TEMP + 42 LONG TERM = 63	4 SURFACE PADS = 21 2 BIKE STORAGE ROOMS = 42	
Total 252 DU/.5 = 126 Parking Spaces		TOTAL 455 SPACES		TOTAL = 63	

88-425 – OTHER DEVLEOPMENT STANDARDS	Method of Compliance	
88-408 Parkland Dedication	PAYMENT IN LIEU	
88-415 Stream Buffers	DISTURBANCE OUTSIDE OF THE 50' PROTECTED ZONE IS 6.7%	
88-430 Outdoor Lighting	SEE LIGHTING CUT SHEETS, ASP-7 AND ASP-8	
88-435 Outdoor Display, Storage and Work Areas	SEE GARAGE AND MAINTENANCE BUILDINGS, AG-100, AG-101 AND AM-100	
88-445 Signs	SEE MONUMENT SIGN, ASP-6	
88-450 Pedestrian Standards	KCMO AND ADA STANDARDS ARE USED	

SITE DATA	Existing	Proposed	Deviation Requested?	Approved
Zoning	UR	UR	AMENDMENT	
Gross Land Area				
in square feet	88,347			
in acres	20.4			
Right-of-way Dedication	0 30 40 3 20 40 40 40 40 40 40 40 40 40 40 40 40 40			
in square feet	0			
in acres	0			
Net Land Area				
in square feet	88,347			
in acres	20.4			
Building Area (sq. ft.)		354,841 GSF		
Floor Area Ratio		7.9 DU/Acre		
Residential Use Info				
Total Dwelling Units		252		
Detached House				
Zero lot line House				
Cottage House				
Semi-attached House				
Townhouse	****		***************************************	
Two-unit House				
Multi-unit House				
Colonnade				
Multiplex				
Multi-unit Building	N 10 10 10 10 10 10 10 10 10 10 10 10 10	7 BLDGS		
Total Lots				
Residential				
Public/Civic				
Commercial				
Industrial			1	
Other			1	

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PROJECT TITLE

**UR COVER SHEET** 

# **VICINITY MAP**



# **SITE AERIAL**



# **RENDERINGS: FRONT VIEW APARTMENT BUILDINGS**



ISSUED	FOR:		DATE
REVIS	SIONS		
MARK	DATE	REVISIO	N

22-004



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SEAL

PROJECT TITLE

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SHEET TITLE

ISSUED FOR:

APP SET

**PRELIMINARY** PLAT

DATE


08/26/22


2E\/I9	SIONS	
	DESCRIPTION	DATE

DO NOT SCALE PRINTS - USE FIGURED DIMENSIONS ONLY

22-003

C-100

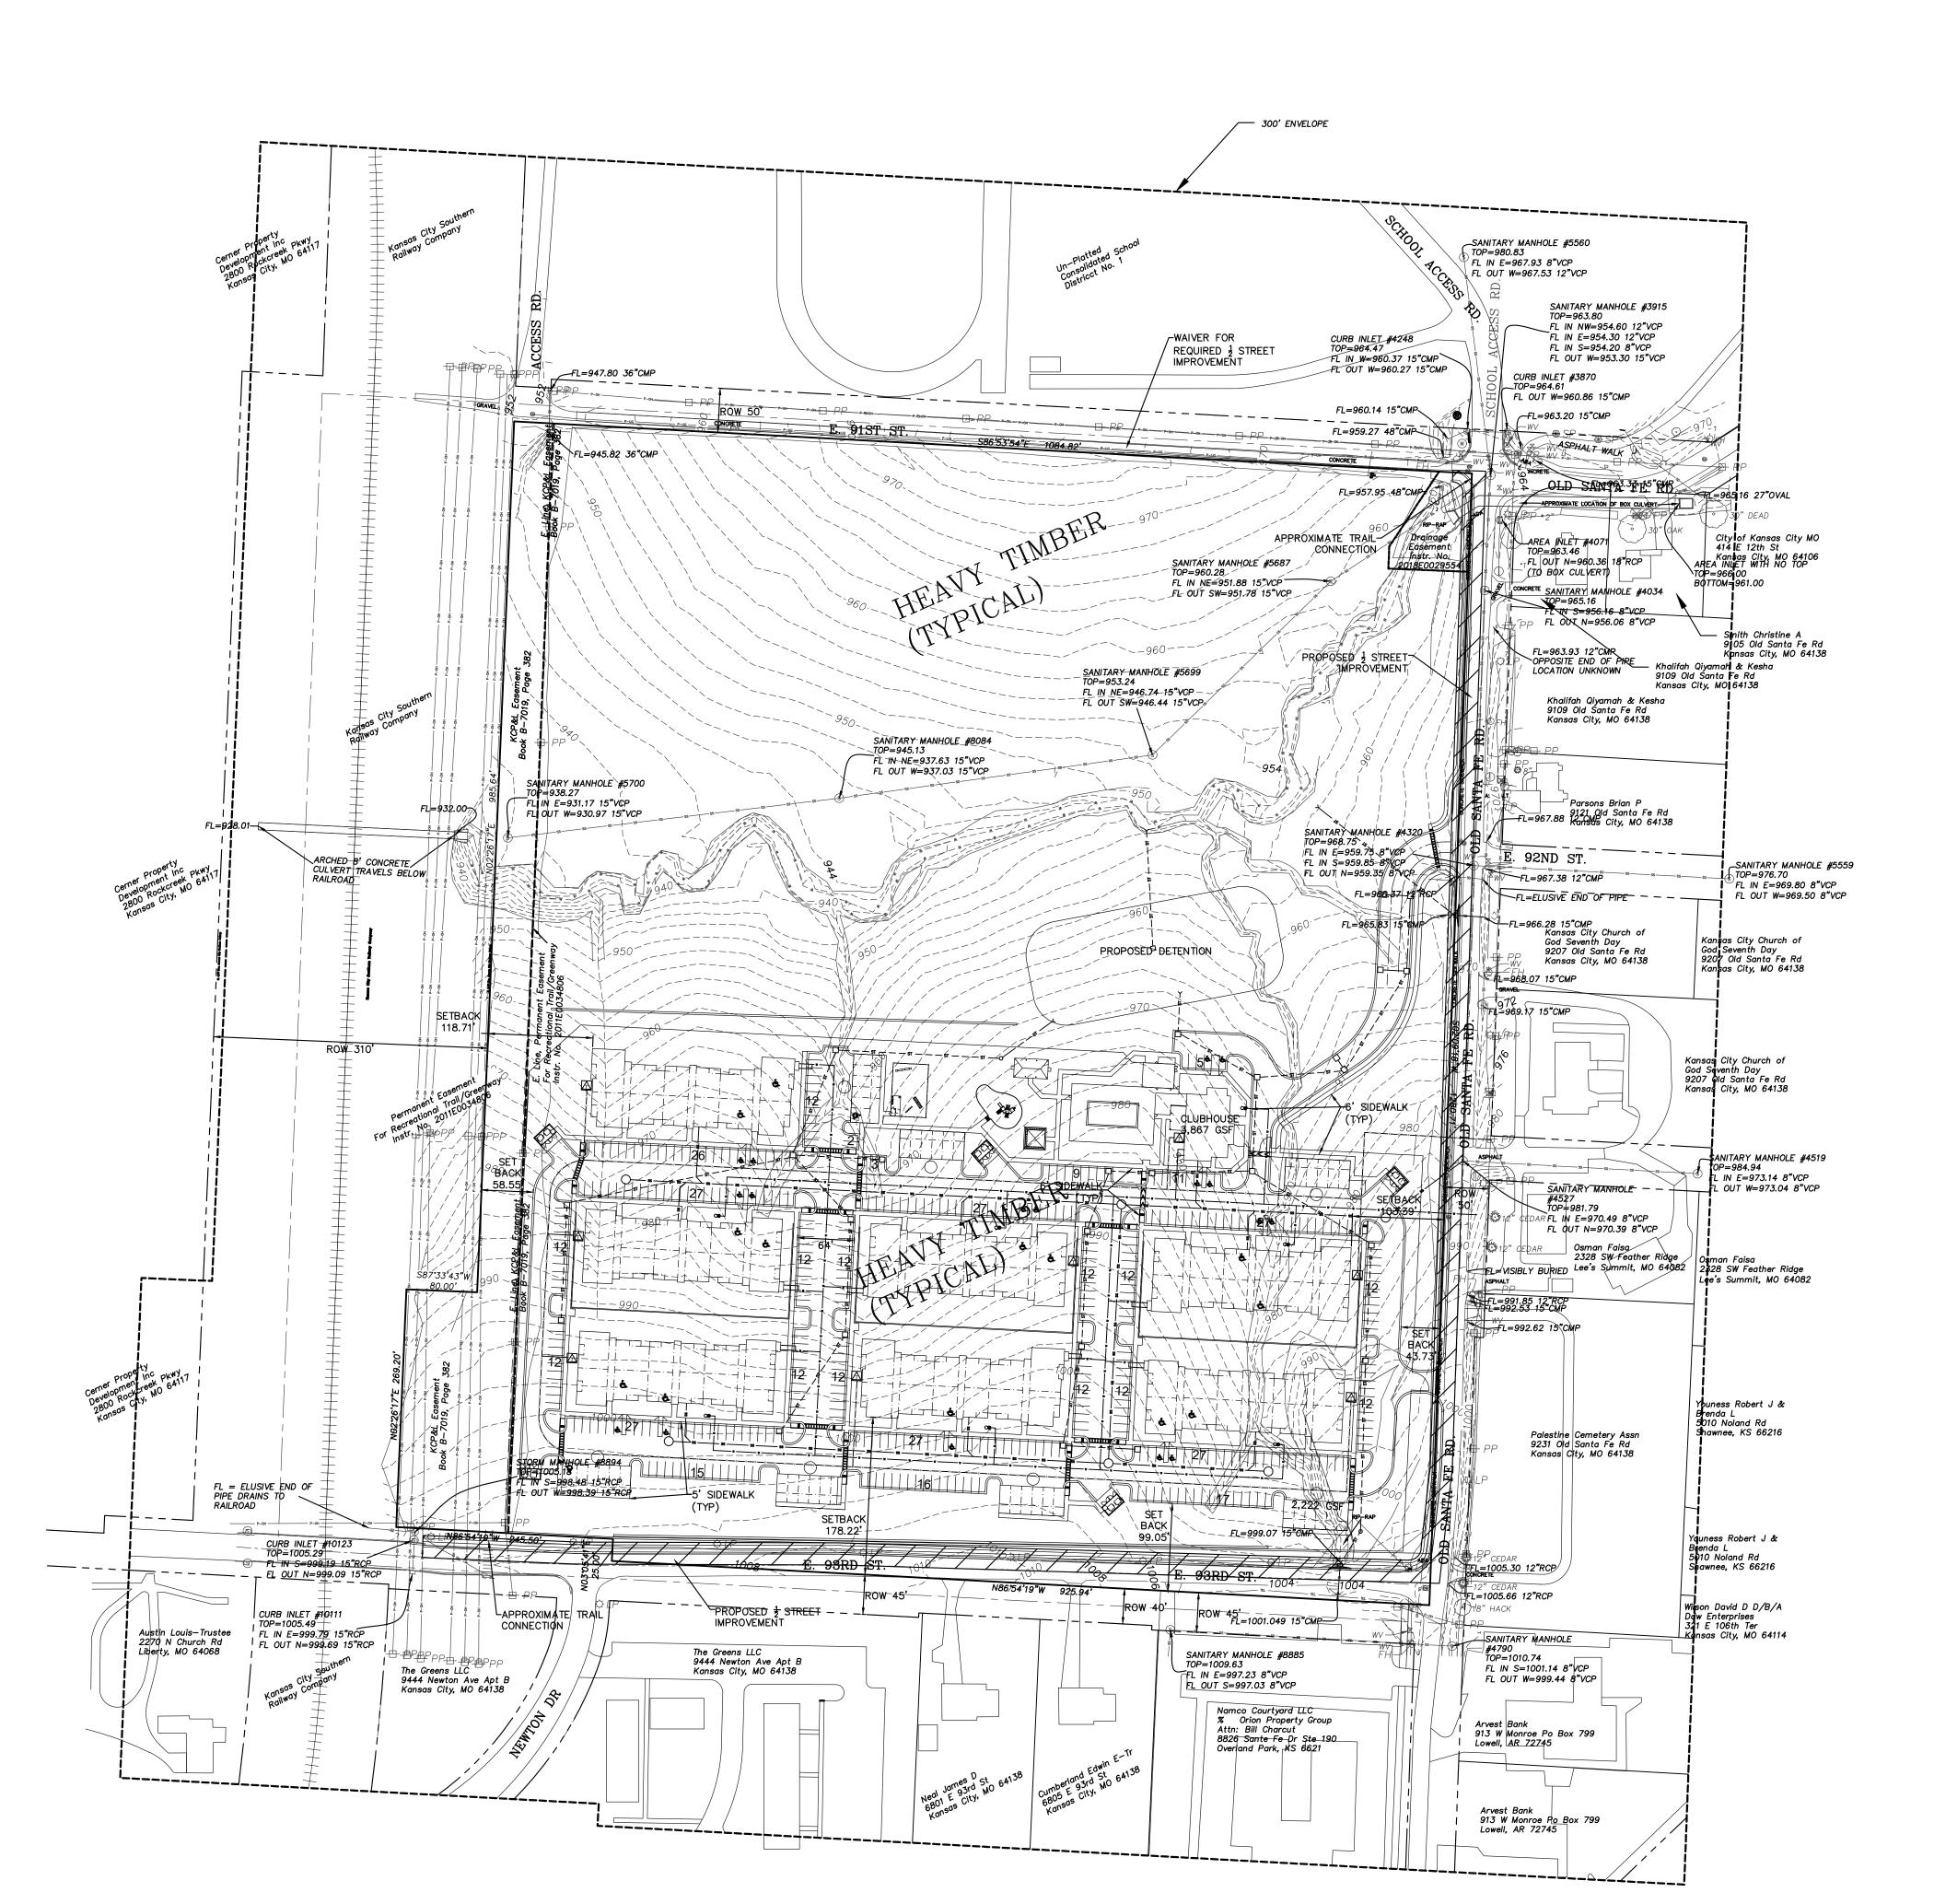

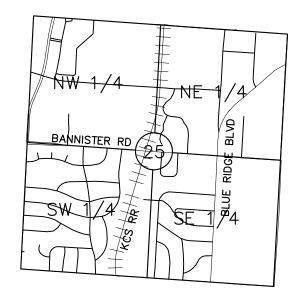

**VICINITY MAP** SECTION 25 48N 33W (1"=2000')

DEVELOPER: KITTLE PROPERTY GROUP 310 EAST 96TH STREET. STE 400 INDIANAPOLIS, IN 46250

CONTACT: ELIZABETH EBY PHONE: 317-486-3111

# PREPARED AND SUBMITTED BY:


SE3, LLC 8401 E M 350 HIGHWAY KANSAS CITY, MO 64133

JAMES CHERNEY, PE MISSOURI PE: 2001004573

LEGAL DESCRIPTION:

PROPERTY DESCRIPTION: As Provided By First American Title Insurance Company: All of the Northwest Quarter of the Northeast Quarter of Section 25, Township 48, Range 33, in Kansas City, Jackson County, Missouri, lying East of the East right of way line of the Kansas City Southern Railroad, EXCEPT that part taken for public right of way, and EXCEPT all that part of Lot 1, "SUBDIVISION OF SECHREST ESTATE", a subdivision in Kansas City, Jackson County, Missouri, described as follows: BEGINNING at the intersection of the South line of the Northwest Quarter of the Northeast Quarter of Section 25, Township 48, Range 33 (also being the South line of said Lot 1) with the Northerly prolongation of the East line of Newton Drive, as dedicated by the subdivision plat of "CAMELOT COURTS"; thence Westerly along the South line of said Quarter Quarter Section 245.35 feet, more or less, to the East line of the Kansas City Southern Railway; thence Northerly along the East line of said railway to its intersection with a line drawn 45.0 feet North of and parallel to the South line of the aforesaid Quarter Quarter Section; thence Easterly along said parallel line to its intersection with the Northerly prolongation of the East line of the aforesaid Newton Drive; thence Southerly along said prolongation to the POINT OF BEGINNING. This tract also being a part of Lot 1, a SUBDIVISION OF SECHREST ESTATE.

> PRELIMINARY PLAT SCALE: 1" = 100'-0"

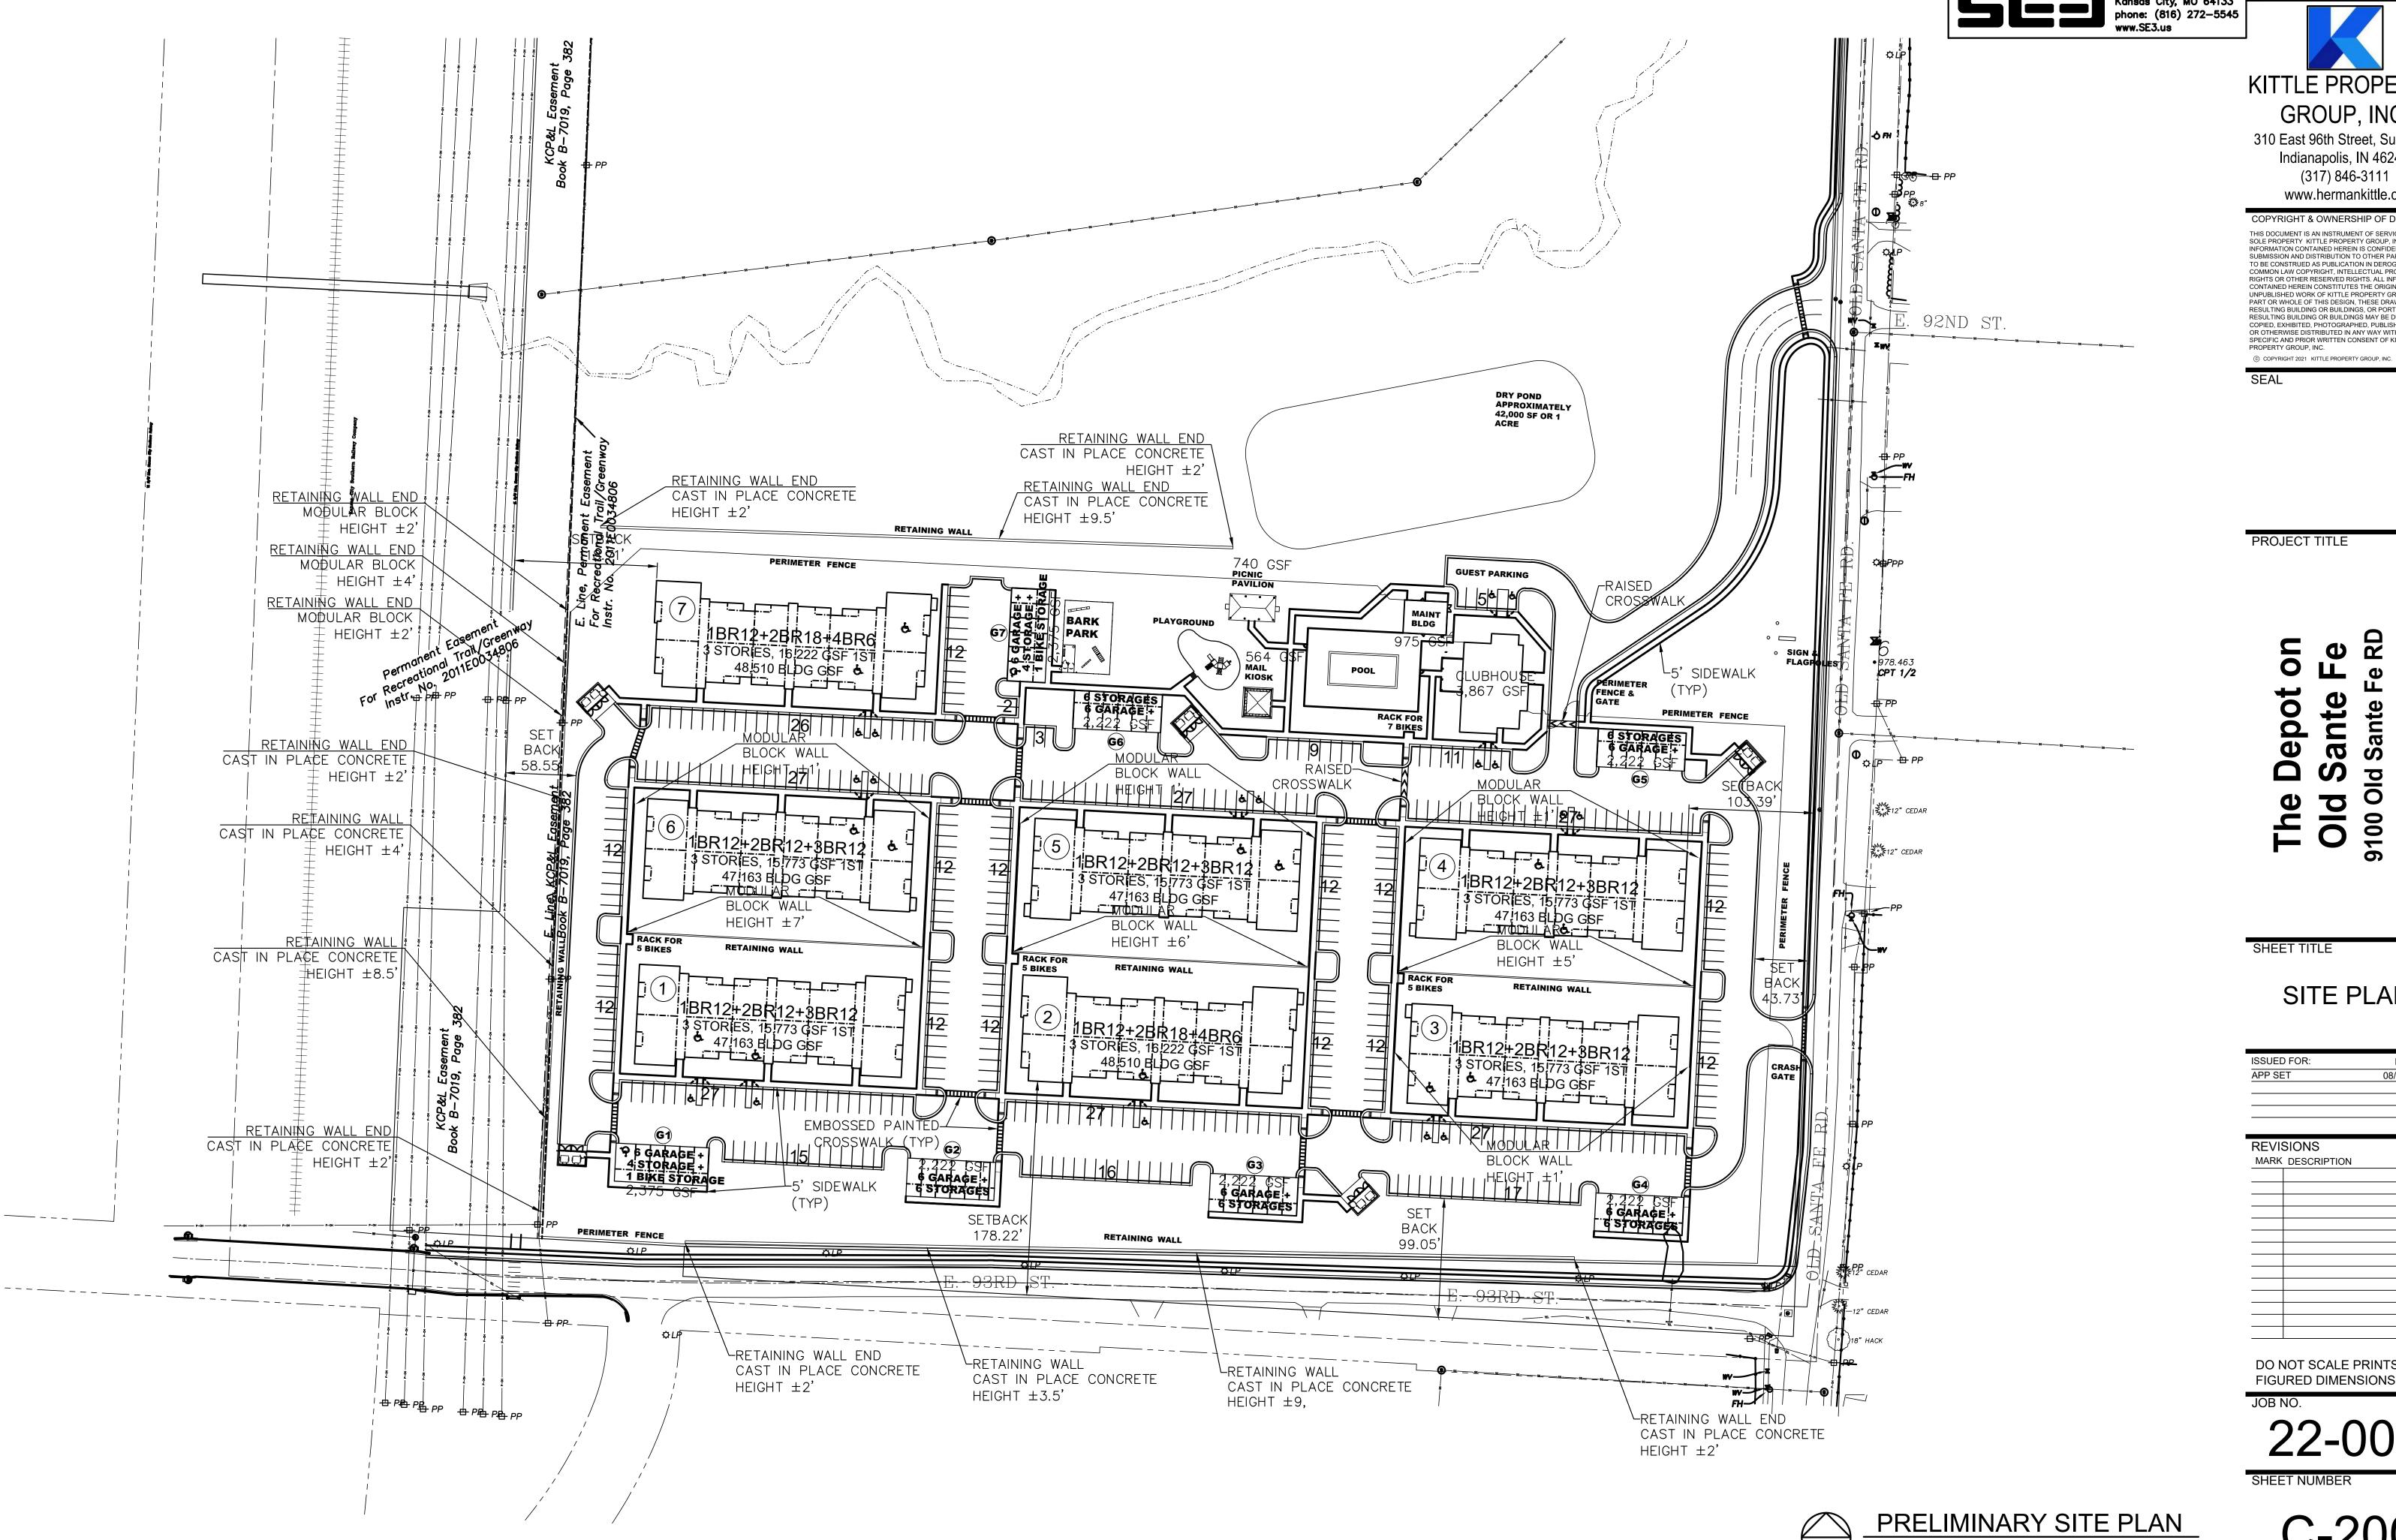

KITTLE PROPERTY GROUP, INC.

310 East 96th Street, Suite 400 Indianapolis, IN 46240 (317) 846-3111 www.hermankittle.com

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SEAL

PROJECT TITLE

**Th Olc** 9100 Kansa


SHEET TITLE

SITE PLAN


ISSUED FUR.	DATE
APP SET	08/26/22
REVISIONS	
	DATE
MARK DESCRIPTION	DATE

DO NOT SCALE PRINTS - USE FIGURED DIMENSIONS ONLY

22-003

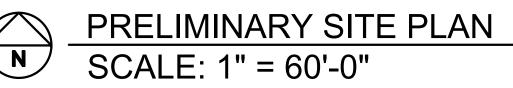

C-200

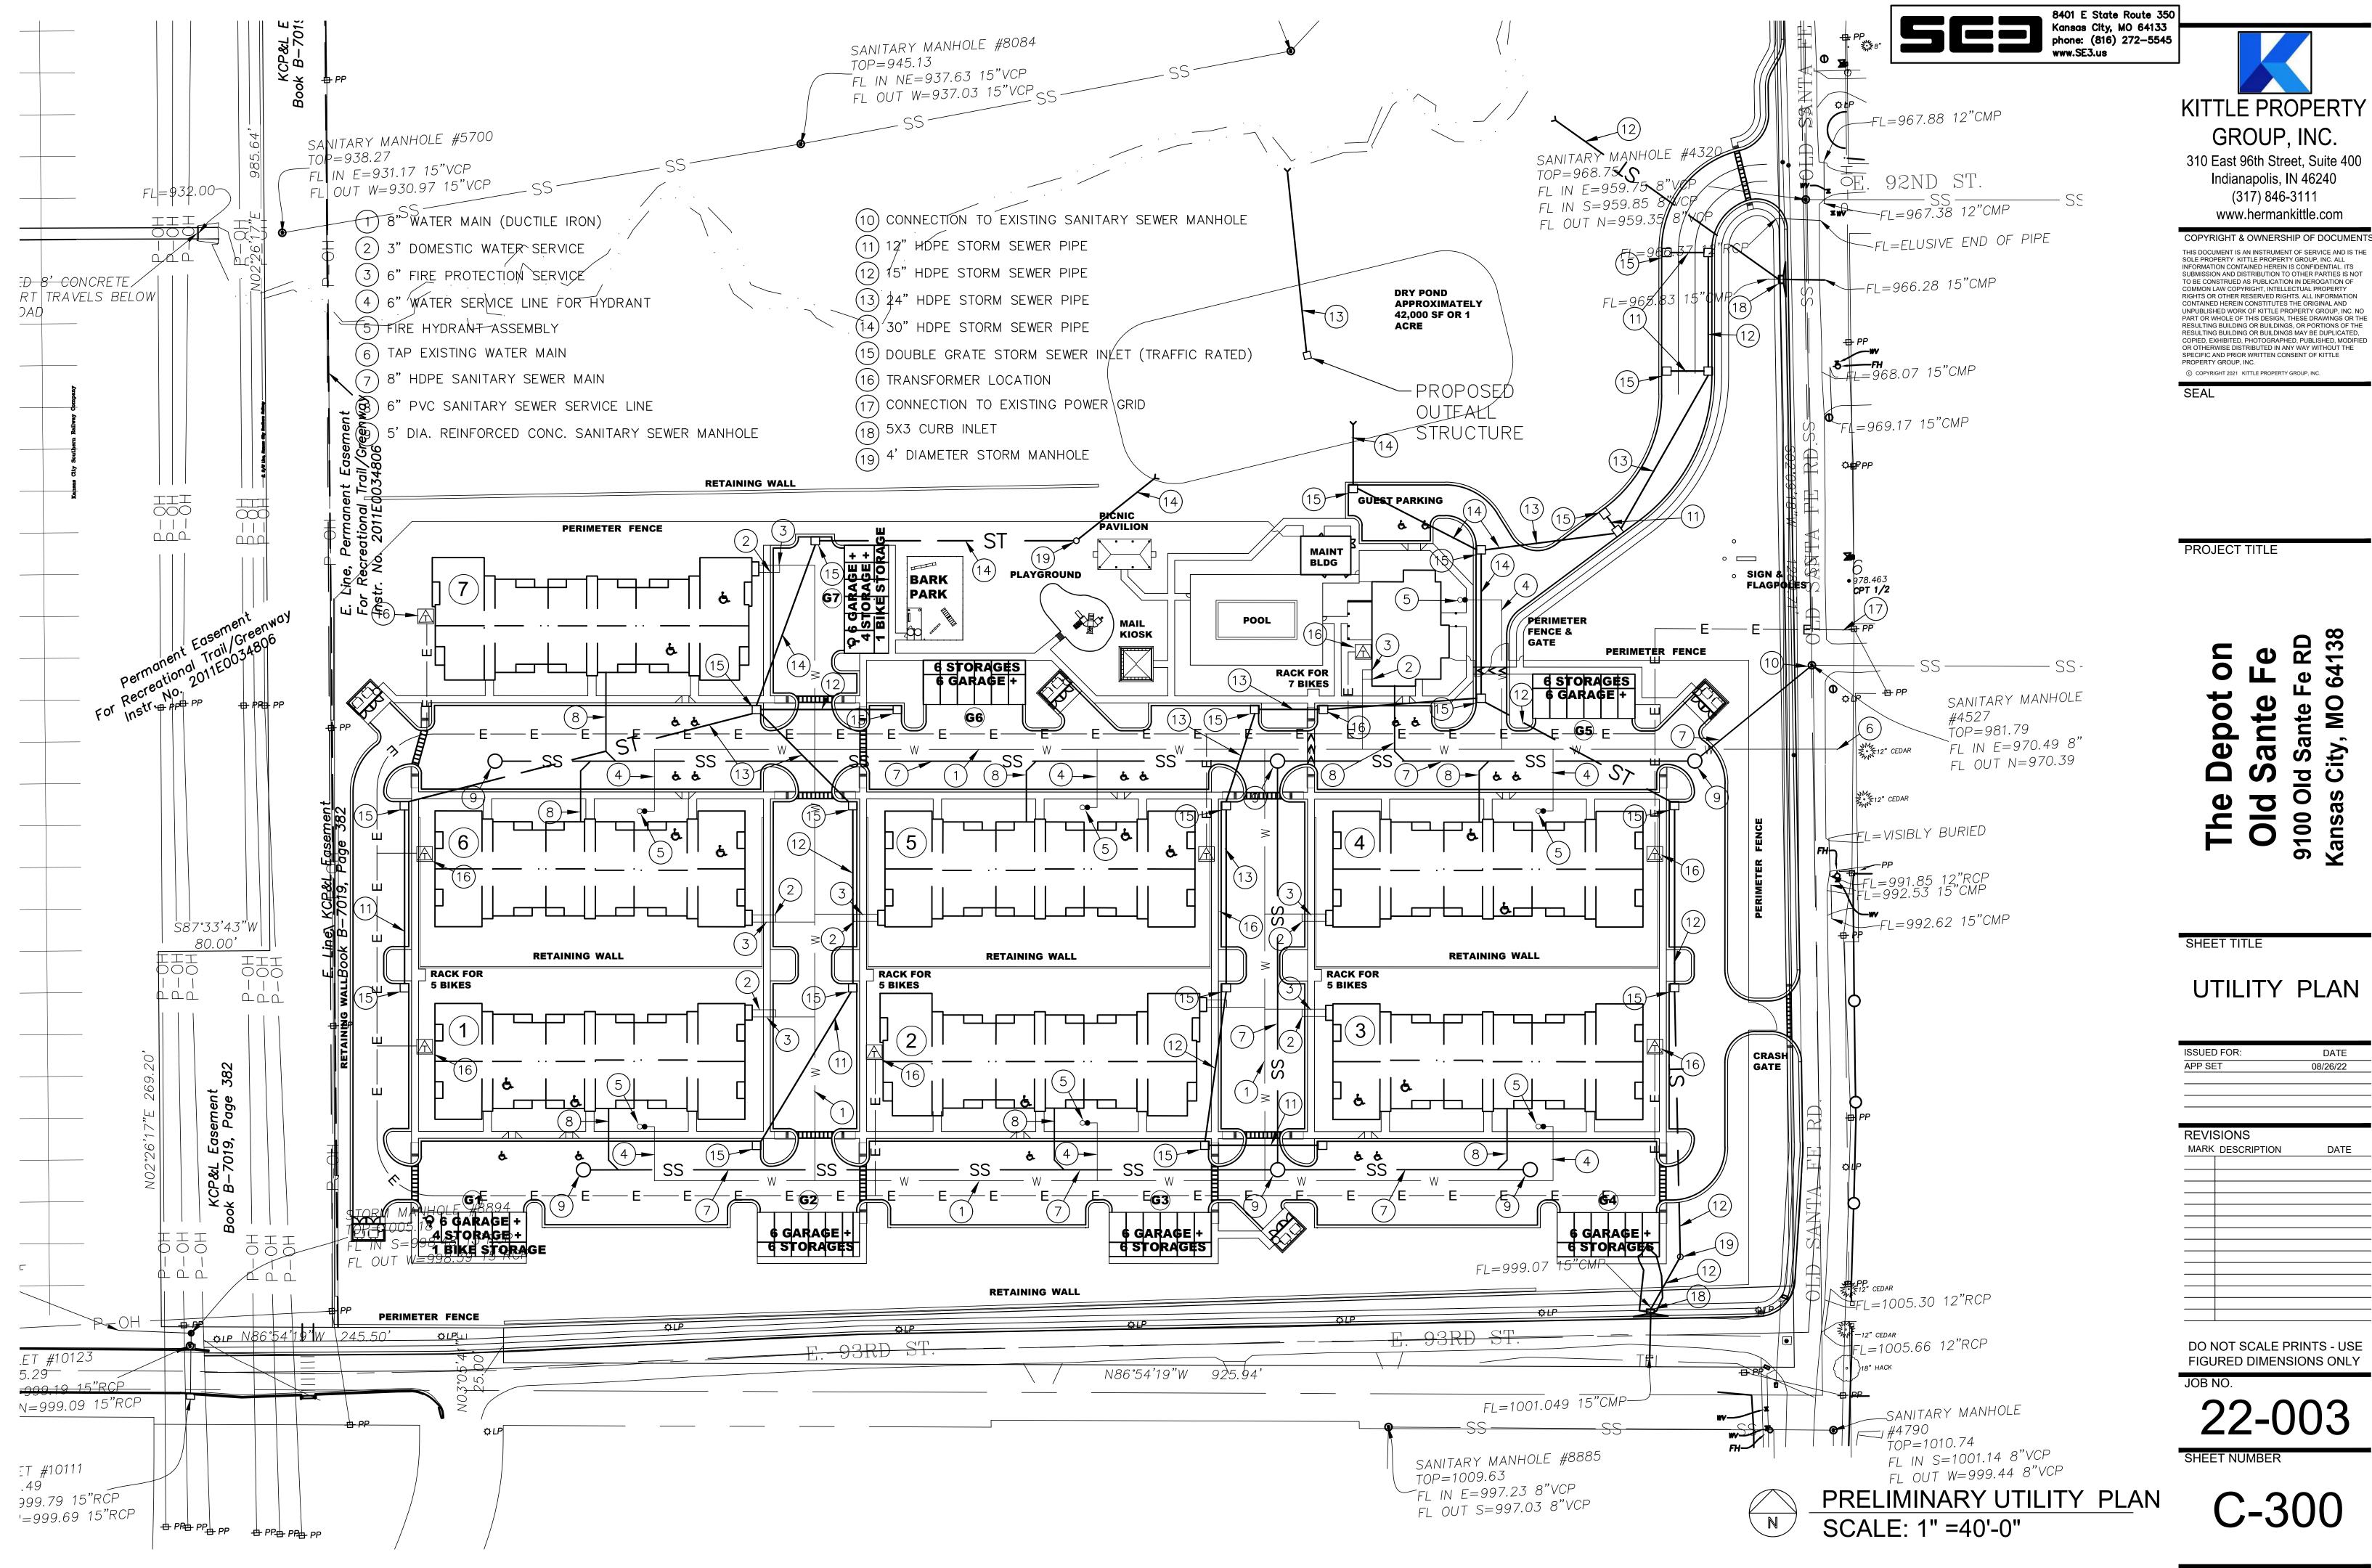

08/26/22





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PROJECT TITLE

The Depot on Old Sante Fe 9100 Old Sante Fe RD Kansas City, MO 64138

PRELIMINARY
STREAM BUFFER
PLAN

DATE 08/26/22

REVIS	NONC	
KEVIS	DIONS	
MARK	DESCRIPTION	DATE

DO NOT SCALE PRINTS - USE FIGURED DIMENSIONS ONLY


JOB NO.

22-003

SHEET NUMBI

C-100



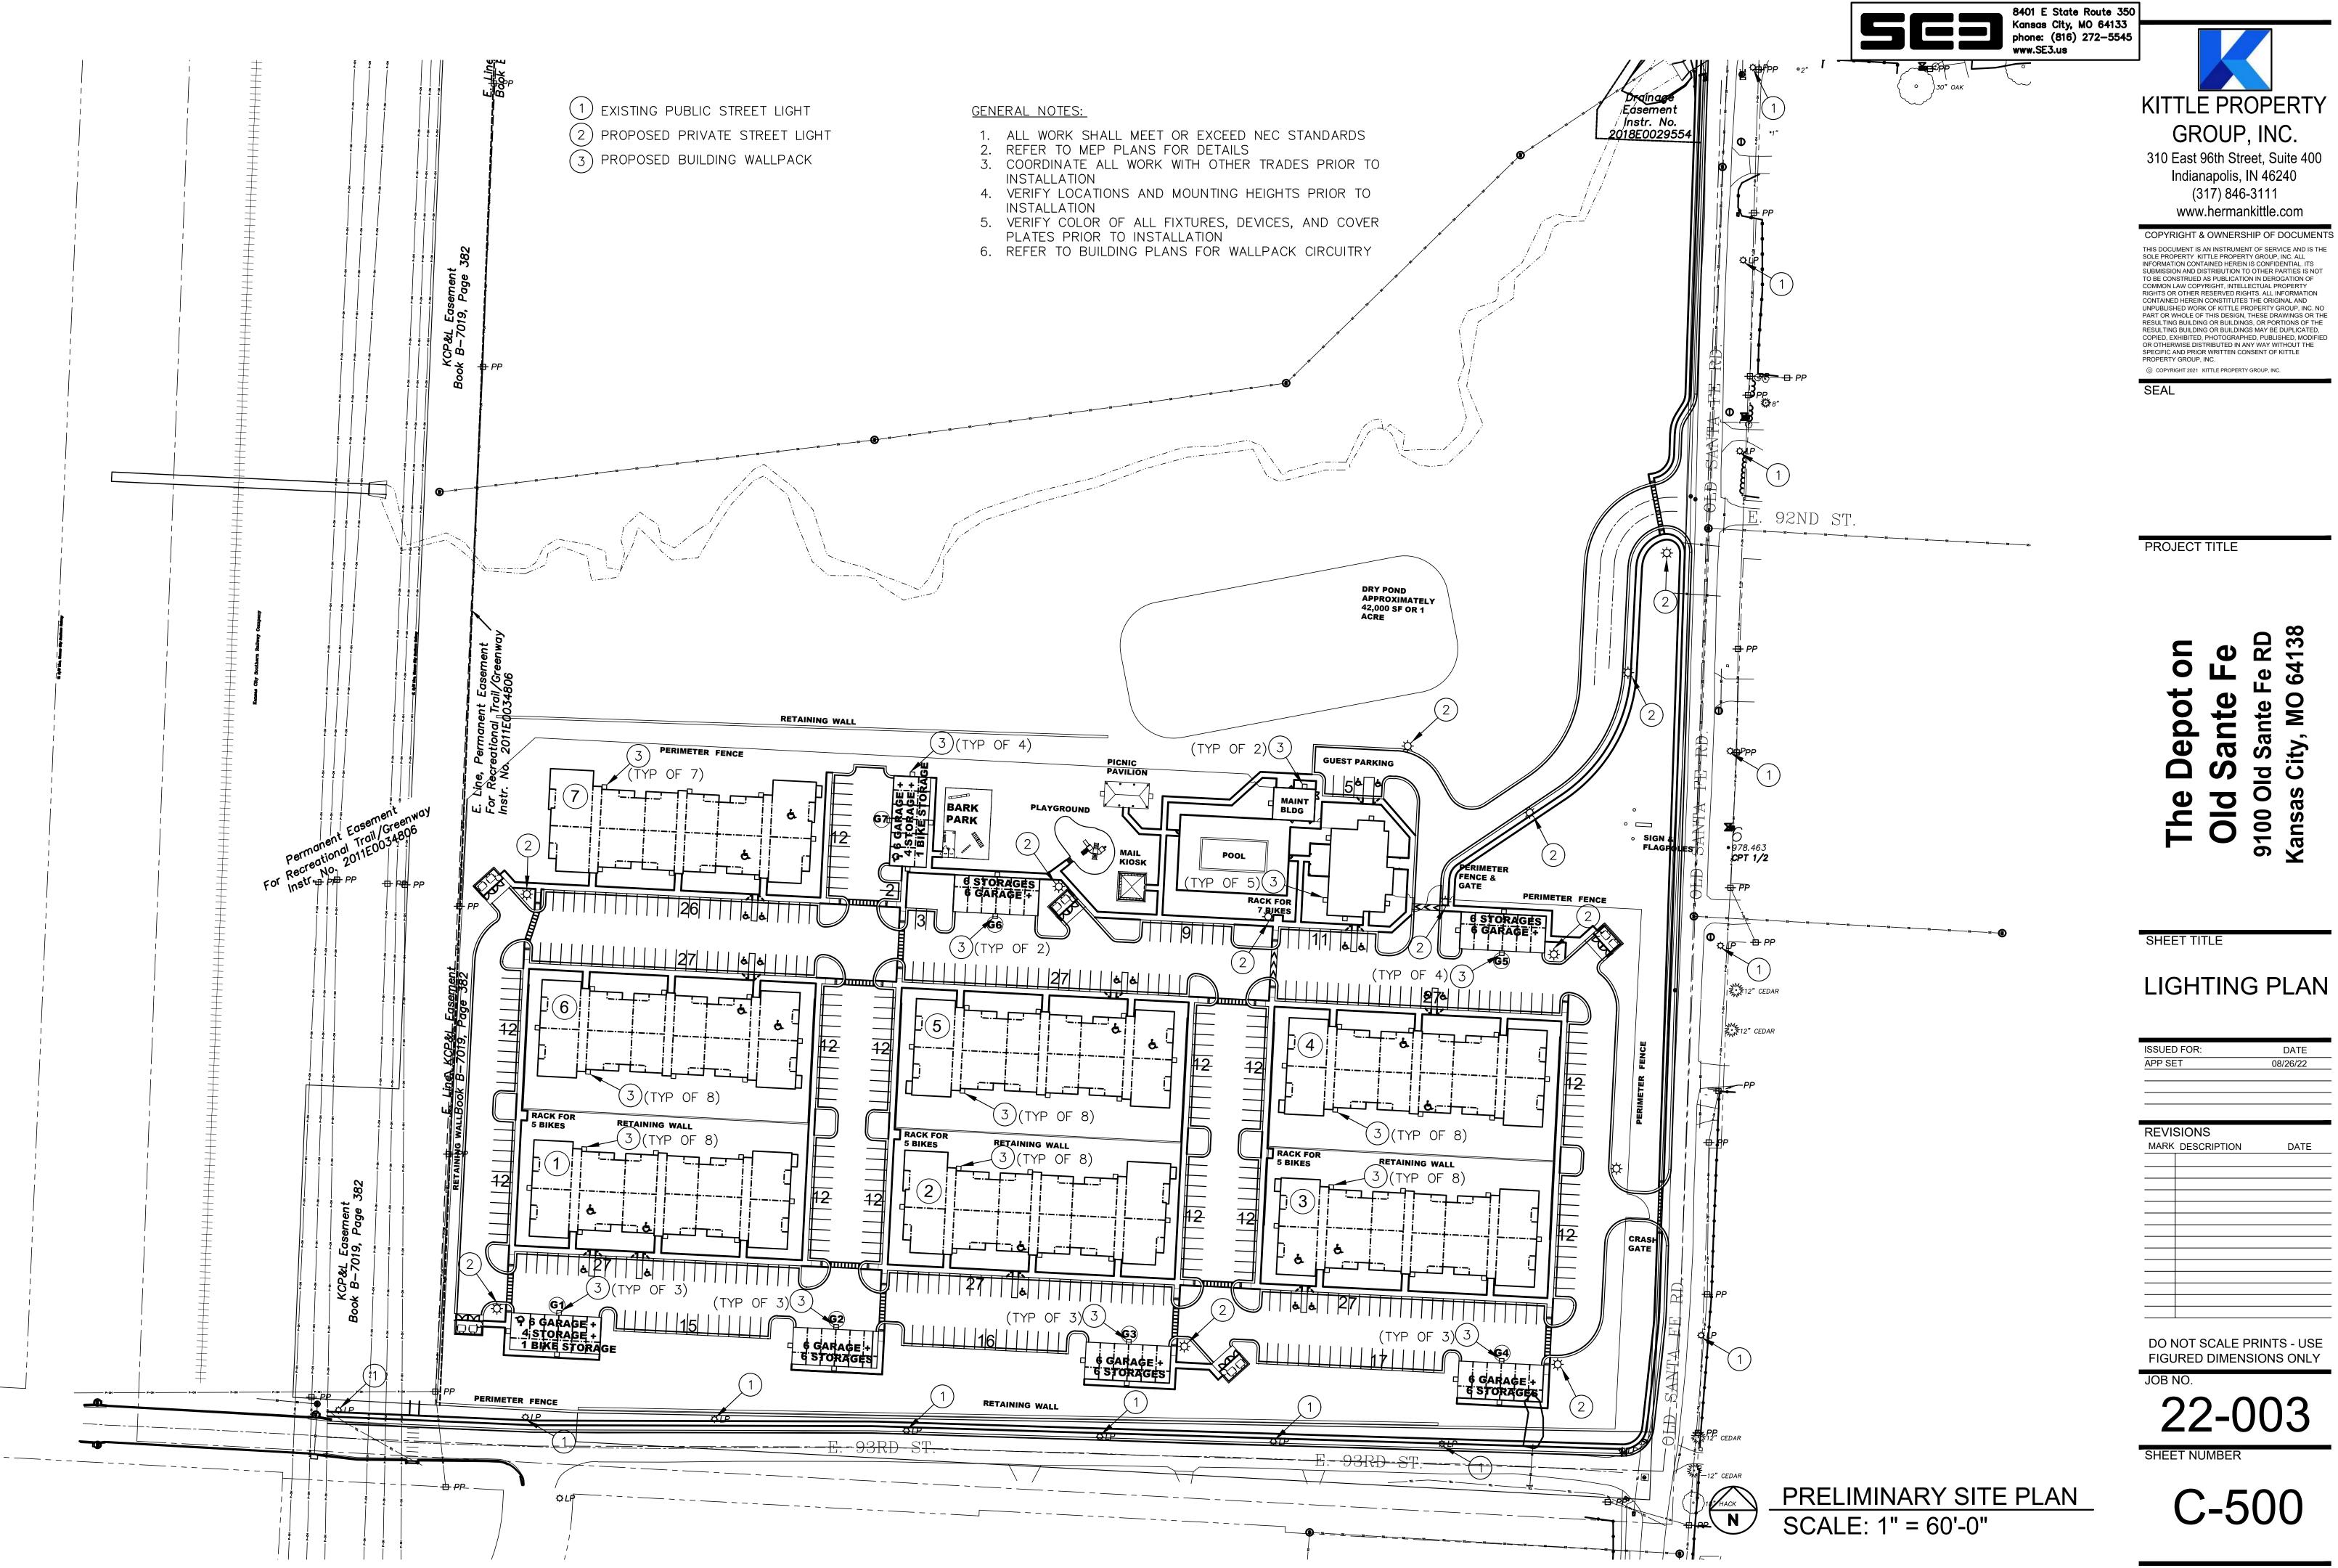



#### McGraw-Edison DESCRIPTION Туре The Galleon™ LED luminaire delivers exceptional performance in a highly scalable, low-profile design. Patented, high-efficiency AccuLED Optics™ system provides uniform and energy conscious illumination to walkways, parking lots, roadways, building areas and security lighting applications. IP66 rated and UL/cUL Listed for wet locations. PARKING LOT SPECIFICATION FEATURES Construction Round pole adapter included. Extruded aluminum driver LED drivers are mounted to For wall mounting, specify wall enclosure thermally isolated from removable tray assembly for ease mount bracket option. 3G vibration Light Squares for optimal thermal of maintenance. 120-277V 50/60Hz, rated. QUICK MOUNT ARM: Arm performance. Heavy-wall, die-347V 60Hz or 480V 60Hz operation. is bolted directly to the pole and cast aluminum end caps enclose 480V is compatible for use with the fixture slides onto the quick housing and die-cast aluminum mount arm and is secured via a 480V Wye systems only. Standard heat sinks. A unique, patent with 0-10V dimming. Shipped single fastener, facilitating quick pending interlocking housing and standard with Eaton proprietary and easy installation. The versatile, heat sink provides scalability with circuit module designed to patent pending, quick mount superior structural rigidity. 3G withstand 10kV of transient line arm accommodates multiple drill vibration tested. Optional toolsurge. The Galleon LED luminaire patterns ranging from 1-1/2" to less hardware available for ease is suitable for operation in -40°C 4-7/8". Removal of the door on the

to 40°C ambient environments.

For applications with ambient

temperatures exceeding 40°C,

specify the HA (High Ambient)

option. Light Squares are IP66

rated. Greater than 90% lumen

maintenance expected at 60,000

hours. Available in standard 1A

and 700mA drive currents.

STANDARD ARM MOUNT:

drive current and optional 530mA

of entry into electrical chamber.

Housing is IP66 rated.

Patented, high-efficiency

injection-molded AccuLED

Optics technology. Optics are

efficiency and application spacing.

AccuLED Optics create consistent

distributions with the scalability

to meet customized application

precisely designed to shape

the distribution maximizing

FATON

Date

**GLEON** 


Solid State LED

2016-01-29 10:56:52

**GALLEON LED** 

1-10 Light Squares

AREA/SITE LUMINAIRE

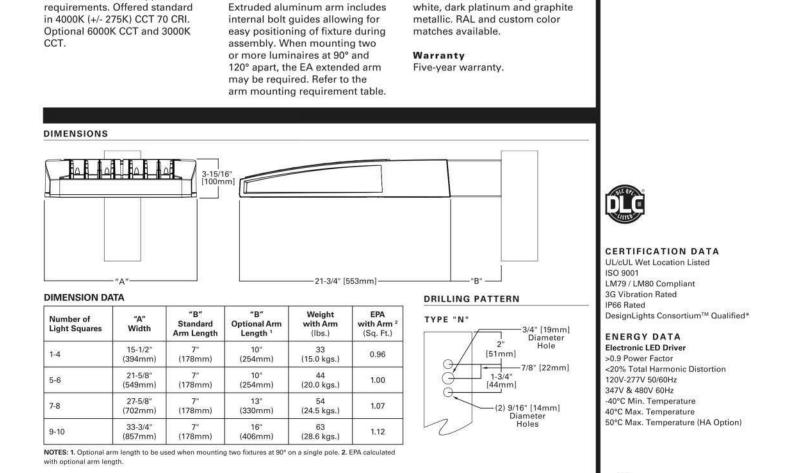

quick mount arm enables wiring of

the fixture without having to access

the driver compartment. A knock-

out enables round pole mounting.

Housing finished in super durable

TGIC polyester powder coat paint,

superior protection against fade

and wear. Heat sink is powder

coated black. Standard colors


\*www.designlights.org


include black, bronze, grey,


2.5 mil nominal thickness for


IOMINAI											
Number of	mber of Light Squares 1		2	3	4	5	6	7	8	9	10
Drive Curre	ent	1A									
Nominal P	ower (Watts)	56	107	157	213	264	315	370	421	475	528
Input Curre	ent @ 120V (A)	0.47	0.90	1.31	1.79	2.21	2.64	3.09	3.51	3.96	4.41
Input Curre	ent @ 208V (A)	0.28	0.51	0.74	1.02	1.25	1.48	1.76	1.99	2.22	2.50
Input Curre	ent @ 240V (A)	0.25	0.45	0.65	0.90	1.10	1.30	1.55	1.75	1.95	2.20
Input Curre	ent @ 277V (A)	0.23	0.41	0.59	0.82	1.00	1.18	1.41	1.59	1.77	2.00
Optics											
T0	Lumens	5,272	10,303	15,373	20,313	25,168	30,118	35,618	40,357	45,018	49,842
T2	BUG Rating	B1-U0-G1	B2-U0-G2	B2-U0-G2	B3-U0-G3	B3-U0-G4	B3-U0-G4	B3-U0-G4	B3-U0-G5	B4-U0-G5	B4-U0-G5
TOD	Lumens	5,597	10,938	16,321	21,565	26,719	31,974	37,813	42,844	47,792	52,914
T2R	BUG Rating	B1-U0-G1	B2-U0-G2	B2-U0-G2	B3-U0-G3	B3-U0-G3	B3-U0-G4	B3-U0-G4	B3-U0-G4	B4-U0-G4	B4-U0-G
1000	Lumens	5,374	10,501	15,669	20,704	25,652	30,697	36,303	41,134	45,884	50,802
Т3	BUG Rating	B1-U0-G2	B2-U0-G2	B2-U0-G3	B3-U0-G3	B3-U0-G4	B3-U0-G4	B3-U0-G5	B3-U0-G5	B4-U0-G5	B4-U0-G
T3R	Lumens	5,493	10,735	16,017	21,164	26,222	31,379	37,110	42,048	46,904	51,930
	BUG Rating	B1-U0-G2	B1-U0-G2	B2-U0-G3	B2-U0-G4	B3-U0-G4	B3-U0-G4	B3-U0-G5	B3-U0-G5	B3-U0-G5	B3-U0-G
T4FT	Lumens	5,405	10,562	15,760	20,824	25,801	30,875	36,514	41,372	46,150	51,096
	BUG Rating	B1-U0-G2	B2-U0-G2	B2-U0-G3	B3-U0-G4	B3-U0-G4	B3-U0-G5	B3-U0-G5	B3-U0-G5	B3-U0-G5	B3-U0-G
T4W	Lumens	5,335	10,426	15,556	20,555	25,468	30,476	36,042	40,838	45,554	50,436
	BUG Rating	B1-U0-G2	B2-U0-G2	B2-U0-G3	B3-U0-G4	B3-U0-G4	B3-U0-G5	B3-U0-G5	B4-U0-G5	B4-U0-G5	B4-U0-G
	Lumens	5,263	10,285	15,347	20,278	25,124	30,066	35,556	40,288	44,940	49,756
SL2	BUG Rating	B1-U0-G2	B2-U0-G2	B2-U0-G3	B3-U0-G3	B3-U0-G4	B3-U0-G4	B3-U0-G5	B3-U0-G5	B4-U0-G5	B4-U0-G
	Lumens	5,373	10,500	15,667	20,701	25,649	30,693	36,298	41,128	45,878	50,794
SL3	BUG Rating	B1-U0-G2	B2-U0-G3	B2-U0-G3	B3-U0-G4	B3-U0-G4	B3-U0-G4	B3-U0-G5	B3-U0-G5	B3-U0-G5	B3-U0-G8
	Lumens	5,105	9,976	14,886	19,669	24,370	29,163	34,488	39,078	43,591	48,262
SL4	BUG Rating	B1-U0-G2	B1-U0-G3	B1-U0-G3	B2-U0-G4	B2-U0-G4	B2-U0-G5	B3-U0-G5	B3-U0-G5	B3-U0-G5	B3-U0-G
	Lumens	5,542	10,830	16,160	21,352	26,455	31,658	37,439	42,421	47,320	52,392
5NQ	BUG Rating	B2-U0-G1	B3-U0-G1	B3-U0-G2	B4-U0-G2	B4-U0-G2	B5-U0-G2	B5-U0-G3	B5-U0-G3	B5-U0-G3	B5-U0-G4
A77500	Lumens	5,644	11,029	16,457	21,745	26,942	32,241	38,128	43,202	48,191	53,356
5MQ	BUG Rating	B3-U0-G1	B4-U0-G2	B4-U0-G2	B5-U0-G3	B5-U0-G3	B5-U0-G4	B5-U0-G4	B5-U0-G4	B5-U0-G4	B5-U0-G
	Lumens	5,659	11,059	16,501	21,803	27,014	32,327	38,230	43,317	48,320	53,498
5WQ	BUG Rating	B3-U0-G1	B4-U0-G2	B4-U0-G2	B5-U0-G3	B5-U0-G4	B5-U0-G4	B5-U0-G4	B5-U0-G5	B5-U0-G5	B5-U0-G
	Lumens	4,722	9,227	13,767	18,191	22,539	26,971	31,897	36,141	40,315	44,635
SLL/SLR	BUG Rating	B1-U0-G2	B1-U0-G3	B2-U0-G3	B2-U0-G3	B3-U0-G4	B3-U0-G4	B3-U0-G5	B3-U0-G5	B3-U0-G5	B3-U0-G
2011	Lumens	5,492	10,732	16,014	21,159	26,216	31,372	37,101	42,038	46,893	51,918
RW	BUG Rating	B2-U0-G1	B3-U0-G1	B4-U0-G2	B4-U0-G2	B4-U0-G2	B5-U0-G3	B5-U0-G3	B5-U0-G3	B5-U0-G4	B5-U0-G
0.720.00	Lumens	5,512	10,771	16,072	21,236	26,311	31,486	37,236	42,191	47,063	52,107
AFL	BUG Rating	B1-U0-G1	B1-U0-G1	B2-U0-G2	B2-U0-G2	B3-U0-G3	B3-U0-G3	B3-U0-G3	B3-U0-G3	B3-U0-G3	B3-U0-G4

		100		9
Ambient Temperature	Lumen Multiplier	Ambient Temperature	TM-21 Lumen Maintenance	Theoretical L70 (Hours)
0°C	1.02		(60,000 Hours)	1/2/2000/00/00
10°C	1.01	25°C	> 94%	> 350,000
25°C	1.00	40°C	> 93%	> 250,000
40°C	0.99	50°C*	> 90%	> 170,000
2.000	200200	* 50°C lumen main	ntenance data applies	to 530mA and
50°C	0.97	700mA drive curr		10 0001111 1 0110

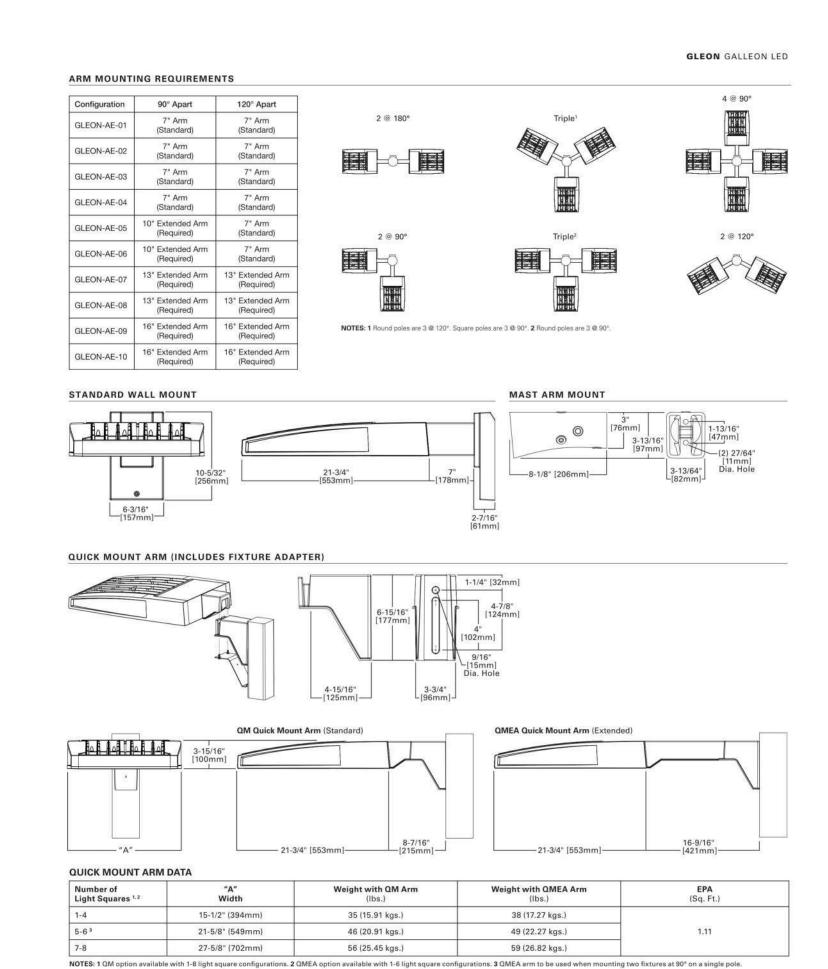

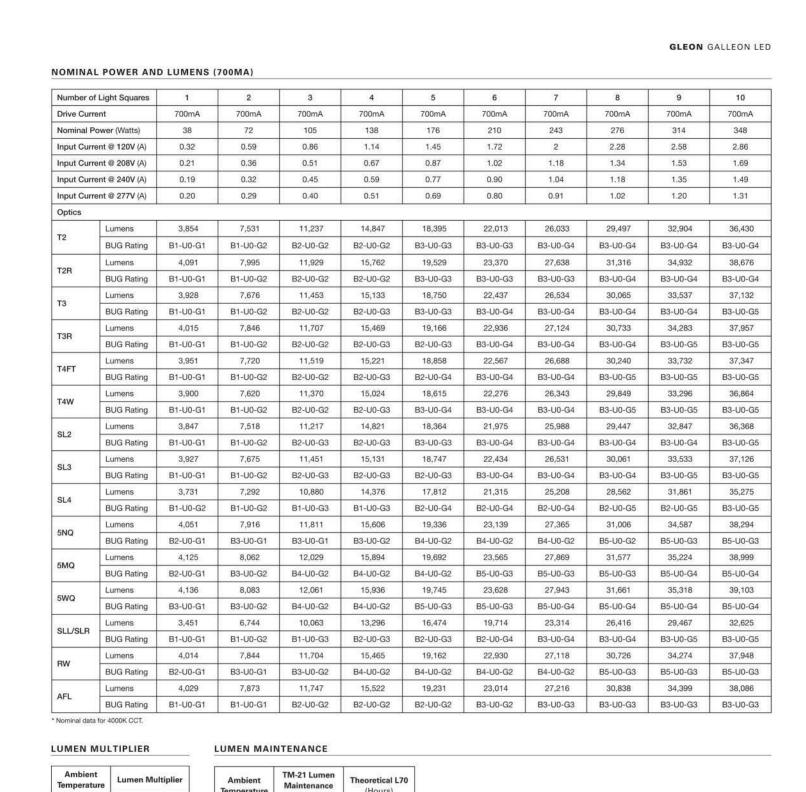

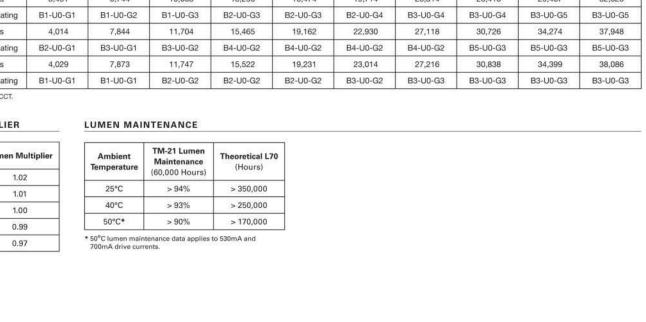

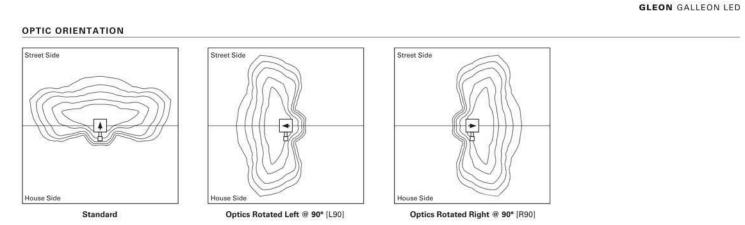

OPTICAL DISTRIBUTIONS - Asymmetric Area Distributions -(Type IV Wide) (Type IV with Spill Control) (Type II with Spill Control) (Type III with Spill Control) (Type IV Forward Throw) (90° Spill Light Eliminator Left) (90° Spill Light Eliminator Right

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2016-01-29 10:56:52

GLEON GALLEON LED NOMINAL POWER AND LUMENS (530MA) 1 2 3 4 5 6 7 8 9 10 530mA 530mA 530mA 530mA 530mA 530mA 530mA 530mA 
 Nominal Power (Watts)
 30
 54
 80
 105
 130
 159
 184
 209
 234

 Input Current @ 120V (A)
 0.25
 0.45
 0.66
 0.86
 1.07
 1.32
 1.52
 1.72
 1.93

 Input Current @ 208V (A)
 0.17
 0.28
 0.39
 0.51
 0.63
 0.78
 0.9
 1.02
 1.14
 Input Current @ 240V (A) 0.17 0.25 0.35 0.45 0.55 0.70 0.80 0.90 1.00 Input Current @ 277V (A) 0.19 0.24 0.32 0.40 0.49 0.64 0.72 0.80 0.89 3,079 6,017 8,978 11,862 14,697 17,588 20,800 23,567 26,289 29,106 BUG Rating B1-U0-G1 B1-U0-G2 B2-U0-G2 B2-U0-G2 B2-U0-G2 B3-U0-G3 B3-U0-G3 B3-U0-G3 B3-U0-G4 B3-U0-G4 3,269 6,388 9,531 12,593 15,603 18,672 22,082 25,020 27,909 30,900 B1-U0-G1 B1-U0-G2 B2-U0-G2 B2-U0-G2 B2-U0-G2 B3-U0-G3 B3-U0-G3 B3-U0-G3 B3-U0-G4 3,138 6,133 9,150 12,091 14,980 17,926 21,200 24,021 3,208 6,269 9,354 12,359 15,313 18,325 21,671 24,555 27,390 BUG Rating B1-U0-G1 B1-U0-G2 B1-U0-G2 B2-U0-G2 B2-U0-G3 B2-U0-G3 B2-U0-G4 B3-U0-G4 B3-U0-G4 B3-U0-G4 3,156 6,168 9,203 12,161 15,067 18,030 21,323 24,160 26,950 BUG Rating B1-U0-G1 B1-U0-G2 B1-U0-G2 B2-U0-G2 B2-U0-G3 B2-U0-G3 B3-U0-G4 B3-U0-G4 B3-U0-G4 B3-U0-G5 Lumens 3,116 6,088 9,084 12,004 14,872 17,797 21,047 23,848 26,602 BUG Rating B1-U0-G1 B1-U0-G2 B2-U0-G2 B2-U0-G2 B2-U0-G3 B3-U0-G3 B3-U0-G4 B3-U0-G4 B3-U0-G4 B3-U0-G5 
 Lumens
 3,074
 6,006
 8,962
 11,842
 14,672
 17,558
 20,764
 23,527
 26,244
 29,056

 BUG Rating
 B1-U0-G1
 B1-U0-G2
 B2-U0-G3
 B2-U0-G3
 B3-U0-G3
 B3-U0-G3
 B3-U0-G4
 B3-U0-G4
 B3-U0-G4
 B3-U0-G4
 Lumens 3,138 6,132 9,149 12,089 14,978 17,924 21,197 24,018 26,791 29,662 BUG Rating B1-U0-G1 B1-U0-G2 B1-U0-G2 B2-U0-G3 B2-U0-G3 B2-U0-G3 B3-U0-G4 B3-U0-G4 B3-U0-G4 B3-U0-G4 2,981 5,826 8,693 11,486 14,231 17,030 20,140 22,820 25,456 BUG Rating B0-U0-G1 B1-U0-G2 B1-U0-G3 B1-U0-G3 B1-U0-G3 B2-U0-G4 B2-U0-G4 B2-U0-G4 B2-U0-G4 B2-U0-G5 3,236 6,324 9,437 12,469 15,449 18,487 21,863 24,773 27,634 BUG Rating B1-U0-G0 B2-U0-G1 B3-U0-G1 B3-U0-G2 B3-U0-G2 B4-U0-G2 B4-U0-G2 B4-U0-G2 B4-U0-G2 3,296 6,441 9,610 12,698 15,733 18,828 22,266 25,229 28,142 BUG Rating B2-U0-G1 B3-U0-G1 B3-U0-G2 B4-U0-G2 B4-U0-G2 B5-U0-G3 B5-U0-G3 B5-U0-G3 B5-U0-G3 Lumens 3,305 6,458 9,636 12,732 15,775 18,878 22,325 25,296 28,217 BUG Rating B2-U0-G1 B3-U0-G2 B4-U0-G2 B4-U0-G2 B4-U0-G2 B5-U0-G3 B5-U0-G3 B5-U0-G3 B5-U0-G4 B5-U0-G4 Lumens 2,757 5,388 8,040 10,623 13,162 15,751 18,627 21,105 23,543 BUG Rating B1-U0-G1 B1-U0-G2 B1-U0-G2 B1-U0-G3 B2-U0-G3 B2-U0-G3 B2-U0-G3 B2-U0-G4 B3-U0-G4 B3-U0-G4 Lumens 3,207 6,267 9,351 12,356 15,309 18,320 21,666 24,549 27,384 BUG Rating B2-U0-G1 B3-U0-G1 B3-U0-G1 B3-U0-G2 B4-U0-G2 B4-U0-G2 B4-U0-G2 B4-U0-G2 B4-U0-G2 B4-U0-G2 B5-U0-G3 
 Lumens
 3,219
 6,290
 9,385
 12,401
 15,365
 18,387
 21,745
 24,638
 27,484
 30,429

 BUG Rating
 B1-U0-G1
 B1-U0-G1
 B2-U0-G2
 B2-U0-G2
 B2-U0-G2
 B2-U0-G2
 B3-U0-G3
 B3-U0-G3

Ambient Temperature	Lumen Multiplier	Ambient Temperature	TM-21 Lumen Maintenance	Theoretical L70
0°C	1.02		(60,000 Hours)	(3) (3)
10°C	1.01	25°C	> 94%	> 350,000
25°C	1.00	40°C	> 93%	> 250,000
40°C	0.99	50°C*	> 90%	> 170,000
50°C	0.97	* 50°C lumen main 700mA drive cun	tenance data applies	to 530mA and

REVISIONS DESCRIPTION DO NOT SCALE PRINTS - USE FIGURED DIMENSIONS ONLY PROJECT NO. 22-004

9100 OLD SANTA KANSAS CITY,

DATE

SANT

ISSUED FOR:

PROPERTY GROUP INC

310 East 96th Street, Suite 400

Indianapolis, IN 46240

(317) 846-3111

www.kittleproperties.com

PROJECT TITLE

SITE LIGHTING

SHEET TITLE

SHEET NUMBER

Faton
1121 Highway 74 South
Peachtree City, GA 30269
Powering Business Worldwide
Powerlong Business Worldwide

\* Nominal data for 4000K CCT


Faton
1121 Highway 74 South
Peachtree City, GA 30269
Powering Business Worldwide


2016-01-29 10:56:52

Faton
1121 Highway 74 South
Peachtree City, GA 30269
Powering Business Worldwide
Power aton. com/lighting
Power aton. com/lighting

2016-01-29 10:56:52



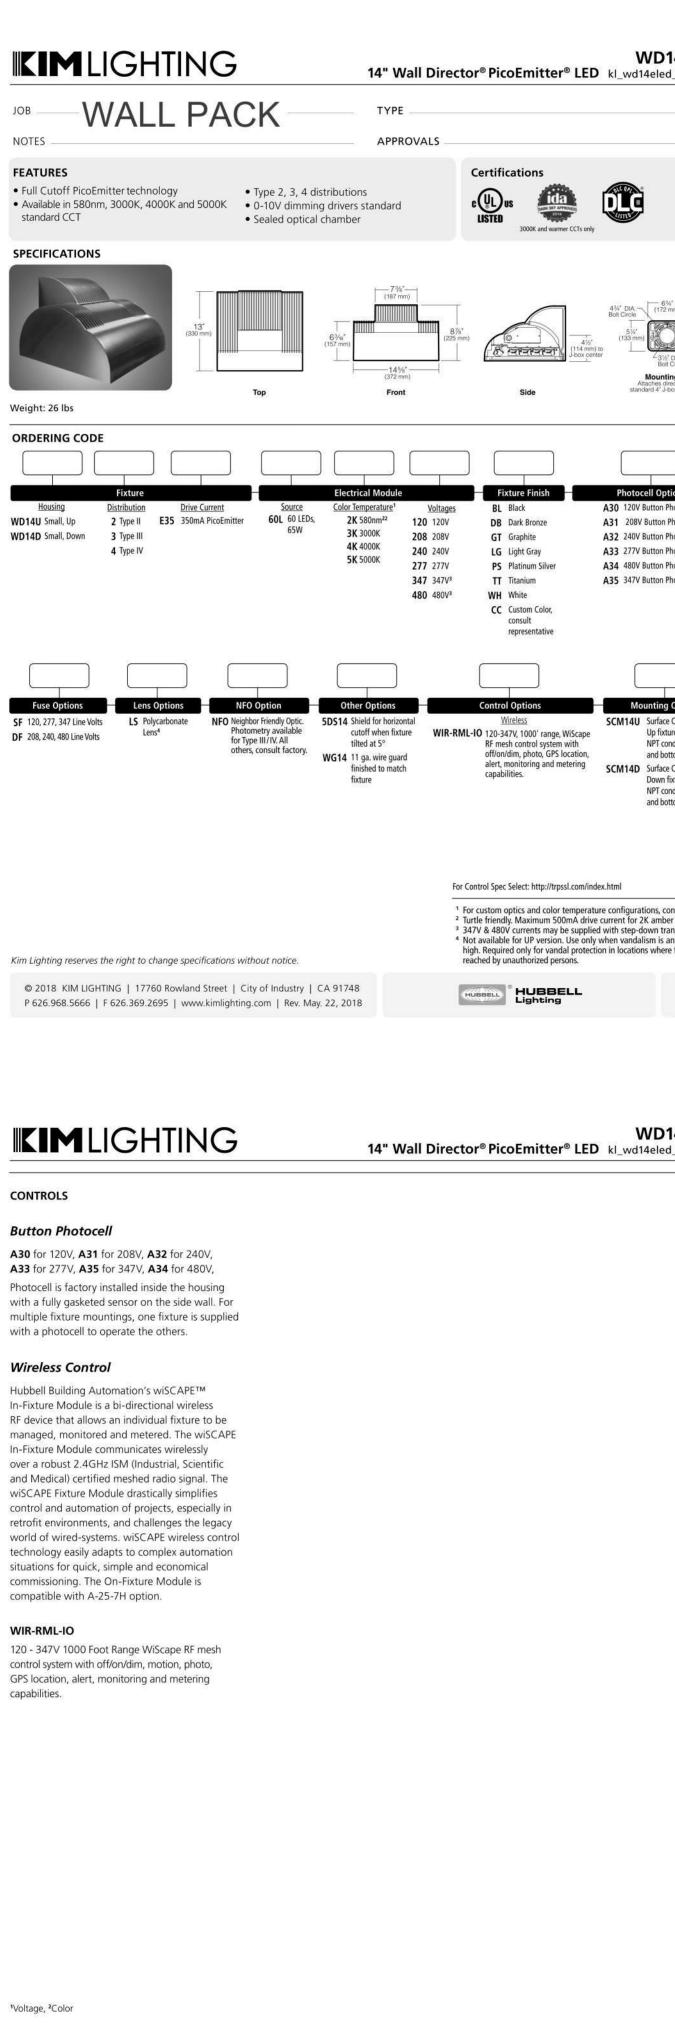

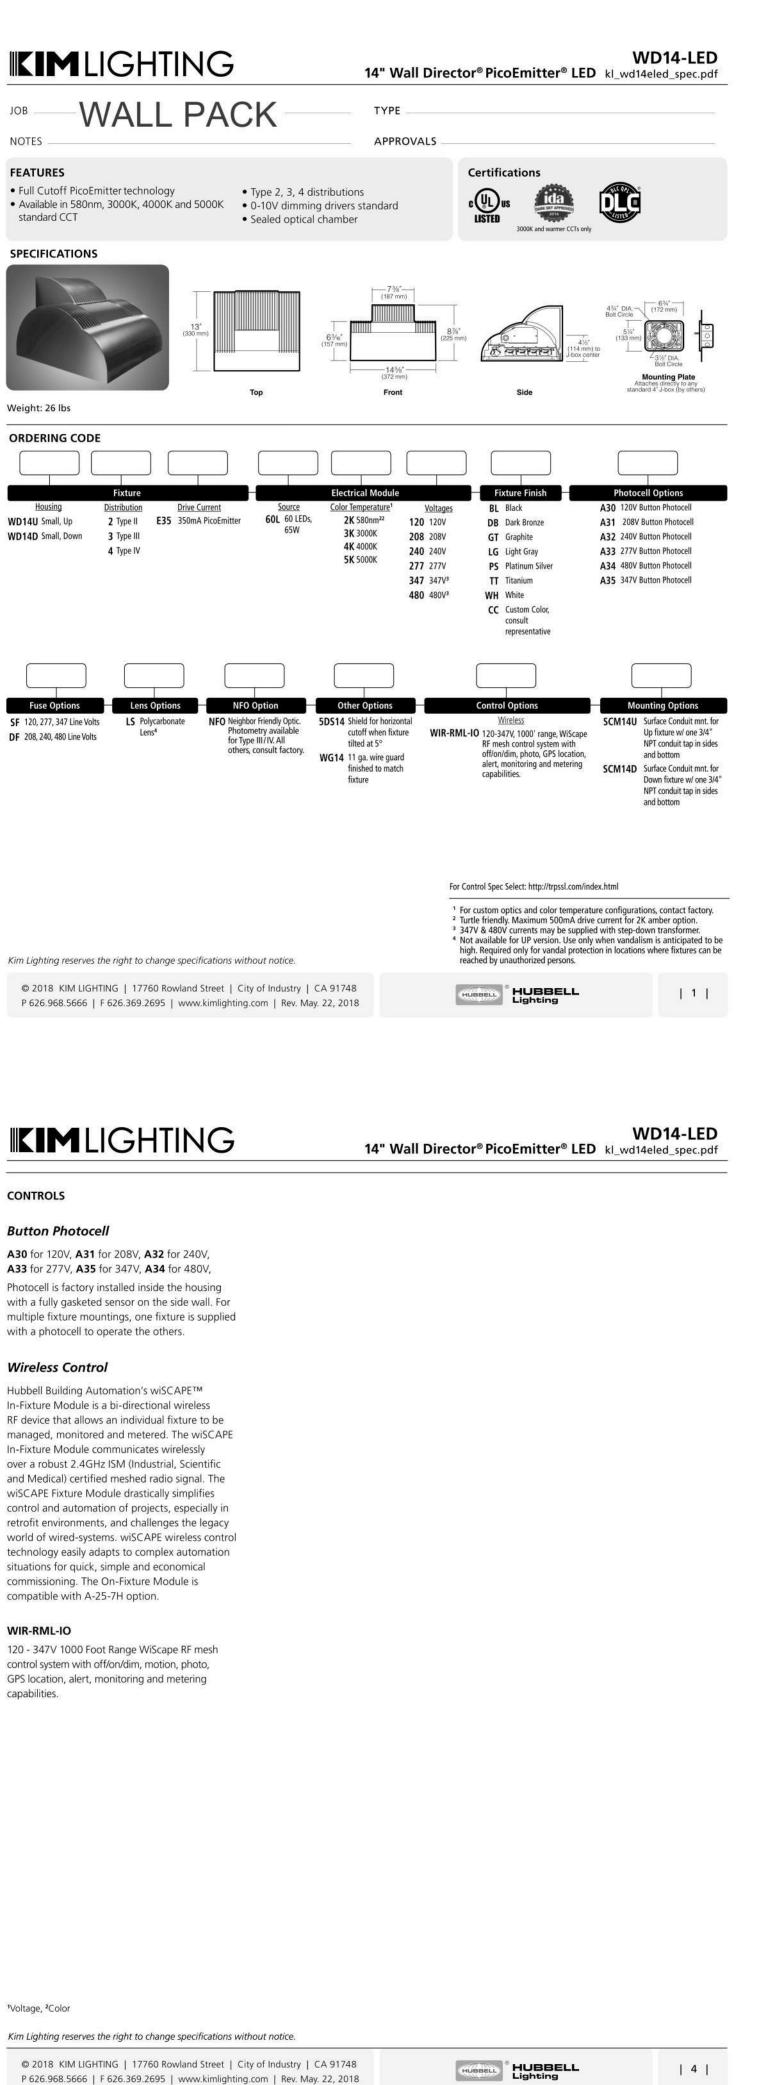



mA

350

ectrical Drive Current							
Volts - AC	Amps - AC	System Watts					
120	0.54	65					
208	0.31	65					
240	0.27	65					
277	0.23	65					
347	0.19	65					
		<del>*</del>					

5100K Average

4600K-5600K

≤70

>.90

3000K Average 4200K Average

3800K-4600K

≤80

>.90

2800K-3175K

≤80

>.90

Correlated Color Temp. CCT (K)

Color Rendering Index (CRI)

Power Factor

Temperature	TYPE 2	TYPE 3	TYPE 3 NFO	TYPE 4	TYPE 4 NFO
3000K	B1 U0 G1	B1 U0 G1	N/A	B1 U0 G1	B0 U0 G1
4200K	B2 U0 G2	B1 U0 G1	N/A	B1 U0 G1	B0 U0 G1
5100K	B2 U0 G2	B1 U0 G1	N/A	B1 U0 G1	B0 U0 G1

0.14

solute Lumens						
Temperature	TYPE 2	TYPE 3	TYPE 3 NFO	TYPE 4	TYPE 4 NFC	
3000K	3937	3868	N/A	3823	3120	
4200K	5104	5015	N/A	4956	4046	
5100K	5460	5365	N/A	5302	4328	

LED performance and lumen output continues to improve at a rapid pace. Log onto www.kimlighting.com to download the most current photometric files from Kim Lighting's IES File For custom optics and color temperature configurations, contact factory.

Kim Lighting reserves the right to change specifications without notice.

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HUBBELL Lighting

| 2 |

(Calculated L70)

657,000 Hrs.

100,000 hrs

93.83%

**KIM**LIGHTING

WD14-LED 14" Wall Director® PicoEmitter® LED kl\_wd14eled\_spec.pdf

# **OPTIONS**

Fusing:

SF for 120, 277 and 347 Line Volts DF for 208, 240 and 480 Line Volts High temperature fuse holders factory installed inside the fixture housing. Fuse is included.

# Polycarbonate Lens

Clear flat polycarbonate lens replaces standard tempered glass lens.360° pattern. Module colors Wire Guard

available Black, Gray, and White. **NOTE:** Use only when vandalism is anticipated to be high. Useful life is limited by UV discoloration from sunlight. A program of regular inspection

and periodic replacement is highly recommended

to maintain optimum fixture performance.

# **Neighbor Friendly Optic**

Integrated Neighbor Friendly Optic on each PicoEmitter module to completely control unwanted backlight. Most effective with Type III and IV distibutions.

# 5° Shield

Aluminum shield field-attached to lens frame. Maintains a horizontal cutoff fixture edge when the luminaire is tilted 5°. Finished to match the

11 ga. (.12" dia.) BB Wire, (.75" sq. welded


mesh pattern,) 11-3/8" x 10-1/4" x 1-1/2" deep. Finish is TGIC thermoset polyester powder coat. Finished to mach the fixture.

**Surface Conduit Mount** 

# **SCM14U** for UP fixtures only. SCM14D for DOWN fixtures only.

Cast aluminum junction box and fixture mount for attachment (by others) to existing walls, beams or columns. SCM14 has one 3/4" NPT conduit tap in each side and bottom. Must be securely mounted to wall surface. Finished to match the fixture.

NOTE: Must be securely mounted to all surfaces.

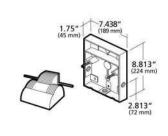

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DESCRIPTION

DATE

Indianapolis, IN 46240

(317) 846-3111

www.kittleproperties.com

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SHEET TITLE

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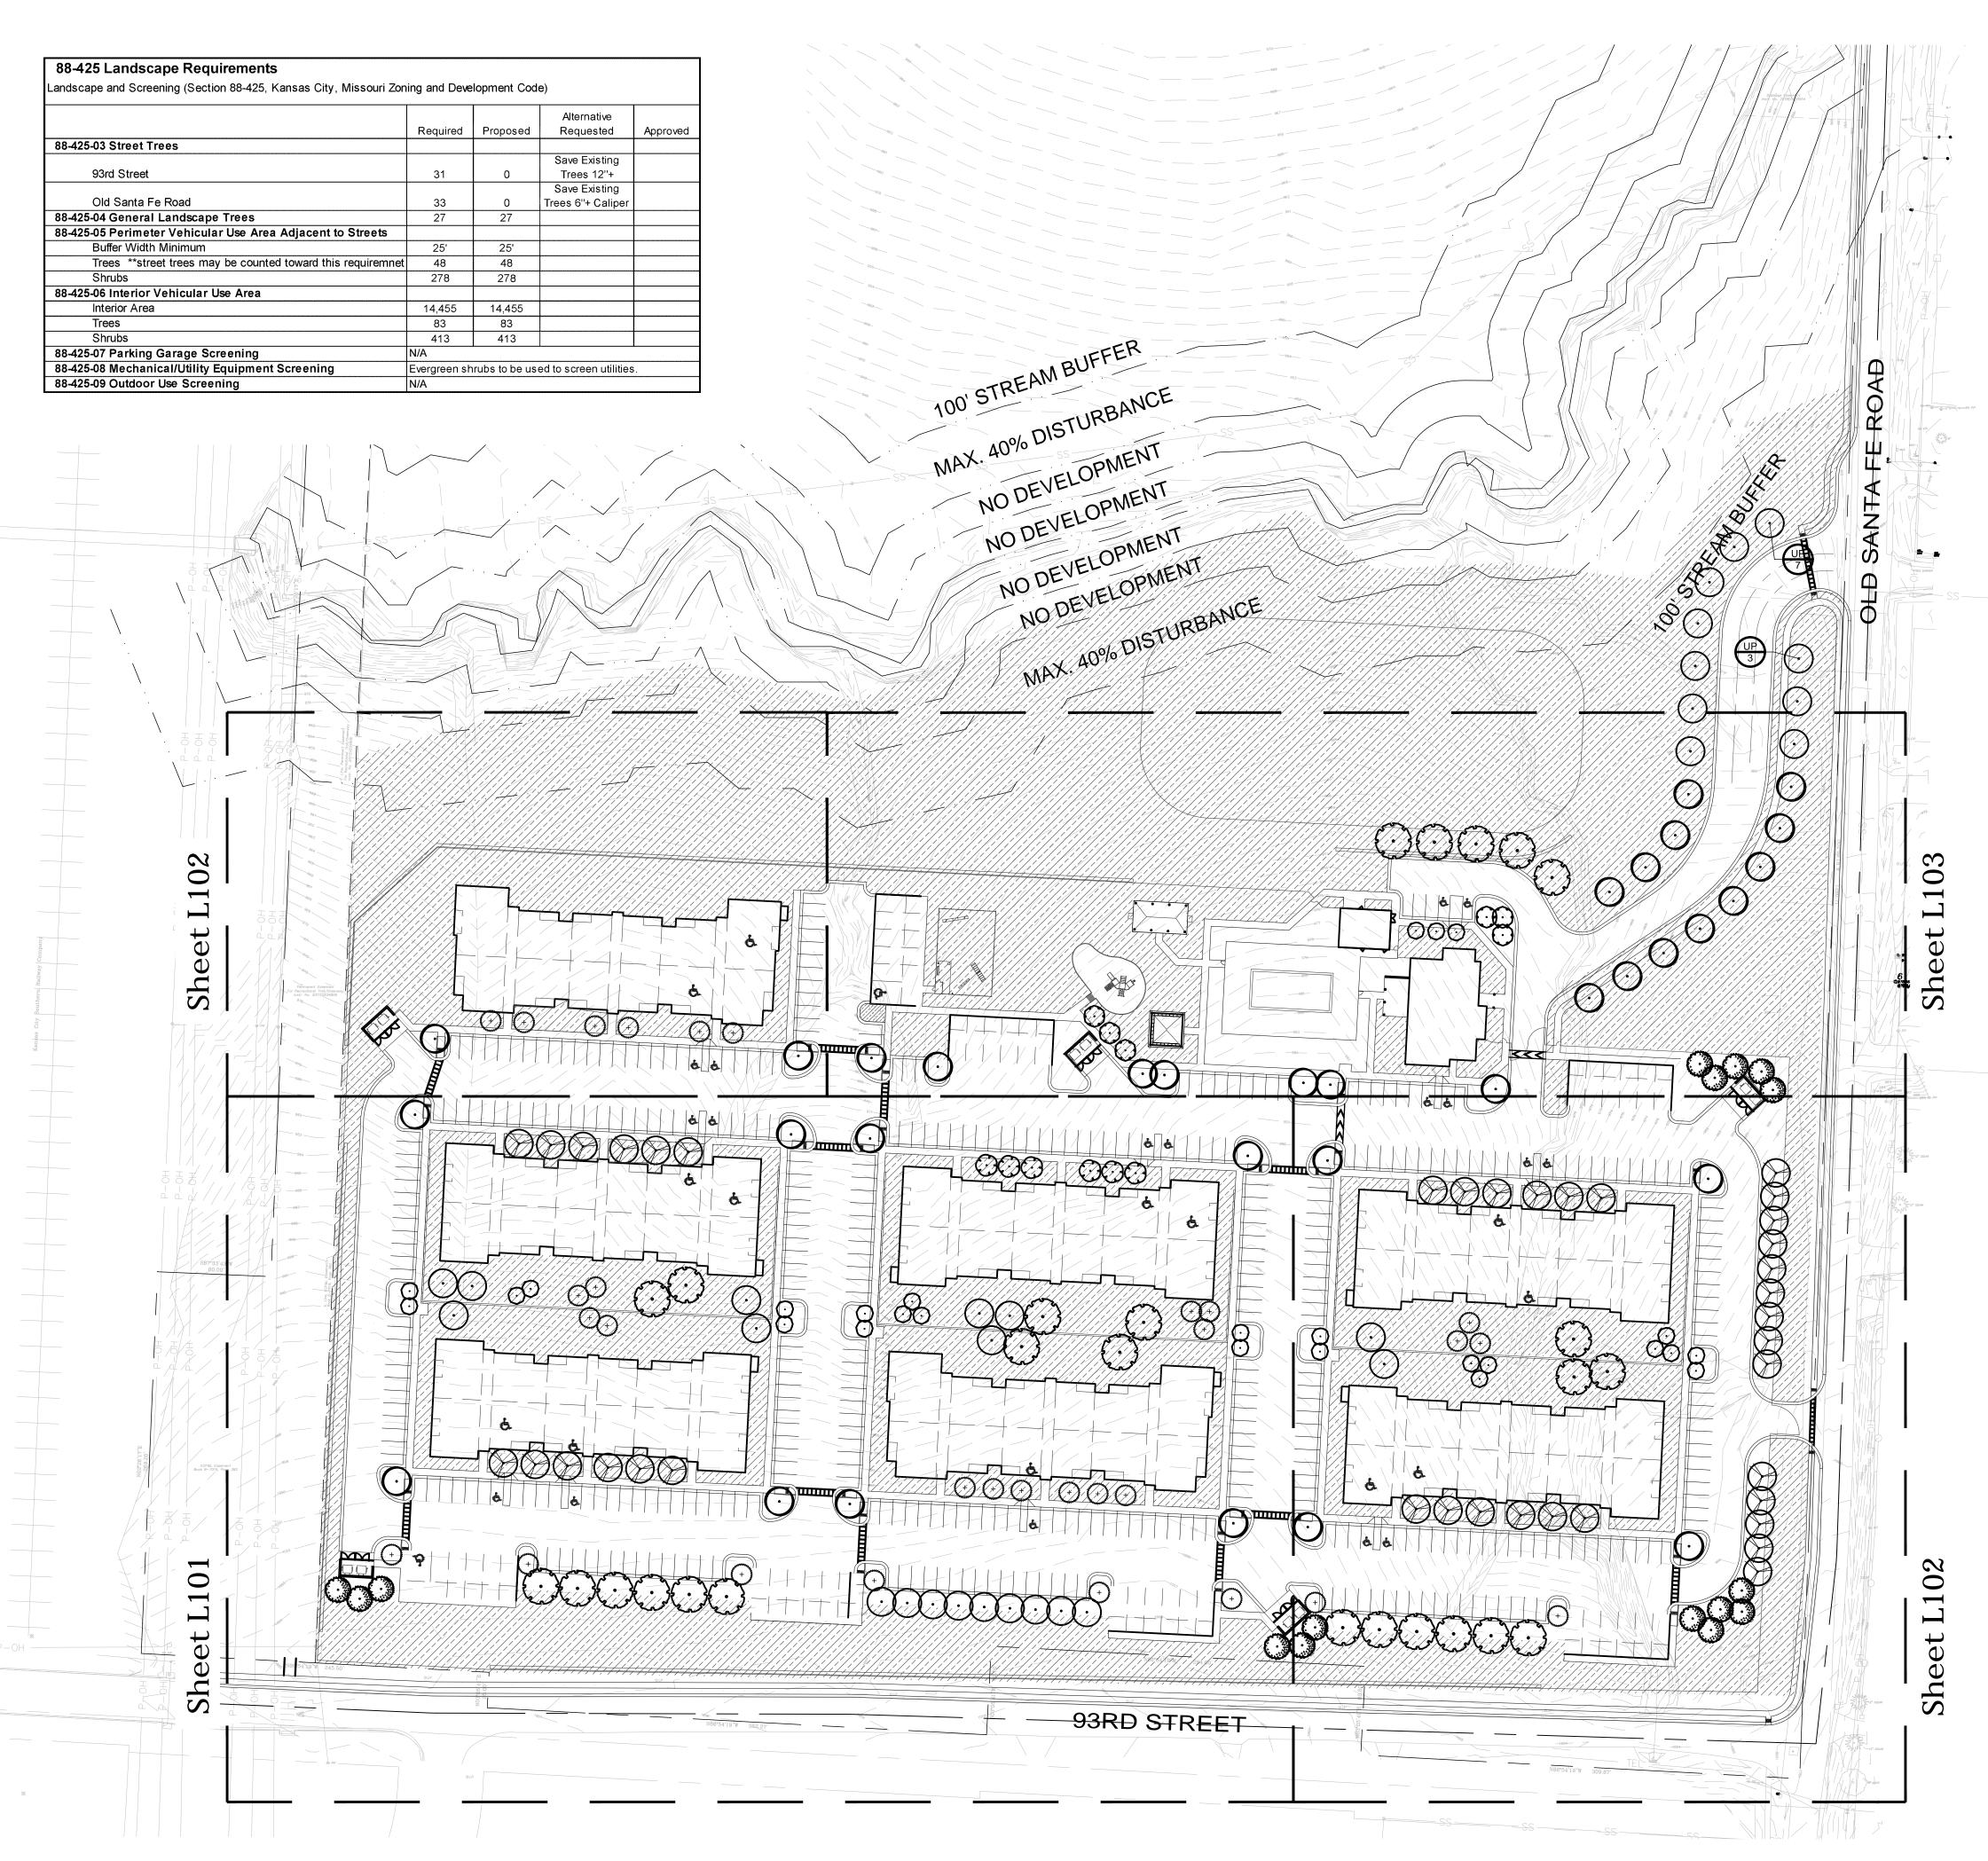
SITE LIGHTING

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| 5 |





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# GENERAL NOTES

- 1. IT IS THE OWNER'S INTENT TO SAVE AND PROTECT ALL EXISTING MATURE AND HEALTHY TREES 12" + CALIPER ALONG 93RD STREET.
- 2. It IS THE OWNER'S INTENT TO SAVE AND PROTECT ALL EXISTING MATURE AND HEALTHY TREES 6" + CALIPER ALONG OLD SANTA FE ROAD.
- 3. IF TREES ARE DAMAGED OR DIE FROM AND/OR DURING CONSTRUCTION ACTIVITIES, CONTRACTOR SHALL PROVIDE A STREET TREE REPLACEMENT TO MEET THE LANDSCAPE CODE REQUIREMENTS.
- 4. IT IS THE OWNER'S INTENT TO SAVE APPROXIMATELY 45% OF EXISTING TREES ON SITE. SEE SHEET L200 FOR REMOVAL LIMITS.

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PROJECT TITLE

The Depot on Old Sante Fe 8100 old Sante Fe RD Kansas City, MO 64138

SHEET TITLE

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OVERALL LANDSCAPE PLAN

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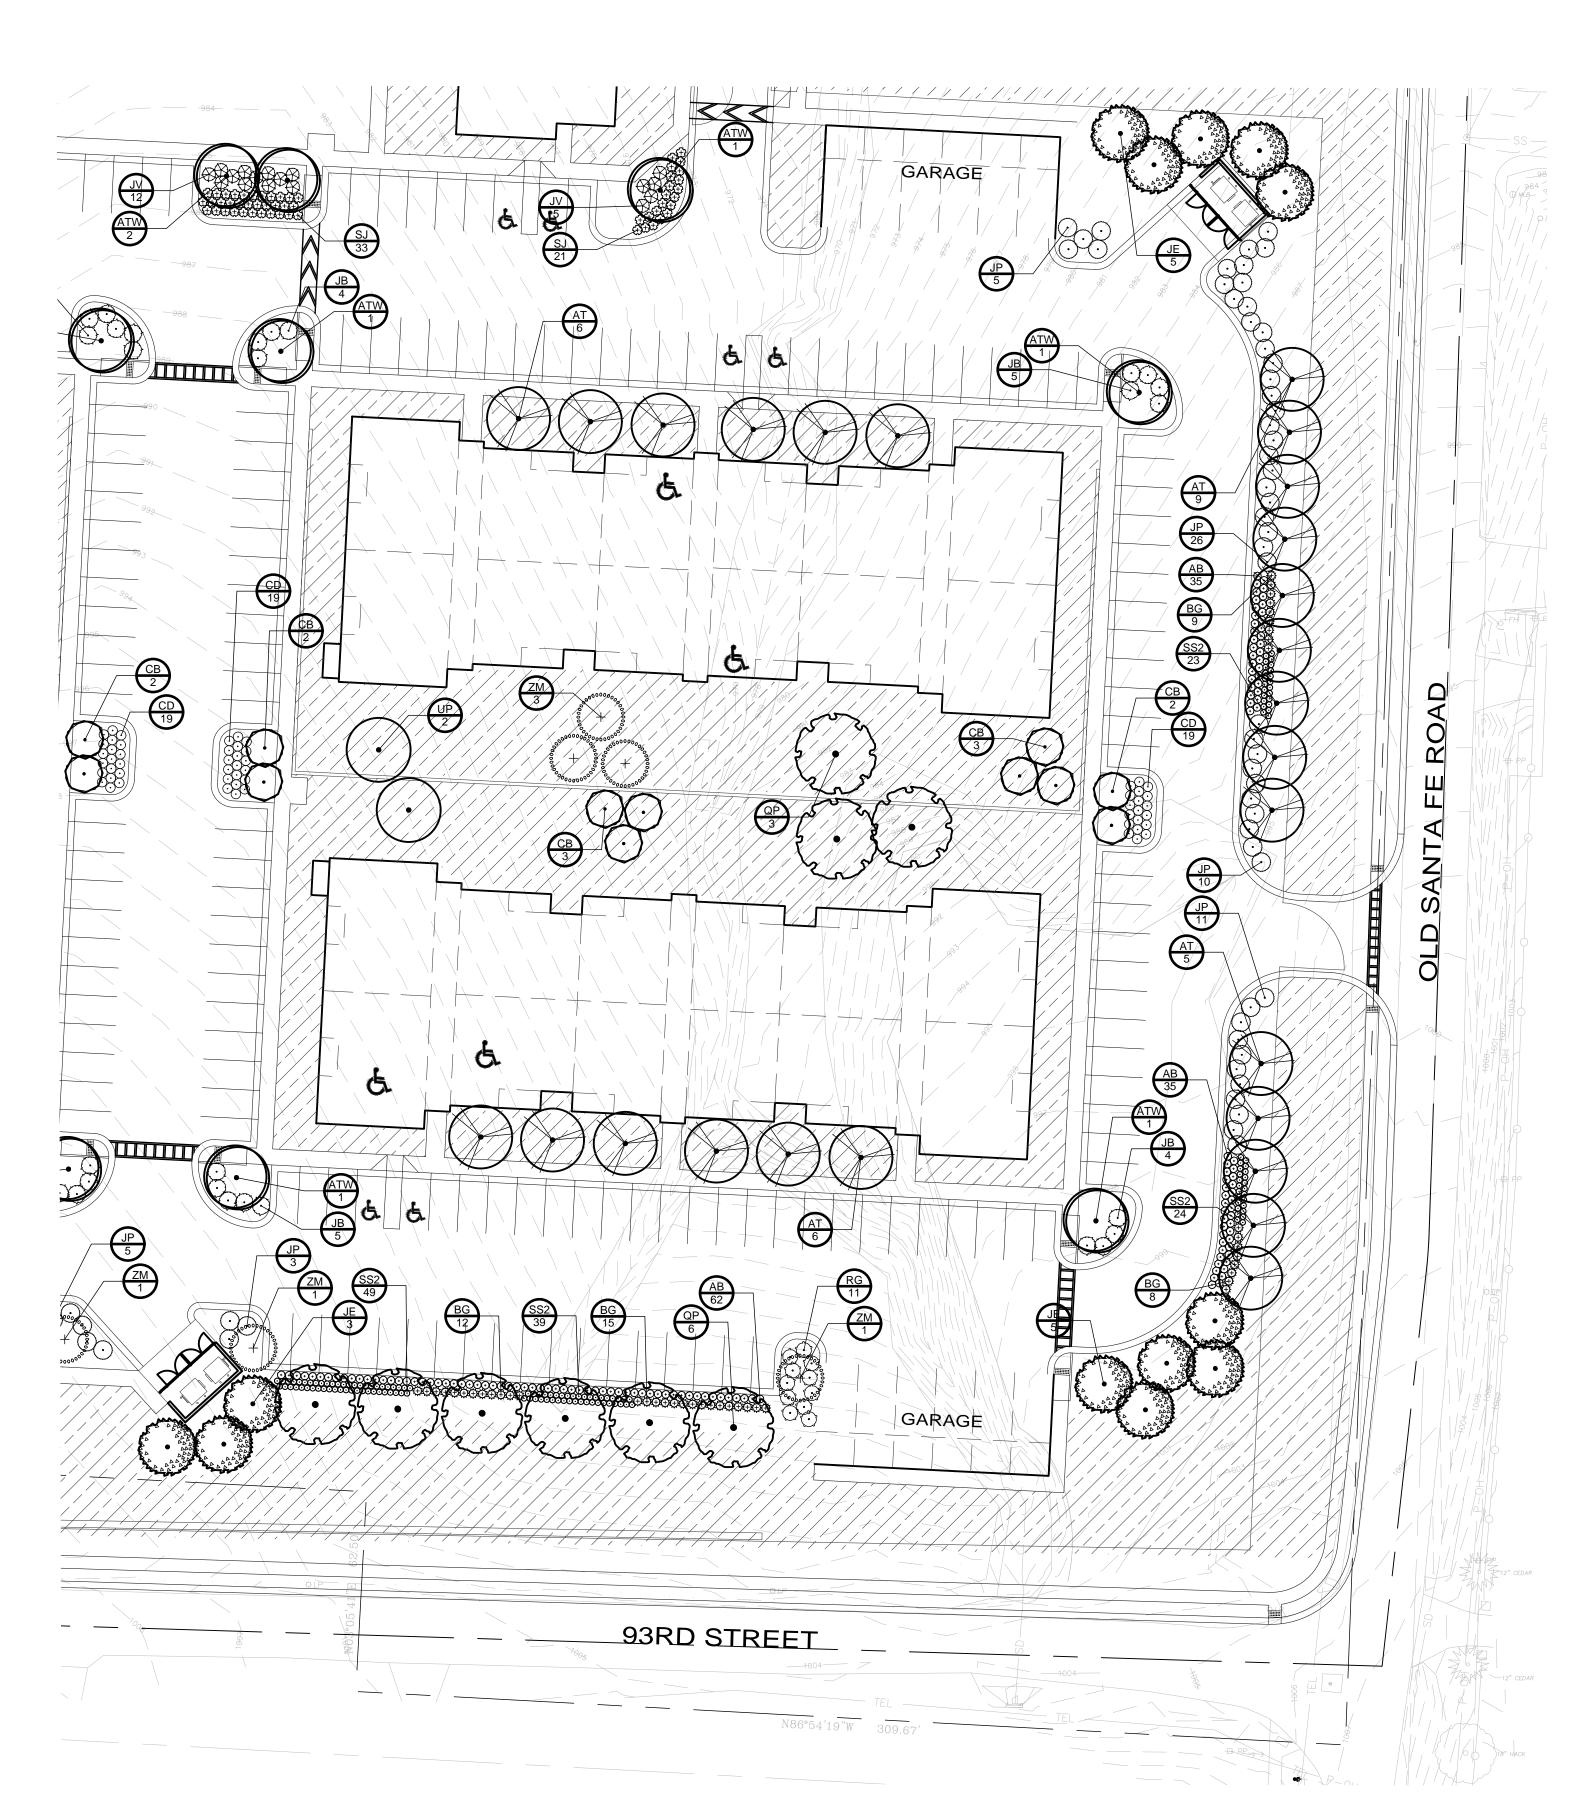
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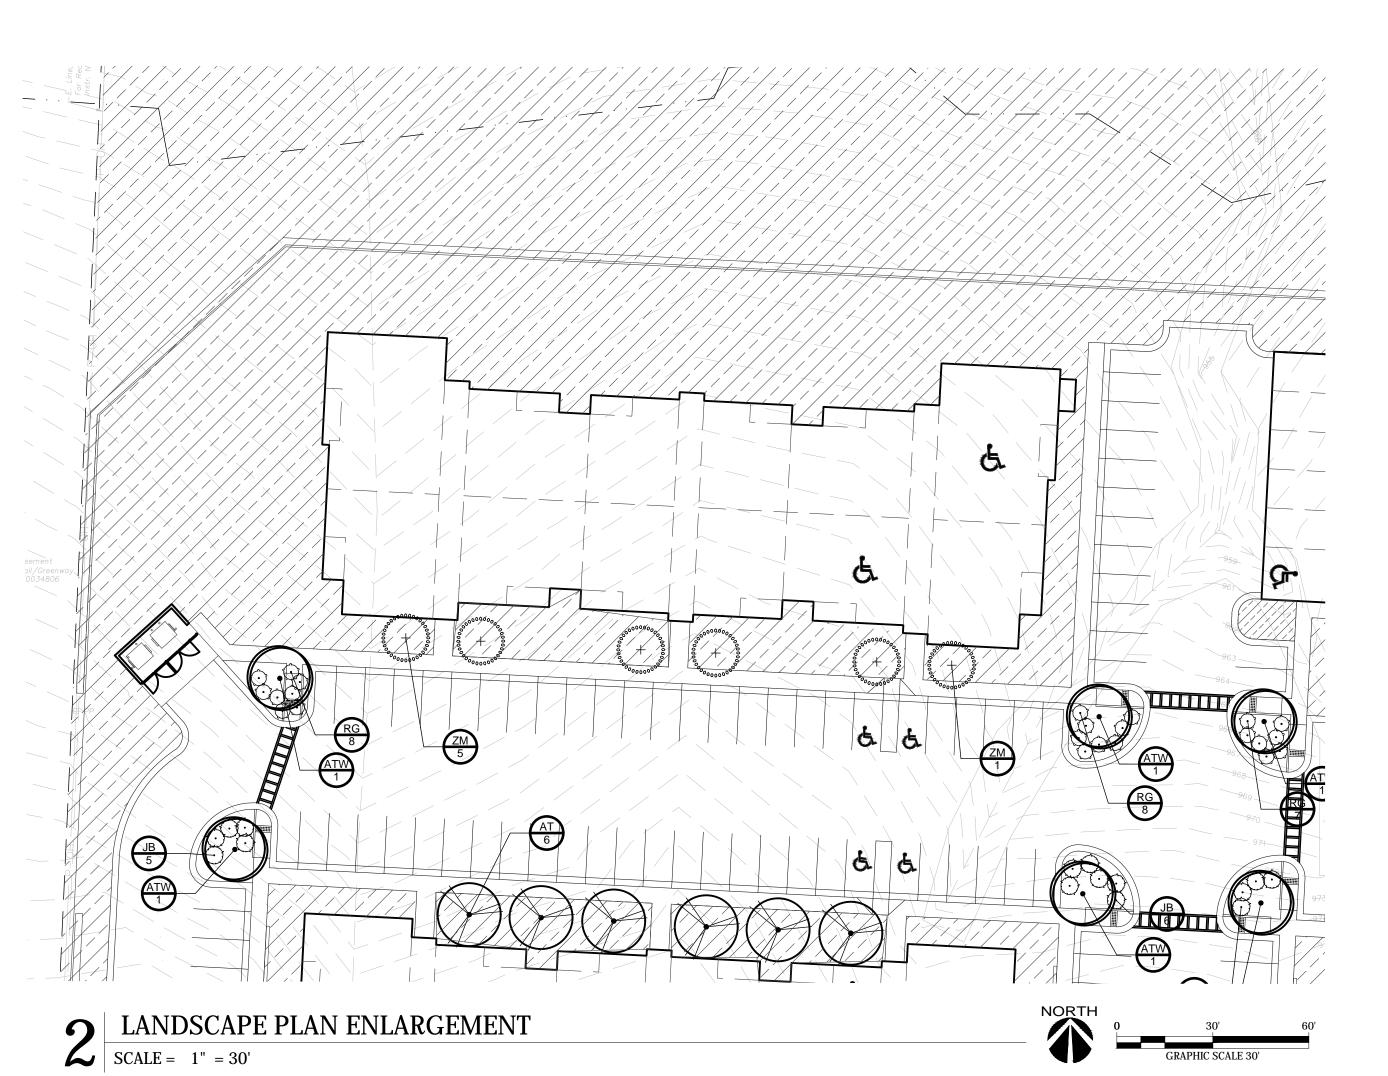
SHEET TITLE

LANDSCAPE PLAN

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MARK DES	SCRIPTION	DATE
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JOB NO. 22-003





PLANT SCHED	ULE										
DECIDUOUS TREES	CODE	QTY	COMMON / BOTANICAL NAME	CONT	CAL	<u>SI</u>	DECIDUOUS SHRUBS	CODE	<u>QTY</u>	COMMON / BOTANICAL NAME	CONT
	АТ	38	SHANTUNG MAPLE / ACER TRUNCATUM	B & B	2"CAL		+	AB	200	LOW SCAPE HEDGER BLACK CHOKEBERRY / ARONIA MELANOCARPA `UCONNAM166` TM	2 GAL
$(\cdot)$	ATW	33	PACIFIC SUNSET MAPLE / ACER TRUNCATUM 'WARRENRED'	В&В	2"CAL		$\odot$	CD	114	SUNSHINE BLUE II BLUEBEARD / CARYOPTERIS X CLANDONENSIS `SUNSHINE BLUE II`	2 GAL
$\odot$	СВ	26	COLUMNAR EUROPEAN HORNBEAM / CARPINUS BETULUS 'COLUMNARIS'	В&В	2"CAL		$\odot$	RG	87	GRO-LOW FRAGRANT SUMAC / RHUS AROMATICA `GRO-LOW`	2 GAL
{ . }	QP	26	AMERICAN DREAM OAK / QUERCUS BICOLOR `JFS-KW12` TM	B & B	2"CAL		<del>(+)</del>	SJ	77	NEON FLASH SPIREA / SPIRAEA JAPONICA `NEON FLASH`	2 GAL
.00000	UP	29	EMERALD SUNSHINE ELM / ULMUS PROPINQUA `JFS-BIEBERICH`	B & B	2"CAL		EVERGREEN SHRUBS	<u>CODE</u> JB	<u>QTY</u> 72	COMMON / BOTANICAL NAME  BLUE RUG JUNIPER / JUNIPERUS HORIZONTALIS `BLUE RUG`	CONT 5 GAL
000 + 000 00000000000000000000000000000	ZM	30	MUSASHINO SAWLEAF ZELKOVA / ZELKOVA SERRATA `MUSASHINO`	В&В	2"CAL		$\otimes$	JV	69	GREY OWL JUNIPER / JUNIPERUS VIRGINIANA `GREY OWL`	5 GAL
EVERGREEN TREES	CODE	QTY	COMMON / BOTANICAL NAME	CONT	CAL	<u>SI.</u>	$\odot$	JP	75	SEA GREEN JUNIPER / JUNIPERUS X PFITZERIANA `SEA GREEN`	5 GAL
	JE	16	EASTERN REDCEDAR / JUNIPERUS VIRGINIANA	B & B		6`	GRASSES & PERENNIALS	CODE	QTY	COMMON / BOTANICAL NAME	CONT
ORNAMENTAL TREES	CODE	QTY	COMMON / BOTANICAL NAME	CONT	CAL	<u>SI.</u>	<del>\``</del> }	BG	70	BLONDE AMBITION BLUE GRAMA / BOUTELOUA GRACILIS	1 GAL
	AA	6	AUTUMN BRILLIANCE SERVICEBERRY / AMELANCHIER CANADENSIS `AUTUMN BRILLIANCE`	В&В	1.5"CAL		$\odot$	SS2	203	JAZZ LITTLE BLUESTEM GRASS / SCHIZACHYRIUM SCOPARIUM `JAZZ`	1 GAL
	СК	6	KOUSA DOGWOOD / CORNUS KOUSA	B & B	1.5"CAL		GROUND COVERS	CODE	QTY	COMMON / BOTANICAL NAME	CONT
								TF	382,737 SF	TALL FESCUE / TURF TYPE TALL FESCUE BLEND	SEED



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SEAL

PROJECT TITLE

The Depot on Old Sante Fe 8100 old Sante Fe RD Kansas City, MO 64138

SHEET TITLE


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SHEET NU





EXISTING TREES TO BE REMOVED

EXISTING TREES TO BE PRESERVED

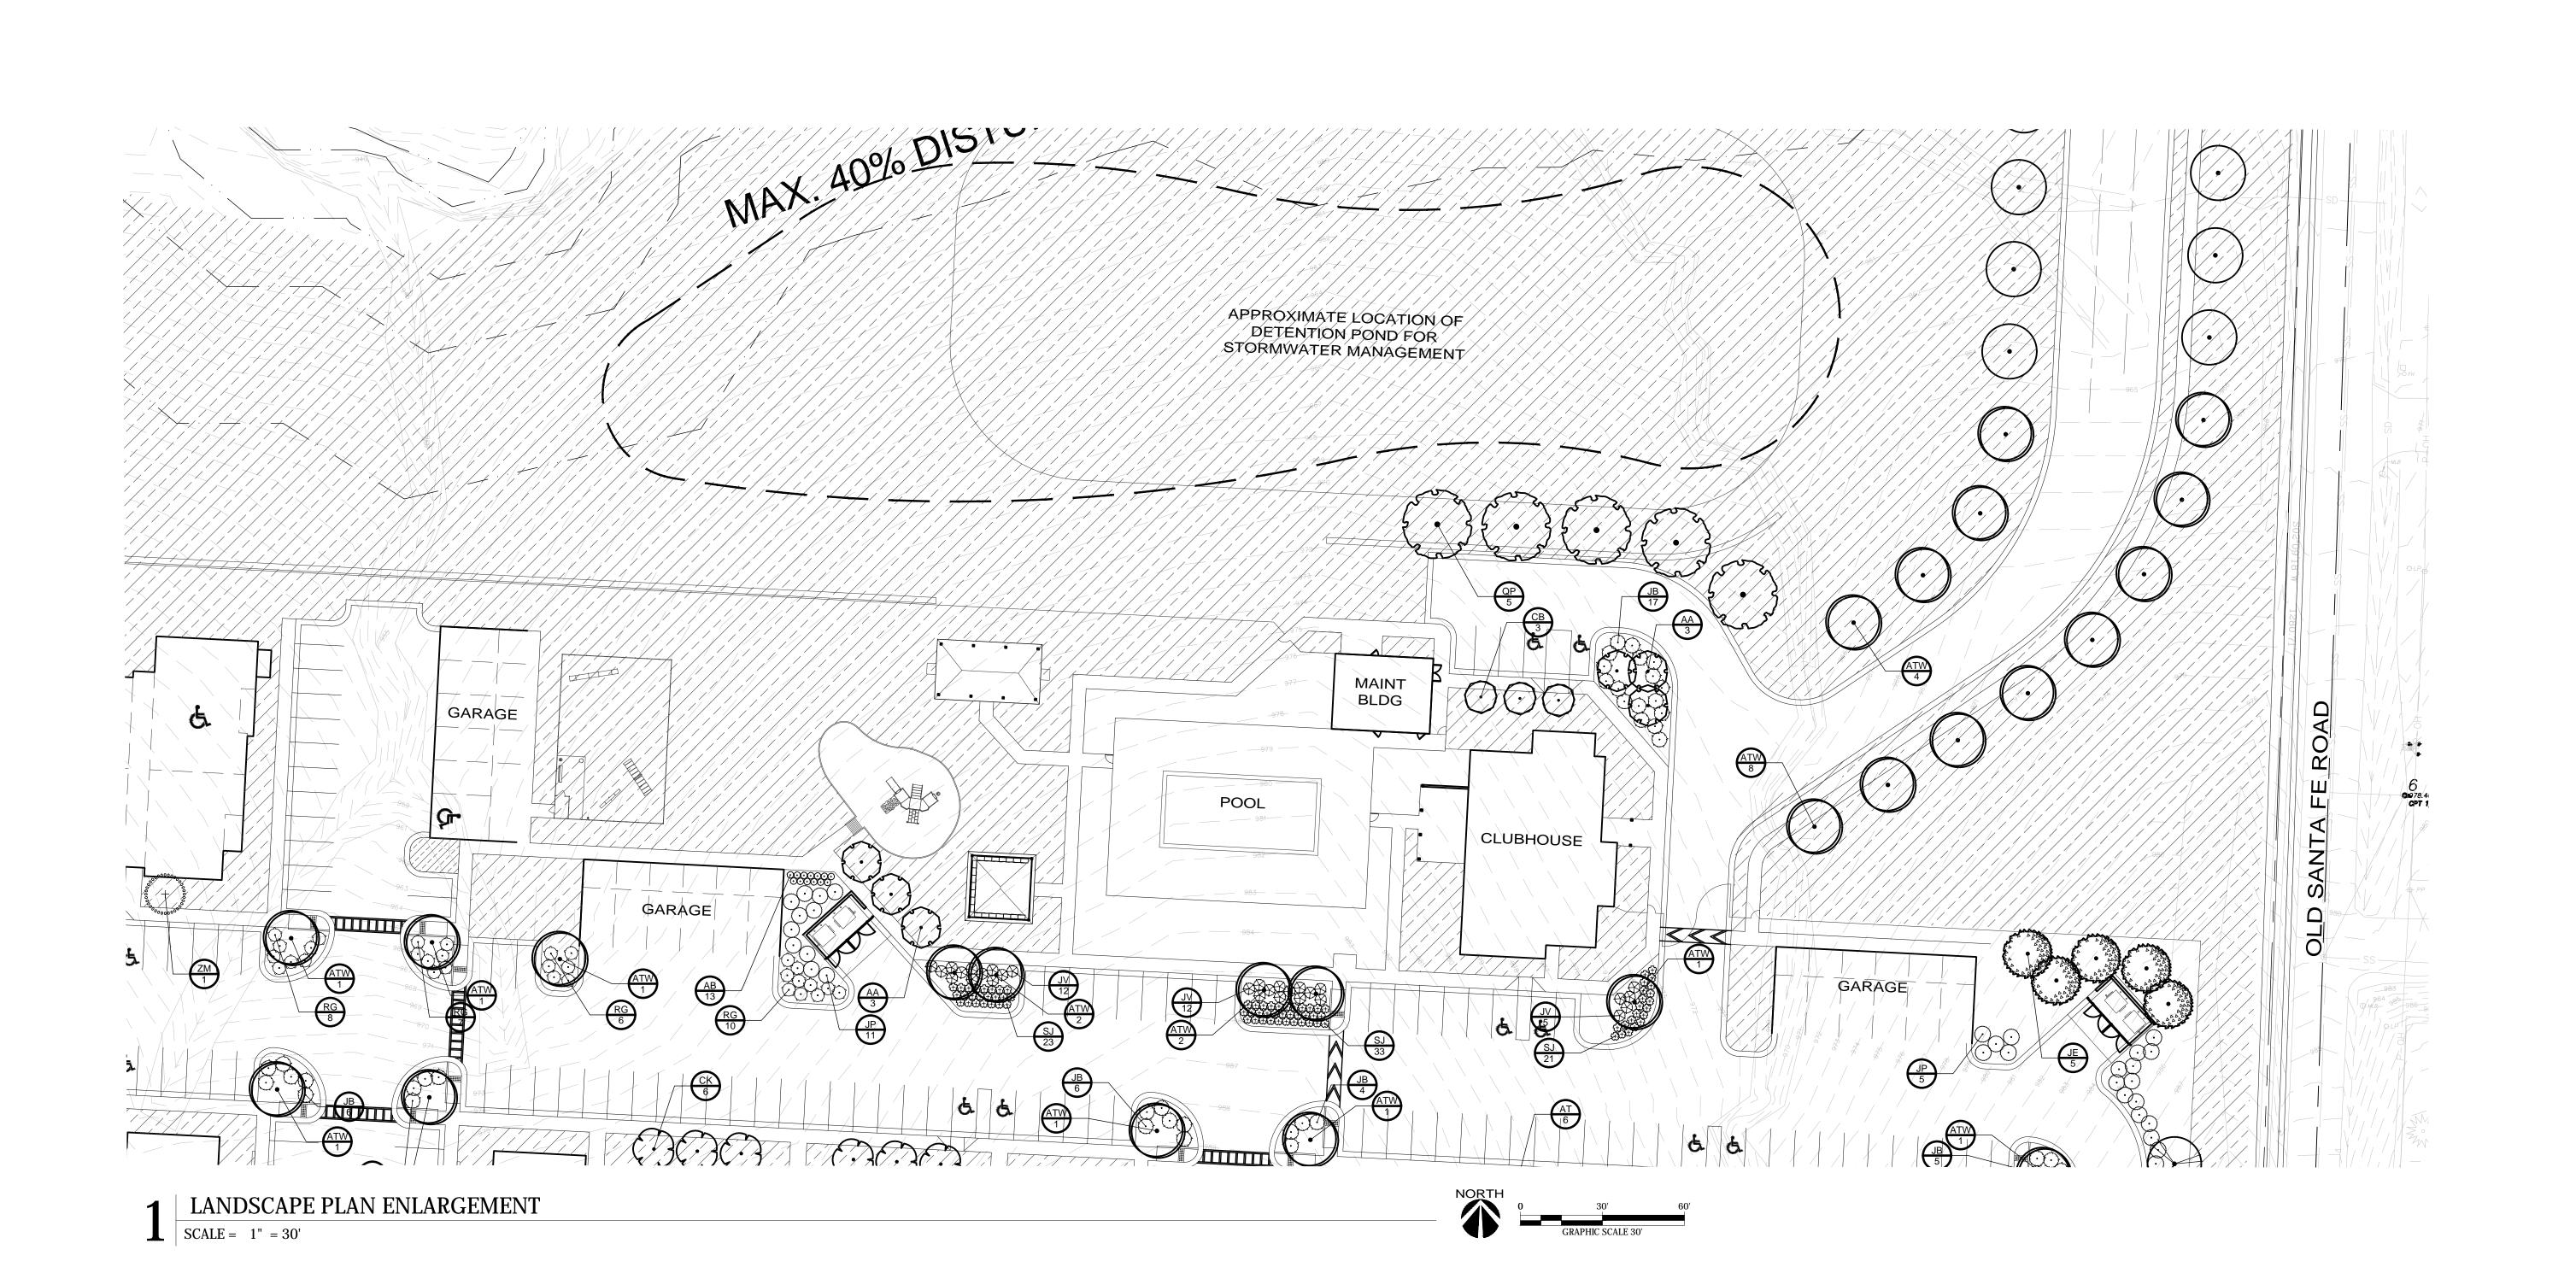EXISTING TREES 12" + CALIPER TO BE PRESERVED

EXISTING TREES 6" + CALIPER TO BE PRESERVED

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LEGEND

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TREE REMOVAL

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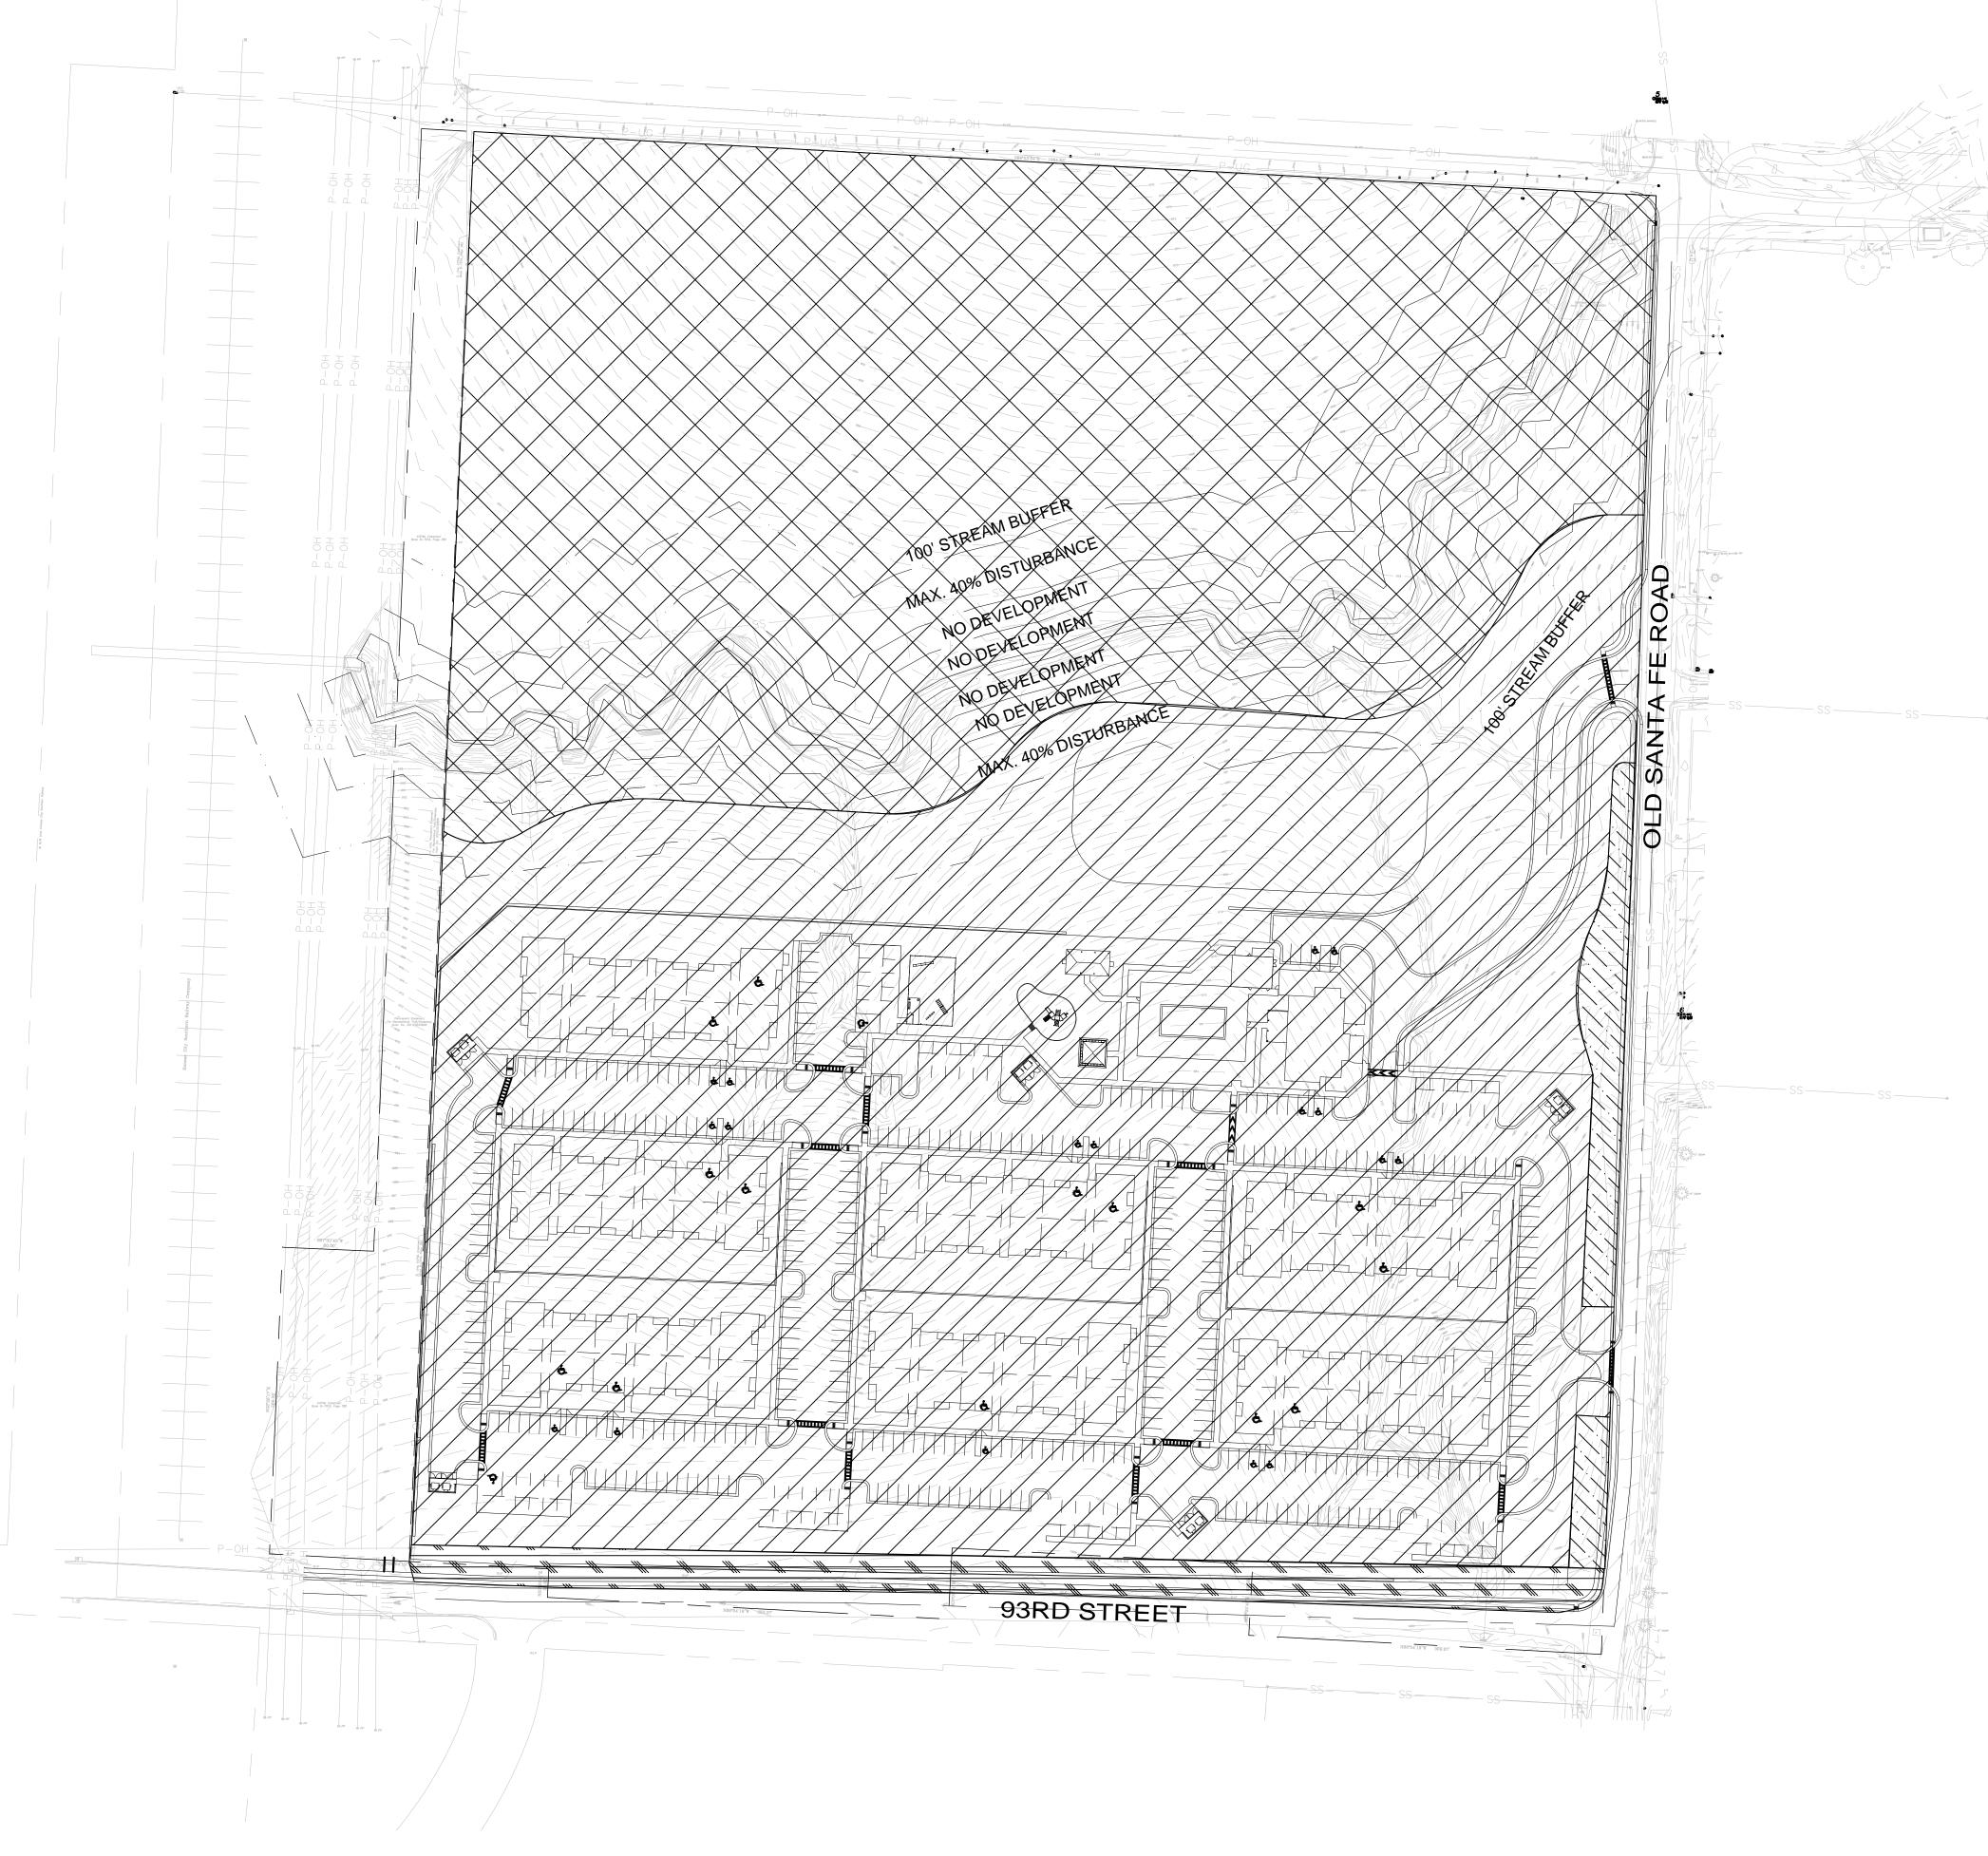
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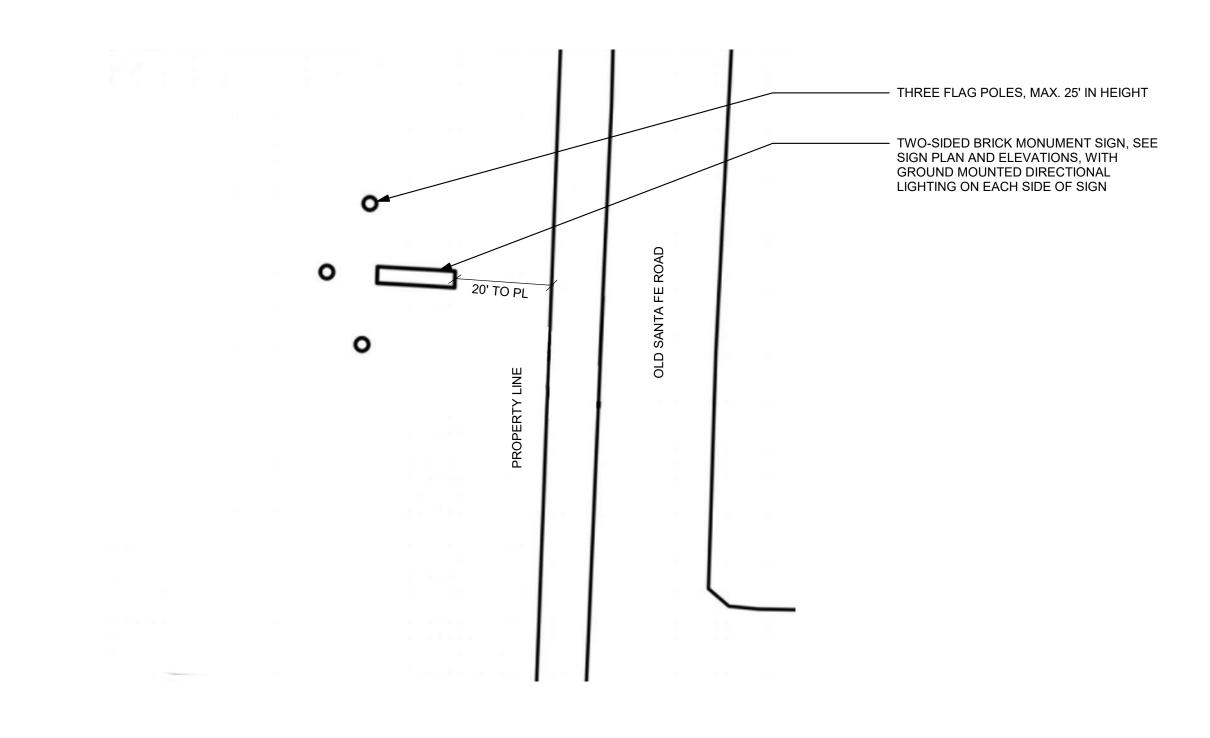
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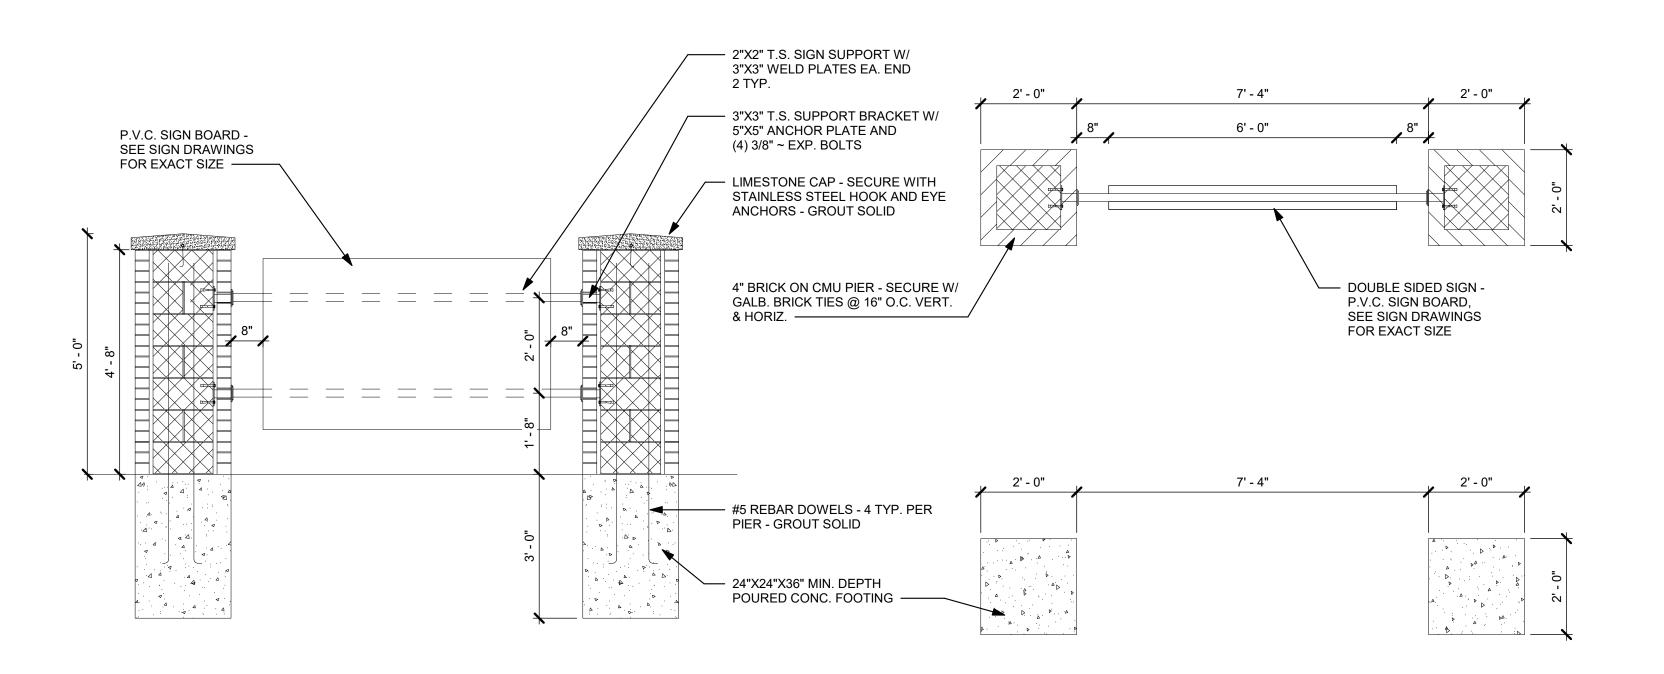
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# MONUMENT SIGN PLAN ASP 6 N.T.S.



1 MONUMENT SIGN DETAILS
ASP 6 SCALE: 1/2" = 1'-0"

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IE DEPOT ON OLD
SANTA FE ROAD

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SHEET TITLE

MONUMENT SIGN

SHEET NUMBER

ASP 6



3BR12+2BR12+1BR12 - FRONT ELEVATION 3/32" = 1'-0"



33BR12+2BR12+1BR12 - RIGHT ELEVATION 3/32" = 1'-0"



**2** 3BR12+2BR12+1BR12 - LEFT ELEVATION 3/32" = 1'-0"



**4** 3BR12+2BR12+1BR12 - REAR ELEVATION 3/32" = 1'-0"



Value Keynote Text E1 DIMENSIONAL ASPHALT SHINGLE ROOF - 30 YEAR WARRANTY E4 VERTICAL 2X6 BOARD AND BATTEN - VERTICAL VINYL SIDING -COLOR 2 E5 VINYL WINDOWS - SEE WINDOW SCHEDULE E6 1X6 TRIM BETWEEN WINDOWS - TYP. E7 BRICK SILL E8 BRICK HEADER E9 WOOD BEAM / 1X12 COMPOSITE WRAP - SEE STRUCTURE FOR E10 6X6 FIRE TREATED COMPOSITE COLUMN, WRAPPED IN FIBER CEMENT - ALL PORCHES AND BALCONIES E12 6" ALUMINUM GUTTER & DOWNSPOUTS, PRE-FINISHED E13 DOWNSPOUTS (TYP.) TO TIE INTO STORM DRAINS

**ELEVATIONS KEYNOTES** 

E20 6" FIBERCEMENT TRIM BOARDS E22 1x6 TRIM WRAP CONTINUOUS AROUND BLDG AT ROOF LINE E23 FIBERGLASS ENTRY/PATIO DOOR .. E25 VINYL SIDING - COLOR 2

**BUILDING EXTERIOR MATERIAL PERCENTAGE BREAKDOWN:** 

BRICK VENEER = 30%

E26 VINYL SIDING - COLOR 3

E15 RIDGE VENT

E18 COMPOSITE RAILING

VINYL SIDING = 70%

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ANTA

9100 OLD 8 KANSA

DATE

08/26/22 REVISIONS DESCRIPTION DATE DO NOT SCALE PRINTS - USE FIGURED DIMENSIONS ONLY PROJECT NO. 22-003

ISSUED FOR:

SHEET TITLE

**ELEVATIONS -**1BR12+2BR12+3BR12

SHEET NUMBER

DDO IEOT TITI

# HE DEPOT ON OLD SANTA FE

9100 OLD KANSA

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SHEET TITLE

**ELEVATIONS KEYNOTES** 

E1 DIMENSIONAL ASPHALT SHINGLE ROOF - 30 YEAR WARRANTY

E10 6X6 FIRE TREATED COMPOSITE COLUMN, WRAPPED IN FIBER

E22 1x6 TRIM WRAP CONTINUOUS AROUND BLDG AT ROOF LINE

BUILDING EXTERIOR MATERIAL PERCENTAGE

E12 6" ALUMINUM GUTTER & DOWNSPOUTS, PRE-FINISHED

E13 DOWNSPOUTS (TYP.) TO TIE INTO STORM DRAINS

E4 VERTICAL 2X6 BOARD AND BATTEN - VERTICAL VINYL

E5 VINYL WINDOWS - SEE WINDOW SCHEDULE

CEMENT - ALL PORCHES AND BALCONIES

E6 1X6 TRIM BETWEEN WINDOWS - TYP.

E2 BRICK

E7 BRICK SILL

E15 RIDGE VENT

E18 COMPOSITE RAILING

E25 VINYL SIDING - COLOR 2
E26 VINYL SIDING - COLOR 3

**BREAKDOWN**:

BRICK VENEER = 30%

VINYL SIDING = 70%

E20 6" FIBERCEMENT TRIM BOARDS

E23 FIBERGLASS ENTRY/PATIO DOOR

E8 BRICK HEADER

SIDING -COLOR 2

Keynote Text

ELEVATIONS -1BR12+2BR18+4BR6

SHEET NUMBER

A-201



4BR6+2BR18+1BR12 - FRONT ELEVATION 3/32" = 1'-0"



**3** 4BR6+2BR18+1BR12 - RIGHT ELEVATION 3/32" = 1'-0"



**2** 4BR6+2BR18+1BR12 - LEFT ELEVATION 3/32" = 1'-0"



4BR6+2BR18+1BR12 - REAR ELEVATION 3/32" = 1'-0"



**1** FRONT ELEVATION 1/8" = 1'-0"




EXTERIOR MATERIAL CALCULATIONS

BRICK = 35%

VINYL SIDING = 65%

**2** REAR ELEVATION 1/8" = 1'-0"

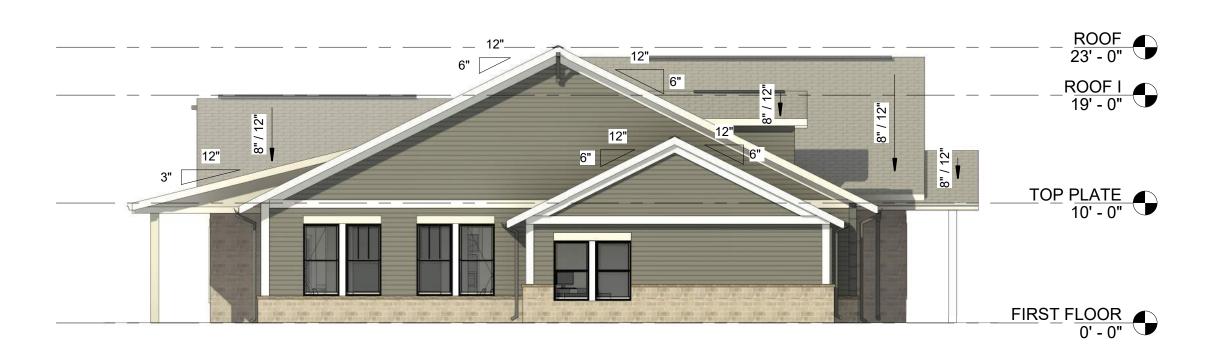

**3** LEFT ELEVATION 1/8" = 1'-0"

**4** RIGH 1/8" =



**4** RIGHT ELEVATION 1/8" = 1'-0"



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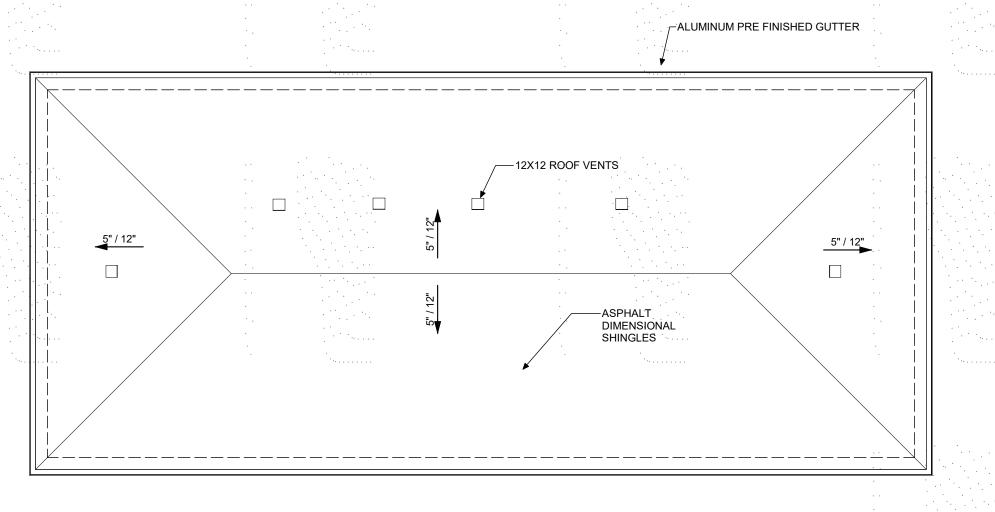
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CLUBHOUSE ELEVATIONS


SHEET NUMBER

AC-200



# 6-BAY GARAGE A ROOF PLAN 1/8" = 1'-0"



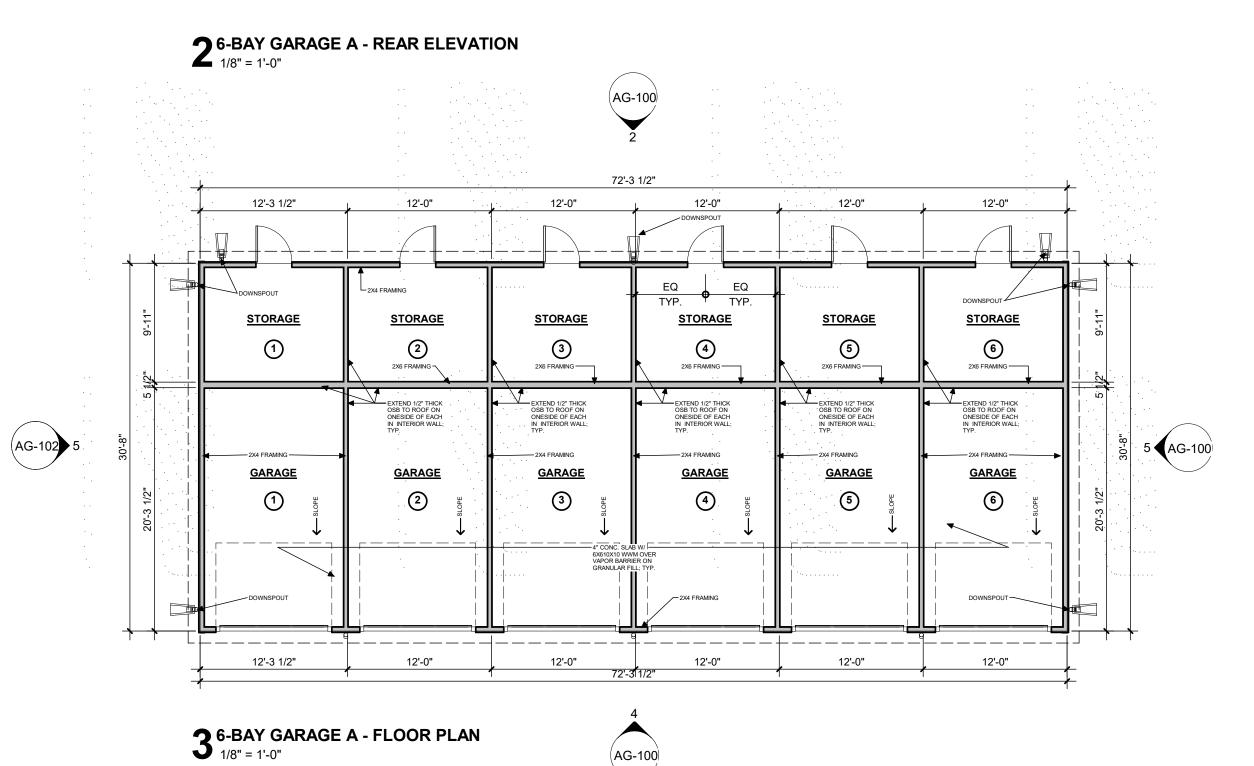




**4** 6-BAY GARAGE A - FRONT ELEVATION 1/8" = 1'-0"

# **EXTERIOR MATERIALS:**

VINYL SIDING: 100%

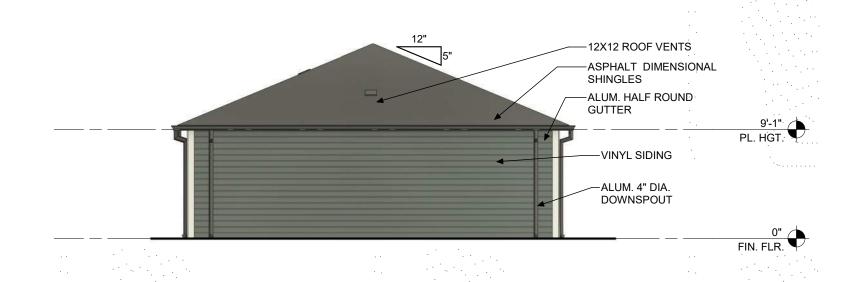

**5** 6-BAY GARAGE A - SIDE ELEVATION 1/8" = 1'-0"



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22-004

SHEET TITLE

TYPE A - 6-BAY, 6 STORAGE GARAGE

SHEET NUMBER

AG-100

12X12 ROOF VENTS

12X12 ROOF VENTS


57/12\*

ASPHALT
DIMENSIONAL
SHINGLES

**5** ACCESSIBLE 6-BAY TYPE B, 6 STORAGE GARAGE ROOF PLAN 1/8" = 1'-0"



**4** ACCESSIBLE 6-BAY TYPE B, 6 STORAGE GARAGE REAR ELEVATION 1/8" = 1'-0"

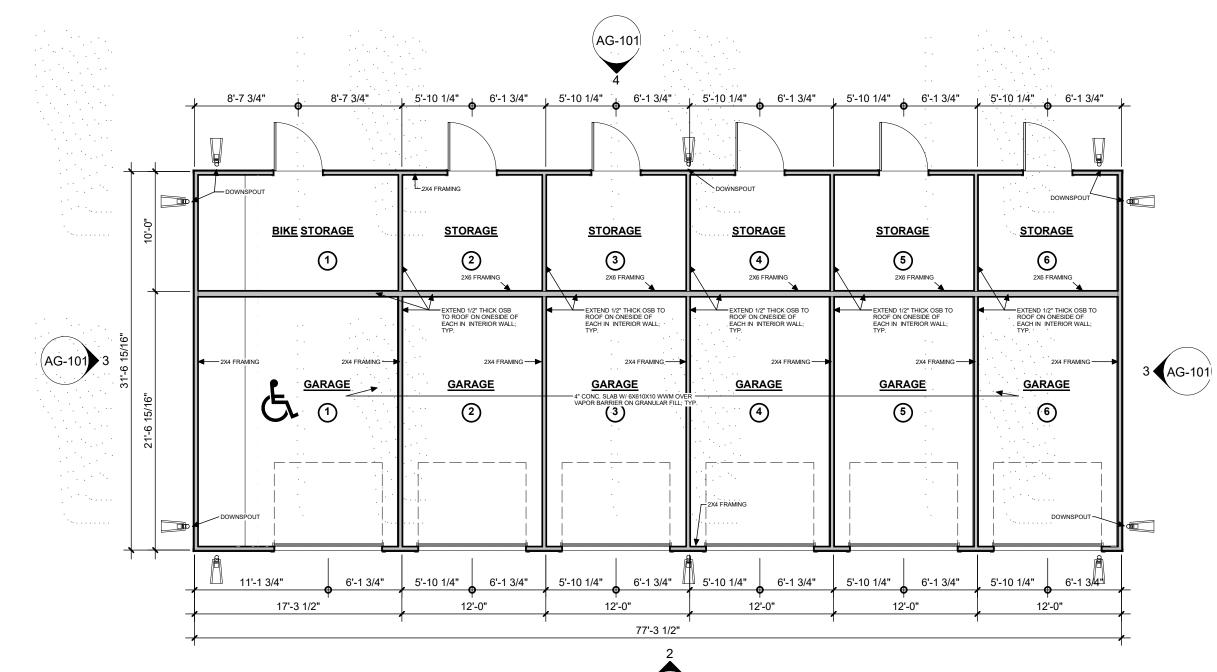

ACCESSIBLE 6-BAY TYPE B, 6 STORAGE GARAGE PLAN
1/8" = 1'-0"




(AG-101)

2 ACCESSIBLE 6-BAY TYPE B, 6 STORAGE GARAGE FRONT ELEVATION

1/8" = 1'-0"

# **EXTERIOR MATERIALS:**

VINYL SIDING: 100%

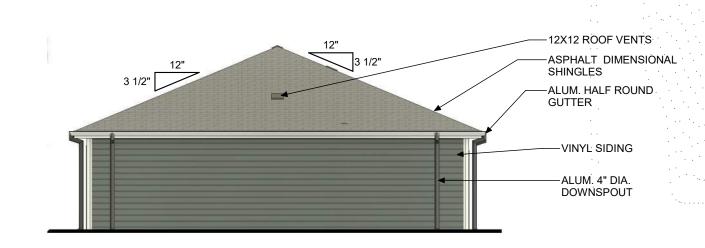

3 ACCESSIBLE 6-BAY TYPE B, 6 STORAGE GARAGE SIDE ELEVATION



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PROJECT TITLE

# SANTA FE ROAD

ISSUED FOR: DATE

REVISIONS

MARK DESCRIPTION DAT

DO NOT SCALE PRINTS - USE FIGURED DIMENSIONS ONLY


22-004

SHEET TITLE

TYPE B- ACCESSIBLE 6-BAY, 6 STORAGE GARAGE

SHEET NUMBER

AG-101

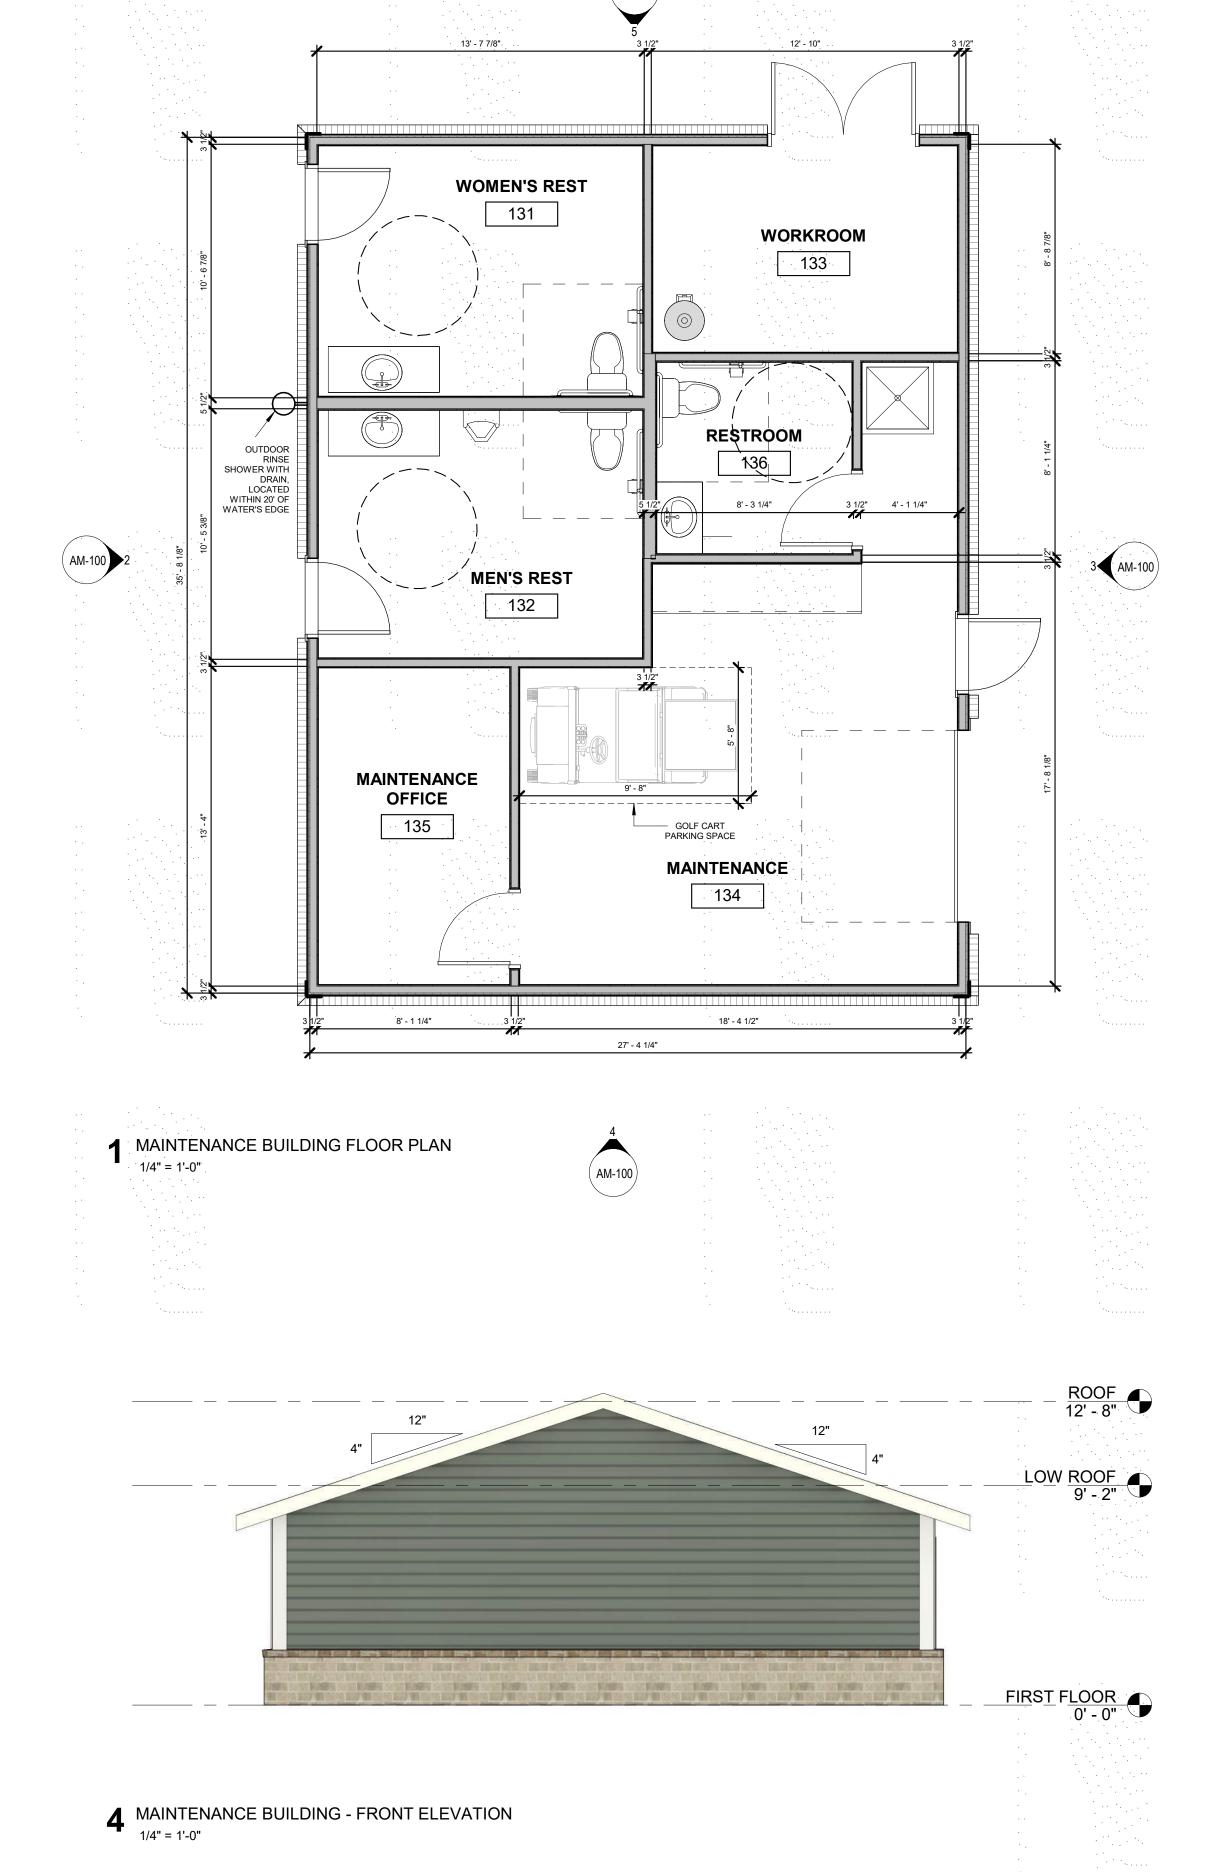

# **BUILDING EXTERIOR MATERIAL** PERCENTAGE BREAKDOWN:

BRICK VENEER = 30% VINYL SIDING = 70%



2 MAINTENANCE BUILDING - LEFT SIDE ELEVATION
1/4" = 1'-0"



**3** MAINTENANCE BUILDING - RIGHT SIDE ELEVATION 1/4" = 1'-0"



**5** MAINTENANCE BUILDING - REAR ELEVATION 1/4" = 1'-0"



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SEAL

PROJECT TITLE

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ISSUED FO	OR:	DATE
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REVISIONS DESCRIPTION

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22-004


SHEET TITLE

MAINTENANCE BLDG FLOOR PLAN AND **ELEVATIONS** 

SHEET NUMBER

AM-100



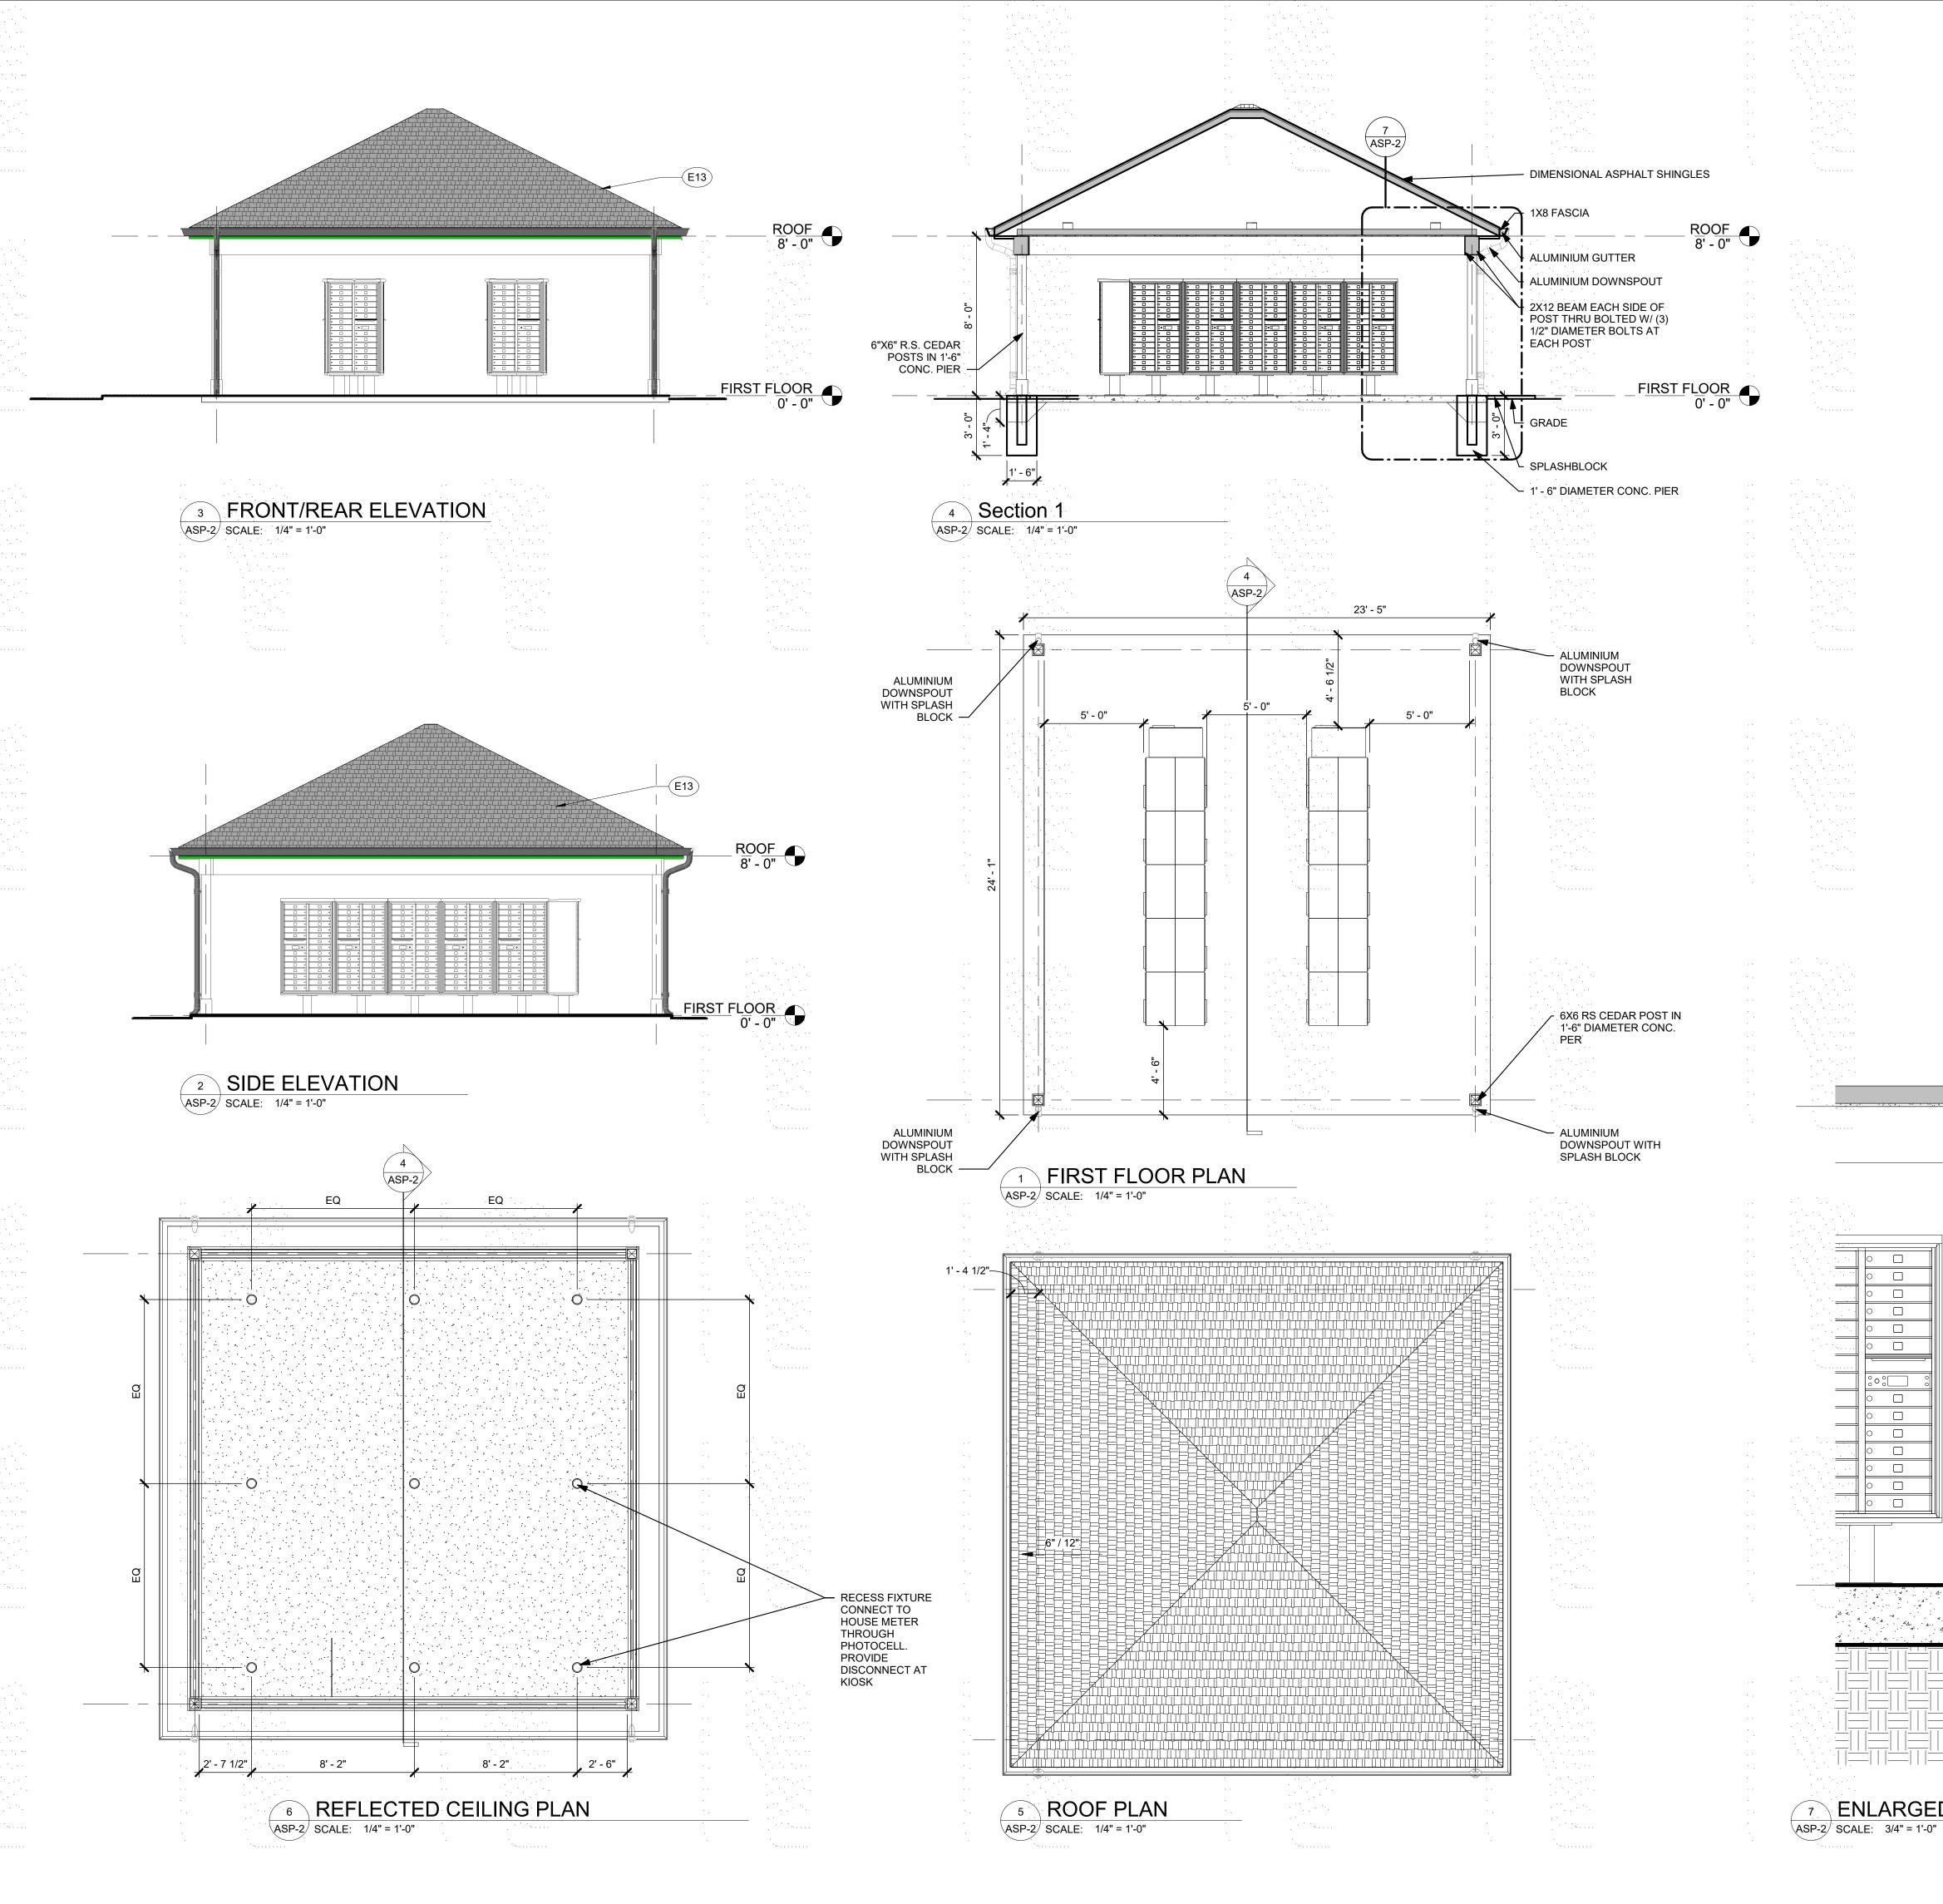

**ELEVATION KEYNOTES** 

[6"] ALUMINUM GUTTER

DIMENSIONAL ASPHALT SHINGLE ROOF - 30 YEAR WARRANTY

MAIL AND PARCEL BOXES:

CLUSTER PEDESTAL MAILBOX WITH 8 MAILBOXES AND 2 PARCEL

- CLASS A FIBERGLASS SHINGLES ON 5LB. FELT

TOTAL REQUIRED: 252 MAILBOXES AND 51 PARCEL BOXES

PROVIDED:

16 CLUSTER BOXES = 252 MAILBOXES 16 CLUSTER BOXES WITH 2 PARCEL BOXES EACH + 6 PARCEL BOXES WITH 4 PARCEL BOXES EACH = 58 PARCEL BOXES

310 East 96th Street, Suite 400 Indianapolis, IN 46240 (317) 846-3111 www.kittleproperties.com

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22-004


DRAWINGS

SHEET TITLE

MAIL KIOSK

SHEET NUMBER

ASP-2

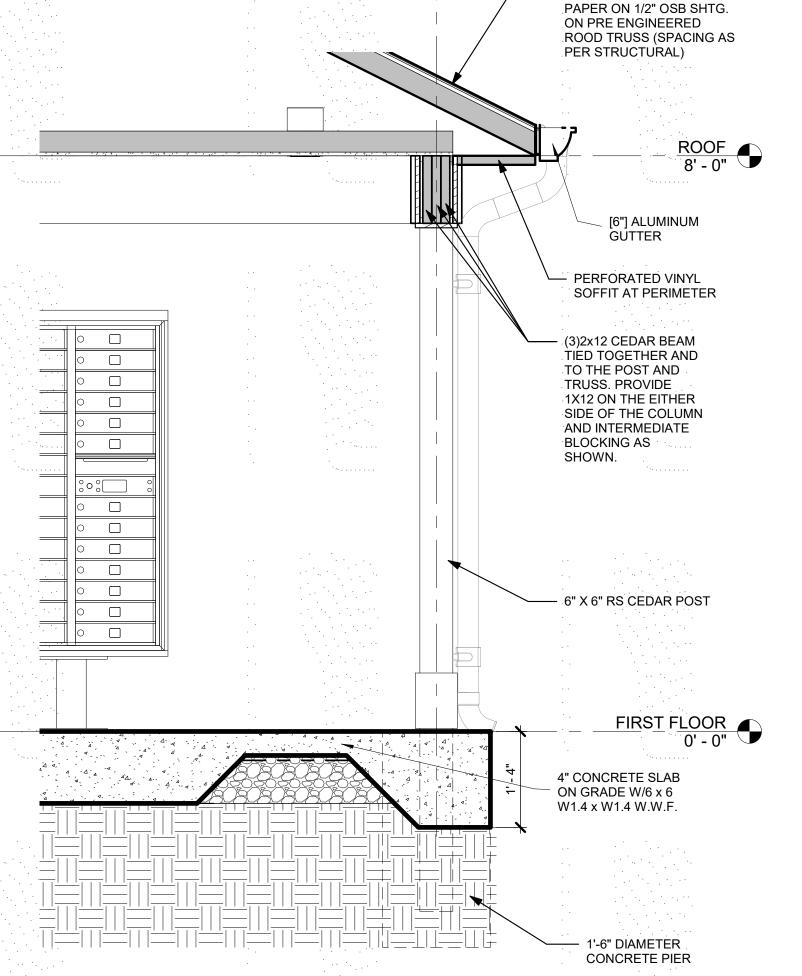


**ENLARGED DETAIL** 

# NOTE:


- COORDINATE ENTRANCE SIDE OF DUMPSTER ENCLOSURE WITH ARCHITECTURAL AND CIVIL SITE PLAN(S).
- COORDINATE GATE DETAILS AND FIXED FENCING WITH ARCHITECTURAL AND CIVIL SITE PLAN(S).

ASP 3




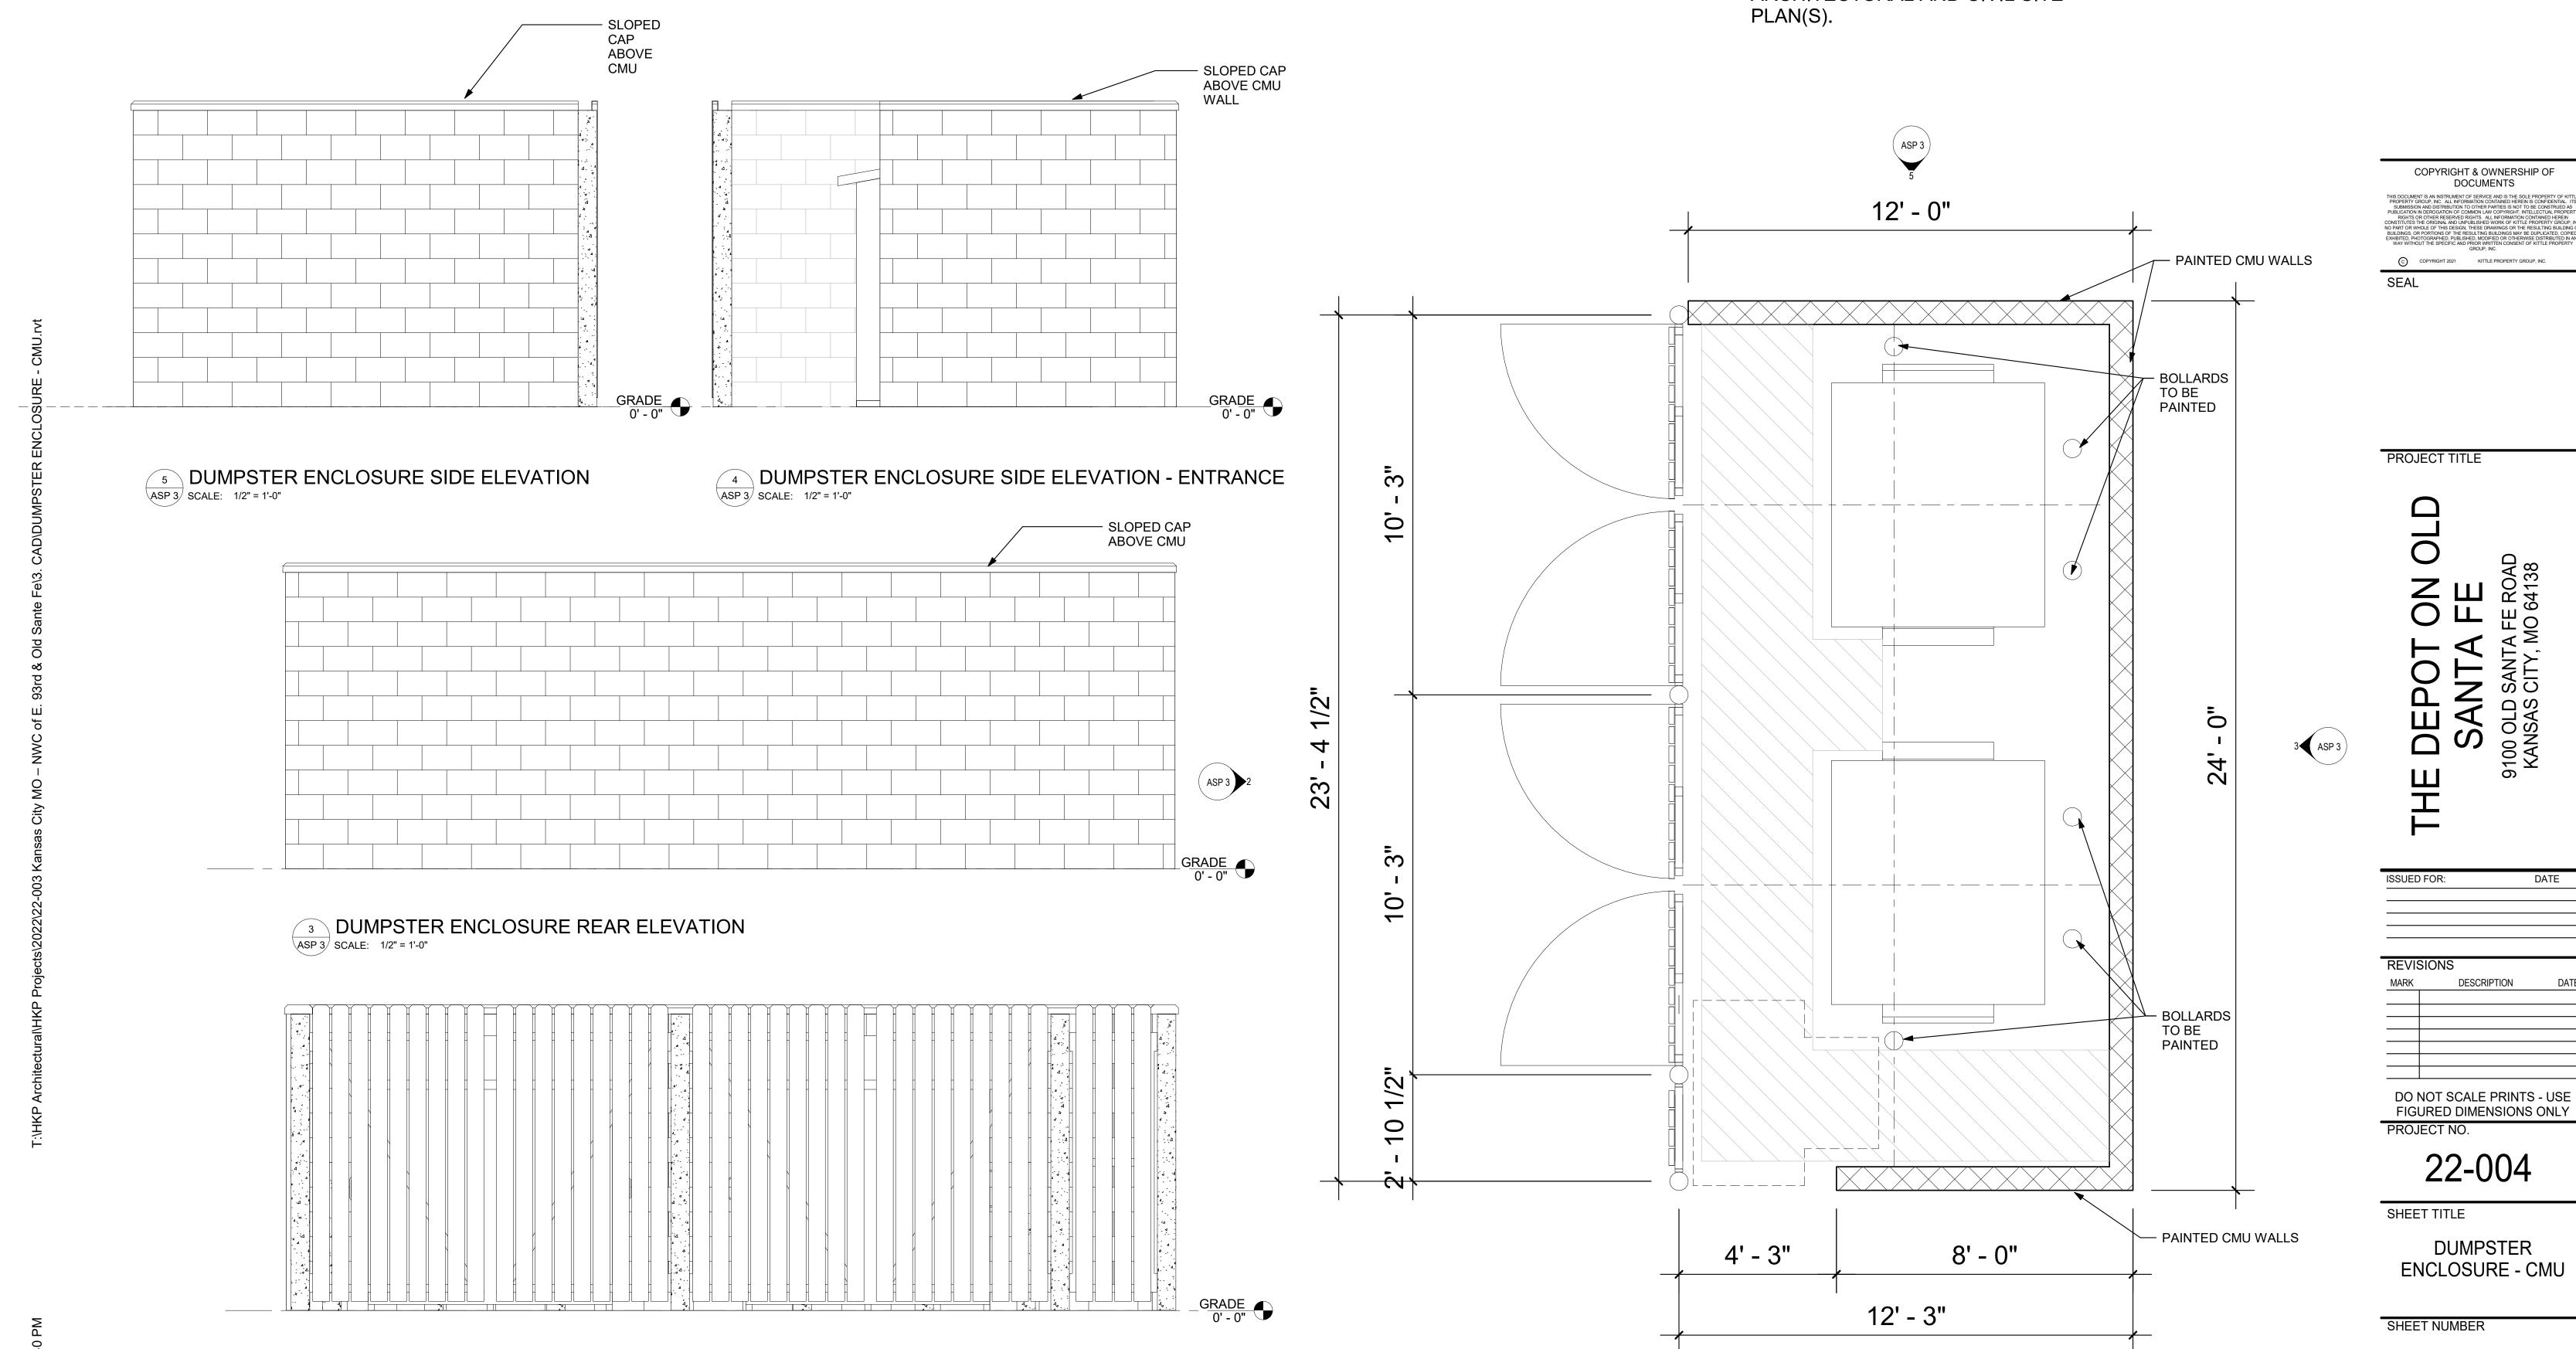


ASP 3

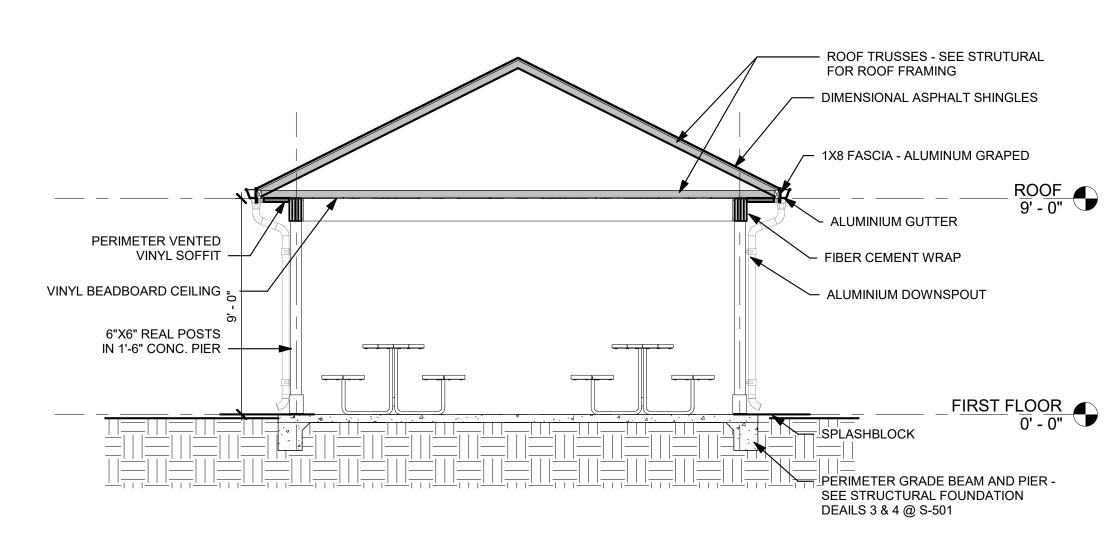

4 SECTION ASP 5 SCALE: 1/4" = 1'-0"

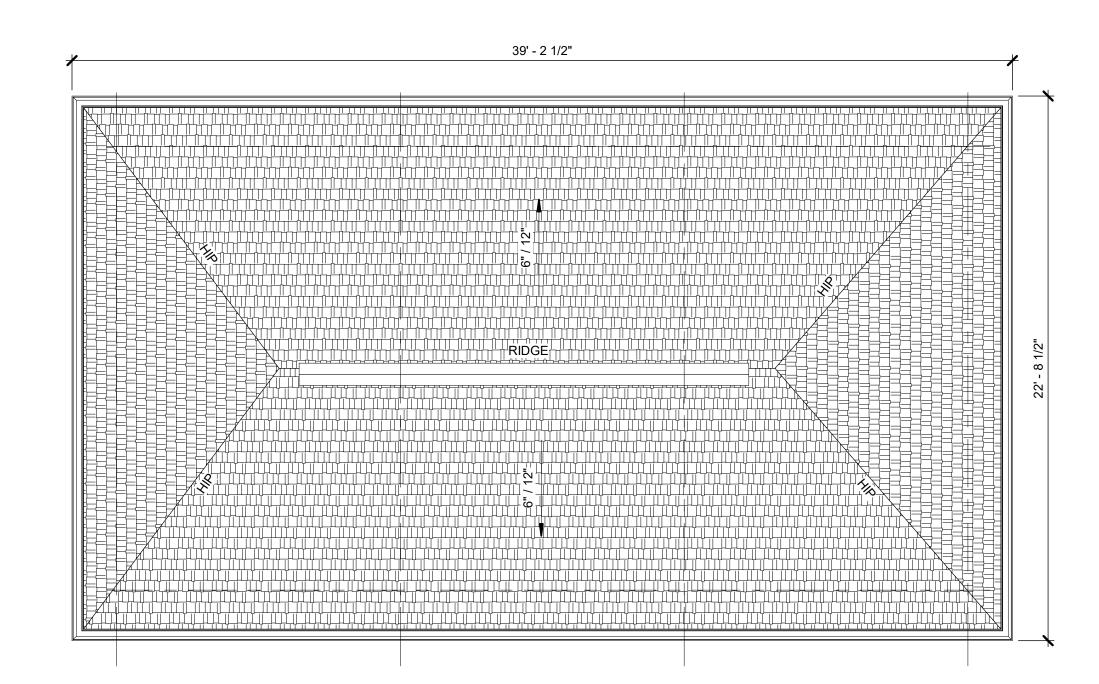

2 ROOF PLAN
ASP 5 SCALE: 1/4" = 1'-0"

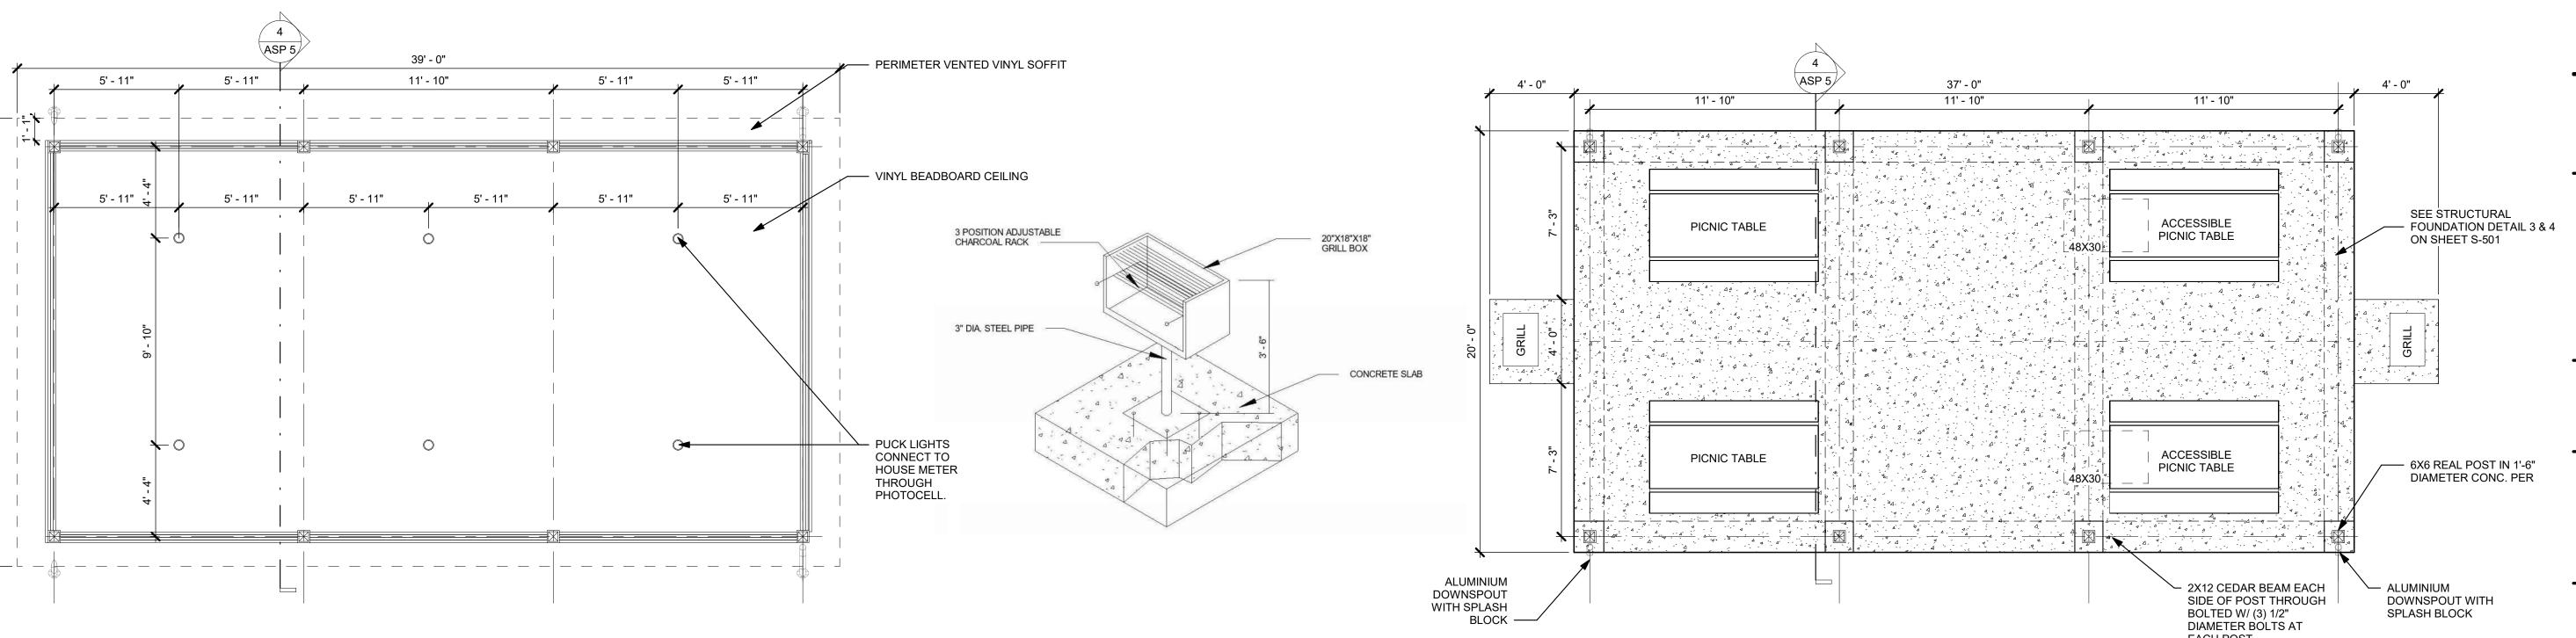

ENTERTAINMENT AREA - FLOOR PLAN ASP 5 SCALE: 1/4" = 1'-0"

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SHEET TITLE

**ENTERTAINMENT** PAVILION PLAN AND **DETAILS** 

SHEET NUMBER

**EACH POST** 

ASP 5

# **Public Meeting Notice**

Kittle Proper	ty Group	
for a meeting about	Depot on Old Santa Fe Rezone	
case number CD-CPC-2	2022-00161	
proposed for the following	address: 9100 Old Santa Fe	
	Kansas City, MO	

Meeting Date:

Wednesday, September 14, 2022

Meeting Time:

6:00 PM

Meeting Location:

KCMO Police Department South Community Room

9701 Marion Park Drive

Project Description:

Multi-family development with community building, pool, garages, playground, green space and more

If you have any questions, please contact:

Name: Brenda Haddad

Phone: 417-529-8929

Email: bhaddad@kittleproperties.com

You are receiving this notice in accordance with city code that requires a public meeting with neighborhoods for certain types of development projects. You can read more about the process requirements at kcmo.gov/publicengagement



Brende Haddael

If you would like further information on this proposed project, please visit the city's planning and permitting system, Compass KC, at Compasskc.kcmo.org. You may search by project type and address/case number to find project details.

Sincerely,

# Meeting Sign-In Sheet

Project Name and Address

The Depot on Old Santa Fe

# 93rd & Old Santa Fe, Kansas City

Name	Address	Phone	Email	
00-/	Sna 11 87th		Email Mike, 111413@gn	reil con
1/18eGraf	301W 87th	816-36 BITY		1.07
TILCC	11	16		
David Harve	9205 OLDSprott	1816-504 8651	and Agened	(23 DG
Mr. Mrs Jim Van Scax	Y205 Old Sprott, & FE Rd. 123 E Ruby Au Indap No 64	\$16-252-1828		
FRESA KDENS	44256187 1ERR	KBM0 64137	tereszedens@h,t	mail, 603