

LEGAL DESCRIPTION

LOT 1, CHEZIK ADDITION REPLAT, A SUBDIVISION IN KANSAS CITY, CLAY COUNTY, MISSOURI.

THE LANDS SURVEYED, SHOWN AND DESCRIBED HEREON ARE THE SAME LANDS AS DESCRIBED IN "SCHEDULE A" OF THE TITLE COMMITMENT PROVIDED BY FIRST AMERICAN TITLE INSURANCE COMPANY, COMMITMENT/ FILE NO: NCS-1110789-COL, BEARING AN EFFECTIVE DATE OF JANUARY 28, 2022, AT 8:00AM.

BENCH MARK

BM1: MAG NAIL LOCATED APPROXIMATELY 71 FEET EAST AND 66 FEET NORTH OF THE SOUTHWEST PROPERTY LINE CORNER. ELEVATION: 911.61' N: 39.166157 E: -94.577705

According to the Flood Insurance Rate Map of the Federal Emergency Management Agency, Panel Number 41 of 625, Community-Panel Number 29095C0041G, Revised January 20, 2017, portions of the subject property lay within Zone AE - Base Flood Elevations determined.

UTILITY CONTACTS

AT&T TELEPHONE COMPANY 816-275-2721 CENTURYLINK 1-800-283-4237 COMCAST 1-866-641-1625 CONSOLIDATED 1-800-283-4237 **EVERGY** 816-471-5275 GOOGLE FIBER 1-866-954-1572 KANSAS CITY. MO. PUBLIC WORKS DEPT. 816-513-9871 KANSAS CITY, MO. WATER SERVICES DEPT. 816-513-0209 KC FIBER/LINK CITY 816-564-9994 LEVEL 3 913-645-5032 1-800-720-2417 MAGELLAN MIDSTREAM PARTNERS 1-888-275-6636 NORTH KANSAS CITY SCHOOL DISTRICT 816-413-5075 913-422-6321 SOUTHERN STAR CENTRAL SPECTRUM 1-866-967-7611 SPIRE ENERGY 1-314-776-9517 SPRINT 913-488-8489 UNITE PRIVATE NETWORK 1-866-963-4237 UTILITY LOCATION MARKING 1-800-DIG-RITE VEOLIA ENERGY (TRIGEN) 816-889-4977 VERIZON COMMUNICATIONS, INC. 1-800-624-9675 816-591-0282

UTILITIES:


- 1. THE UNDERGROUND UTILITIES SHOWN HAVE BEEN LOCATED FROM OBSERVED FIELD SURVEY INFORMATION, PURSUANT TO SECTION 5 PARAGRAPH E (IV) OF THE ALTA/NSPS MINIMUM STANDARD DETAIL REQUIREMENTS. THE SURVEYOR MAKES NO GUARANTEE THAT THE UNDERGROUND UTILITIES, IF SHOWN, COMPRISE ALL SUCH UTILITIES IN THE AREA, IF ANY, EITHER IN SERVICE OR ABANDONED. THE SURVEYOR FURTHER DOES NOT WARRANTY THAT THE UNDERGROUND UTILITIES, IF SHOWN, ARE IN THE EXACT LOCATION INDICATED ALTHOUGH HE DOES CERTIFY THAT THEY ARE LOCATED AS ACCURATELY AS POSSIBLE FROM INFORMATION AVAILABLE. THE SURVEYOR HAS NOT PHYSICALLY LOCATED THE UNDERGROUND UTILITIES. THERE WERE NO PLANS AND/OR REPORTS PROVIDED BY THE CLIENT REGARDING UNDERGROUND UTILITY INFORMATION.
- 2. UNDERGROUND ELECTRICAL LINES, STORM SEWER LINES AND UNDERGROUND GAS VALVE VERIFIED BY THE FURNISHED GPRS FINDINGS MAP, DATED 02/09/2022.
- 3. LIST OF KANSAS CITY, MO UTILITY COMPANIES:

www.kcmo.gov/home/showpublisheddocument/7513/637753362513270000



1 - 800 - 344 - 7483

1 - 800 - (DIG-RITE)

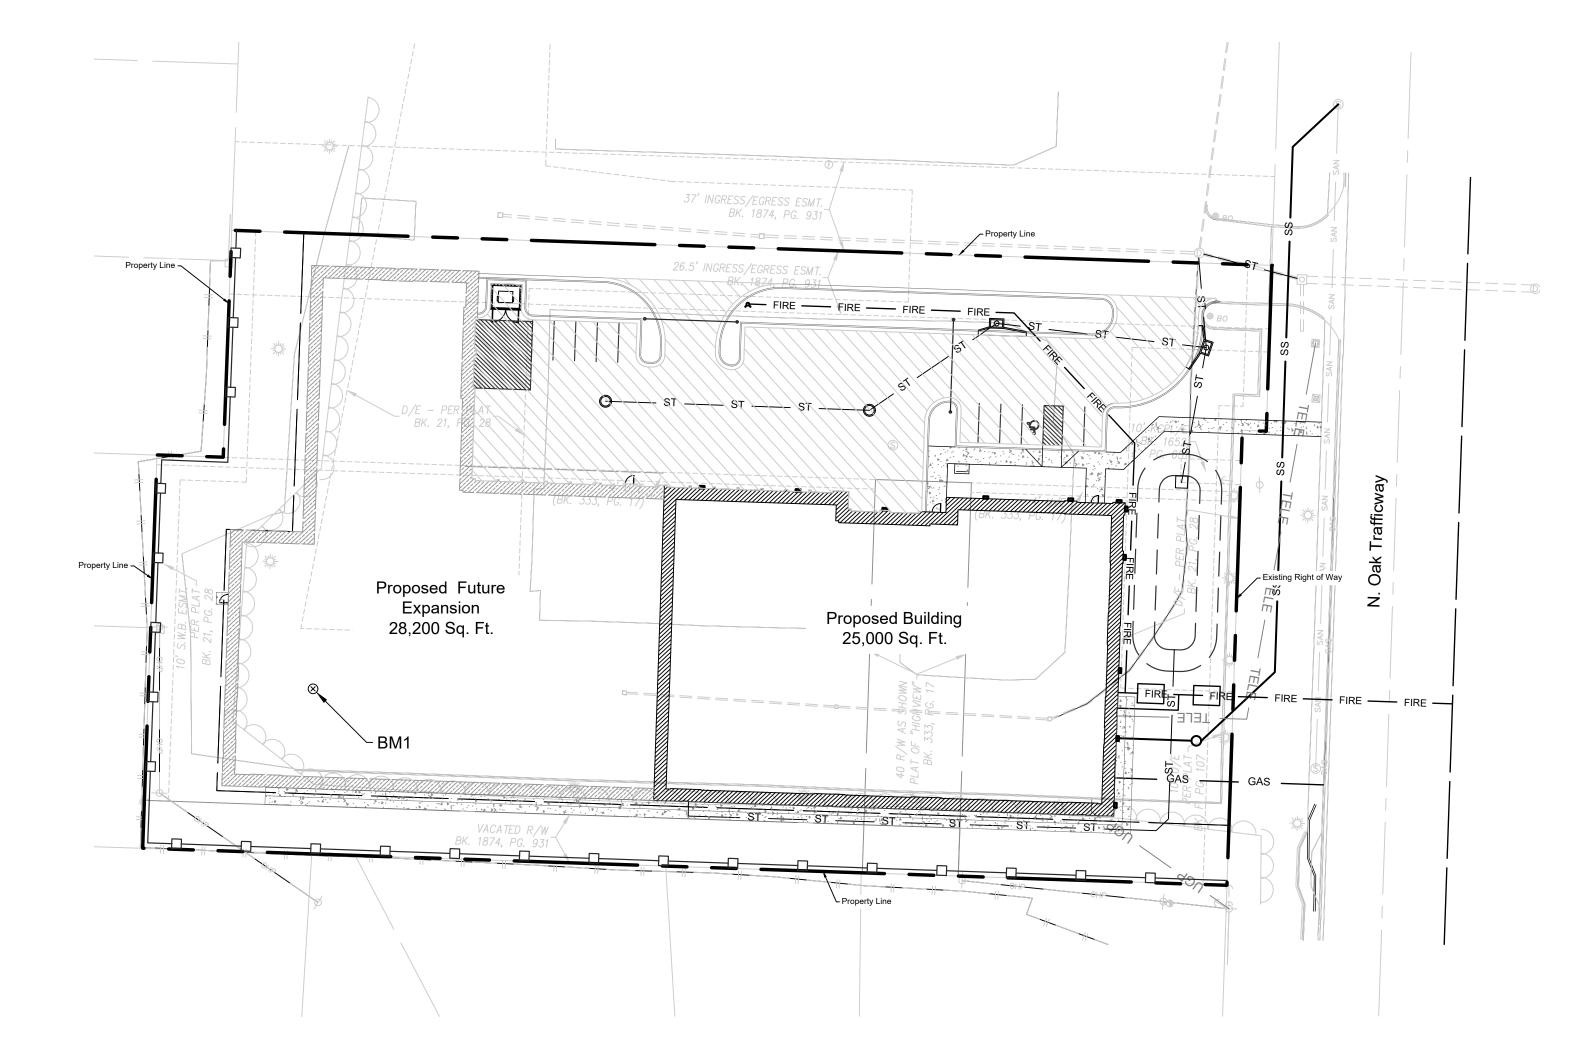

	<u>LEG</u>	<u>END</u>	
	Existing Section Line		Proposed Right-of-Way
	Existing Right-of-Way Line		Proposed Property Line
	Existing Lot Line		Proposed Lot Line
	Existing Easement Line		Proposed Easement
	Existing Curb & Gutter		Proposed Curb & Gutter
	Existing Sidewalk		Proposed Sidewalk
	Existing Storm Sewer		Proposed Storm Sewer
-	Existing Storm Structure		Proposed Storm Structure
	Existing Waterline	А	Proposed Fire Hydrant
ON	Existing Gas Main	WATER	Proposed Waterline
	Existing Sanitary Sewer		Proposed Sanitary Sewer
<u></u>	Existing Sanitary Manhole	S	Proposed Sanitary Manhole
<u> </u>	Existing Contour Major		Proposed Contour Major
	Existing Contour Minor		Proposed Contour Minor
			Future Curb and Gutter


	Sheet List Table
Sheet Number	Sheet Title
C01	Title Sheet
C02	Existing Conditions - Demoloition Pla
C03	General layout
C04	Dimension Plans
C05	Grading Plan
C06	Site Utility
C07	Fire Truck Turning Movement
L01	Landscape Plan
A-101	First Floor Building Plan
A-102	Second Floor Building Plan
A-201	Elevations
A-202	Elevations
A-203	Phase I North and East Elevations
PH	Electrical Photometrics


	<u>LEG</u>	END	
	Existing Section Line		Proposed Right-of-Way
	Existing Right-of-Way Line		Proposed Property Line
	Existing Lot Line		Proposed Lot Line
	Existing Easement Line		Proposed Easement
	Existing Curb & Gutter		Proposed Curb & Gutter
	Existing Sidewalk	\$0.544 P.000 P.005	Proposed Sidewalk
	Existing Storm Sewer		Proposed Storm Sewer
	Existing Storm Structure		Proposed Storm Structure
#Y #Y #Y #Y	Existing Waterline	A	Proposed Fire Hydrant
60 - 60 - 60 - 60 - 60 -	Existing Gas Main	—— WATER ———	Proposed Waterline
	Existing Sanitary Sewer		Proposed Sanitary Sewer
	Existing Sanitary Manhole	S	Proposed Sanitary Manhole
	Existing Contour Major		Proposed Contour Major
	Existing Contour Minor		Proposed Contour Minor
	J = = = = = = = = = = = = = = = = = = =		Future Curb and Gutter



Sheet C01


REVISION

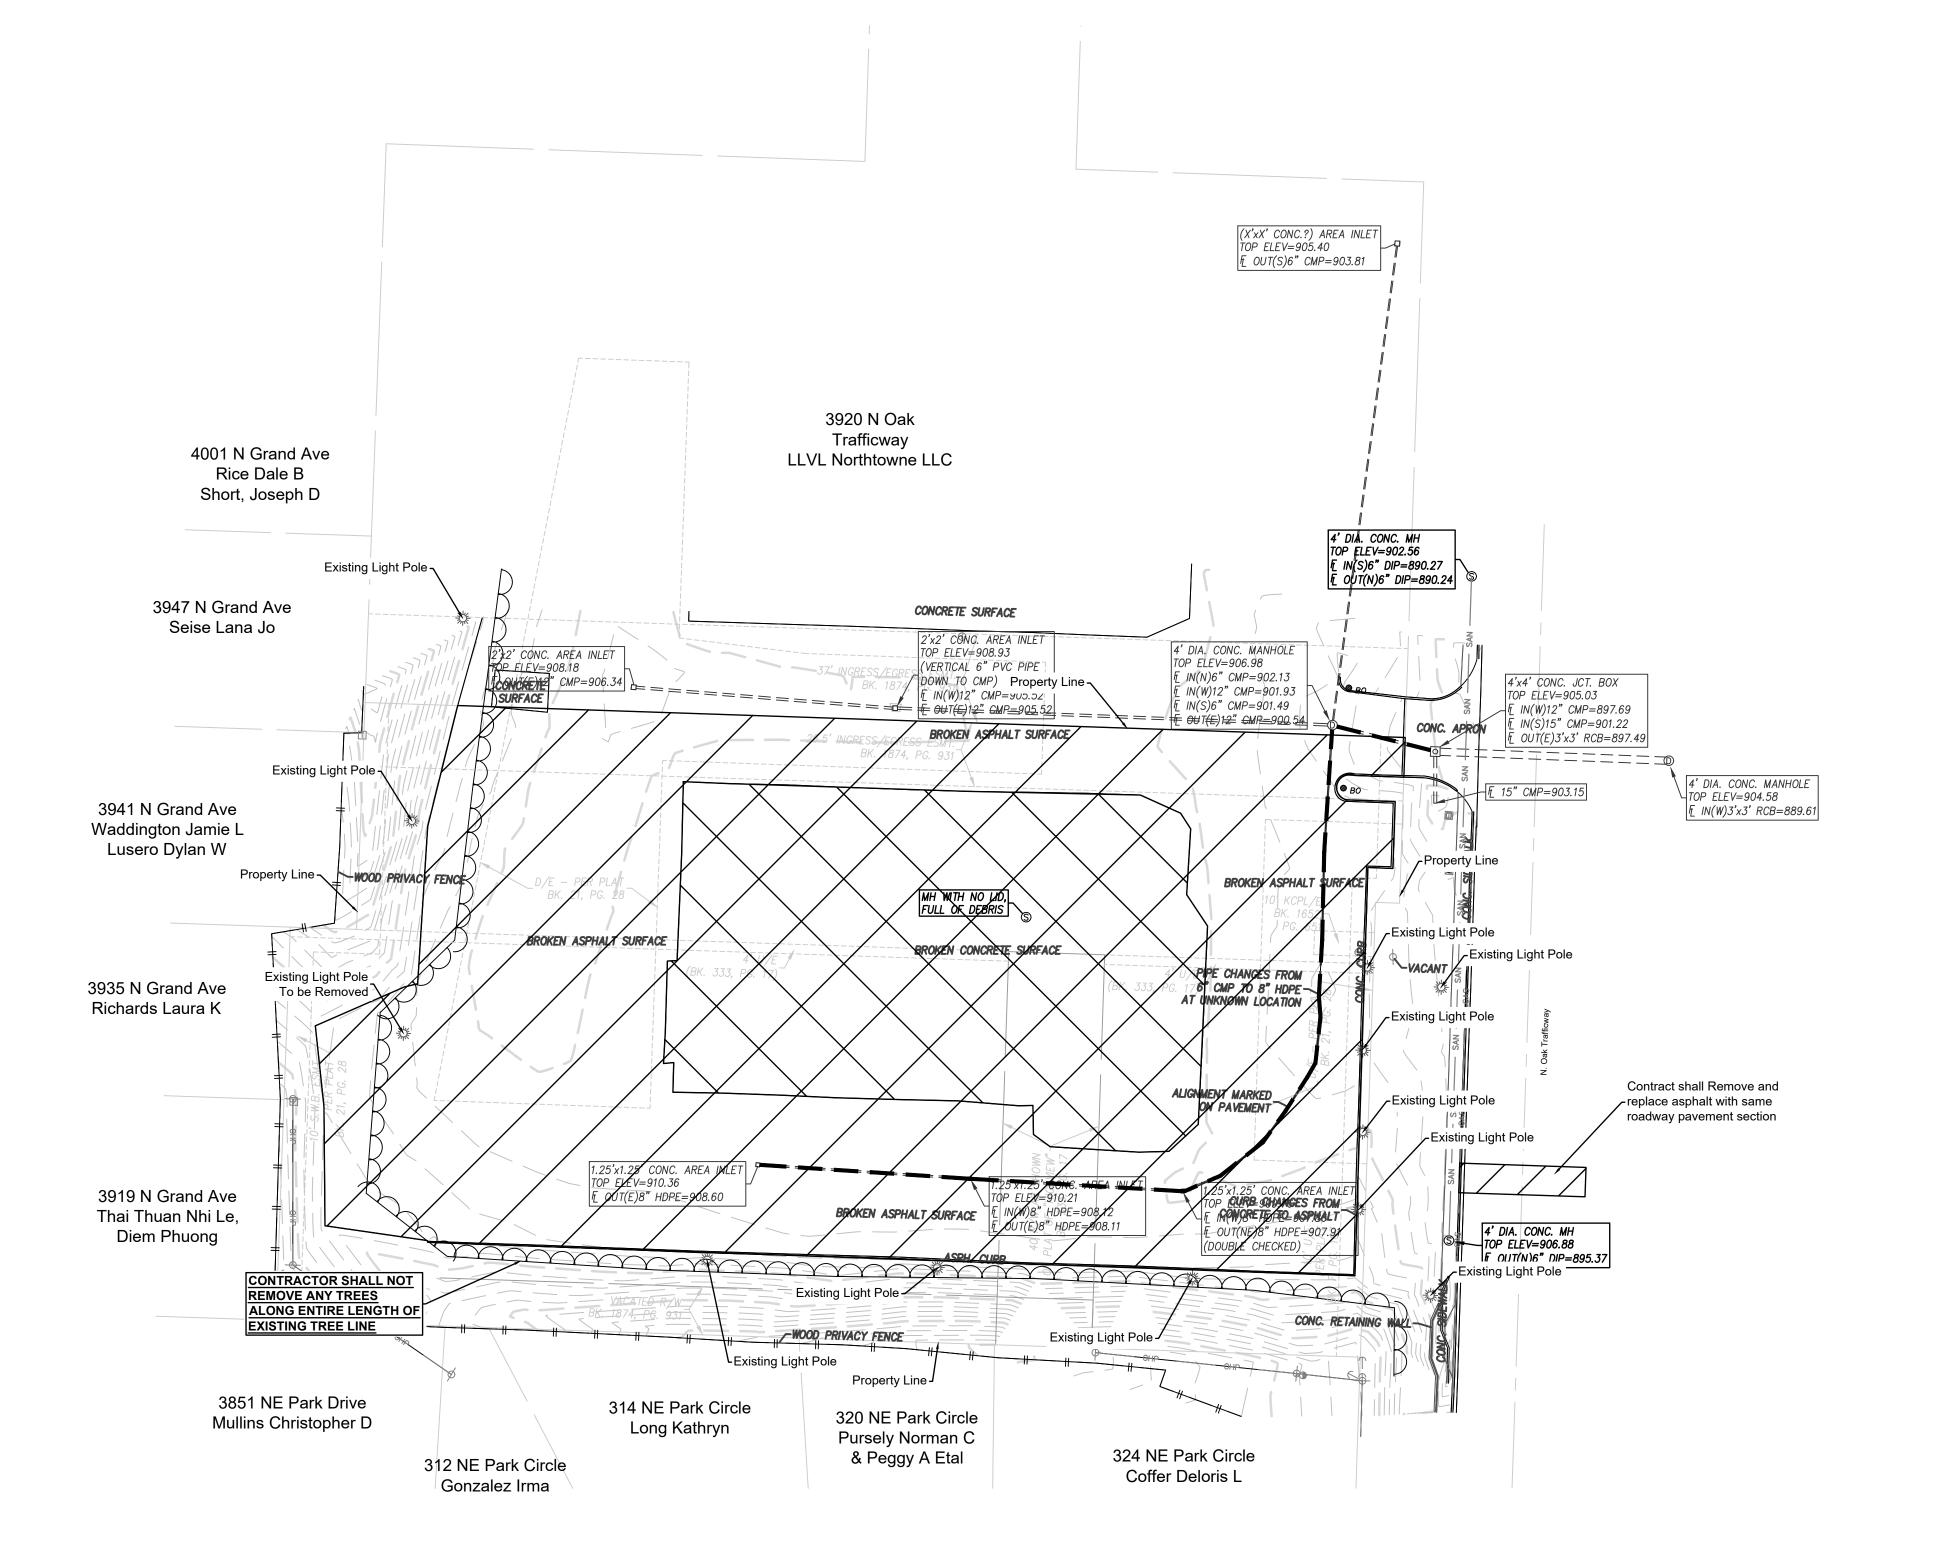

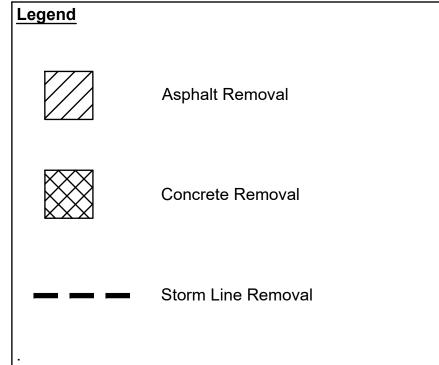

DEMOLITION NOTES:

- 1. Contractor shall be responsible for raising and removal of the existing structures, related utilities, paving, and any other existing improvements as noted.
- 2. Contractor is to remove and dispose of all debris, rubbish and other materials resulting from previous and current demolition operations. Disposal will be in accordance with all local, state and/or federal regulations governing such operations.
- 3. All demolition work shall be performed in accordance with the owner's site work specifications.
- Contractor is responsible for repairs of damage and adjustments due to conflicts or grading to any existing structures or underground utilities that are to remain in place.
- 5. All items designated to be demolished and removed from the site shall be disposed of in an appropriate location in accordance with state or local guidelines.
- 6. Public streets and sidewalks shall be kept clean and clear of trash and debris from demolition operations at all times.
- 7. The contractor shall be responsible for dust and erosion control during demolition operations.
- 8. The contractor shall coordinate with all applicable utility companies prior to removal or relocation of any utilities and to safely stop services and dismantle service lines prior to beginning demolition operations.
- 9. Contractor is to remove and re-use if applicable, but is not limited to sewer pipes, power poles and guy wires, water lines and meters, vegetation, asphalt, and other unsuitable debris or material shown or not shown within construction limits and where necessary to allow for construction activity, all material to be removed as unclassified excavation.
- 10. All cavities created by removal of existing facilities in the area of proposed construction shall be filled and compacted in accordance with the site work specifications to subgrade elevation.
- 11. The contractor shall exercise extreme caution when working in the vicinity of the existing overhead electrical power lines.
- 12. Existing utilities are shown as located and identified in the field by utility company representative. The owner and the engineer make no assurance of the actual location, depth, size or type of utility lines shown. The owner and the engineer makes no assurance that all of the existing utility lines on the site are shown.

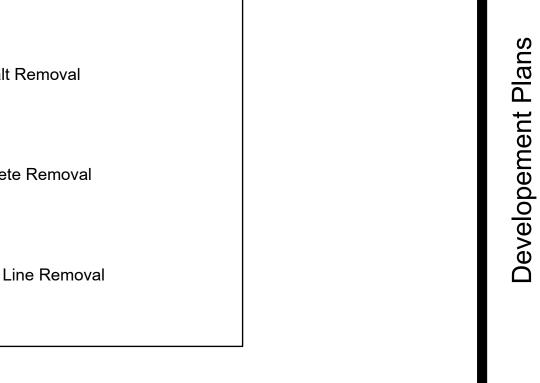



Renaissance
Infrastructur
Onsulting

AND E 17TH STRET
KANSAS CITY, MISSOURI 64108

WWW.RIC-CONSULT.0

Original Submitta

REVISION


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22-0140 rafficway Clay Cou

Existing Conditions Demoloition Plan

Sheet C02

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Sheet C03

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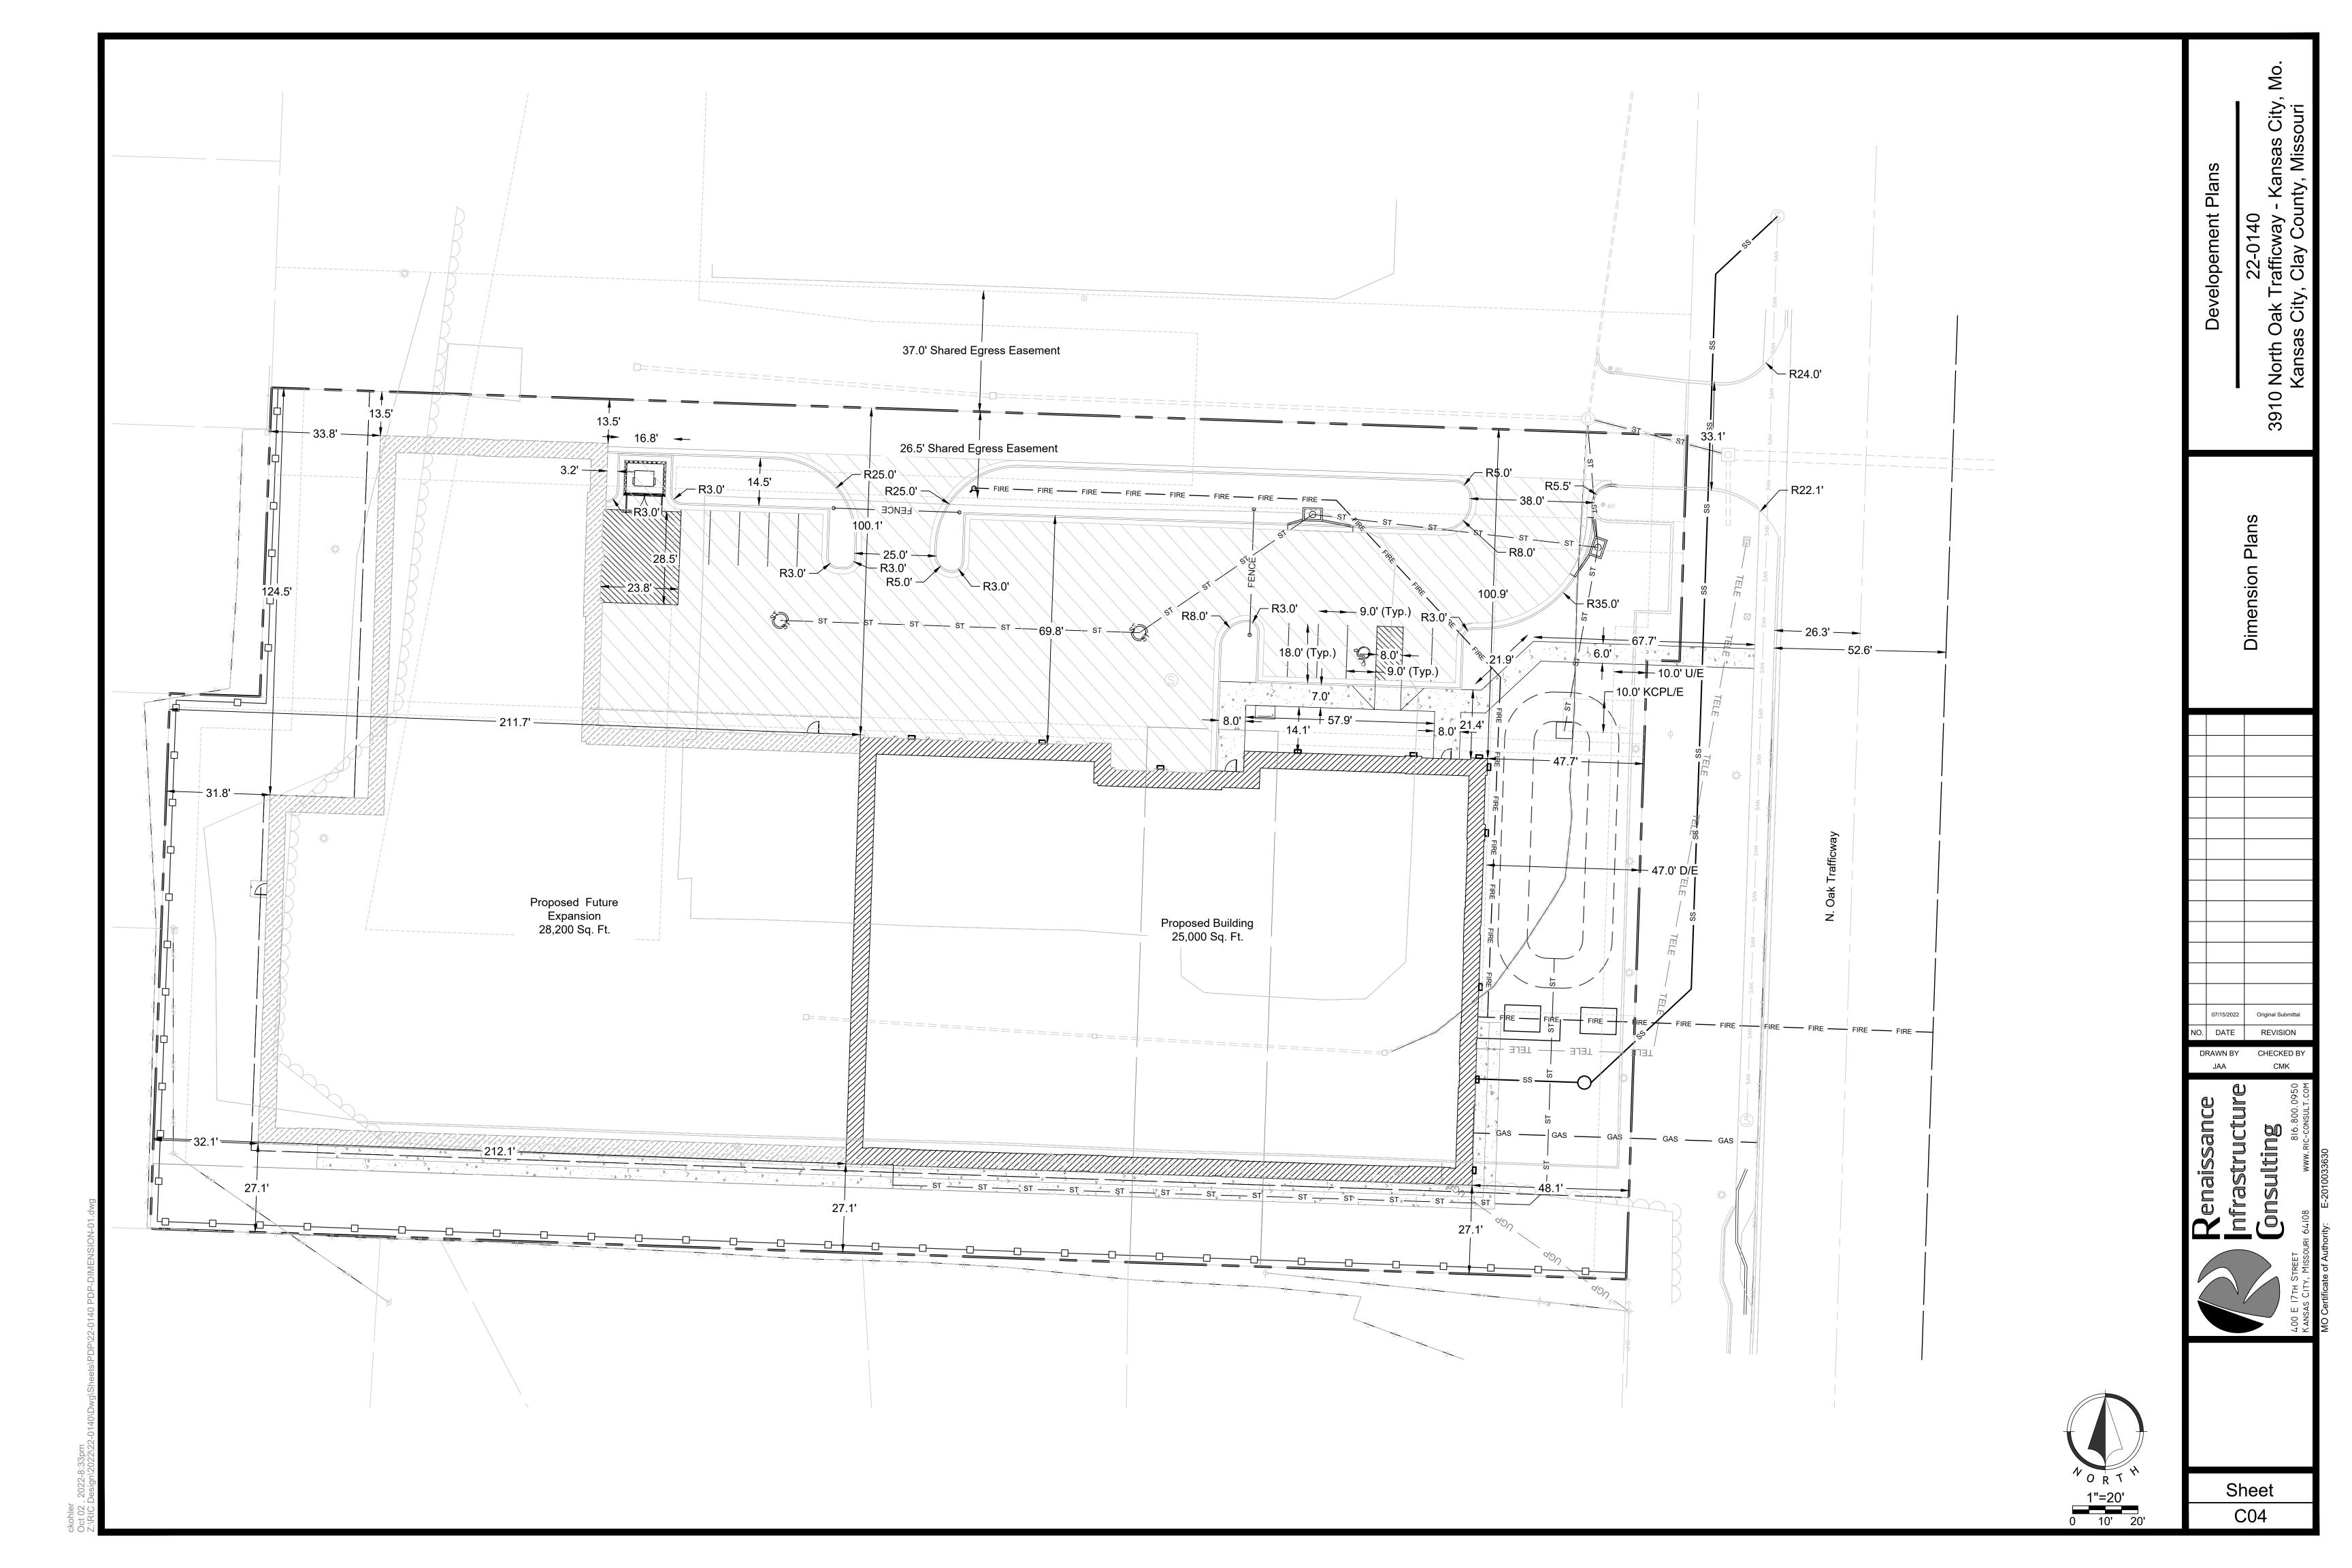
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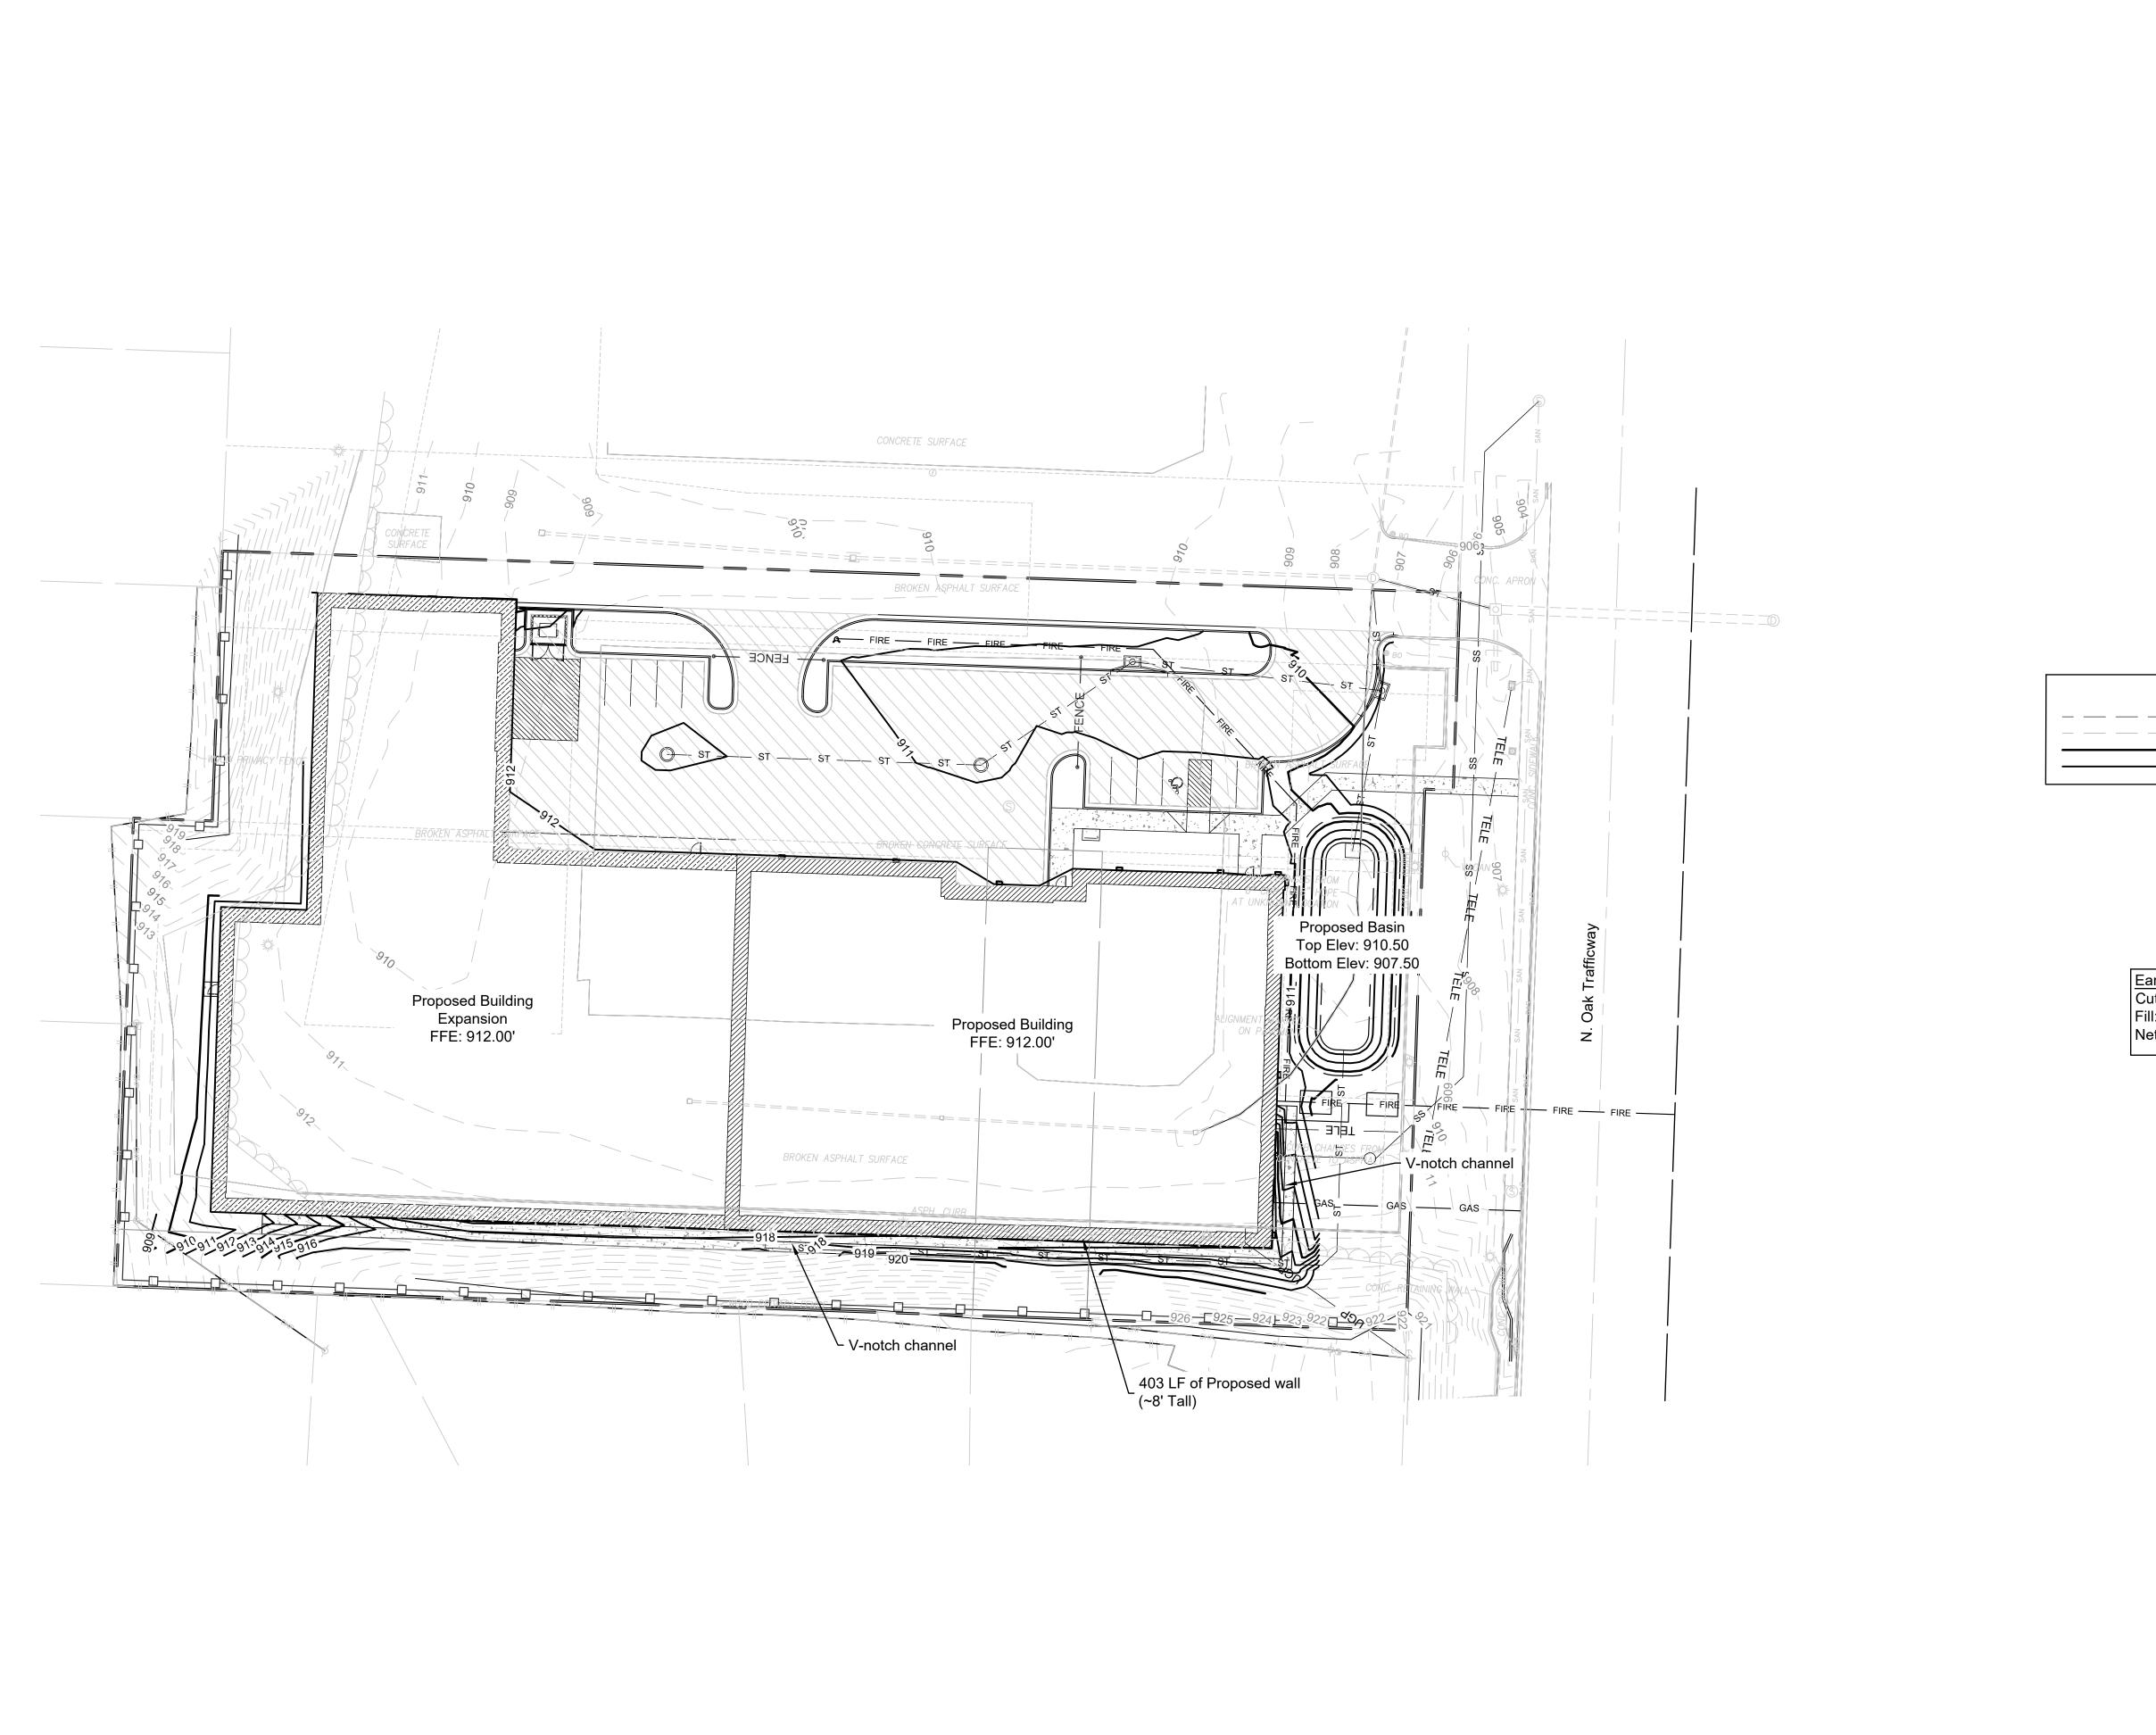
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DATE

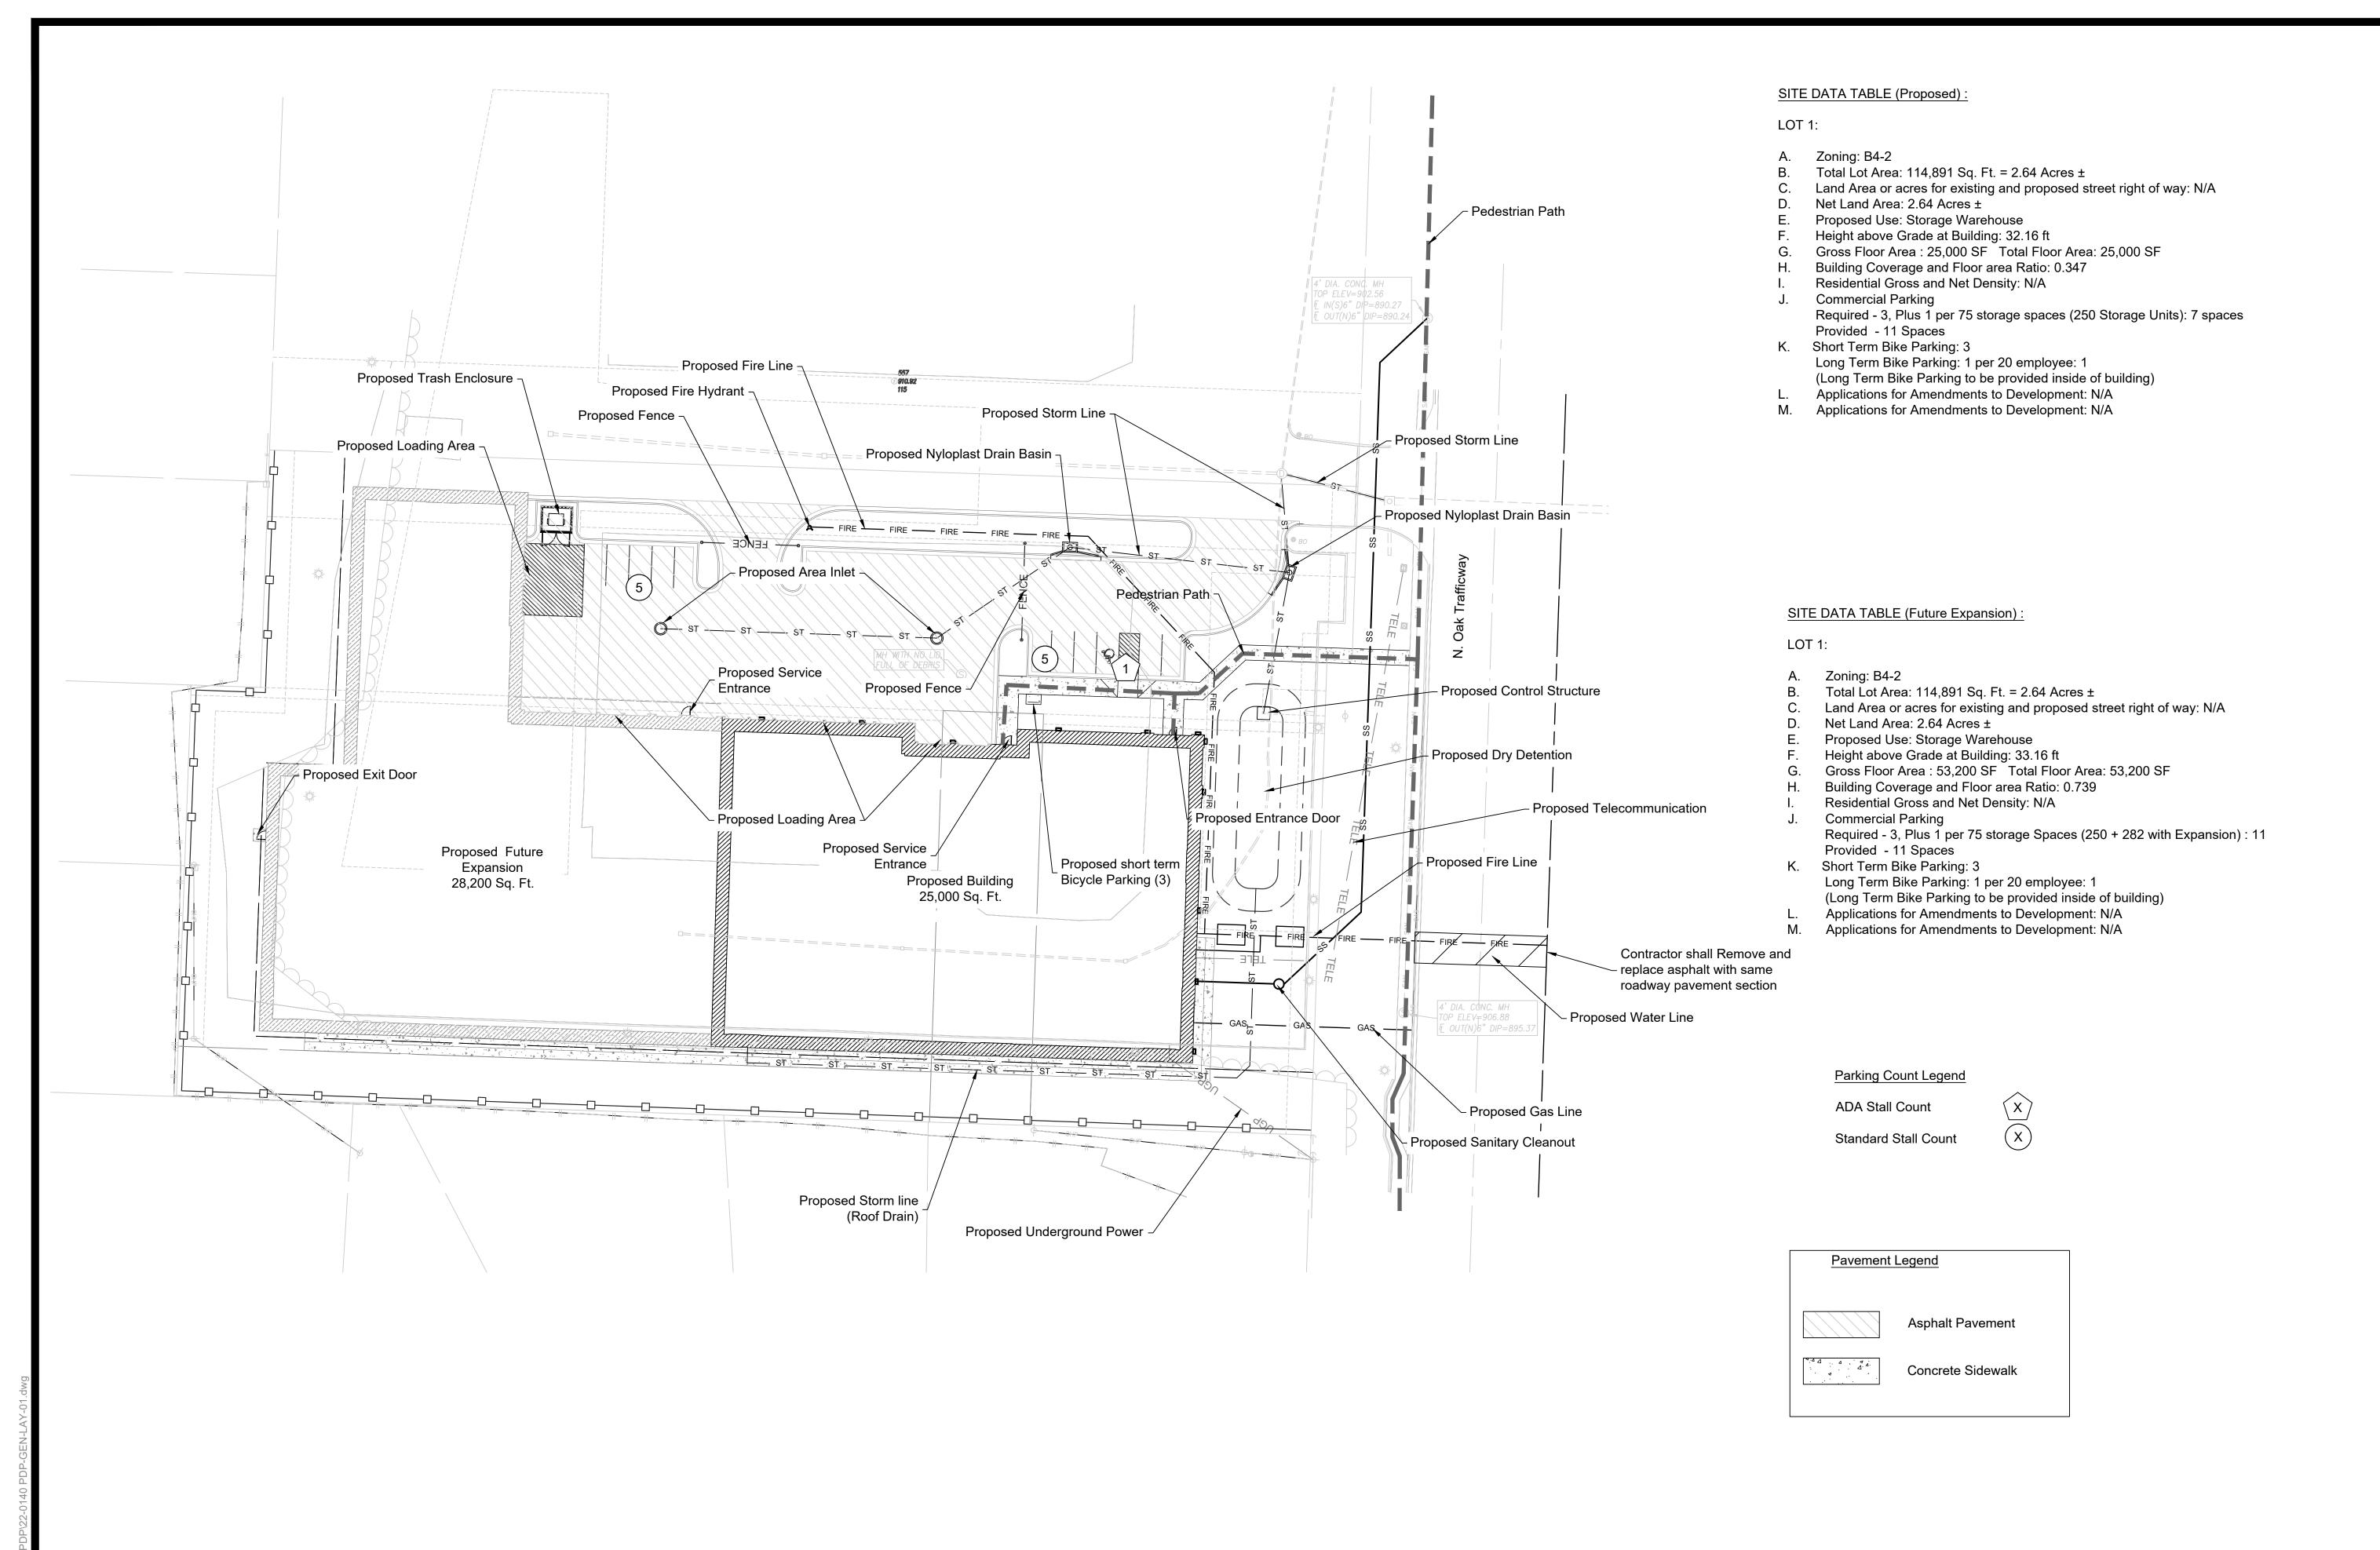Renaissance Infrastructure Consulting

Developement





Existing Major Contour
Existing Minor Contour
Proposed Major Contour
Proposed Minor Contour

Earthwork Calculations
Cut: 1003.18 CY
Fill: 3264.87 CY
Net (Fill): 2261.70 CY



O. DATE REVISION

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JAA

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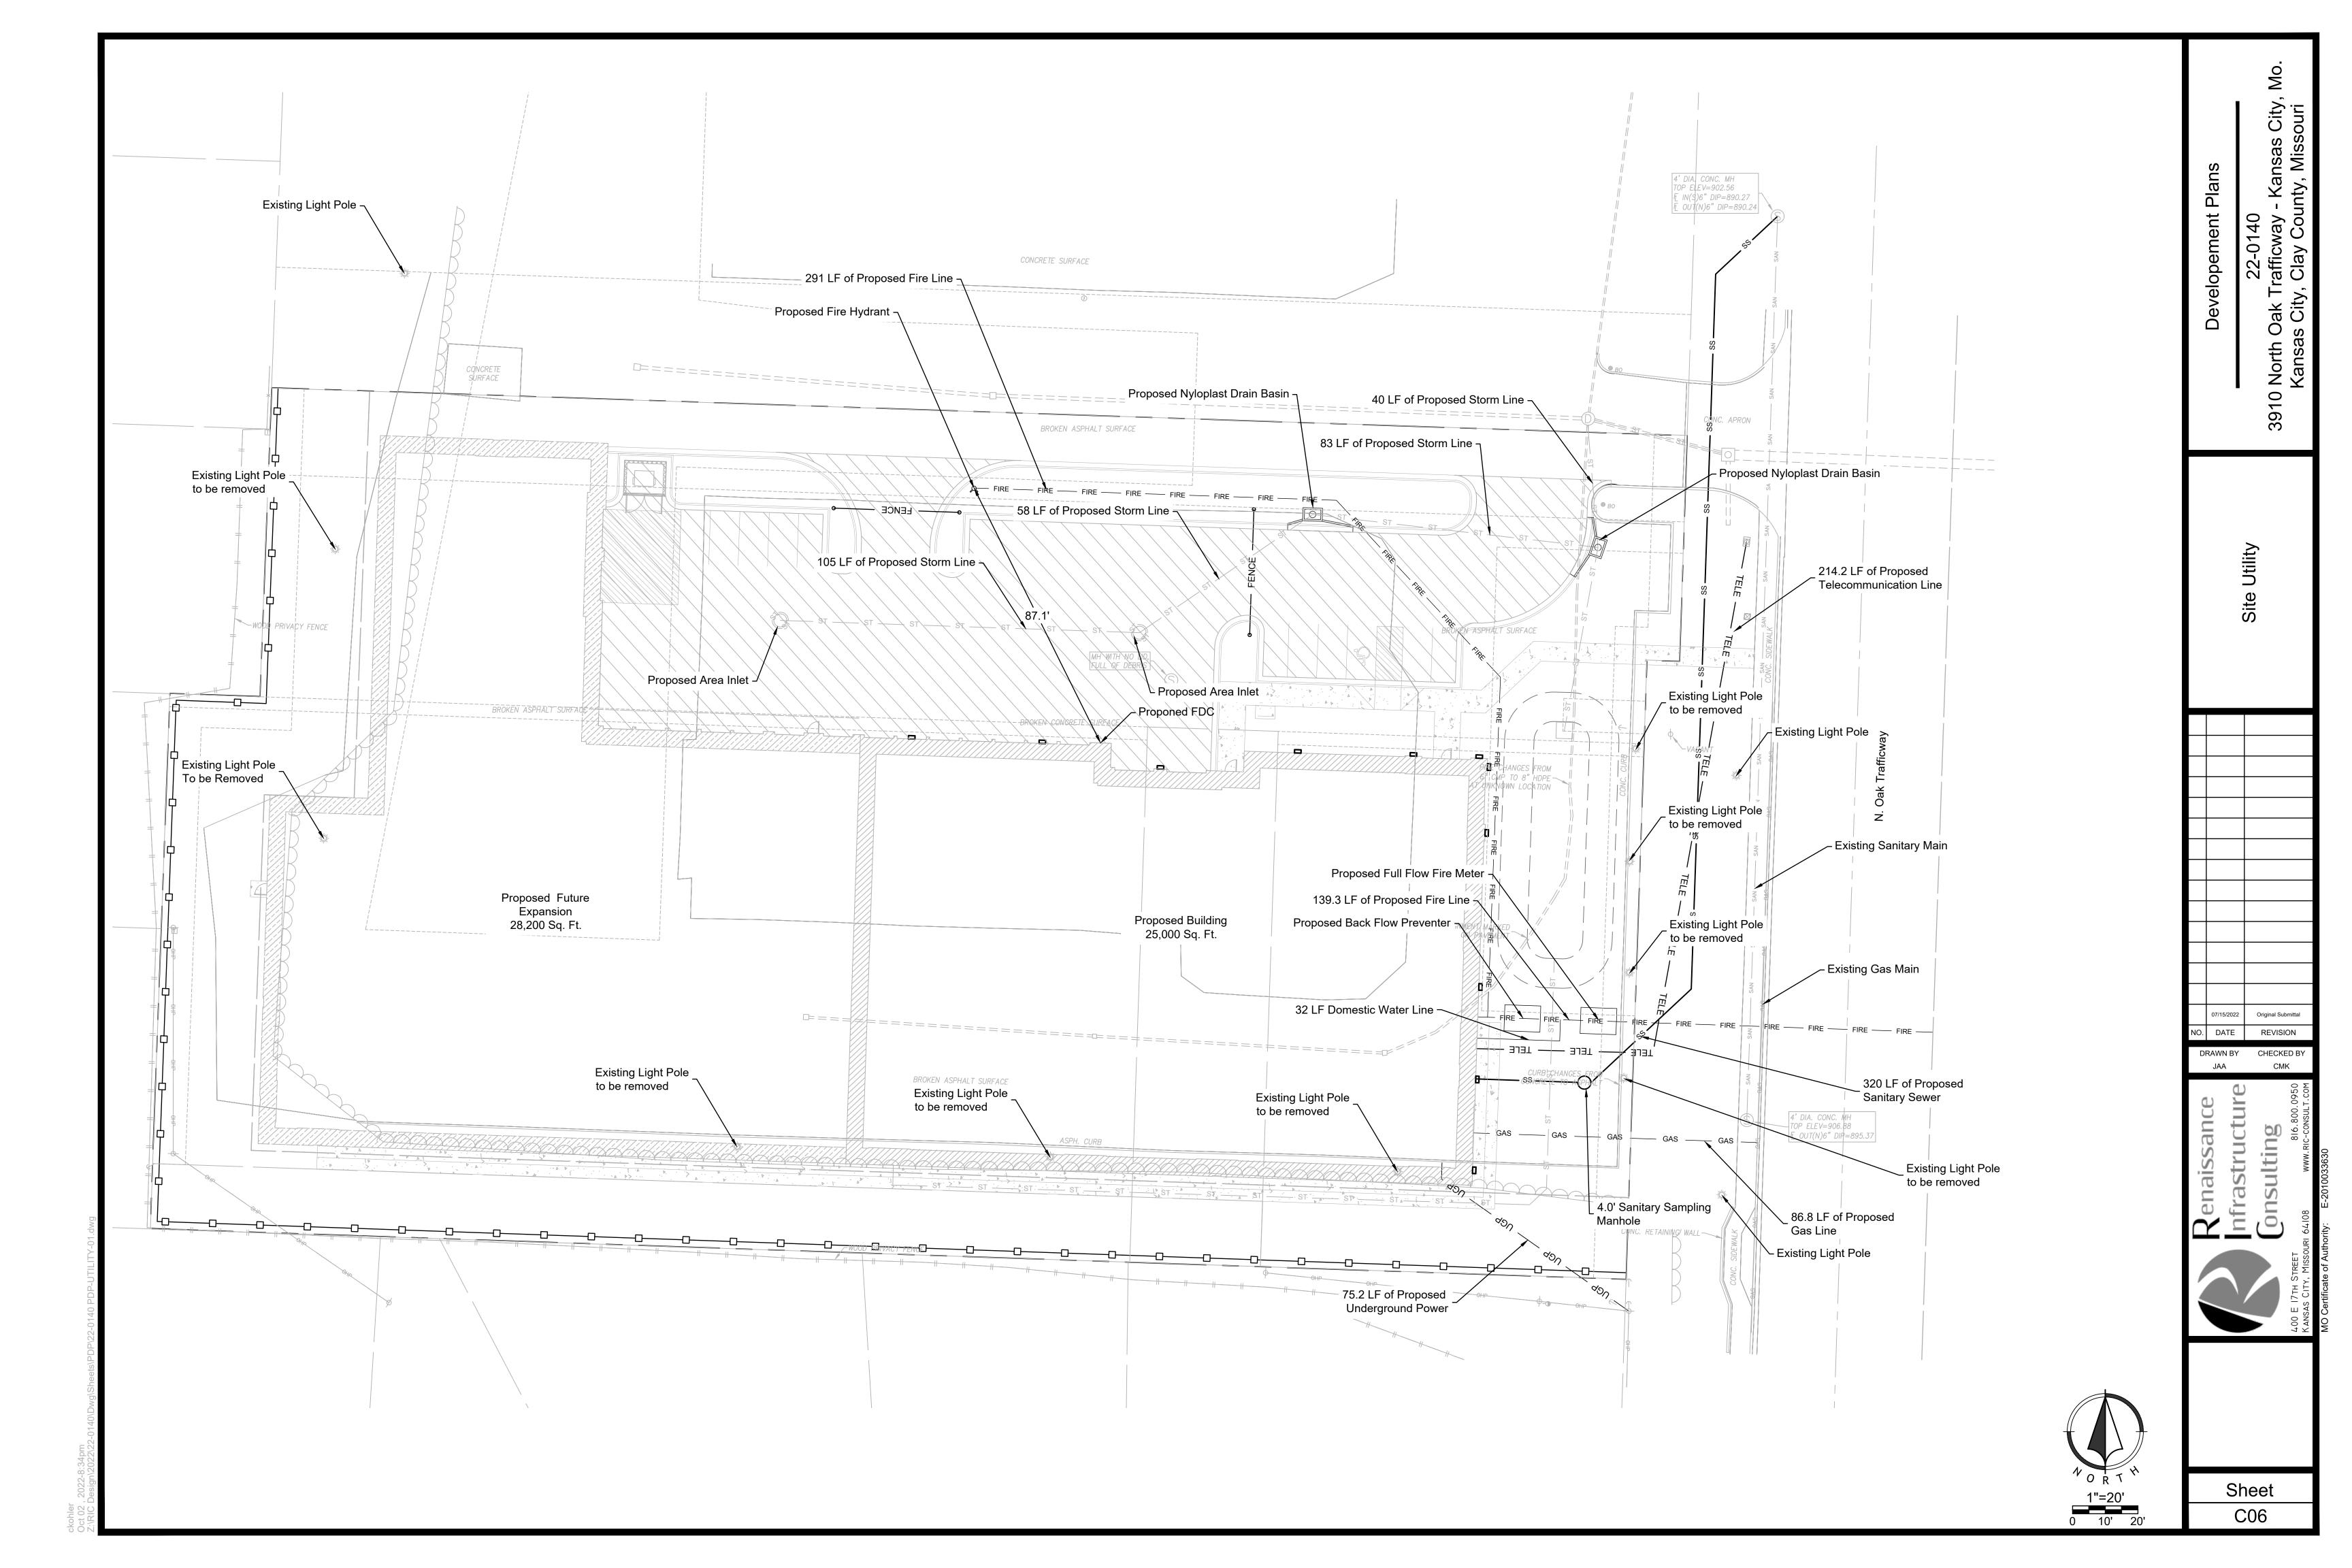
Developement Plans


22-0140 Trafficway -:y, Clay Cou


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Grading Plan

Sheet C05





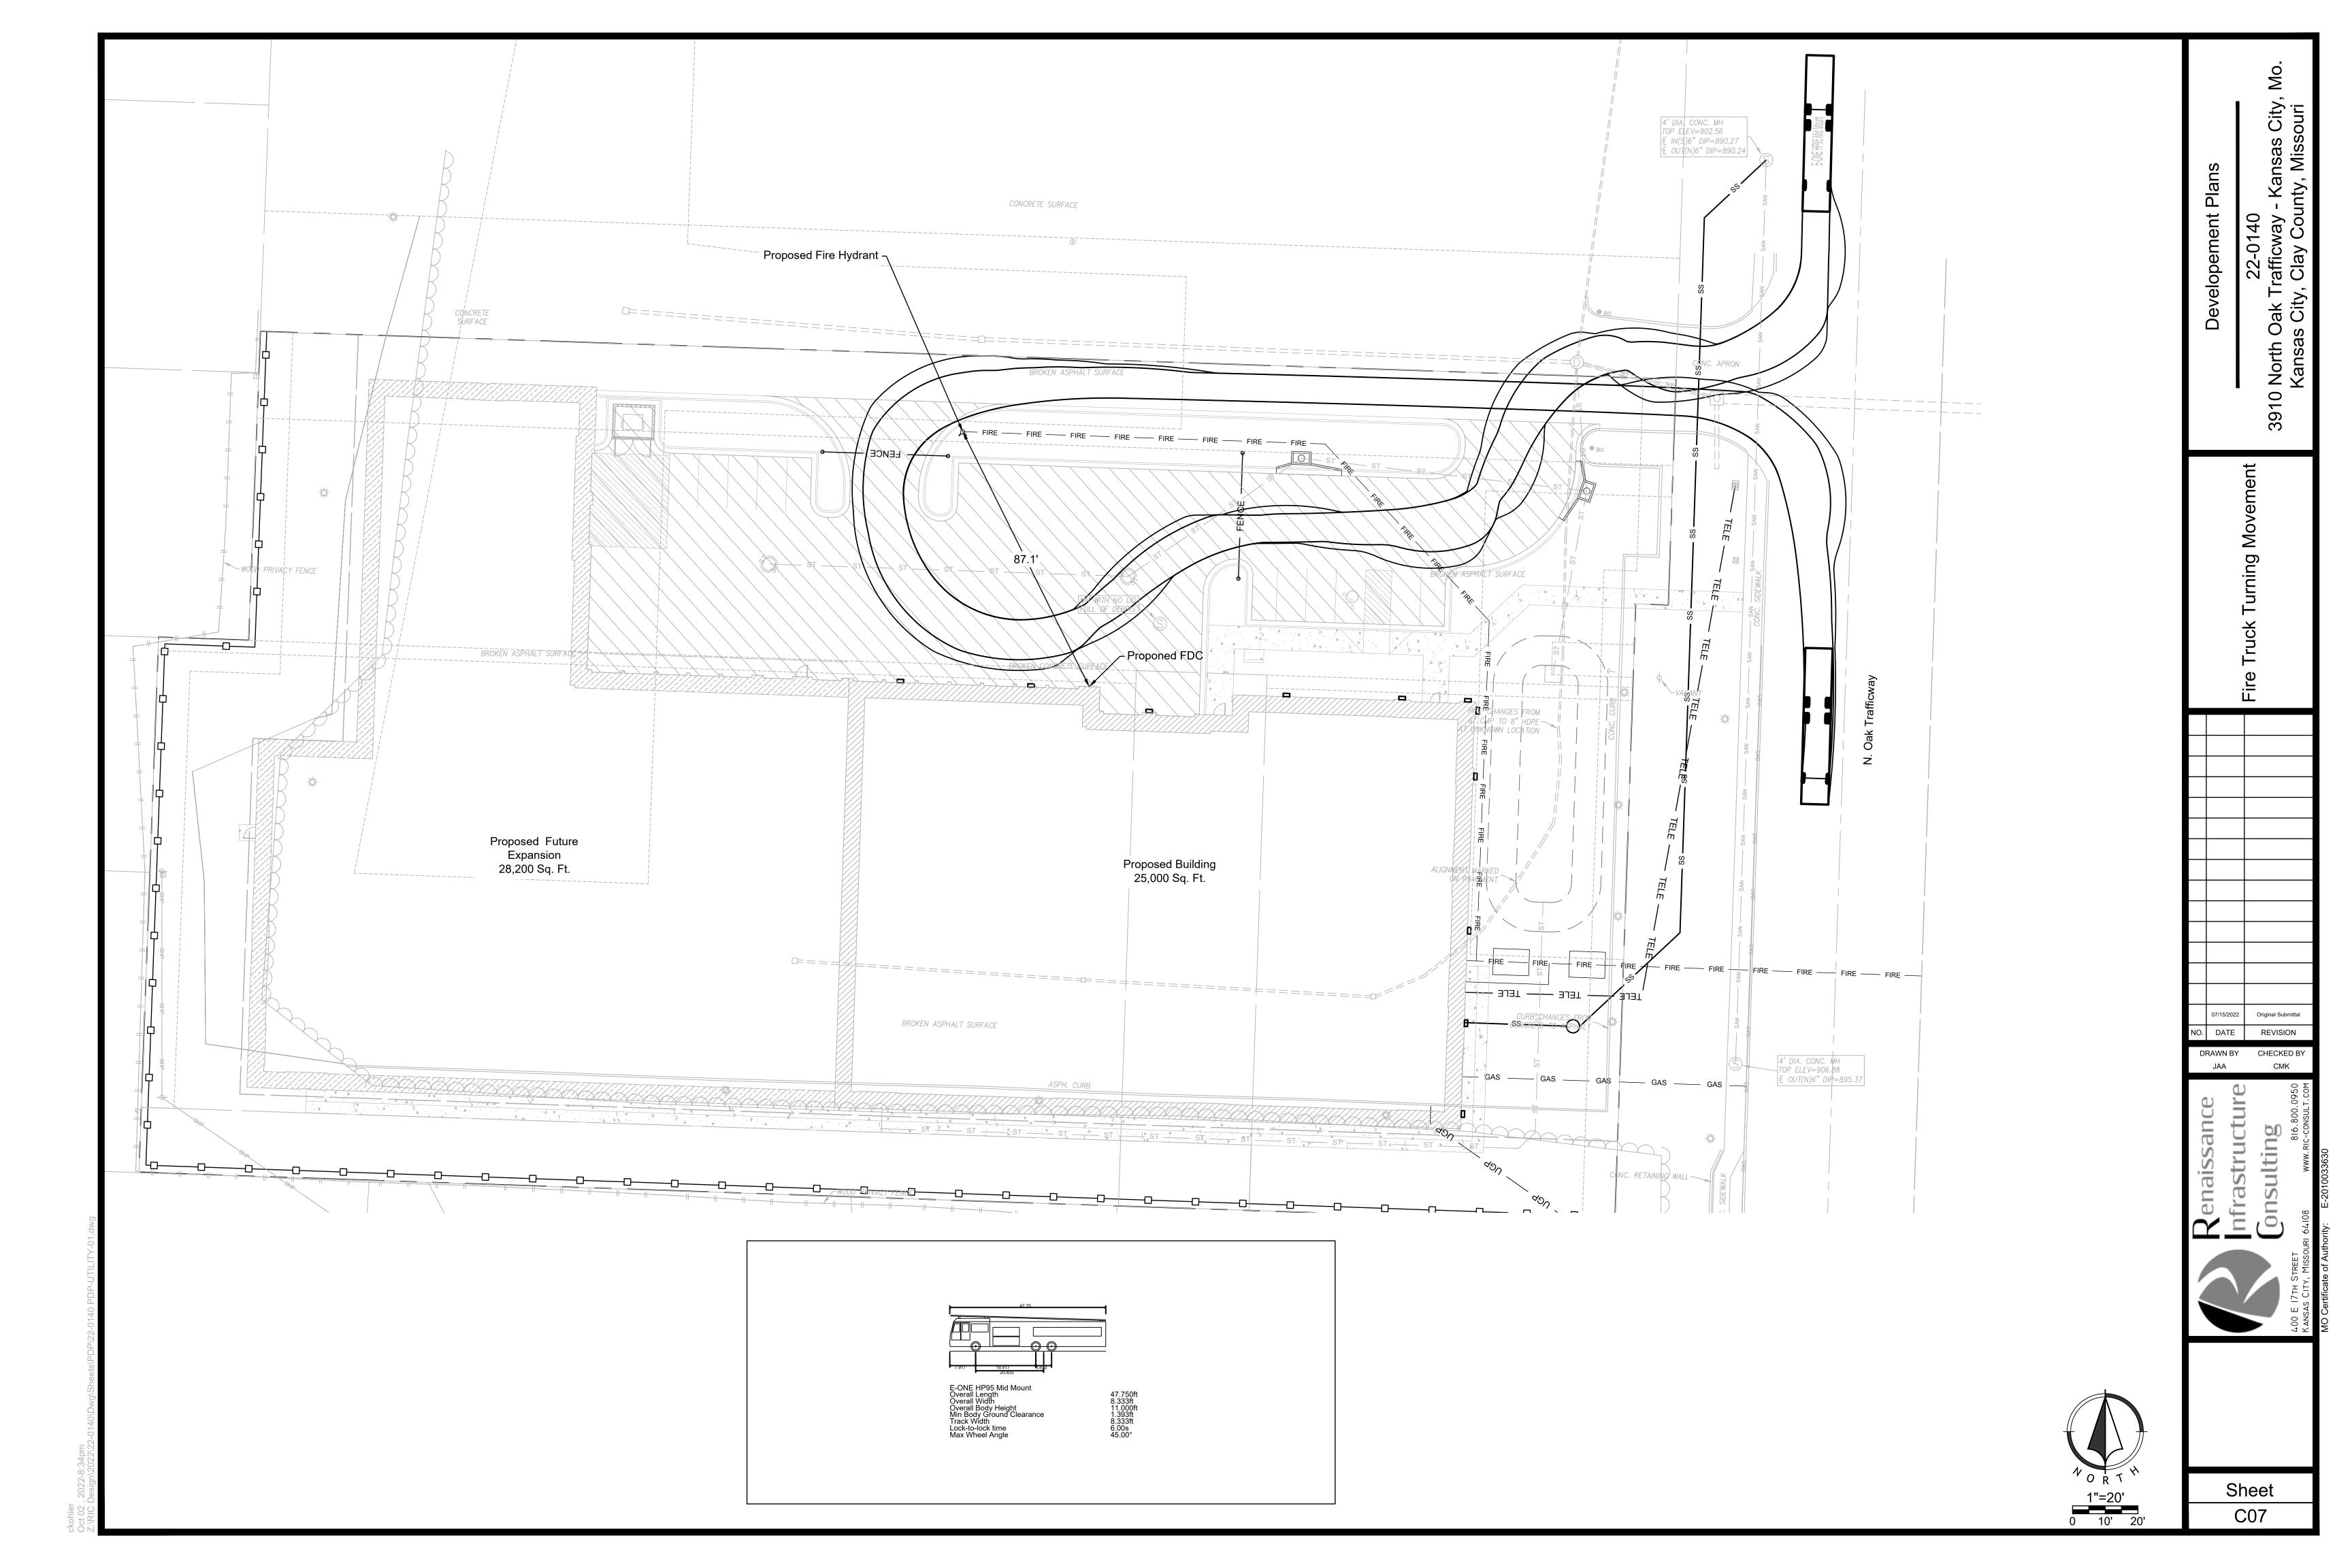

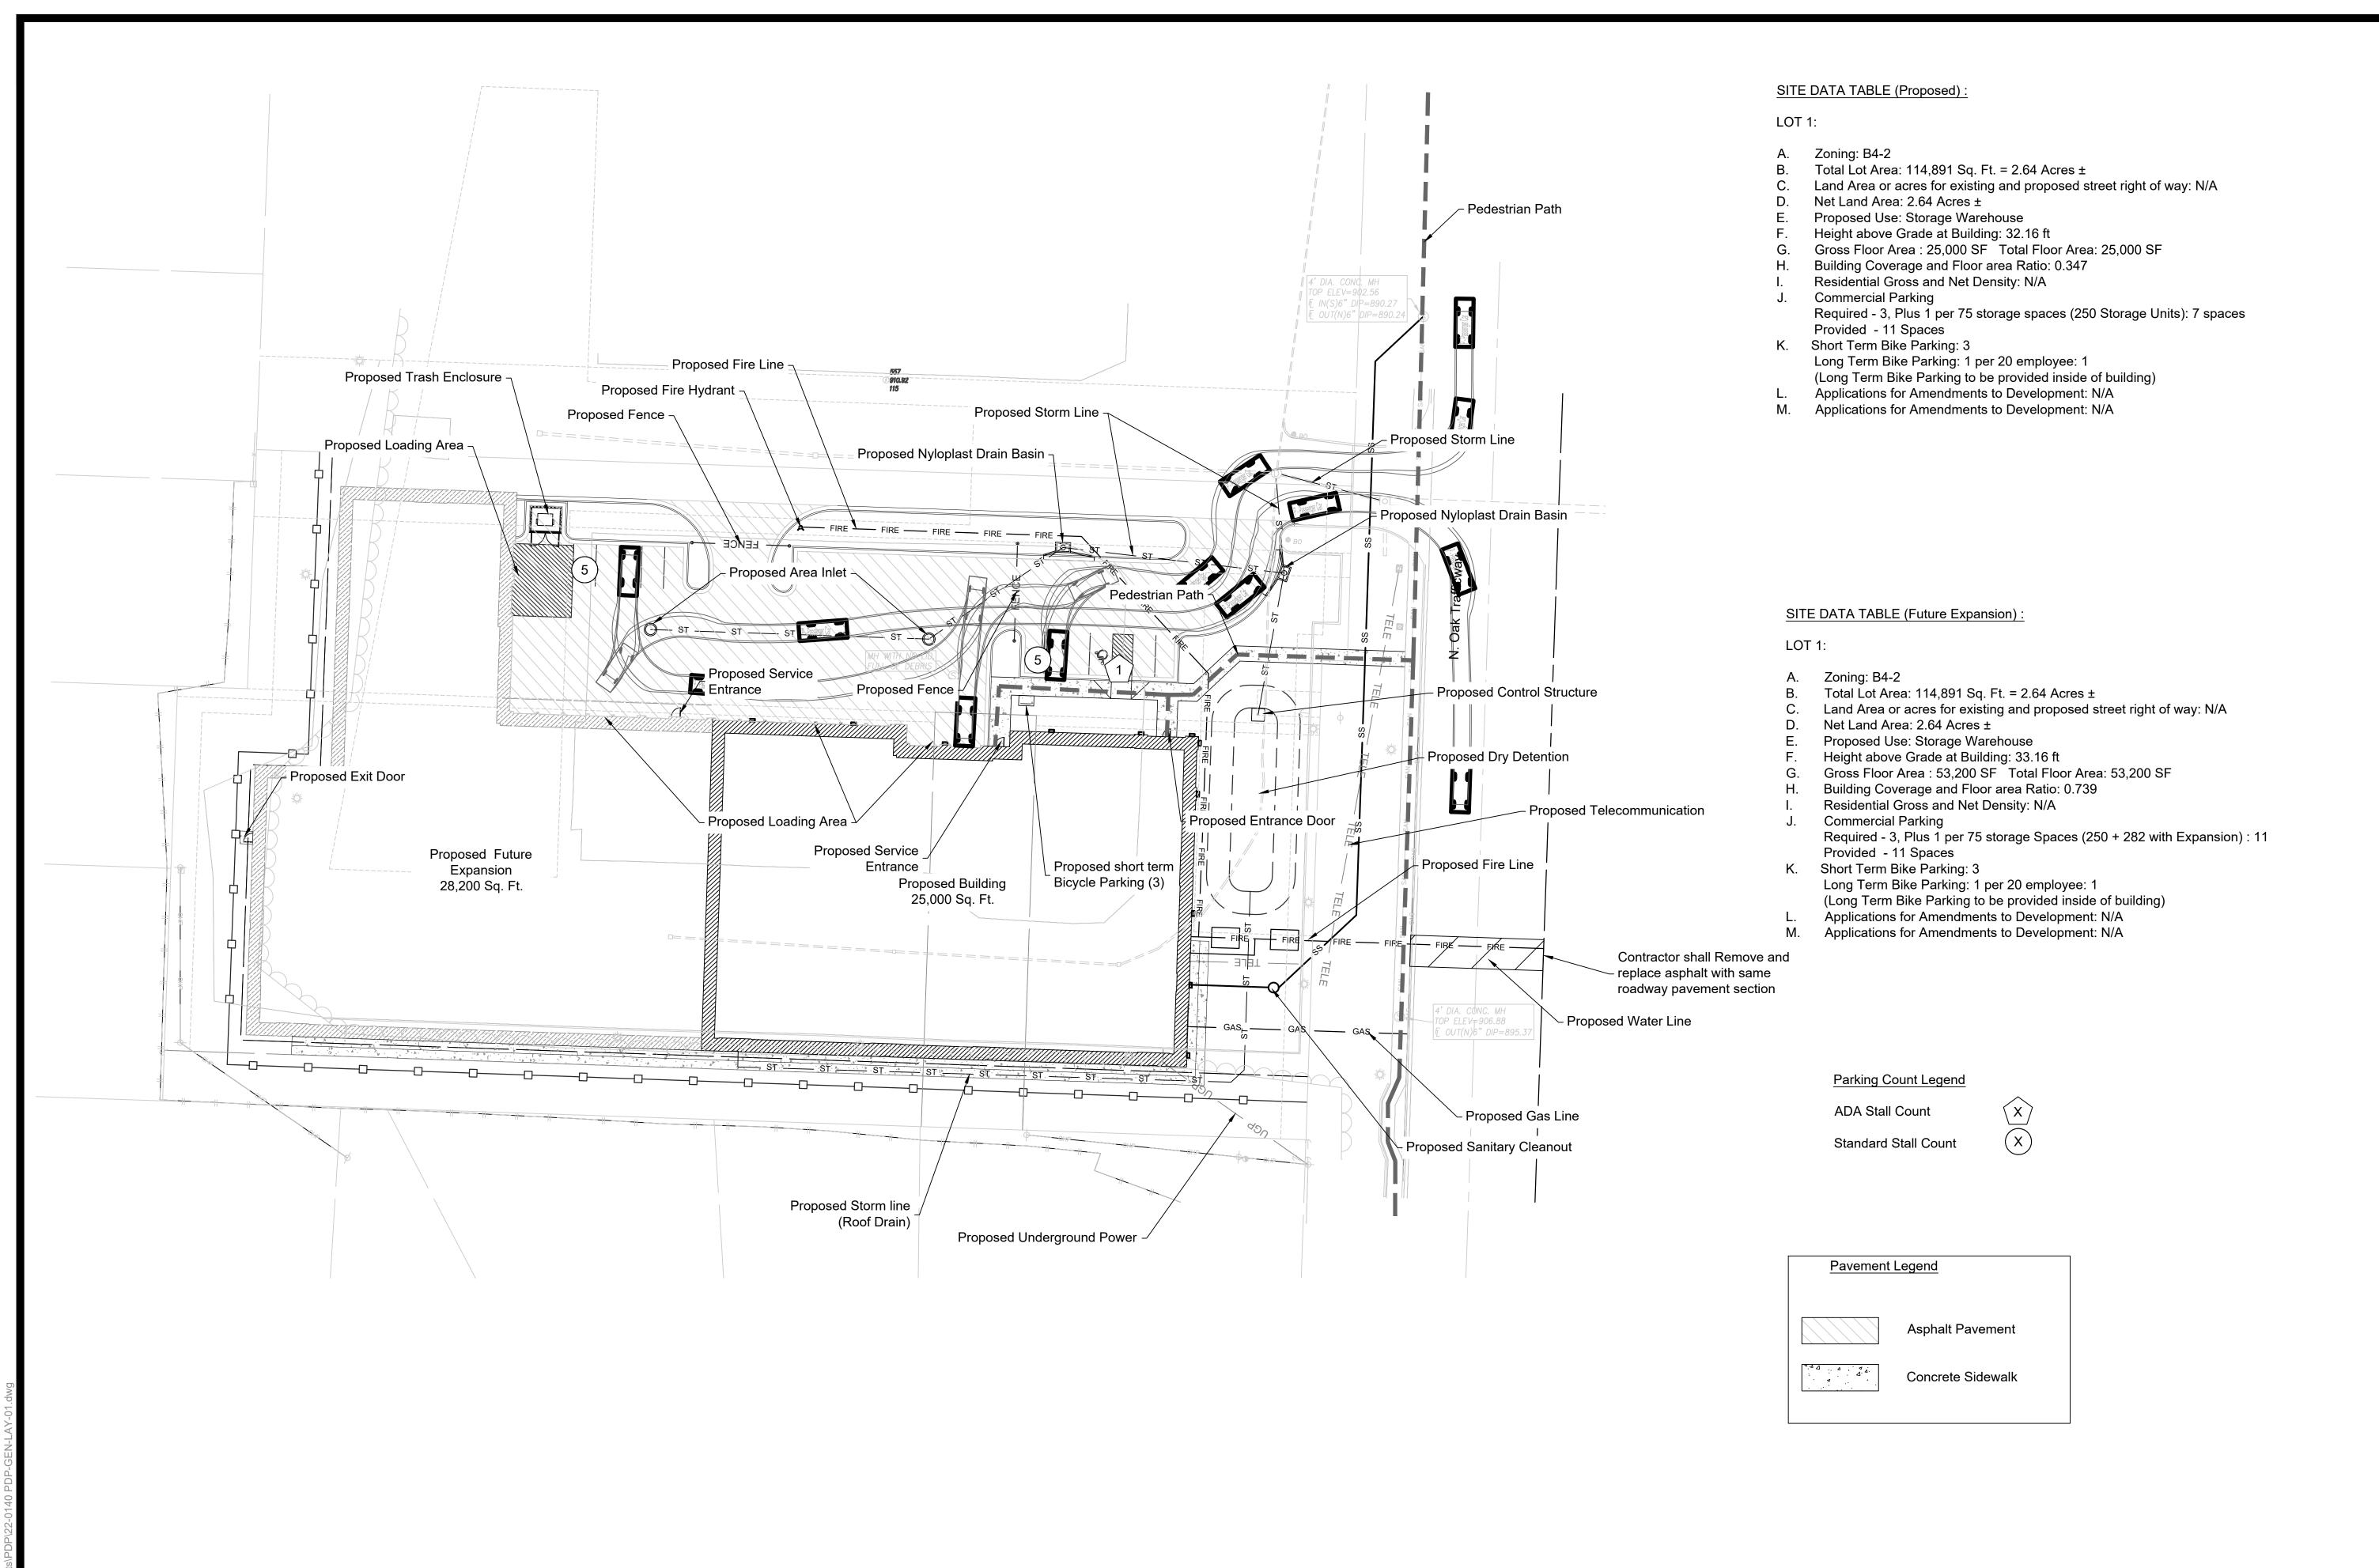

=30'

Sheet C03

REVISION


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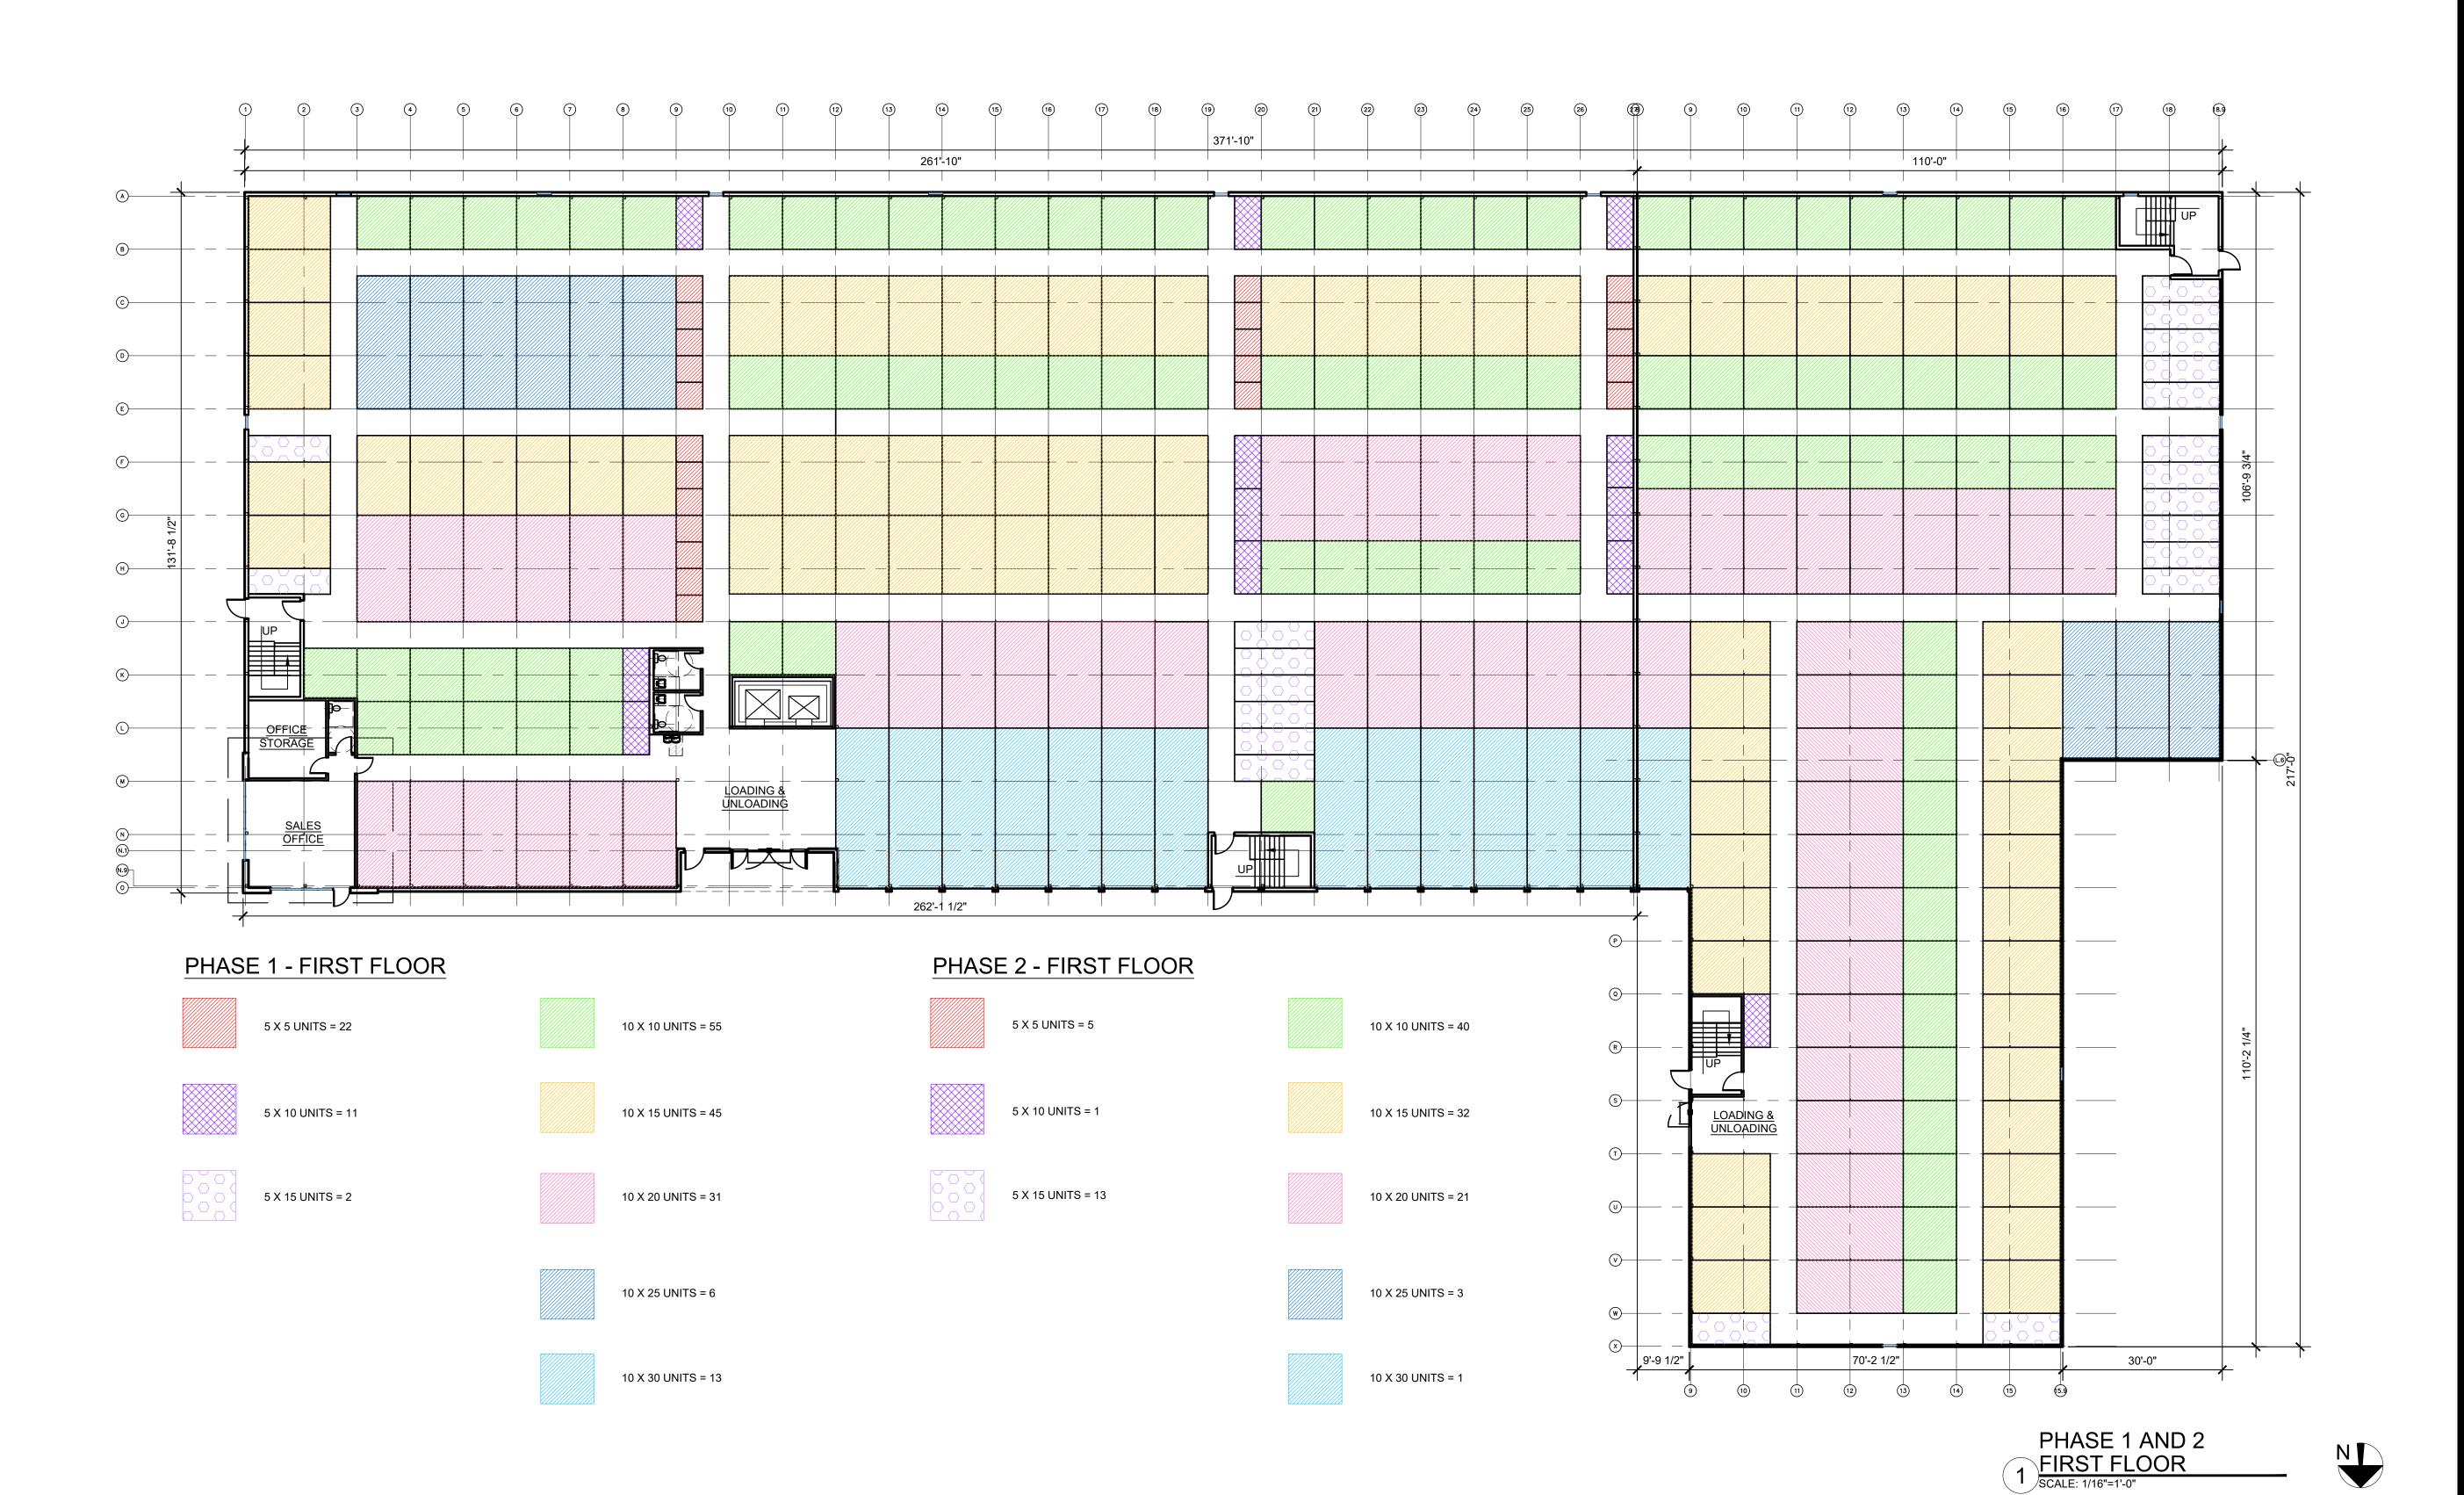
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Developement




UNIT COUNTS							
	PHASE 1 - FIRST FLOOR	PHASE 1 - SECOND FLOOR	TOTAL PER PHASE 1	PHASE 2 - FIRST FLOOR	PHASE 2 - SECOND FLOOR	TOTAL PER PHASE 2	TOTALS FOR ALL PHASES
5 X 5 RED	22	47	69	5	3	8	77
5 X 10 PURPLE DIAMONE	11	33	44	1	1	2	46
5 X 15 LAVENDER HEX	2	7	9	13	5	18	27
10 X 10 GREEN	55	60	115	40	41	81	196
10 X 15 ORANGE	45	58	103	32	37	69	172
10 X 20 PINK	31	26	57	21	21	42	99
10 X 25 BLUE	6	6	12	3	3	6	18
10 X 30 CYAN	13	0	13	1	0	1	14
TOTALS	185	237	422	116	111	227	649



NOLTE & ASSOCIATES, P.A ARCHITECTS / PLANNERS Sep 30, 2022 DATE ISSUED: REVISIONS: ARCHITECTURAL PROJECT NUMBER 2022020

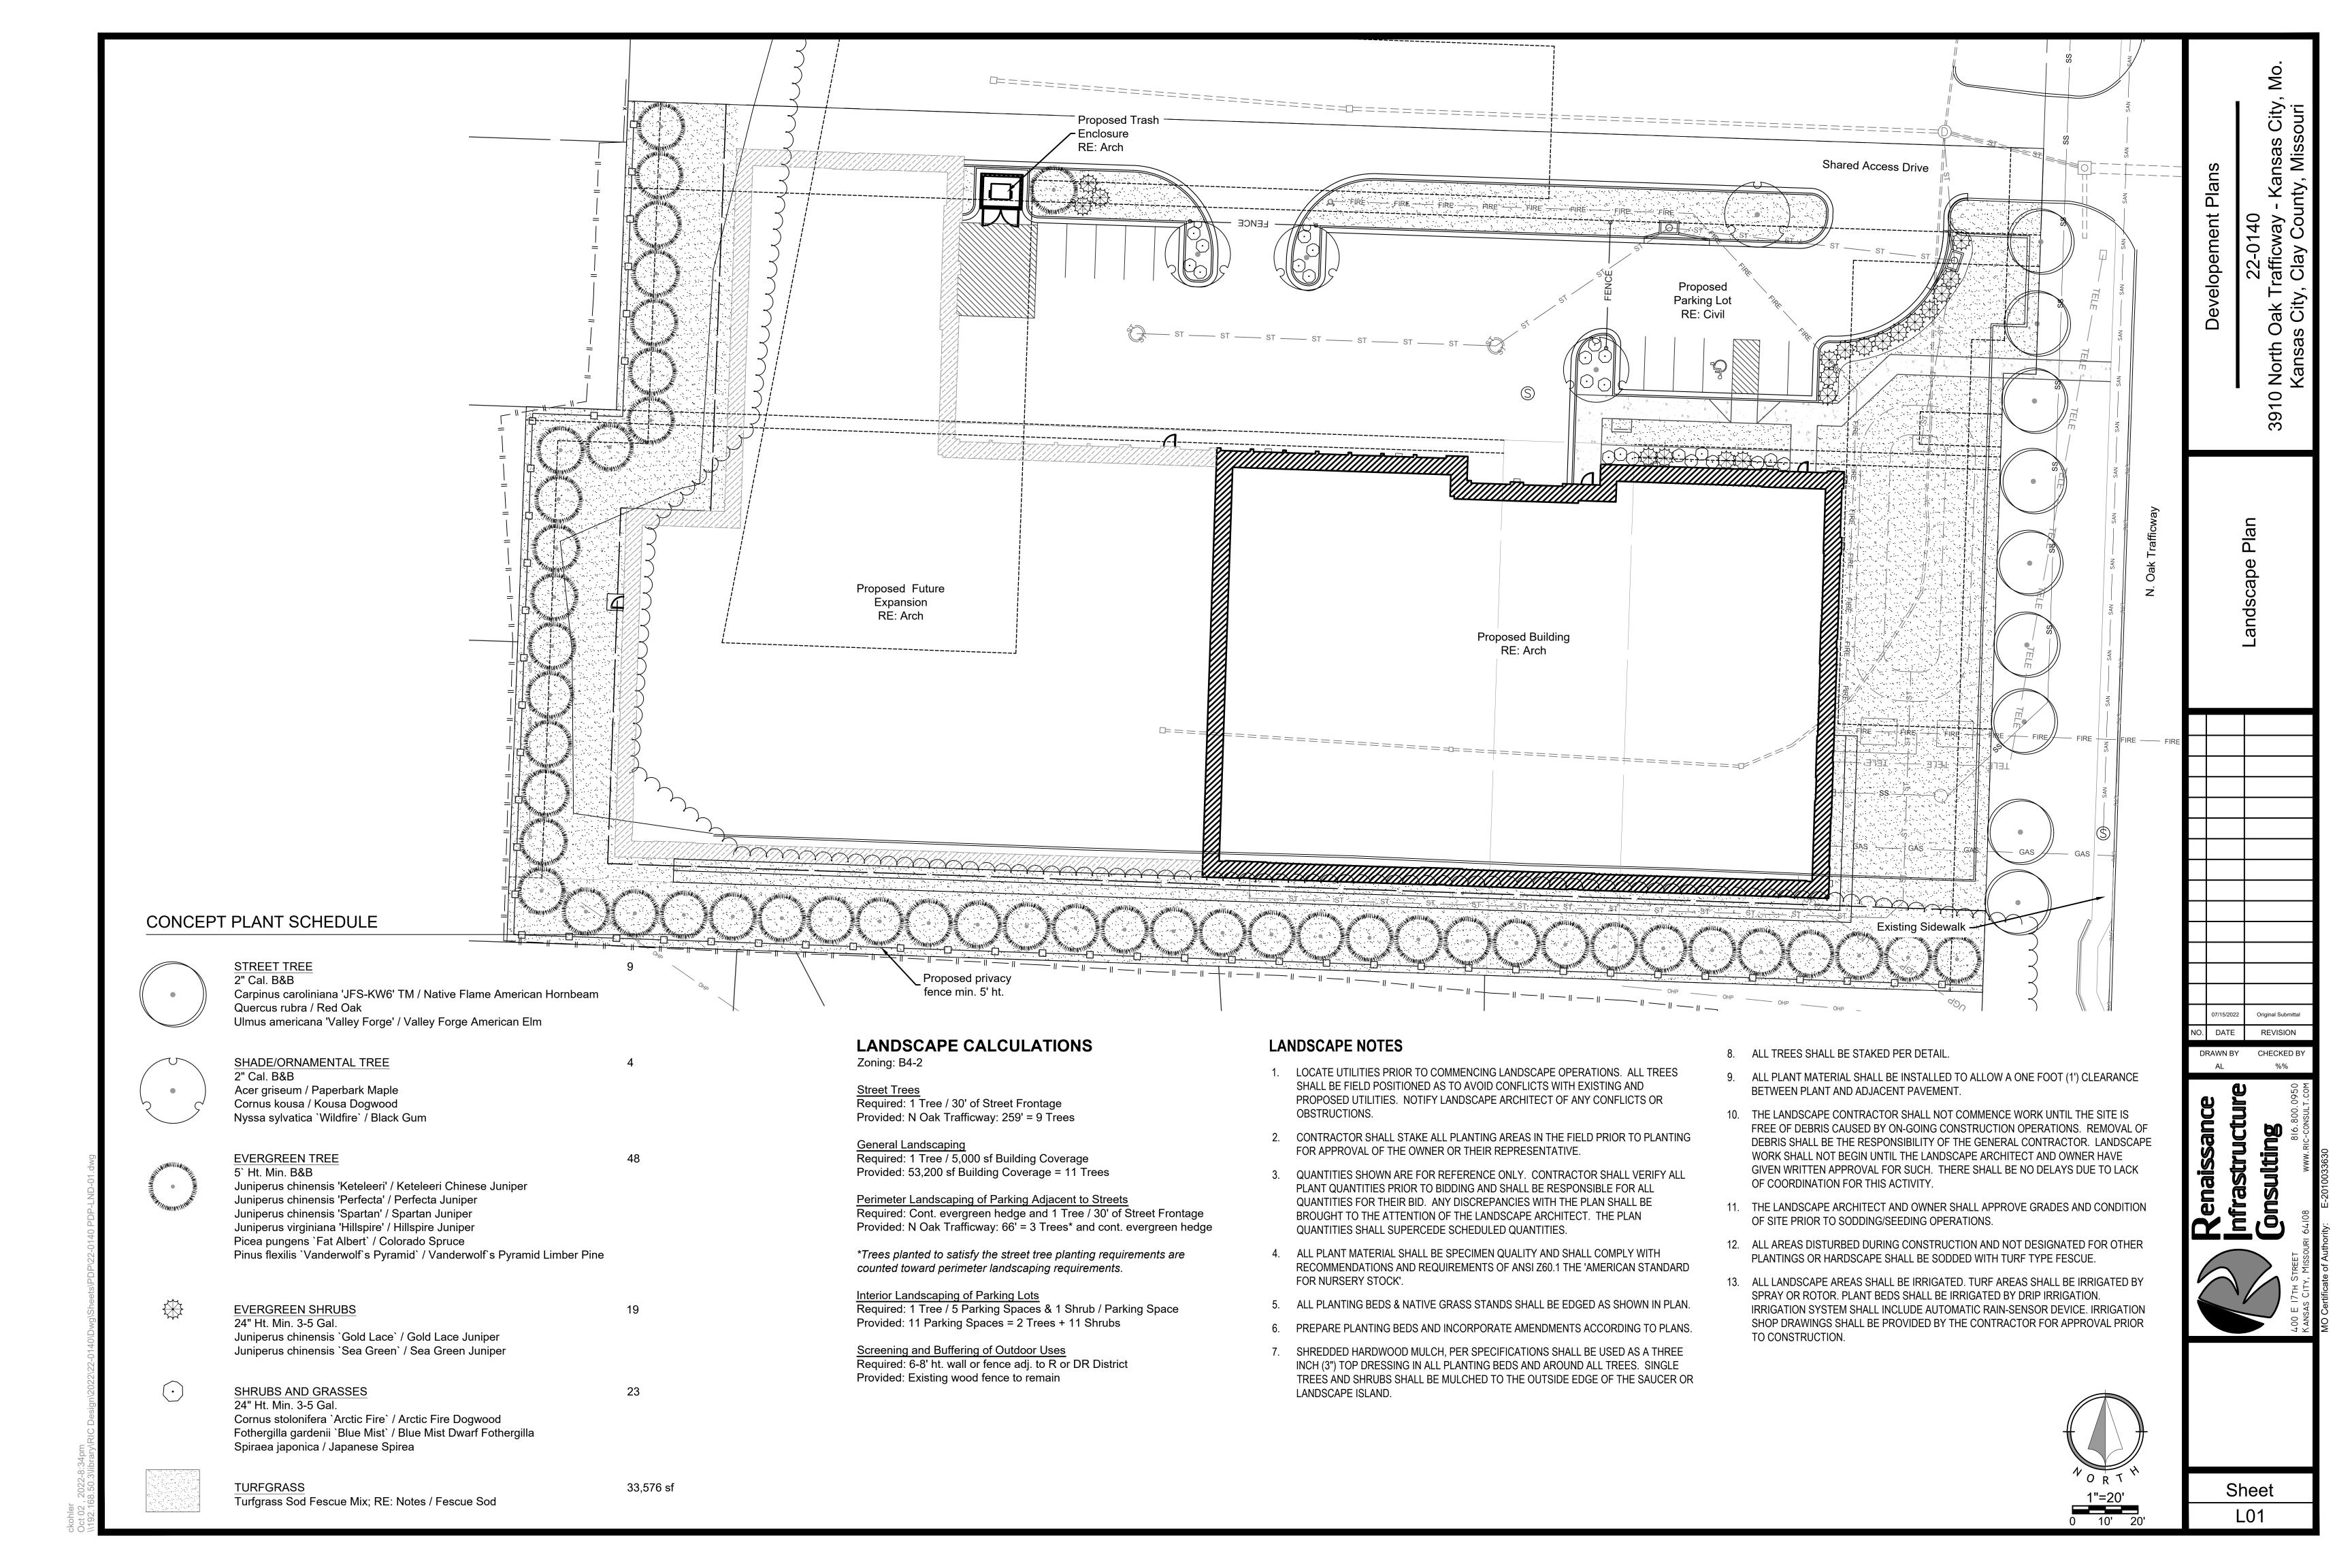FIRST FLOOR

BUILDING PLAN

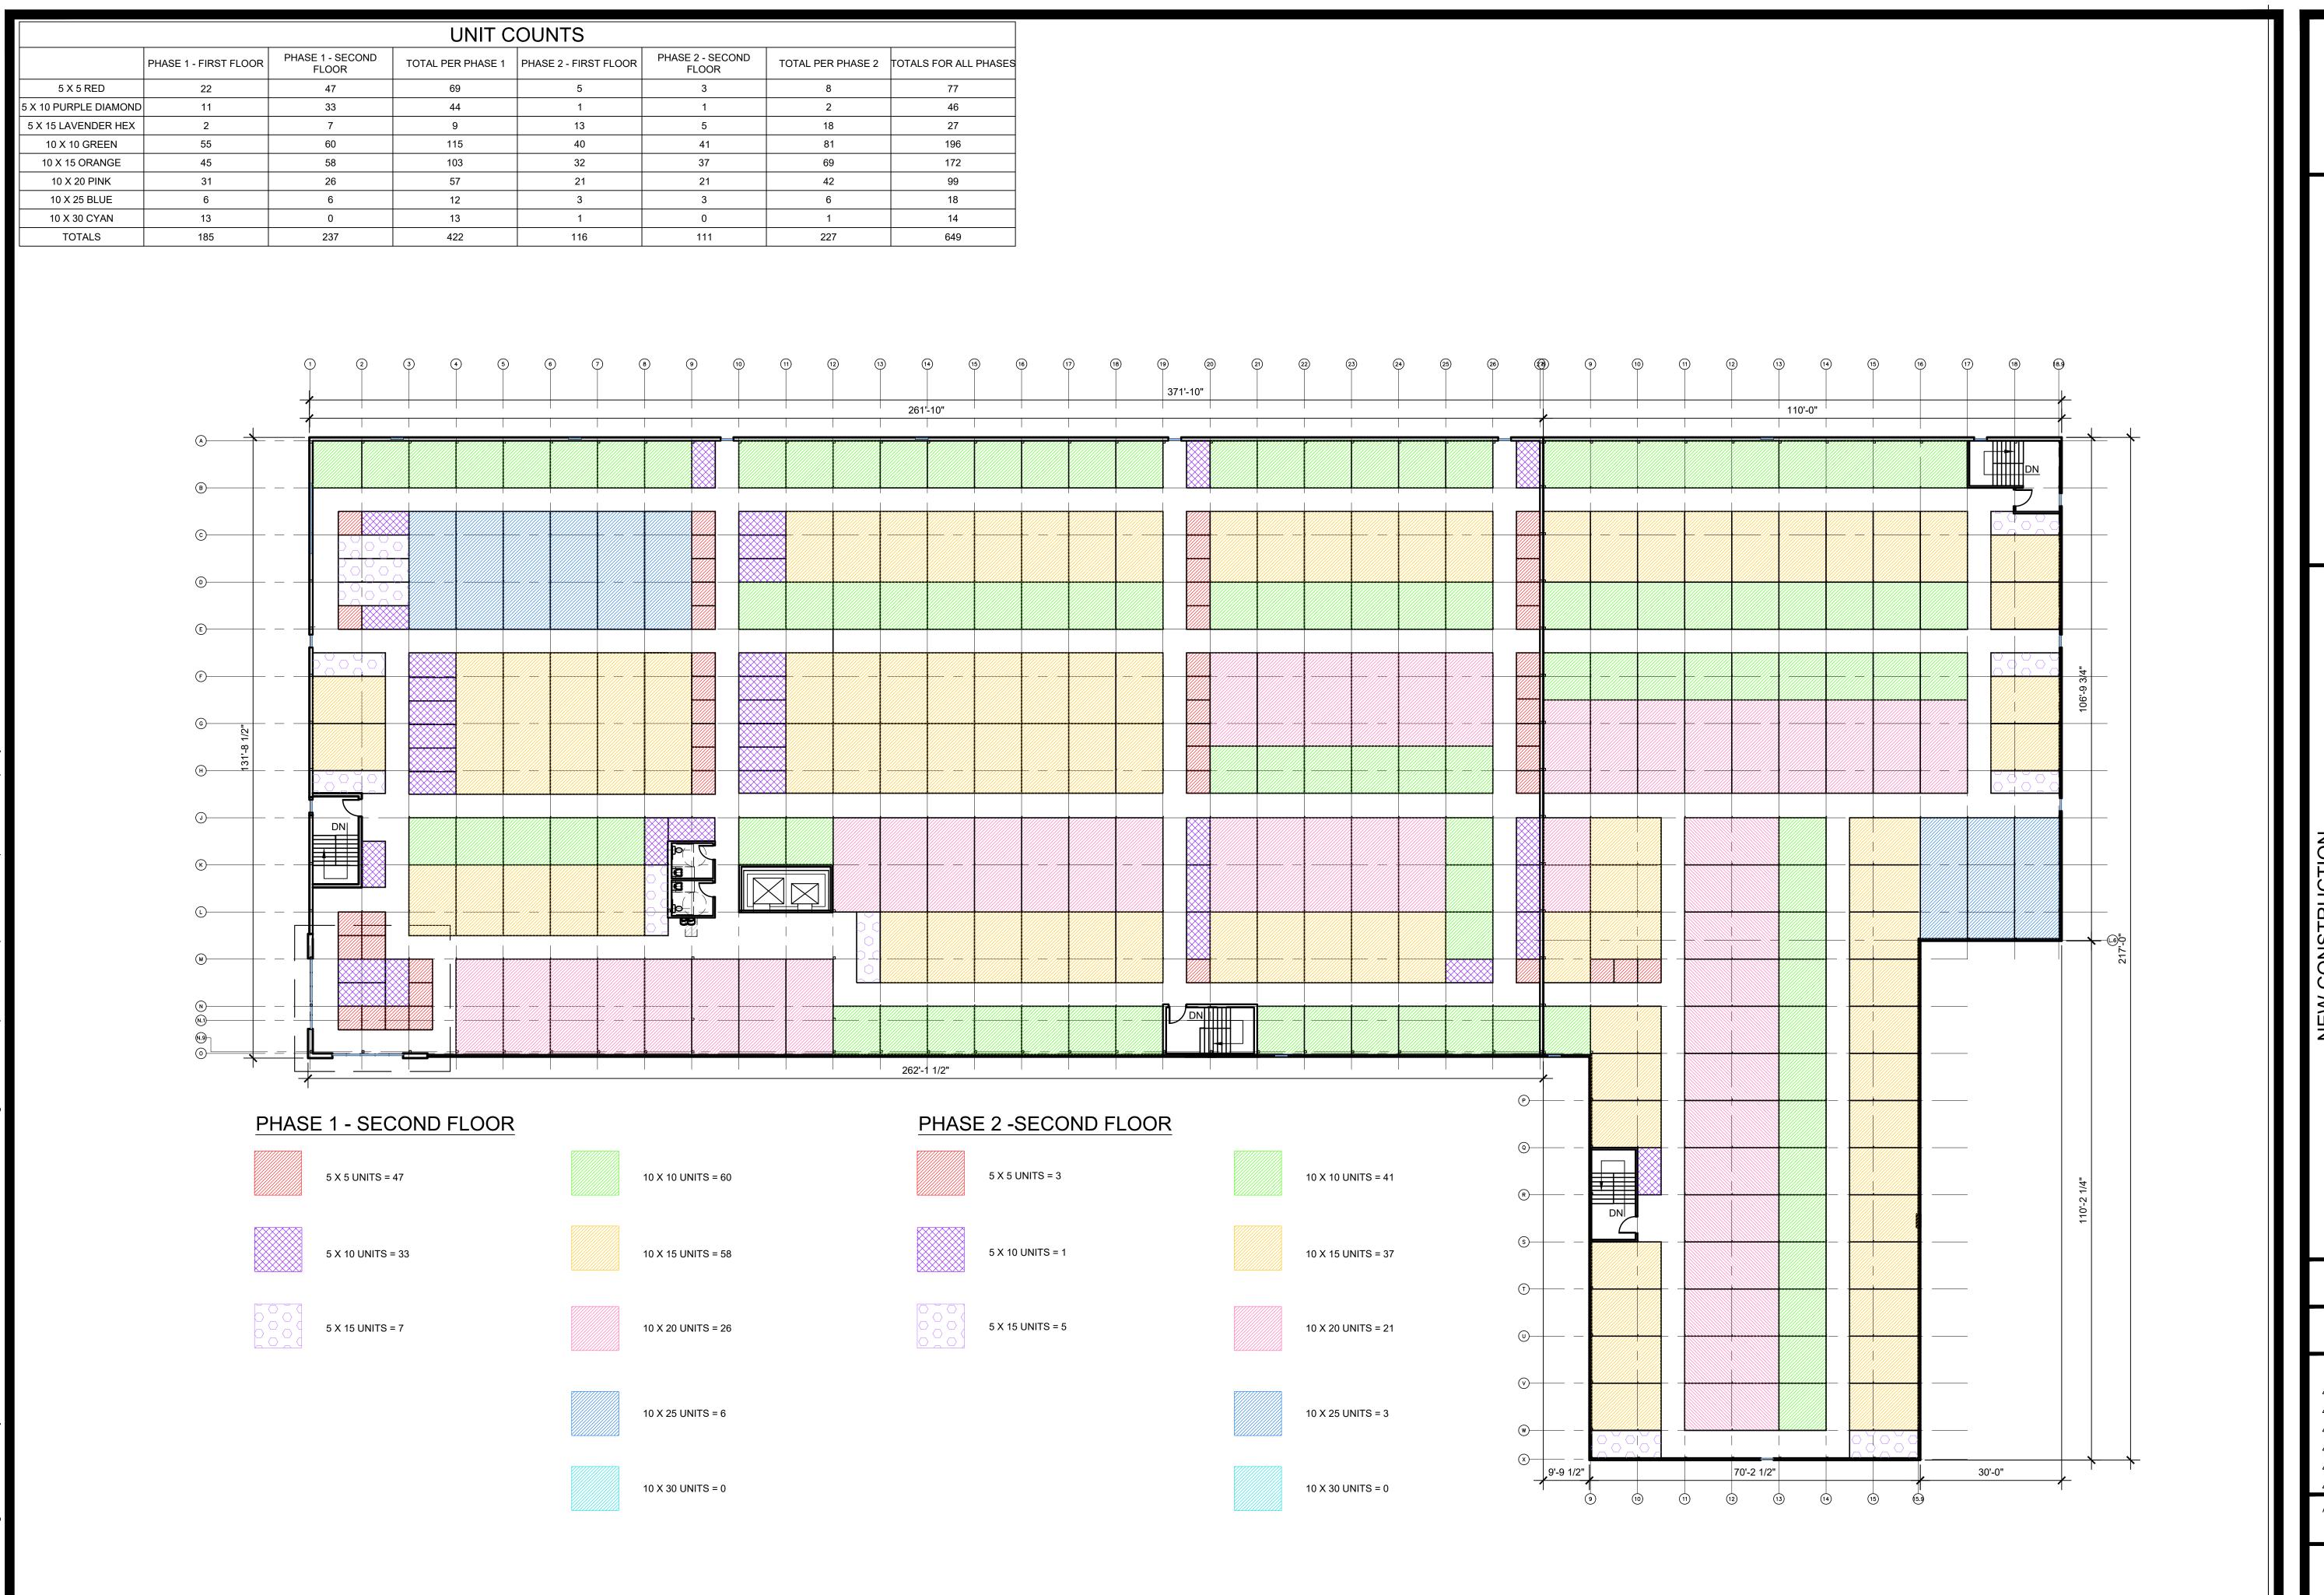

PHASE 1 AND 2
SECOND FLOOR
SCALE: 1/16"=1'-0"



NOLTE & ASSOCIATES, P.A.
ARCHITECTS / PLANNERS
9400 REEDS ROAD, SUITE 200
OVERLAND PARK, KANSAS 66207
(913) 322-2444

TH OAK TRAFFICWAY

CONTROLED STORA

3910 NORTH OAK TRAFFICWAY
KANSAS CITY, MISSOURI
CLAY COUNTY

DATE PRINTED: Sep 30, 2022

DATE ISSUED:


REVISIONS:

ARCHITECTURAL PROJECT NUMBER 2022020

SECOND FLOOR

FLOOR BUILDING PLAN

SHEET NUMBER

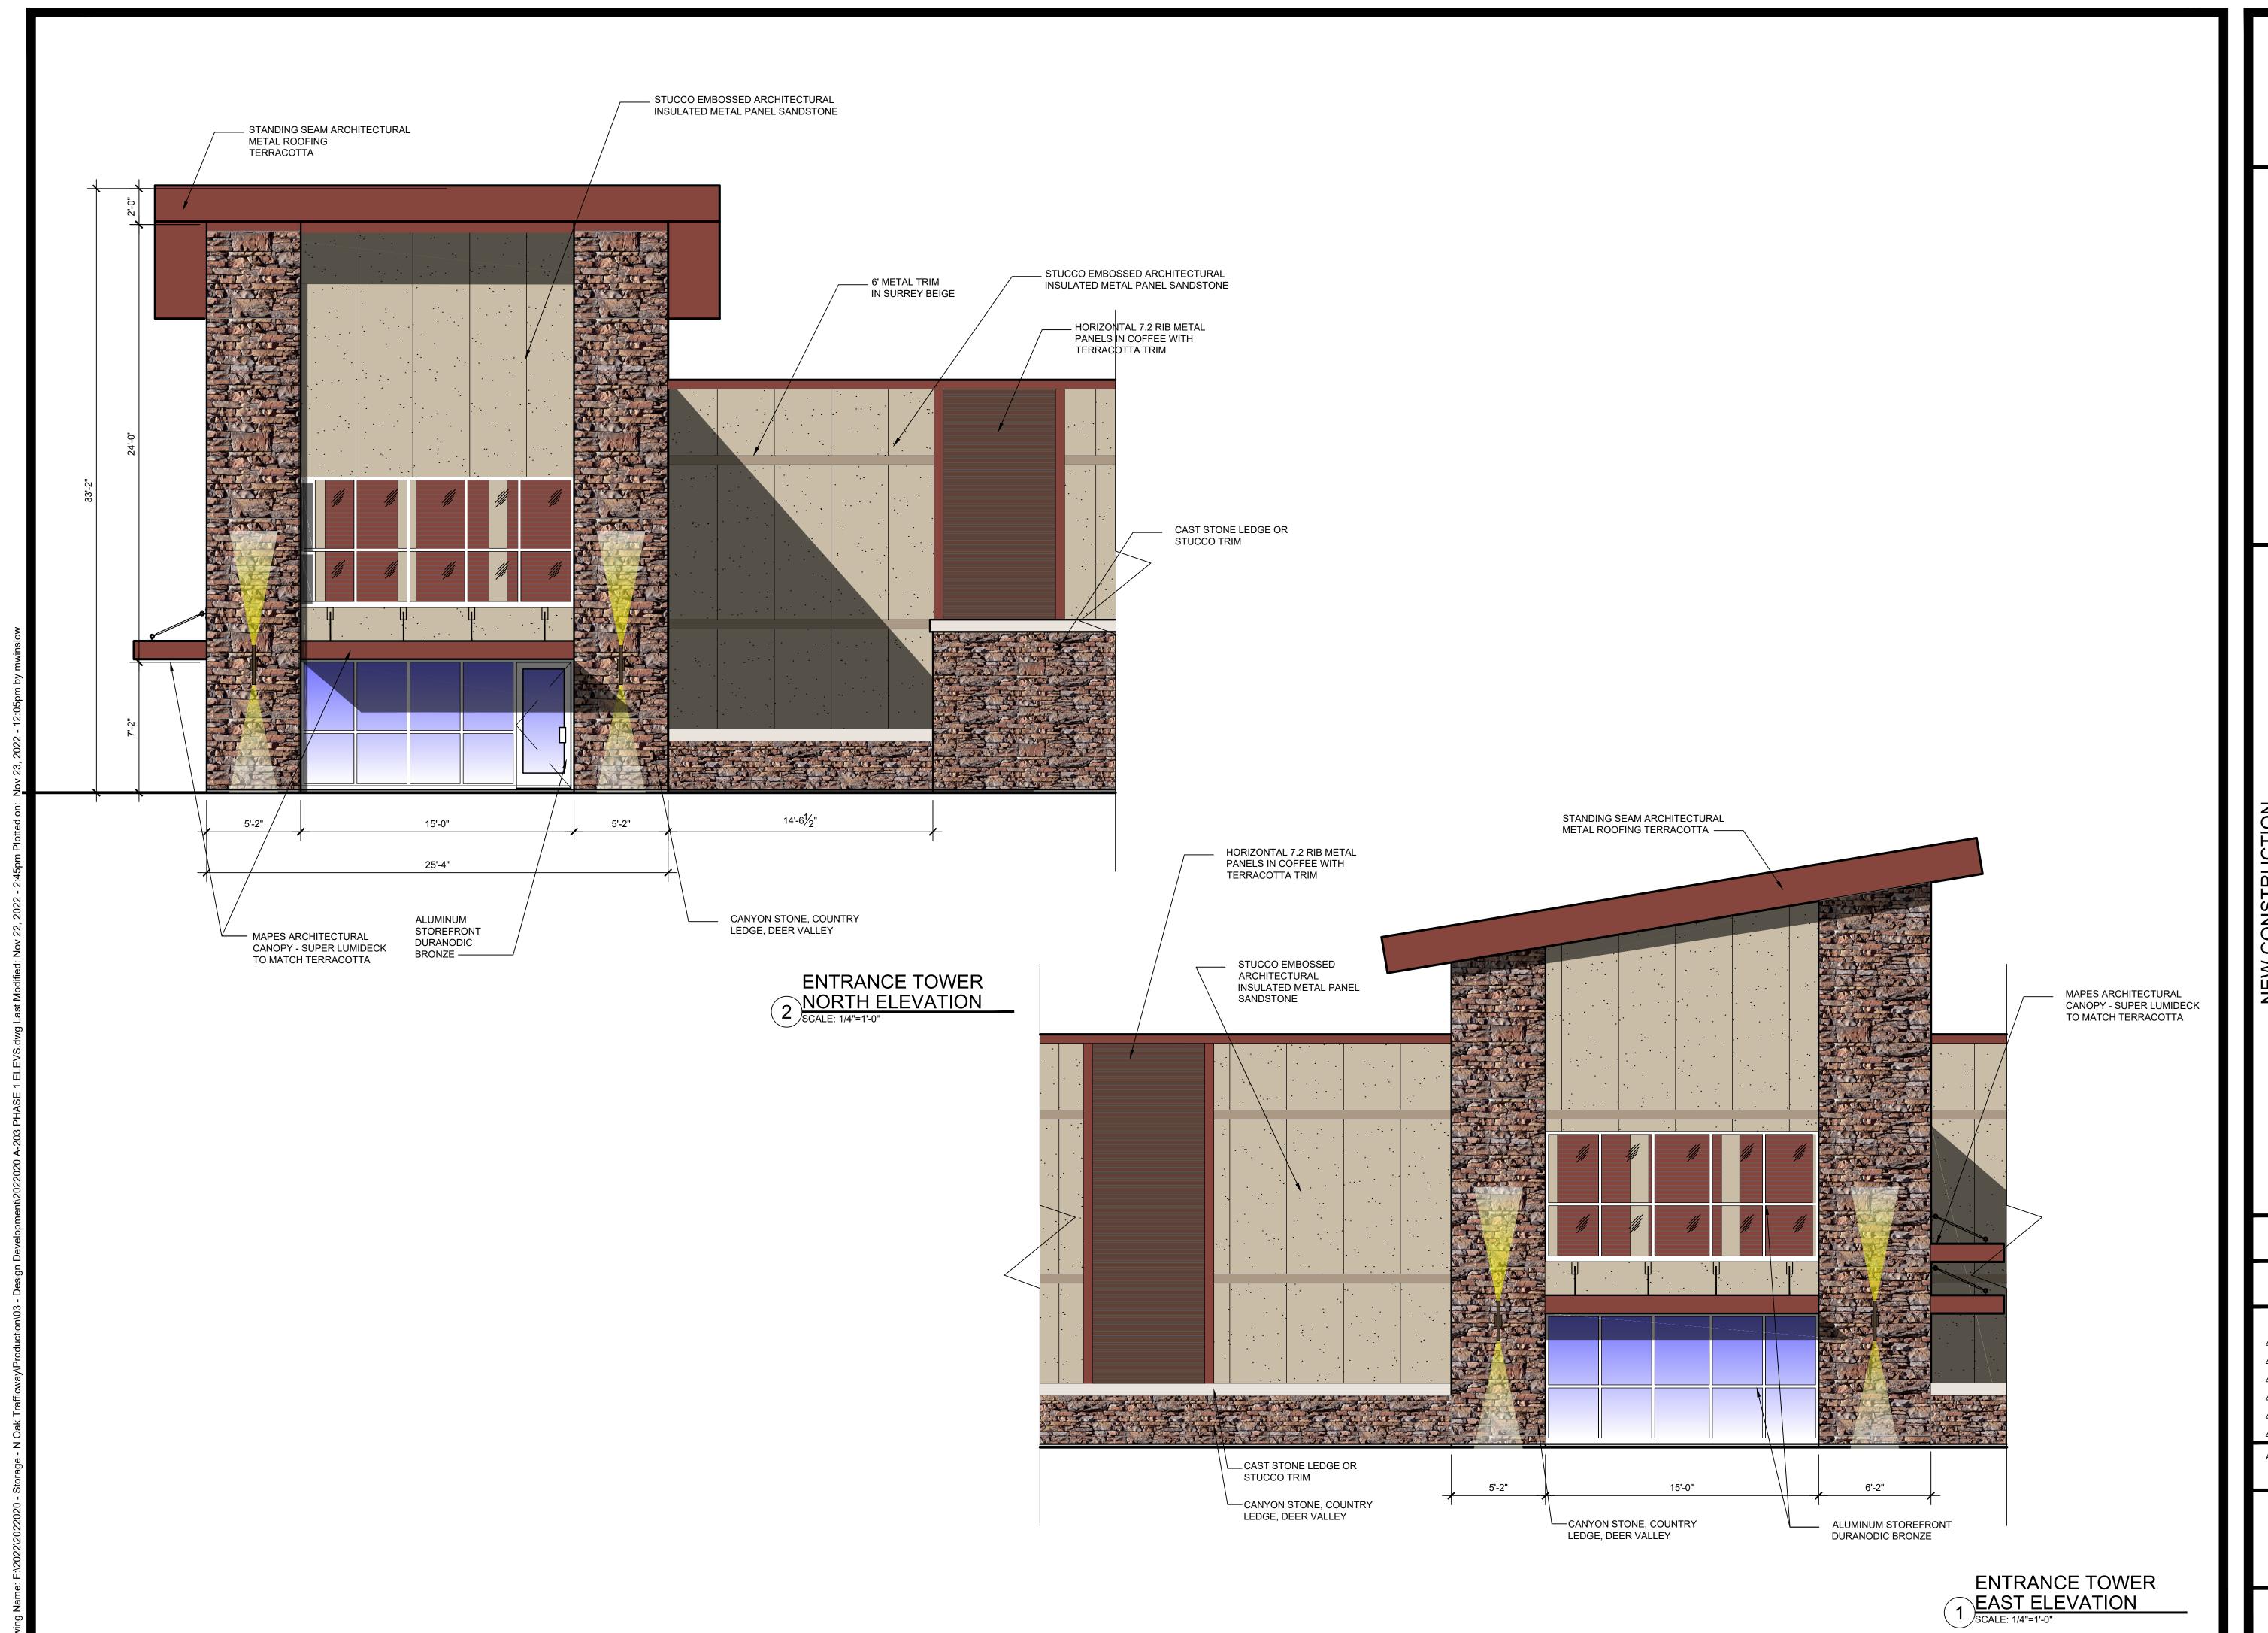

| NOLTE & ASSOCIATES, P.A. | ARCHITECTS / PLANNERS | PRAFFICWAY | ASSOCIATE SOURCE | PLANNERS | PRAFFICWAY | ASSOCIATE SOURCE | PLANNERS | PRAFFICWAY | ASSOCIATE SOURCE | PLANNERS | PRAFFICWAY | PRAFF

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3910 NORTH OAK TRAFFIC
KANSAS CITY, MISSOUF

DATE PRINTED:
Nov 23, 2022

DATE ISSUED:


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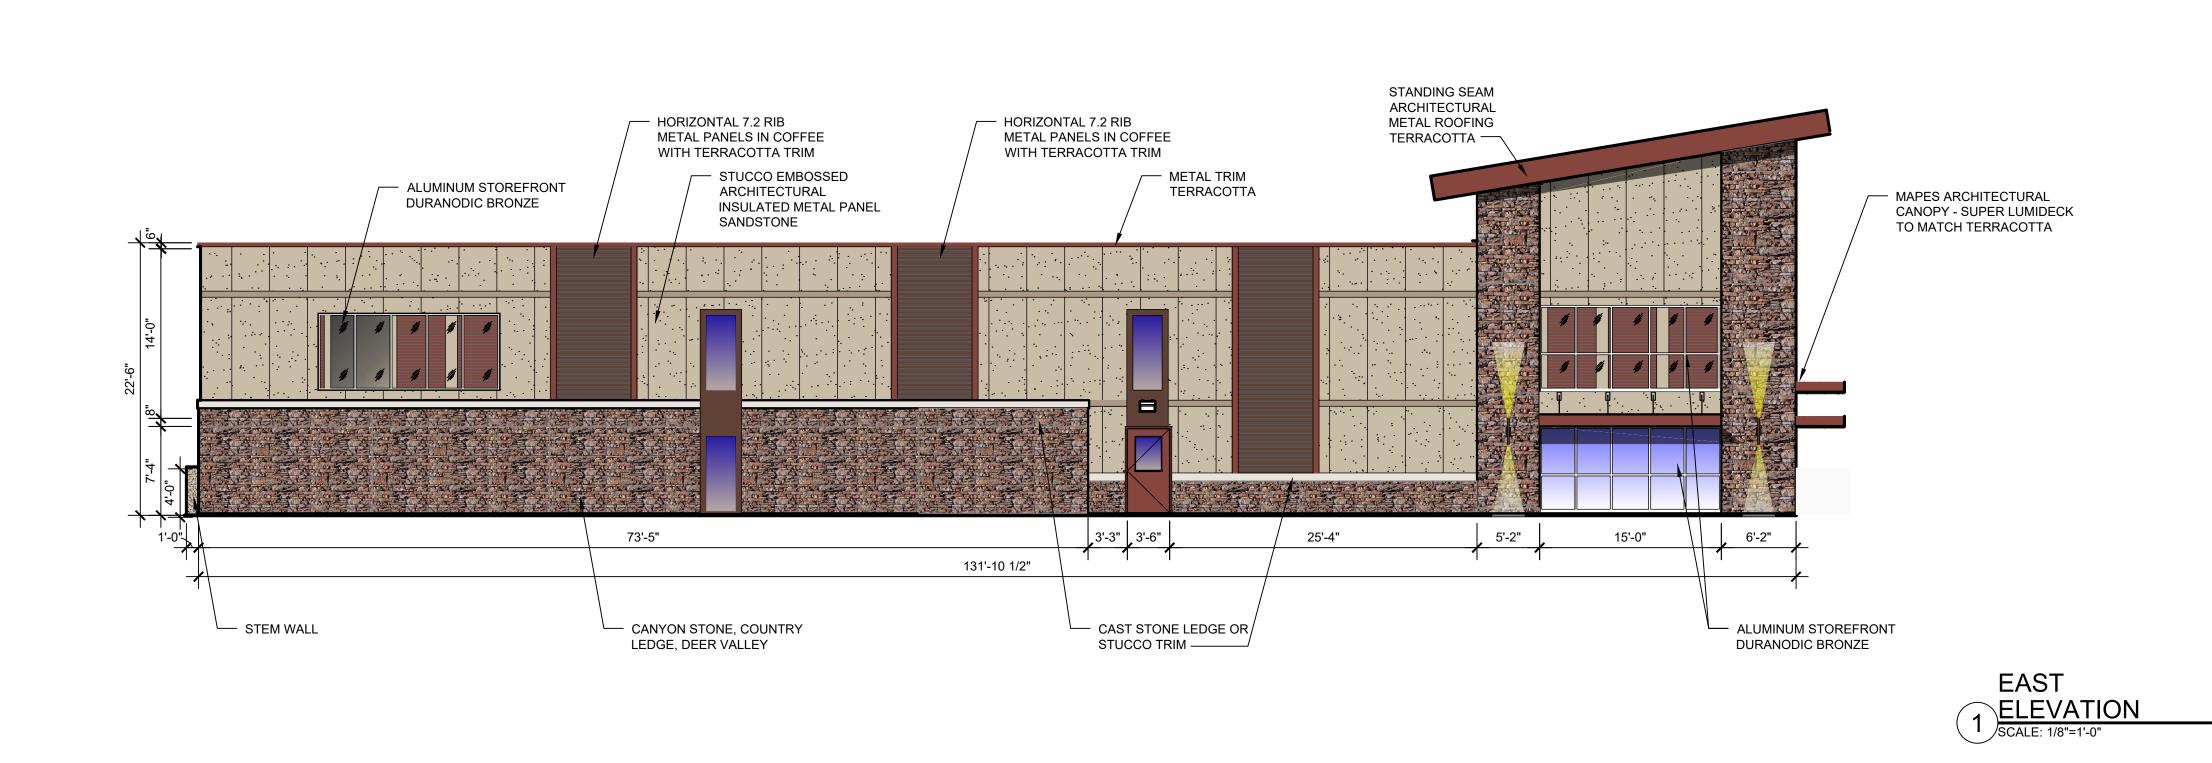
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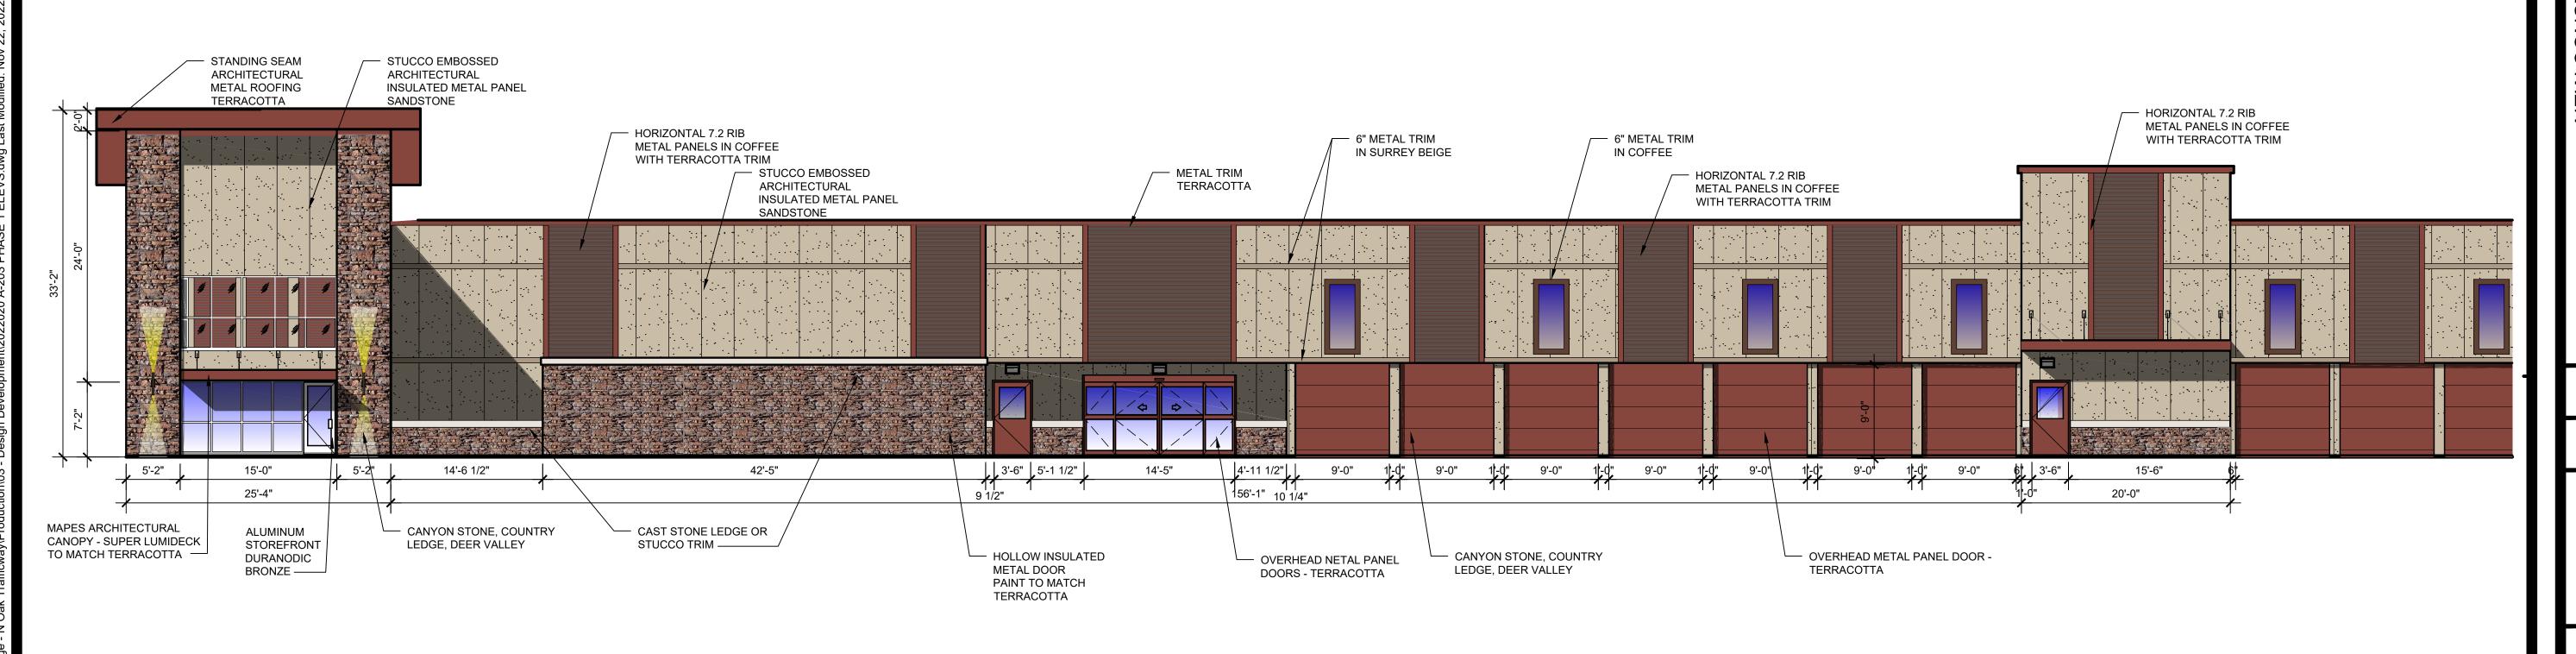
PHASE 1 N/E ENLARGED TOWER ELEVS.

SHEET NUMBER

A-204





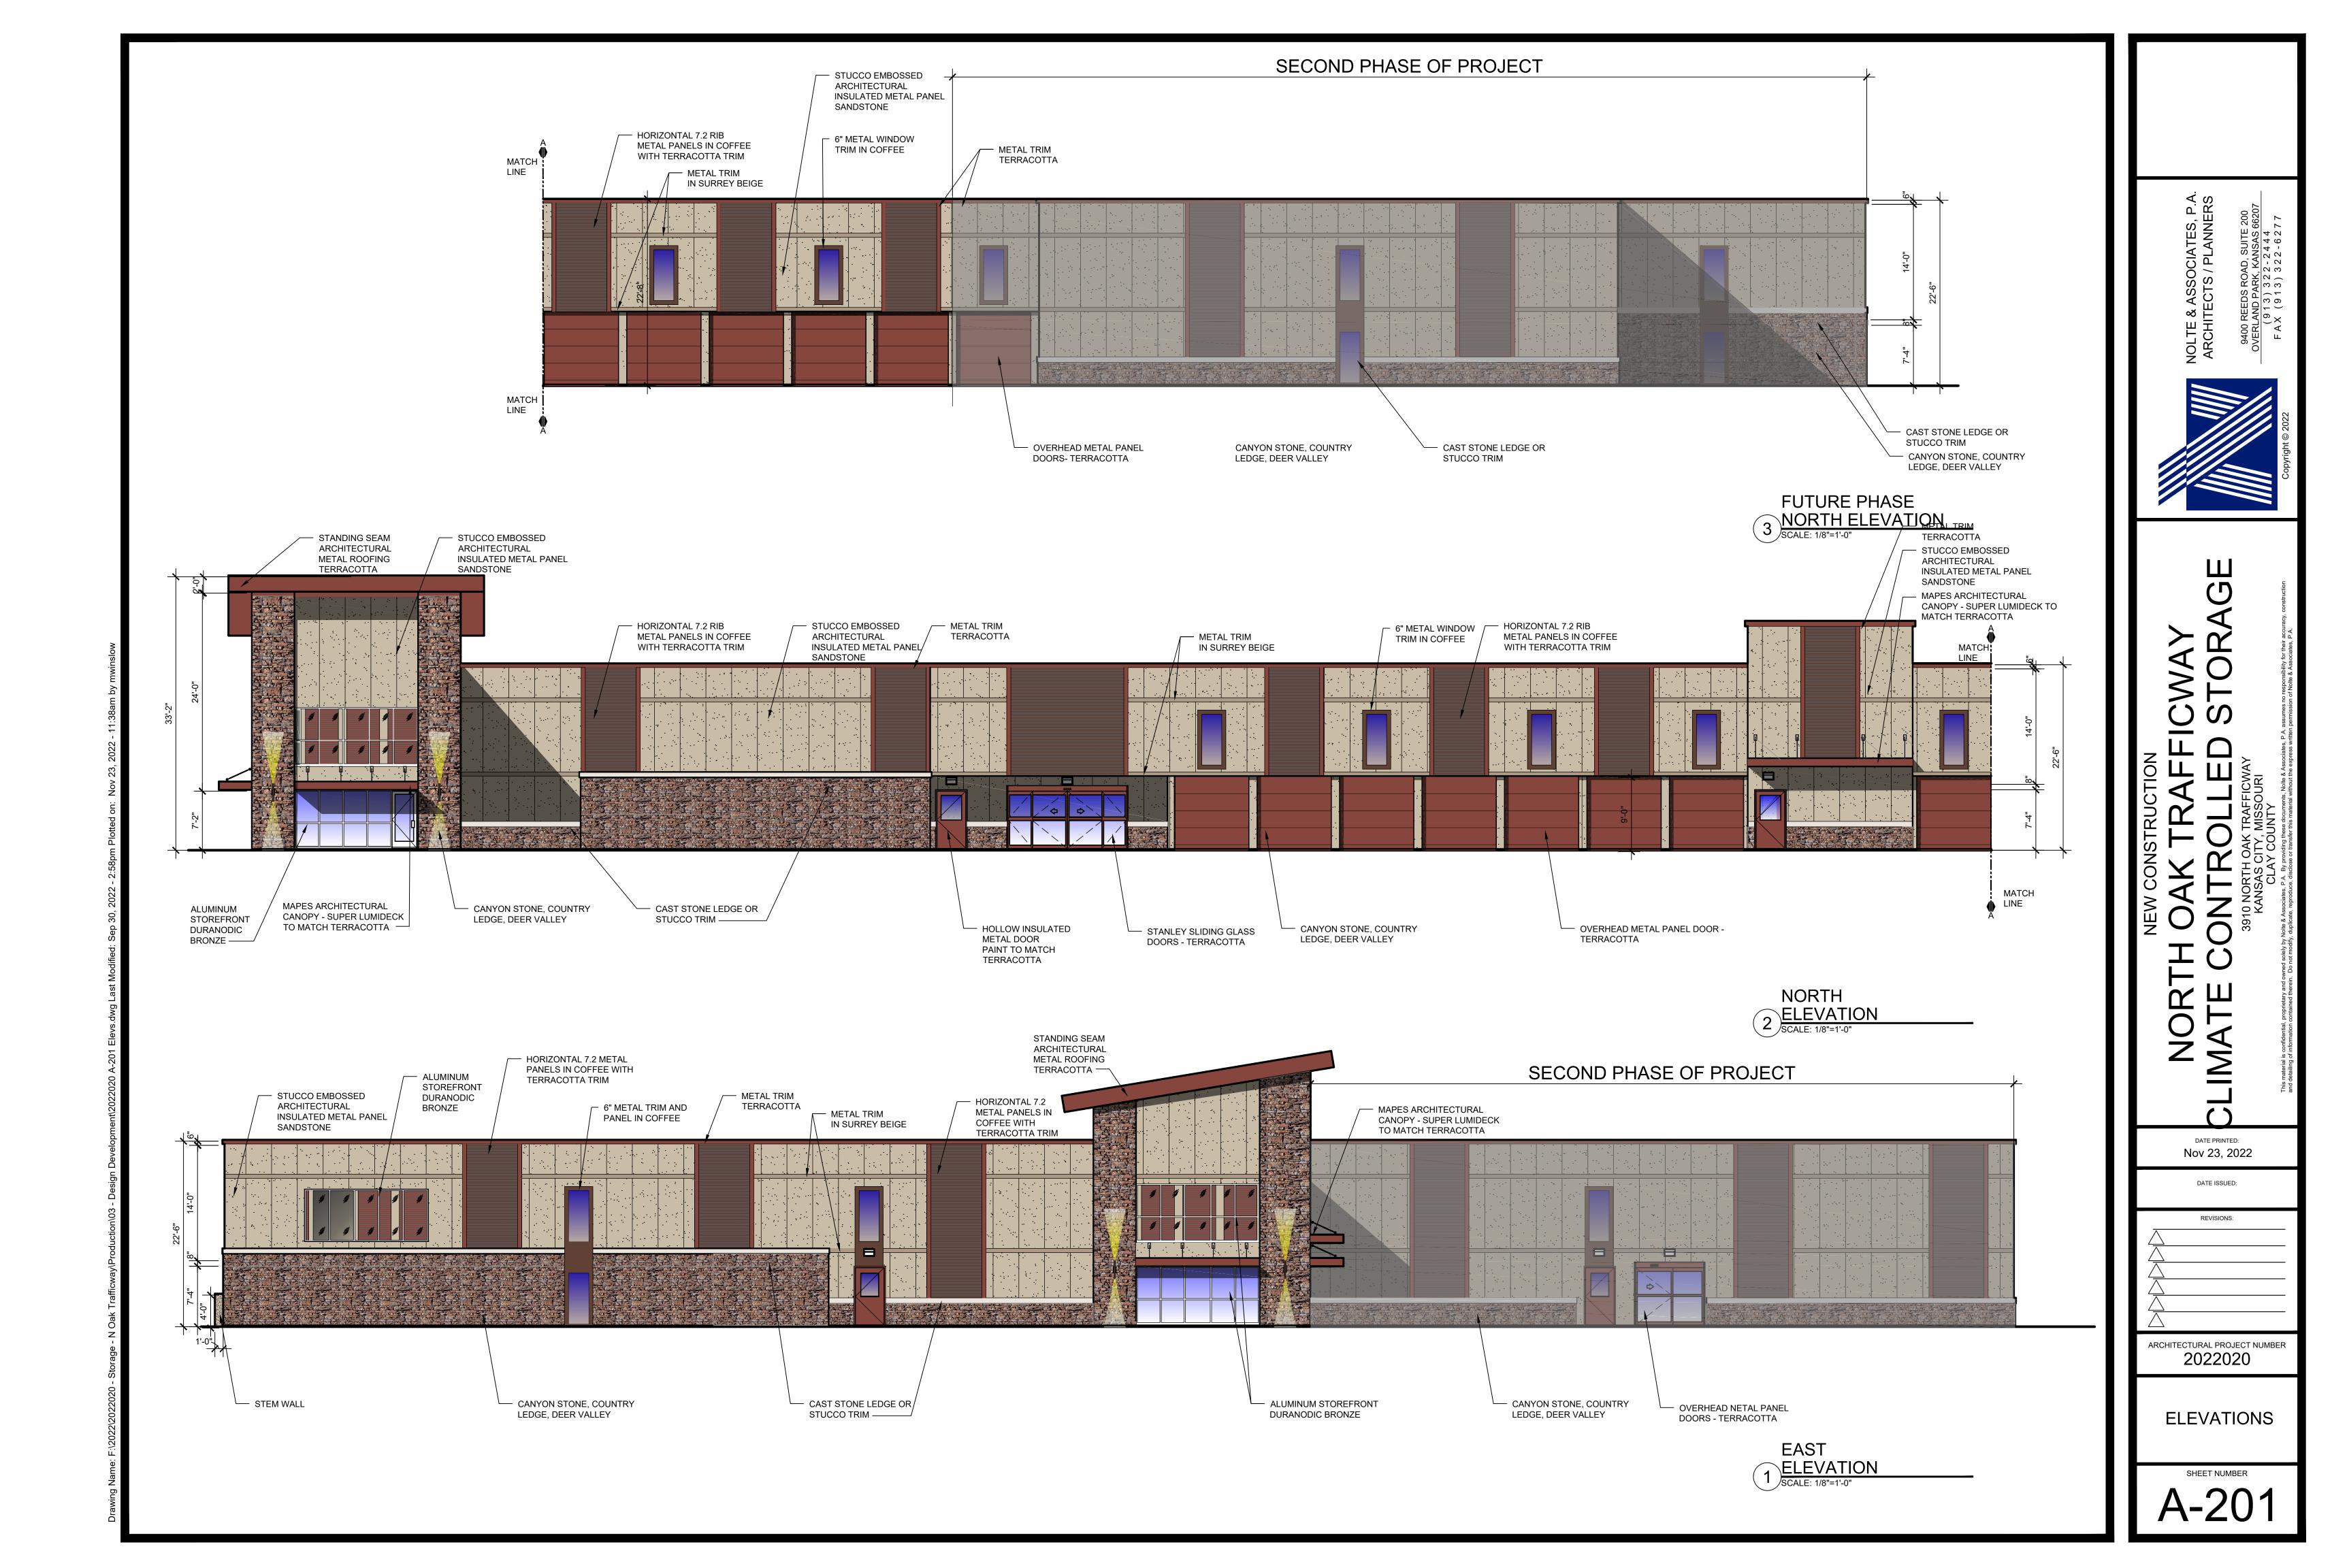

NORTH
ELEVATION
SCALE: 1/8"=1'-0"

NOLTE & ASSOCIAT ARCHITECTS / PLA ASCOCIAT ARCHITECTS / PLA 9400 REEDS ROAD, SU OVERLAND PARK, KANS (913) 322-24 FAX (913) 322-24

STORAGE
SHOWN Their accuracy, construction

NTROLLED ST
TO NORTH OAK TRAFFICWAY
KANSAS CITY, MISSOURI
CLAY COUNTY

3910 NORTH OAK
KANSAS CITY,
CLAY COI
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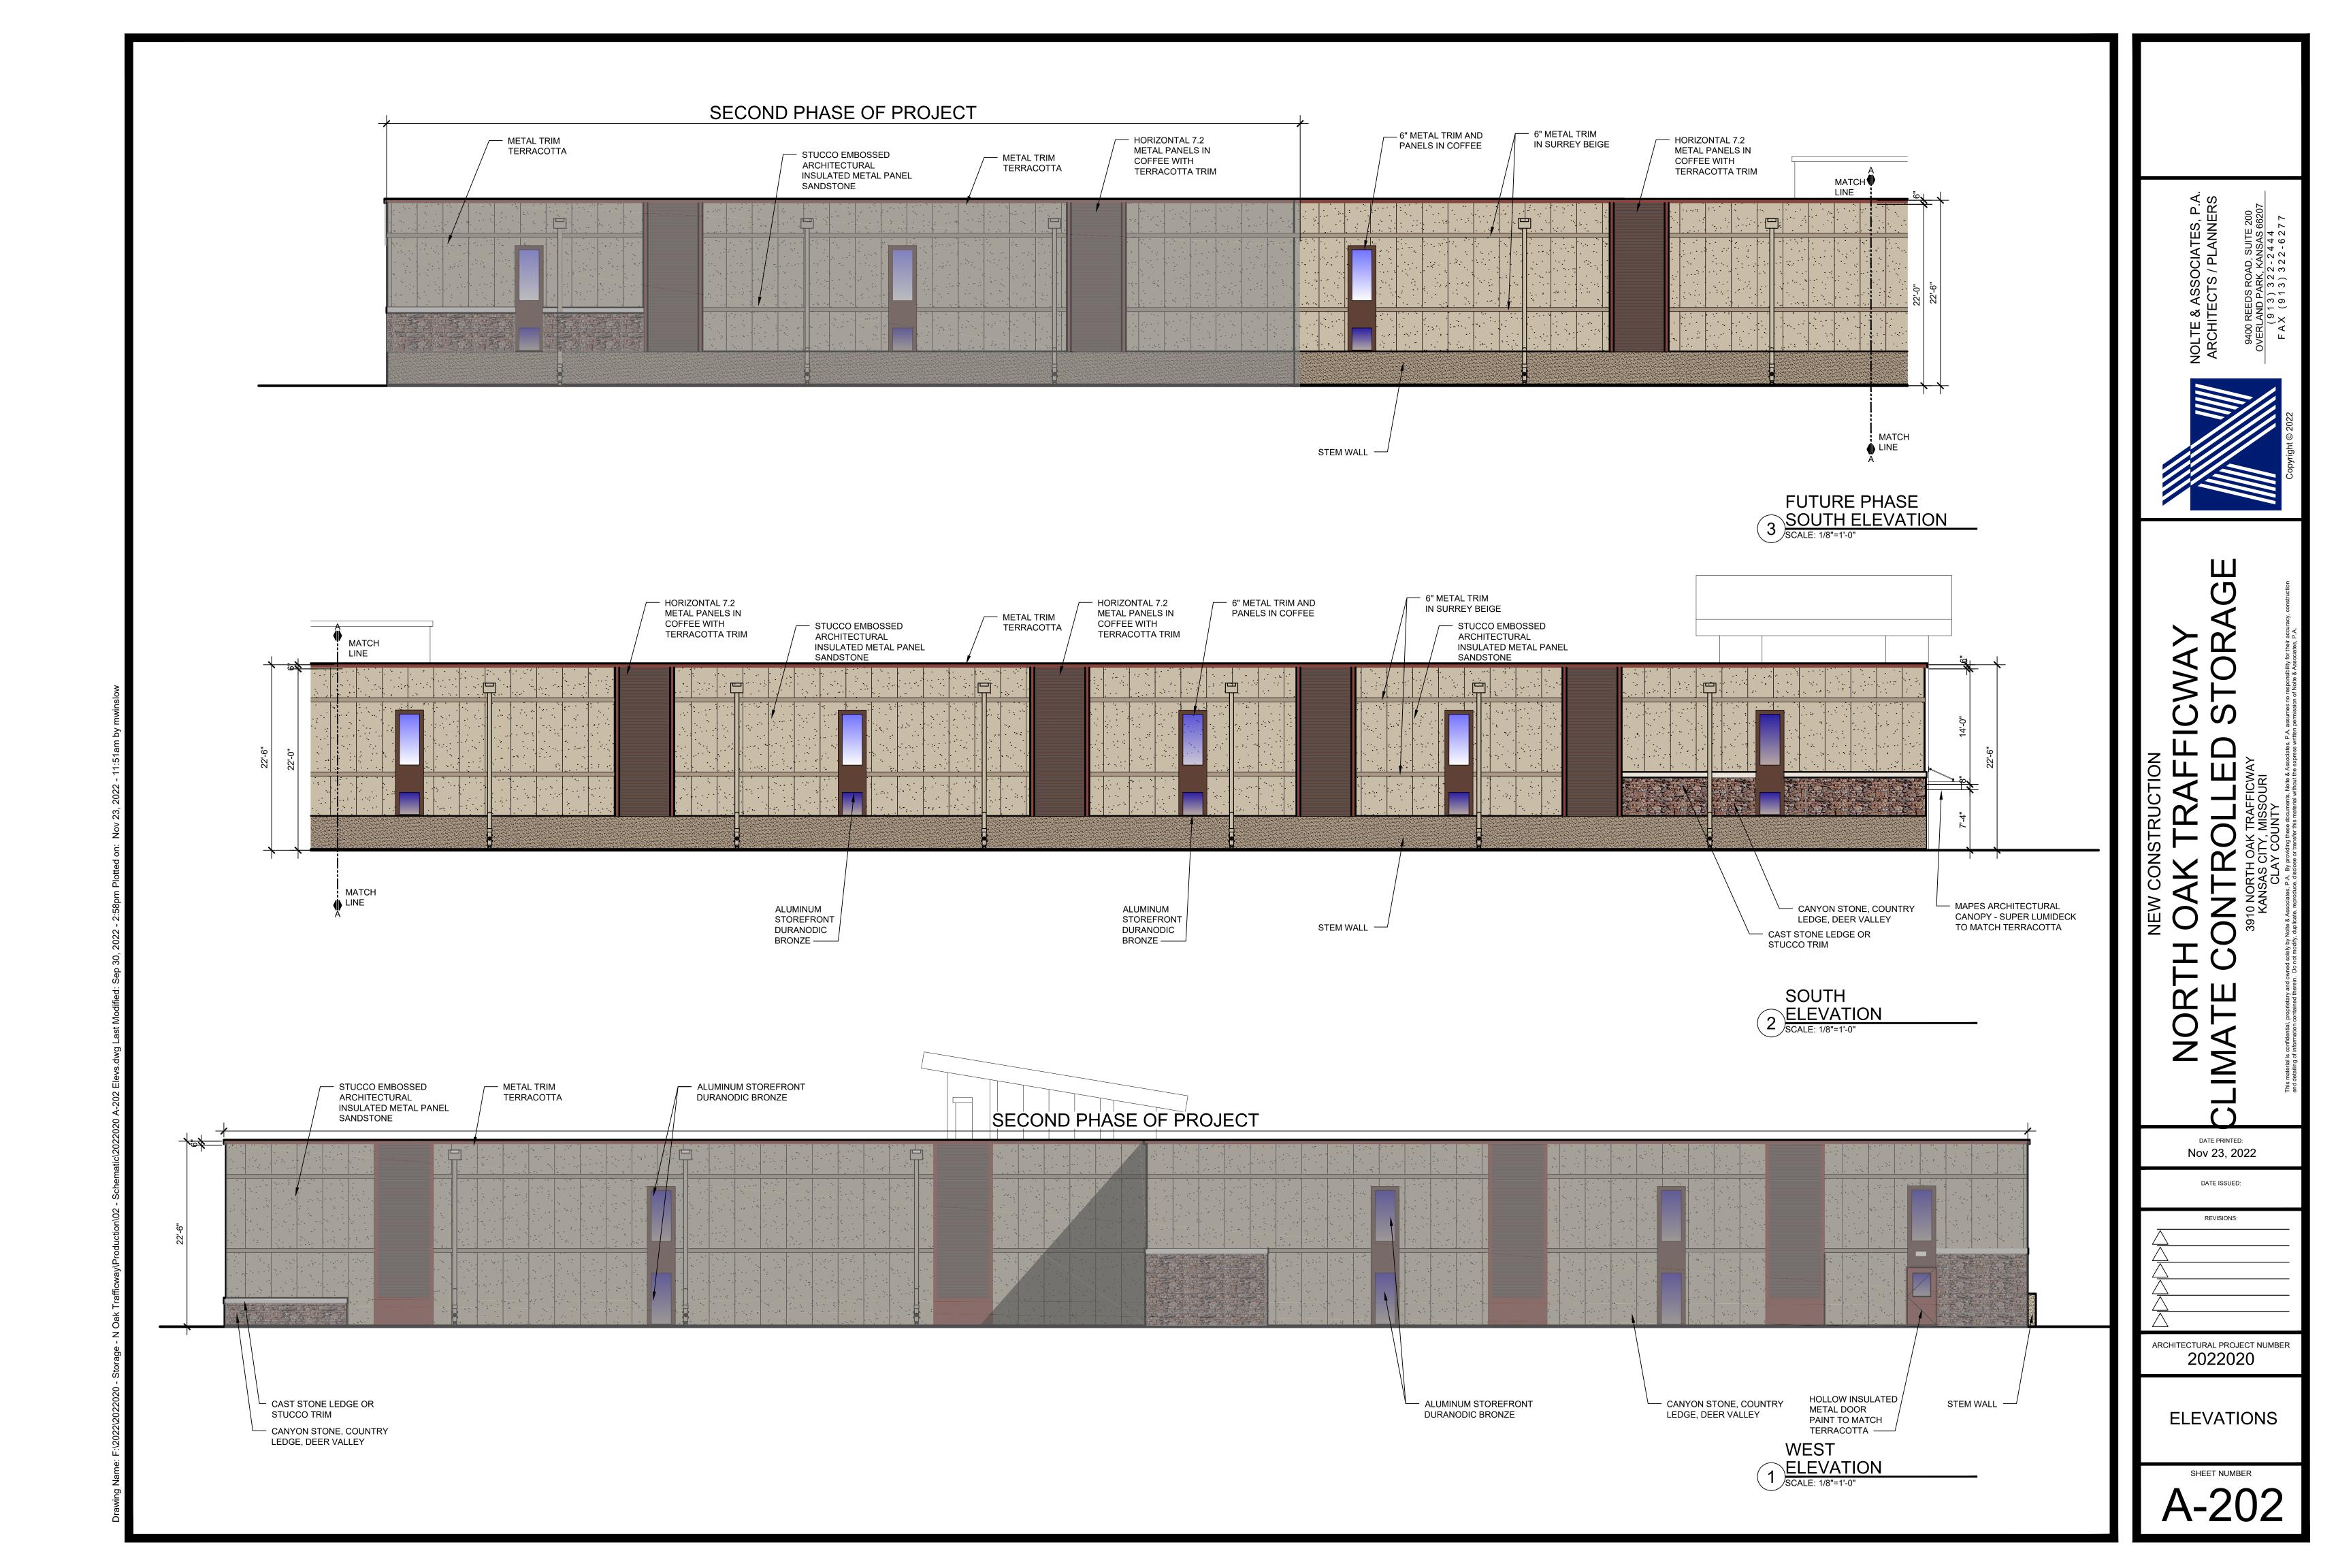
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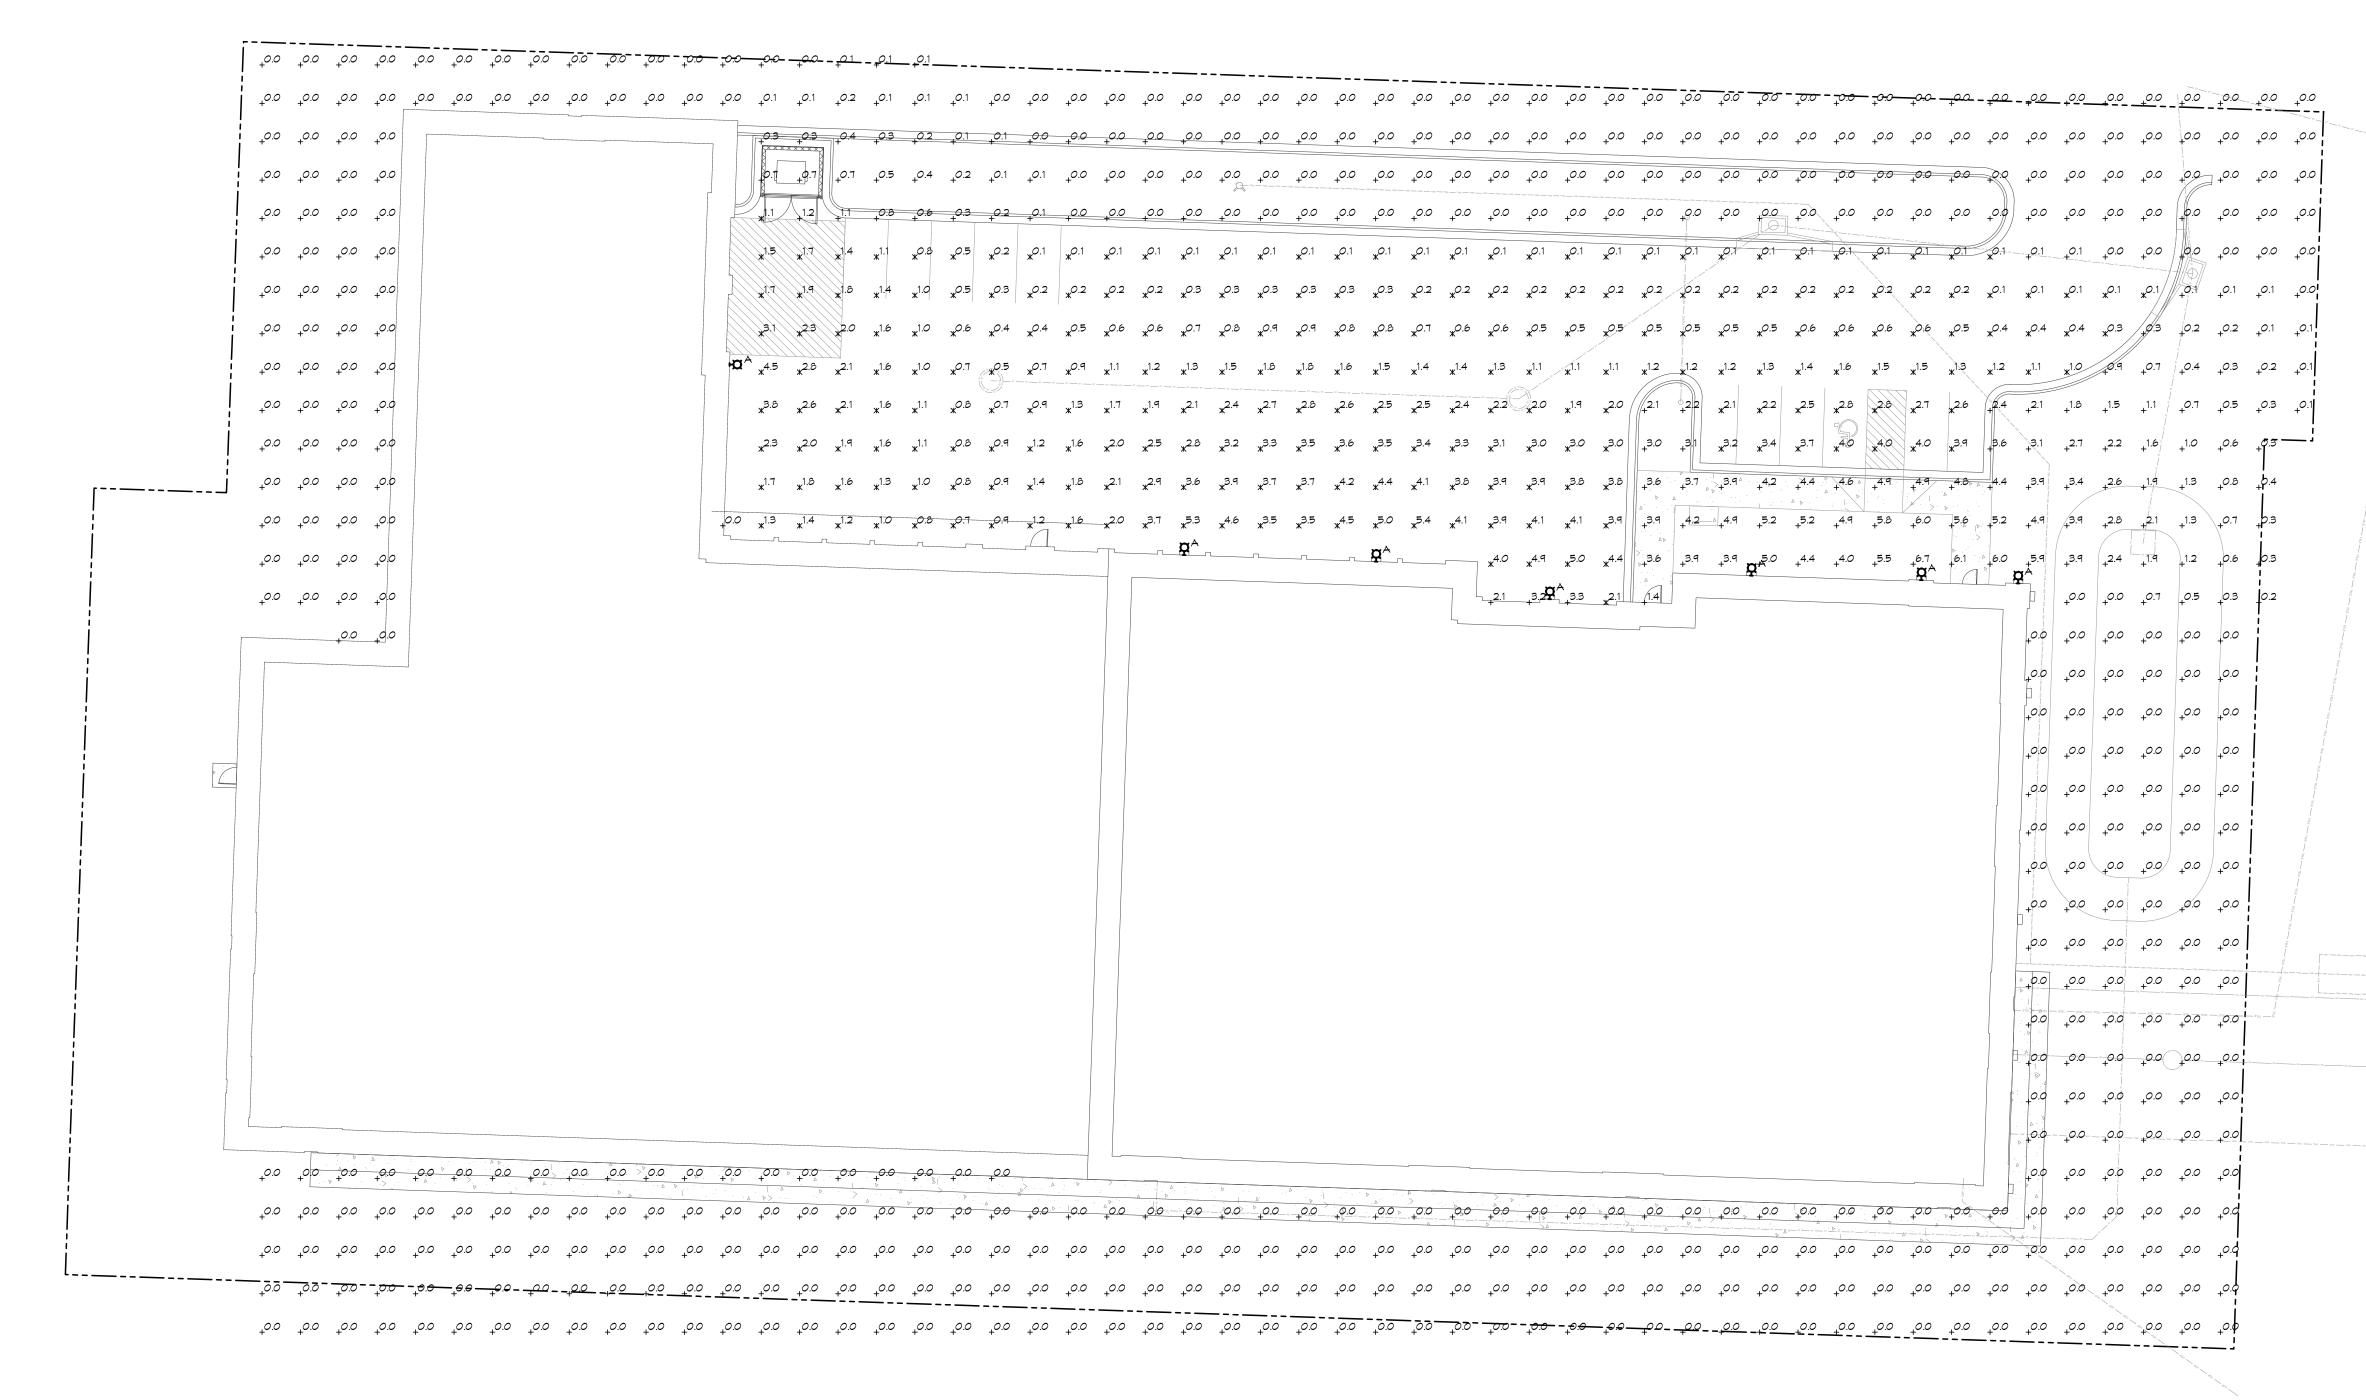
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PHASE 1
NORTH & EAST
ELEVATIONS

SHEET NUMBER


A-203





ELECTRICAL PHOTOMETRICS PLAN

SCALE: 1" = 20'-0"

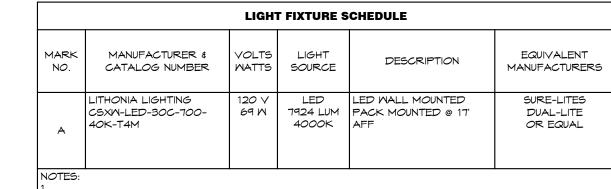

STATISTICAL AREA SUMMARY					
AREA	AVG FC	MAX FC	MIN FC	MAX/MIN	AVG/MIN
PARKING	1.6	5.4	0.1	54.0:1	16.0:1

ENGINEERS

INCORPORATED 5720 Reeder Shawnee, KS 66203

(913)262-1772

PE COA #2009003629

8/15/2022



BC PROJECT #22669

3910 NORTH

ISSUE DATE:
8-15

SHEET TITLE ELECTRICAL PHOTOMETRICS

· MONTAGE II

INDUSTRIAL ORNAMENTAL STEEL FENCE







The Ornamental Iron Standard



As the world's leader in ornamental fencing Ameristar Fence Products continues to deliver value added products that outperform industry standards. Montage II is the preferred choice among owners, architects, and contractors for industrial ornamental fence.

Strength

Montage II is manufactured using a proven fusion welding technology. The welded design of Montage II bonds the industrial pickets at each rail intersection delivering unmatched strength.

Appeal

Montage II is available in multiple styles and heights to match any project requirement. The 1" steel picket design of Montage II delivers a versatile appeal by combining security with aesthetics.

Design

The Montage II ATF (all terrain fence) design can traverse over a 50% grade change. Ameristar's E-Coat coating process protects Montage II from weathering, guaranteeing long lasting beauty and structural integrity providing a 20 year warranty.



We take great pride in manufacturing "Made in the USA" products. Ameristar is located in Tulsa.

Oklahoma and is American owned and operated.

Applications:

- > State Facilities
- Municipal Facilities
- > Airports
- Water Treatment & Storage
- Public Housing Authorities
- Parks & Recreation
- Stadiums & Event Centers
- Schools & Universities
- > Hospitals

Covered by or for use with one or more of the following U.S. patents: 6.811.145, 7.071.439, 7.159.853, 7.282.659, 7.396.002, 7.621.510




MONTAGE II

INDUSTRIAL ORNAMENTAL STEEL FENCE

Panels

Montage II panels are welded using pro-fusion technology, a process proven in the automotive and aerospace industries.

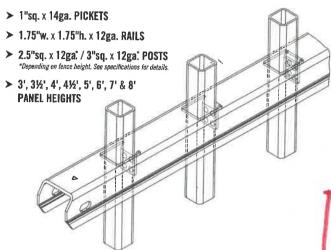

Posts

Posts are manufactured of high tensile steel and are galvanized inside and out for superior corrosion protection.

Brackets

Montage II brackets are designed of high strength stainless steel and accompanied with tamper-proof fasteners. Ameristar's bracketed design allows the contractor to have a flawless installation and helps maintain the integrity of the coating by not welding the panels to the posts.

Gates

Ameristar understands the importance of balancing perimeter security with the highest quality entry control gates. Montage II has a wide variety of Swing, Slide, and Cantilever Gates to match any entry.




Montage II is produced using up to 96% post-industrial recycled steel.

Warranty

Montage II is produced in a state-of-the-art manufacturing facility using the highest quality materials and processes. Ameristar has over 25 years of experience and research in coating and processing of ornamental fence products allowing Montage II to support a 20 year warranty.

Coating

Ameristar has always challenged the industry by developing and producing products with superior coatings. Montage II was developed using E-Coat technology which deposits coatings throughout the entire product, thus eliminating any risk of corrosion where typical powders will not adhere.

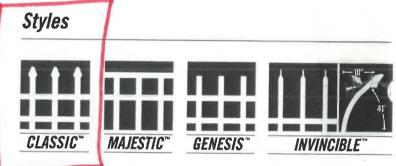



PART# 9790 / REV 05/2013



TRANS PORT

CANTILEVER GATES





THE PREFERRED ENTRY GATE SOLUTION

TransPort Cantilever Gate systems are available for ornamental picket, ornamental pale, chain link, and security mesh applications. TransPort is an all weather cantilever gate utilizing an aluminum track extrusion with internal roller assemblies.

STRENGTH

The gate and track system operate as a single sliding unit. TransPort Cantilever Gates offer superior strength as the track is 60% heavier (by weight) than competitor's extrusions.

VERSATILE

TransPort is a revolutionary cantilever gate system made up of a three components; frame, façade, & hardware. Because of its unique design the TransPort can be easily installed without the use of equipment or excess labor.

MODULAR

Unlike other enclosed-track cantilever gates, TransPort's standard component design made up of top and bottom track, rigid diagonal braces, and uprights make this gate system rigid and well balanced for simplistic functionality.



Applications:

Water Treatment & Storage
Municipal Facilities
Government Facilities
Airports
Manufacturing Plants
Petroleum & Chemical Facilities
Power Plants & Substations
Schools & Universities
Stadiums & Event Centers

Covered by or for use with one or more of the following U.S. patents: 5.136.813, D609551






CANTILEVER GATES

TYPES


TransPort II - 1" Ornamental Picket Design

Matches Montage II, Echelon II, & Aegis II systems
Styles: Classic Majestic, Genesis, Invincible (shown)

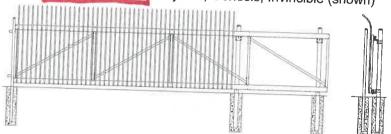

TransPort Estate - 3/4" Ornamental Picket Arched Design Matches Estate Gates


Styles: Classic, Genesis, Majestic (shown)

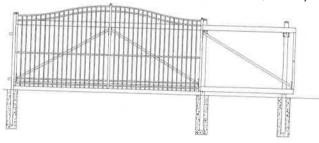

TransPort IS - 2-3/4" Ornamental Pale Design


Matches Impasse

Styles: Gauntlet, Stronghold, Trident (shown)

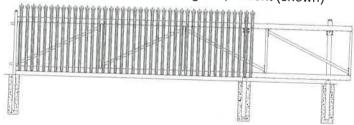


TransPort Link - Chain Link Design

Matches Chain link Fence Construction

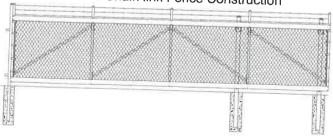


HARDWARE

Unlike other engineered cantilever gates, Transport gates come equipped with 4 internal trollies that distribute the weight of the gate as it is opened an closed.

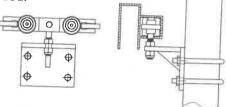

DESIGN

The component design of Ameristar's TransPort Cantilever gate decreases the risk of damage during transit. The new TransPort design does not require a team of installers or machinery to install the gate frame, the cantilever gate can easily be installed with a standard three man crew in about two hours.

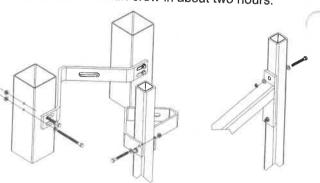

Design Components

Track: 5" x 2" Fast-Trak (top & bottom)
Uprights & Diagonal Bracing: 2" x 1/4" wall

Material: Aluminum (6063 - T6) Minimum 4" x 11ga. gate posts



Effective: 08/2010