

## **CITY PLAN COMMISSION STAFF REPORT**

City of Kansas City, Missouri City Planning & Development Department <u>www.kcmo.gov/cpc</u>

November 7, 2023

### Project Name Hulsing Hotel Addition at KCI

#### Docket # 10

**Request** CD-CPC-2023-00154 Development Plan – Non-Residential

### Applicant

Justin Murray Bell/Knot & Associates

#### Owner

Jeff Pflughoft Hulsing Hotels

Location	11832 NW Plaza Cir.
Area	About 5.1 acres
Zoning	B3-3
Council District	1 <sup>st</sup>
County	Platte
School District	Platte
School District	Platte County R-III

### Surrounding Land Uses

North:NW Cookingham DriveSouth:Lodging, zoned B3-3East:Lodging, zoned B3-3West:Lodging, zoned B3-3

### Major Street Plan

NW Plaza Circle is not identified on the City's Major Street Plan.

### Land Use Plan

The KCI Area Plan recommends commercial/industrial for this location.

### APPROVAL PROCESS



### **PROJECT TIMELINE**

The application for the subject request was filed on 9/18/2023. No scheduling deviations from 2023 Cycle T have occurred.

### **REQUIRED PUBLIC ENGAGEMENT**

Public engagement as required by 88-505-12 does apply to this request. The applicant hosted a meeting on 10/30/2023. A summary of the meeting is attached to the staff report, see Attachment #3.

### **EXISTING CONDITIONS**

The existing 202 room hotel sits on a 5 acres site located between NW 119<sup>th</sup> Terrace and NW Plaza Circle. The hotel is adjacent to several other lodging establishments and within close proximity to KCI.

### SUMMARY OF REQUEST + KEY POINTS

A request to approve a major amendment to an approved development plan to allow for a hotel in district B3-3 on about 5.1 acres generally located at NW Plaza Circle and N. Ambassador Drive.

### **CONTROLLING + RELATED CASES**

Case No. 6217-GP: Rezoned 225 acres from District GP-7 to Districts GP-1 and GP-2 (Ord. No. 40301, passed October 22, 1971).

**Case No. 6217-GP-9**: On August 5, 1997 the City Plan Commission approved a plan amendment on approximately 225 acres generally located on the S.E. corner of I-29 and MO Highway 291 in Districts GP-2 (General Transient Retail Business) and GP-1 (General Industry) to allow a 73 room expansion to the existing 202 room Holiday Inn hotel (**Ord. No. 971315**, passed October 9, 1997).

**Case No. 6217-GP-12**: The City Plan Commission approved an amendment for the purpose of deleting roughly 13.5 acres from the development plan (**Ord. No. 010228**, passed March 10, 2001).

### PROFESSIONAL STAFF RECOMMENDATION

Docket # Recommendation

10 APPROVAL WITH CONDITIONS

#### **PLAN REVIEW**

The applicant is proposing a 100 room, four-story tower addition to an existing hotel immediately east of KCI and Interstate 29. The architecture and design of the new tower will complement the existing five-story, 202 room mid-century style of the south tower. The new tower will be located on the northern perimeter of the site which will provide relief from the northern wind in the winter and early spring. The addition will also create a more defined courtyard and outdoor pool area.

#### PLAN ANALYSIS

The proposed plan complies with the Zoning and Development Code, the KCI Area Plan and all other applicable City standards and policies. The applicant is proposing pedestrian circulation improvements along the southern perimeter of the site and providing a stronger connection to N. Ambassador Drive.

Standards	Applicability	Meets	More Information
Lot and Building Standards (88-120)	Yes	Yes	
Parking and Loading Standards (88-420)	Yes	Yes	
Landscape and Screening Standards (88-425)	Yes	Yes, subject to conditions	
Outdoor Lighting Standards (88-430)	Yes	Yes, subject to conditions	
Sign Standards (88-445)	Yes	Yes, subject to conditions	
Pedestrian Standards (88-450)	Yes	Yes	

#### SPECIFIC REVIEW CRITERIA

#### Development Plans, Project Plan, or Site Plan (88-516-05)

In order to be approved, a development plan, project plan, or site plan must comply with all of the following criteria:

A. The plan must comply with all standards of the Zoning and Development Code and all other applicable City ordinances and policies;

The proposed plan complies with all standards of the Zoning and Development Code and all other applicable City ordinances and policies.

B. The proposed use must be allowed in the district in which it is located;

The proposed use, lodging is permitted within the B3-3 zoning district.

- C. Vehicular ingress and egress to and from the site, and circulation within the site must provide for safe, efficient, and convenient movement of traffic not only within the site but on adjacent roadways; The applicant is providing a new ingress and egress point on the northwest corner of the site. This will allow for improved and balanced access for guests who will be lodging in the proposed northern tower. The new access point will also provide KCFD with greater access to serve the site.
- D. The plan must provide for safe, efficient, and convenient non-motorized travel opportunities, being pedestrian and bicycle movement, on the subject site;

The applicant is proposing pedestrian circulation improvements along the perimeter including a new sidewalk connection. Other improvements are within the interior of the site to promote pedestrian safety within the parking area. All improvements shall comply with the 88-450 (Pedestrian Standards) of the Zoning and Development Code.

E. The plan must provide for adequate utilities based on City standards for the particular development proposed.

The plan will provide for adequate utilities based on City standards for the proposed north tower.

- F. The location, orientation, and architectural features, including design and material, of buildings and other structures on the site must be designed to be compatible with adjacent properties. The applicant will be matching the mid-century style of the existing tower located on site.
- G. Landscaping, berms, fences, and/or walls must be provided to buffer the site from undesirable views, noises, lighting, or other off-site negative influences and to buffer adjacent properties from negative influences that may be created by the plan.

The current hotel is adjacent to several other lodging establishments, Interstate 29 and NW Cookingham Drive. The proposed additional tower is not anticipated to create any undesirable views, noises, lighting or other off-site negative influences. The proposed north tower will provide visual relief and establish a more intimate courtyard for guests to enjoy.

H. The design of streets, drives, and parking areas within the project should result in a minimum of area devoted to asphalt or other impervious surfaces consistent with the needs of the project and city code requirements.

The proposed design does include a new parking area on the northern perimeter of the site, adding a total of thirty-five new parking stalls. The new parking area also allows greater access for emergency personnel.

 The plan must identify trees to be removed and trees to be preserved during the development of the subject property with the goal of saving trees that are not required to be removed for the development of the property.

Four to six trees will be removed for the construction of the proposed addition, but the applicant will be planting thirty new trees on the site.

#### ATTACHMENTS

- 1. Conditions Report
- 2. Applicants Submittal
- 3. Public Engagement Materials

#### **PROFESSIONAL STAFF RECOMMENDATION**

City staff recommends APPROVAL WITH CONDITIONS as stated in the conditions report.

Respectfully Submitted,

den Chrike -1

Andrew Clarke, AICP Planner



### **Plan Conditions**

Report Date: November 02, 2023 Case Number: CD-CPC-2023-00154 Project: Hulsing Hotel Addition at KCI

Condition(s) by City Planning and Development Department. Contact Andrew Clarke at (816) 513-8821 / Andrew.Clarke@kcmo.org with questions.

- 1. The developer shall screen all roof and/or ground mounted mechanical and utility equipment in compliance with 88-425-08.
- 2. The developer shall submit an affidavit, completed by a landscape architect licensed in the State of Missouri, verifying that all landscaping required of the approved plan has been installed in accordance with the plan and is healthy prior to Certificate of Occupancy.
- 3. The developer shall submit an affidavit, prepared by an engineer licensed in the State of Missouri, verifying that all outdoor lighting has been installed in accordance with approved plans and that lighting levels do not exceed that shown on the approved lighting plan at the property lines prior to Certificate of Occupancy.
- 4. All signage shall conform to 88-445 and shall require a sign permit prior to installation.
- 5. The developer shall submit an affidavit, completed by a landscape architect licensed in the State of Missouri, verifying that street trees have been installed in accordance with the approved street tree planting plan and are healthy prior to Certificate of Occupancy.

## Condition(s) by City Planning and Development Department. Contact Terry Thomas at (816) 513-2510 / Terry.A.Thomas@kcmo.org with questions.

- 6. The developer shall submit a storm drainage analysis from a Missouri-licensed civil engineer to the Land Development Division, in accordance with adopted standards, including a BMP level of service analysis prior to approval and issuance of any building permits, and that the developer secure permits to construct any improvements as required by the Land Development Division prior to issuance of any certificate of occupancy.
- 7. The developer shall submit a streetscape plan for approval and permitting by the Land Development Division prior to beginning construction of the streetscape improvements in the public right of way, and construct ADA compliant ramps at all required locations where new private drives are being added, or where existing sidewalks are modified or repaired.
- 8. The developer shall submit verification of vertical and horizontal sight distance for the drive connection to public right-of-way to the Land Development Division and make improvements to ensure local jurisdiction and/or minimum AASHTO adequate sight distance standards are met, prior to issuance of any certificate of occupancy.
- 9. The developer shall submit plans for grading, siltation, and erosion control to Land Development Division for review and acceptance, and secure a Site Disturbance permit for any proposed disturbance area equal to one acre or more prior to beginning any construction activities.
- 10. The developer shall provide acceptable easements for any deep sewers where proposed fill is added or where the sewer will be further obstructed by surface improvements and that a structural analysis be provided to confirm adequate structural integrity for the proposed loading conditions of this plan, and secure permits and provide City approved executed and recorded easement prior to adding fill or constructing surface obstructions as required by Land Development Division.
- 11. The developer shall grant a BMP and/or Surface Drainage Easement to the City as required by the Land Development Division, prior to recording the plat or issuance of any building permits.

Condition(s) by Fire Department. Contact Michael Schroeder at (816) 513-4604 / michael.schroeder@kcmo.org with questions.

- 12. The shall meet the fire flow requirements as set forth in Appendix B of the project International Fire Code 2018. (IFC-2018 § 507.1)
- 13. Fire hydrants shall be installed and operable prior to the arrival of any combustible building materials onto the site. (IFC-2018 § 501.4 and 3312.1; NFPA 241-2013 § 8.7.2)
  - Fire hydrant distribution shall follow IFC-2018 Table C102.1

#### Condition(s) by Fire Department. Contact Michael Schroeder at (816) 513-4604 / michael.schroeder@kcmo.org with questions.

- 14. Buildings equipped with a fire standpipe system shall have an operable fire hydrant within 100 feet of the Fire Department Connection (FDC). (IFC2018 § 507.5.1.1)
- A required fire department access roads shall be an all weather surface. (IFC-2012: § 503.2.3)
  Fire Department access roads shall be provided prior to construction/demolition projects begin. (IFC-2018 § 501.4 and 3310.1; NFPA 241-2013 § 7.5.5)
  - Required fire department access roads shall designed to support a fire apparatus with gross axle weight of 85,000 pounds. (IFC-2018: § 503.2.3)
  - Shall provide fire lane signage on fire access drives.
- 16. Aerial Fire Apparatus access roads shall be provided for any building that is 30 feet in height or greater. Aerial Fire Apparatus Roads are a minimum 26 feet wide, at least 15 feet away from the building but not more than 30 feet from the structure. (IFC-2018 § D105).

## Condition(s) by Water Services Department. Contact Heather Massey at (816) 513-2111 / heather.massey@kcmo.org with questions.

- 17. Branch service lines one-and-one-half inches and larger in diameter for domestic water services or fire protection lines shall be connected to the main by cutting in a minimum 6" branch service tee, installing three gate valves, and two solid sleeves on the main. Line valves on the main shall be the same nominal size as the main.
- The developer shall ensure that water and fire service lines should meet current Water Services Department Rules and Regulations. Prior to C of O. https://www.kcwater.us/wp-content/uploads/2022/05/2022-Rules-and-Regulations-for-Water-Service-Lines-Final.pdf
- The developer shall have a water flow test done to ensure there is adequate water pressure to serve the development. South of River contact - Bryan Wagner 816-513-0275 North of River contact - Pedro Colato 816-513-4892

Condition(s) by Water Services Department. Contact Kirk Rome at (816) 513-0368 / kirk.rome@kcmo.org with questions.

20. The developer shall upsize/replace approx. 400' of existing 6" public water main in NW 119th Terrace to 12" DIP from the new service connection east to the tee in N Ambassador Drive to provide the required domestic and fire flows to meet projected demands, and add fire hydrants as-needed to meet WSD spacing requirements. The developer must submit water main extension and public fire hydrant drawings prepared by a registered professional Engineer in Missouri to the main extension desk for review, acceptance and contracts per the KC Water Rules and Regulations for Water main extensions and Relocations.

(https://www.kcwater.us/wp-content/uploads/2022/05/2022-Rules-and-Regulations-for-Water-Main-Extensions-Final2.pdf).








Client: Hulsing ENTERPRISES, LLC
Project Title / Address: KCI New Tower and Hotel Refresh
11832 NW Plaza Cir Kansas City MO 64153
Architect: Bell/Knott Bell/Knott Bell/Knott Bell/Knott Bell/Knott Bell/Knott Bell/Knott Structural Line Road Structural Consultant: Bell/Knott Voice: 913.378.1600 Fax: 913.378.1601 www.bellknott.com Bell/Knott Fax: 913.378.1601 www.bellknott.com
4338 Belleview Ave. 816.531.4144 Kansas City, MO 64111 www.bdc-engrs.com
5720 Reeder St.       913-262-1772         bawnee, KS 66203       913-262-1772
Civil Consultant:
KAVV VALLEY ENGINEERING 14700 WEST 114TH TERRACE LENEXA, KANSAS 66215 PH. (913) 894-5150   FAX (913) 894-5977 lx@kveng.com   www.kveng.com
Landscaping Consultant: <b>Consultant:</b> <b>Consultant:</b> <b>Consultant</b>
Seal: USTALA NUMBER A-2006025507
Revisions: I – CITY REVIEW RESPONSE I 0/13/2023
Issue Date:9/13/2023Reason for Issue:Review
ReviewProject Number: <b>22-056</b>
Project Phase: <b>Dev Plan Review</b> Sheet Title:
Cover Sheet

Pkg: Sheet Number -05 22

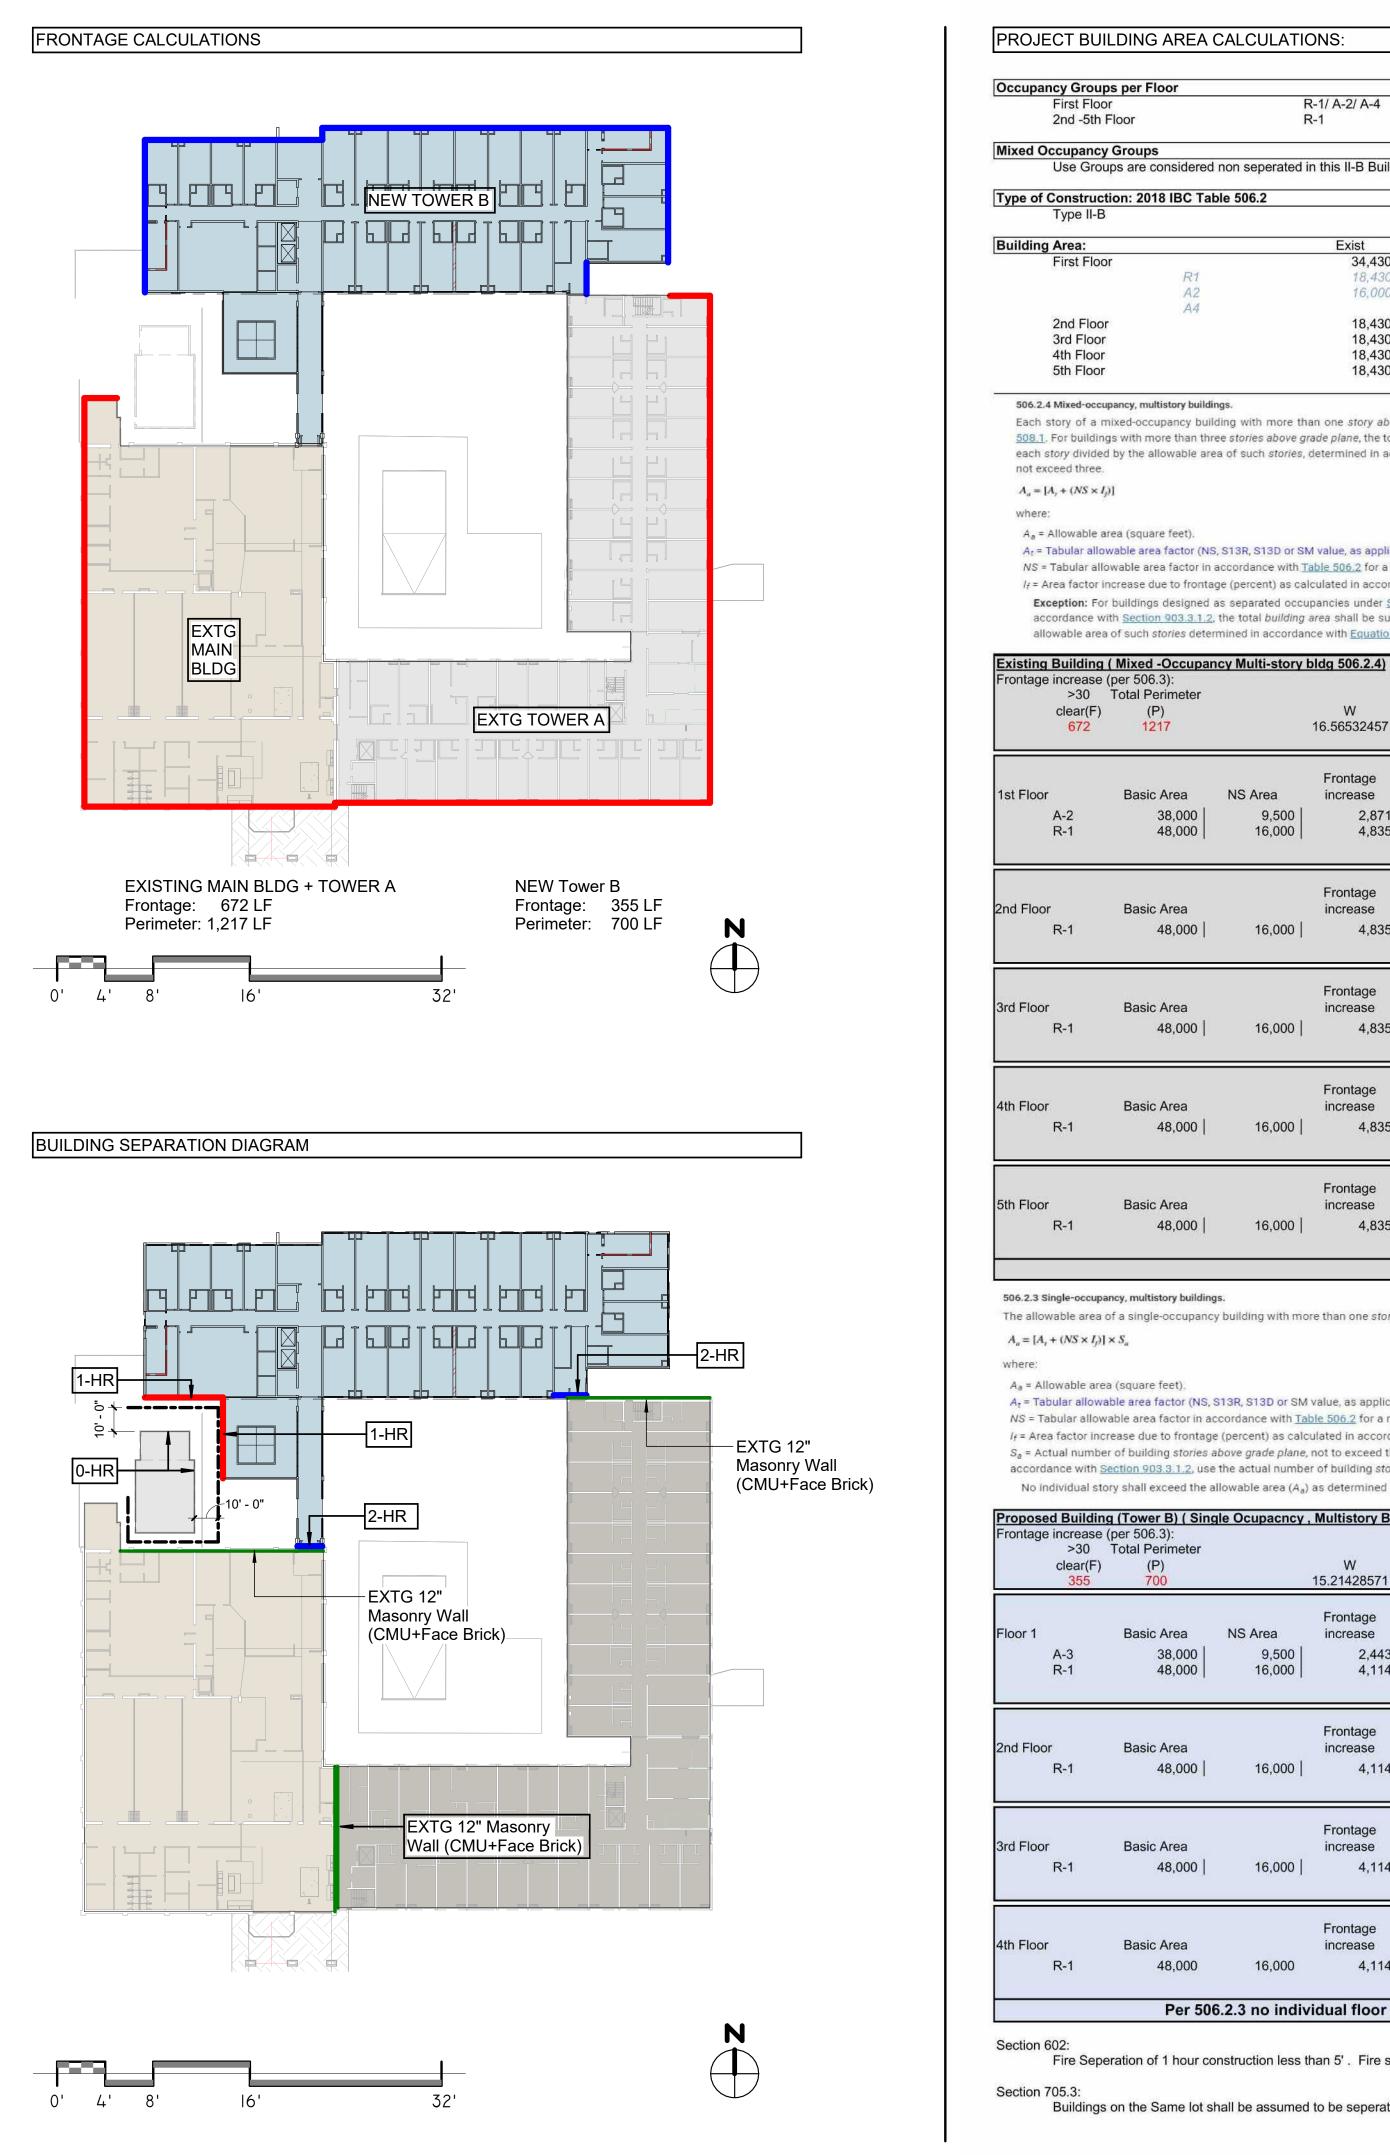

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JILDING AREA C	ALCULATIONS:			
ups per Floor				
bor	R-1/ A-2/ A-4			2,
h Floor	R-1			
cy Groups				
oups are considered n	on seperated in this II-B Buildir	ng		
ction: 2018 IBC Tabl	e 506.2			
·B				
	Exist	Proposed	Total	
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R1	18,430	14.670	and a second	

	A2	16,000		
	A4		1,050	
or		18,430	14,010	32,440
or		18,430	14,010	32,440
or		18,430	14,010	32,440
or		18,430		

Each story of a mixed-occupancy building with more than one story above grade plane shall individually comply with the applicable requirements of Section 508.1. For buildings with more than three stories above grade plane, the total building area shall be such that the aggregate sum of the ratios of the actual area of each story divided by the allowable area of such stories, determined in accordance with Equation 5-3 based on the applicable provisions of Section 508.1, shall

(Equation 5-3)

At = Tabular allowable area factor (NS, S13R, S13D or SM value, as applicable) in accordance with Table 506.2. NS = Tabular allowable area factor in accordance with Table 506.2 for a nonsprinklered building (regardless of whether the building is sprinklered).

If = Area factor increase due to frontage (percent) as calculated in accordance with Section 506.3.

Exception: For buildings designed as separated occupancies under Section 508.4 and equipped throughout with an automatic sprinkler system installed in accordance with Section 903.3.1.2, the total building area shall be such that the aggregate sum of the ratios of the actual area of each story divided by the allowable area of such stories determined in accordance with Equation 5-3 based on the applicable provisions of Section 508.1, shall not exceed four.

Fotal Perimeter (P) <mark>1217</mark>		W 16.56532457	l=(f/p25) 0.30217			
Basic Area	NS Area	Frontage increase	Sprinkler increase	Allowable Area/Floor	Existing Floor Area (unchanged)	Rati
38,000   48,000	9,500   16,000	2,871 4,835	na   na	40,871 52,835	16,130.0 17,710.0	0.3 0.3
					Floor Ratio :	0.73
Basic Area 48,000	16,000	Frontage increase 4,835	Sprinkler increase na	Allowable Area/Floor 52,835	Existing Floor Area (unchanged) 17,710	Ratio 0.34
					Floor Ratio :	0.3
Basic Area 48,000	16,000	Frontage increase 4,835	Sprinkler increase na	Allowable Area/Floor 52,835	Existing Floor Area (unchanged) 17,710 <b>Floor Ratio</b> :	Ratio 0.34 <b>0.3</b> 4
Basic Area 48,000	16,000	Frontage increase 4,835	Sprinkler increase na	Allowable Area/Floor 52,835	Existing Floor Area (unchanged) 17,710	Rati
					Floor Ratio : Existing Floor	0.3
Basic Area 48,000	16,000	Frontage increase 4,835	Sprinkler increase na	Allowable Area/Floor 52,835	Area (unchanged) 17,710	Ratio
					Floor Ratio :	0.3
			Total Ratio: (	= less than 4, Exis	ting DOES Comply)	2.07
cy, multistory building	5		Total Natio.	- 1035 (1101 4, EXIS		-

(Equation 5-2)

At = Tabular allowable area factor (NS, S13R, S13D or SM value, as applicable) in accordance with Table 506.2.

NS = Tabular allowable area factor in accordance with Table 506.2 for a nonsprinklered building (regardless of whether the building is sprinklered). If = Area factor increase due to frontage (percent) as calculated in accordance with Section 506.3.

Sa = Actual number of building stories above grade plane, not to exceed three. For buildings equipped throughout with an automatic sprinkler system installed in accordance with Section 903.3.1.2, use the actual number of building stories above grade plane, not to exceed four. No individual story shall exceed the allowable area ( $A_a$ ) as determined by Equation 5-2 using the value of  $S_a = 1$ .

ina	(Tower B) (Sing	le Ocupacnov	Multistory Bldg	506.2.3)			
e (	per 506.3): Total Perimeter (P)		W	I=(f/p25)	*w/30)		
'	700		15.21428571	0.25714			
			Frontage	Sprinkler	Allowable	Proposed Area	
	Basic Area	NS Area	increase	increase	Area/Floor	Floor	Ratio
	38,000 48,000	9,500   16,000	2,443   4,114	na na	40,443 52,114	1,050 14,720	0.03 0.28
						Total Ratio = less than 1, OK	0.31
			Frankson	Casialdaa	Allawahla	Deserved Area	
	Basic Area		Frontage increase	Sprinkler increase	Allowable Area/Floor	Proposed Area Floor	Ratio
	48,000	16,000	4,114	na	52,114	14,010	0.27
	10,000	10,000 [	.,	ine [		Total Ratio = less than 1, OK	0.27
_							
			Frontage	Sprinkler	Allowable	Proposed Area	202 000
	Basic Area		increase	increase	Area/Floor	Floor	Ratio
	48,000	16,000	4,114	na	52,114	14,010	0.27
						Total Ratio = less than 1, OK	0.27
			Frontage	Sprinkler	Allowable	Proposed Area	
	Basic Area		increase	increase	Area/Floor	Floor	Ratio
	48,000	16,000	4,114	na	52,114	14,010	0.27
						Total Ratio = less than 1, OK	0.27
	Per 506	6.2.3 no indiv	vidual floor sha	all exceed S <sub>s</sub>	>1.0, Propos	sed DOES Comply	
-							

Fire Seperation of 1 hour construction less than 5'. Fire seperation of 10' or greater is 0-hour

Buildings on the Same lot shall be assumed to be seperated by an immaginary line between them. 705.6

### PROJECT DESCRIPTION:

### City, MO 64130. The project consists of one building to be constructed of II-E groups of R-1 (A-3 ACCESSORY).

### LOCAL ADOPTED CODES

- New Building of Construction Type II-B. Building designed as non-separated and separated use
- Egress system complying with the 2018 IBC.
- Fully automatic sprinkler system with alarm supervision • Portable fire extinguishers to be provided.
- Smoke detection at HVAC units were applicable.
- Automatic shutdowns at HVAC units where applicable. • Emergency power for exit lighting and exit signage.


### Exit Width 2018 IBC Section 1005

- 1. Lock or Latch, 2018 IBC 1008.1.9: Exit doors shall I inside without the use of a key or any special knowl operated edge or surface mounted flush bolts are p 2. Floor Level at Doors, 2018 IBC 1008.1.5: Regardle
- there shall be a floor or landing on each side of doo doorways shall not exceed 0.5 inches. Thresholds shall be beveled.
- 3. Landings at Doors, 2018 IBC Section 1008.1.6: Lar not less than the width of the stairway or the width the greater. Doors in the fully open position shall no dimension by more than 7 inches. When landings s of 50 or more, doors in any position shall not reduc than one half its required width. Landings shall hav the direction of travel of not less than 44 inches.

- 1. Where Required: When two or more exits from a s exit signs shall be installed. Exit signs shall be read direction of approach. Exit signs shall be located a indicate the direction of egress travel. No point sha from the nearest visible sign.
- 2. Graphics: The color and design of lettering on exit contrast with their background. Words on the sign s inches in height with a stroke of not less than 3/4 in
- 3. Illumination: Signs shall be internally illuminated by shall be of an approved self-luminous type. Exit sig at all times.
- 4. Power Source: To ensure continued illumination for than 90 minutes in case of primary power loss, the shall be connected to an emergency power system

		7
		Client:
PROJECT DESCRIPTION:	BASIC BUILDING CODE REQUIREMENTS	Hulsing ENTERPRISES, LLC
The NEW GUEST TOWER B addition is located at 11832 NW Plaza Circle Kansas City, MO 64130.	CONSTRUCTION TYPE: II-B Occupancy Groups:	ENTERPRISES, LLC
The project consists of one building to be constructed of II-B construction with use	Floor 1 R-1 (A-3 Accessory) Floors 2,3,4 R-1	
groups of R-1 (A-3 ACCESSORY). The first floor will consist of R-1 (A-3 ACCESSORY) occupancies per Section 508.3.	<u>Occupancy Groups:</u> The building will be considered R-1.	Project Title / Address:
Floors 2 through 4 The second floor will be separated from the first floor per Section 508.4 with B occupancy.	Type of Construction: 2018 IBC Table 503	Project Title / Address:
The building will be fully sprinklered. (All existing buildings are fully sprinklered)	Type II-B <u>Building Area:</u> 2018 IBC Table 503	KCI New Tower and Hotel Refresh
The new building is within allowable areas and proposed construction types per calculations below.	Total Gross Building Area is 57,830 SF.	noteritentesh
The facility will be provided with exits as required by the 2018 International Building Code.	1st Floor is       15,770 SF.         2nd - 4th Floor ea. is       14,010 SF.	11832 NW Plaza Cir
	SprinklerFrontageTotal AllowableProposedAllowable AreaIncreaseArea/FloorArea/FloorR-148,000 SFPER TABLEPER TABLE57,830 SF	Kansas City MO 64153
LOCAL ADOPTED CODES	PER TABLE 57,830 SF The building is in compliance with allowable area requirements.	Architect:
The proposed building is located in the city limits of Kansas City, Missouri. Kansas City, Missouri has adopted the 2018 International Building Package with local	Proposed Allowable Proposed Allowable	Bell/Knott & Associates
amendments. The project will be designed to meet the intent of the following adopted codes:	<u>Height Height Stories</u> R-1 54'-0" 75'-0" 4 5	
2018 International Building Code 2018 International Mechanical Code	Building Height and Stories above grade are in compliance with allowable limits.	CORPORATE ARCHITECTS, P.C. 12730 State Line Road Voice: 913.378.1600
2018 International Fire Code 2018 International Fuel Gas Code 2018 Uniform Plumbing Code		Suite 100Fax: 913.378.1601Leawood, KS 66209www.bellknott.com
2017 National Electrical Code 2021 International Energy Conservation Code	FIRE RESISTIVE CONSTRUCTION REQUIREMENTS:	Structural Consultant:
ANSI A117.1 Accessibility Standard NFPA 13 Sprinkler Systems	2018 IBC Table 601 and 602	$\sim \sim \sim$
	Fire Resistive Requirements 2018 IBC Table 601 for II-B Construction	BOB D. CAMPBELL & CO. Structural Engineers Since 1957
BUILDING LIFE SAFETY FEATURES	Exterior Non-Bearing wallsSee Table 602 for Distance to property linesExterior Bearing walls0-HourStructural Frame0-Hour	4338 Belleview Ave. 816.531.4144 Kansas City, MO 64111 www.bdc-engrs.com
The following is a list of fire and safety features, which are being proposed for the project:	Permanent Partitions 0-Hour Shaft Enclosures 0-Hour	MEP Consultant:
<ul> <li>New Building of Construction Type II-B.</li> <li>Building designed as non-separated and separated use groups.</li> </ul>	Floor Ceiling Assemblies0-Hour (1 Hour Occupancy Separation)Roof Ceiling Assemblies0-HourFire Walls1-Hour (Occupancy Separation)	
<ul> <li>Egress system complying with the 2018 IBC.</li> <li>Fully automatic sprinkler system with alarm supervision.</li> <li>Portable fire extinguishers to be provided.</li> </ul>	Corridor Walls 0-Hour with sprinklers	<b>BC</b> ENGINEERS
<ul><li>Smoke detection at HVAC units were applicable.</li><li>Automatic shutdowns at HVAC units where applicable.</li></ul>	<u>Fire Resistance of Exterior Walls Based on Fire Separation Distance, 2018 IBC</u> <u>Table 602</u>	
Emergency power for exit lighting and exit signage.	Fire SeparationType ofGroupDistanceConstruction(R-1 Worst Case)<5'	5720 Reeder St.         913-262-1772           Shawnee, KS 66203         bcngineer.com
BUILDING LIFE SAFETY ANALYSIS AND FIRE RESISTIVE	>= 5' to <10' II-B 1-hour >= 10' to <30' II-B 0-Hour	Civil Consultant:
REQUIREMENTS	>= 30' II-B 0-Hour <u>Maximum Area of Exterior Wall Openings, 2018 IBC Table 705.8</u>	
Exits Required 2018 IBC Section 1015.1 and Chapter 10	Opening <u>Fire Separation Distance</u>	
Every building or usable portion thereof shall have at least one exit and not less than 2 exits where required by 1015.1. Every story or portion thereof having an occupant load of 500 or less shall be provided with not less than two exits.	Classification         3' to <5'         5' to <10'         10' to <15'         15' to <20'           Unprotected         15%         25%         NL         NL           Openings         0         0         0         0         0	
Every story or portion thereof having an occupant load of 501 to 1,000 shall not have less than three exits. Every story or portion thereof having an occupant load of 1,001 or more shall not have less than four exits.		KAW VALLEY ENGINEERING 14700 WEST 114TH TERRACE
Exit Width 2018 IBC Section 1005		LENEXA, KANSAS 66215 PH. (913) 894-5150   FAX (913) 894-5977
The total width of exits in inches shall not be less than the total occupant load served by an exit multiplied by 0.2 for stairways and 0.15 for other exits. Such widths shall be divided approximately equally among the separate exits. Per		lx@kveng.com   www.kveng.com
Section 1005.3 Exceptions an emergency voice alarm communication system is provided.		Landscaping Consultant:
Arrangement of Exits 2018 OBC 1015.2.1 and 1015.2.2 When only two exits are required, within a sprinklered building, they shall be placed		<pre></pre>
a distance apart equal to not less than one third the length of the maximum overall diagonal dimension of the building or area to be served measured in a straight line		
between exits. Where access to three or more exits is required, at least two exits shall be arranged		102 South Cherry Street 2nd Floor Olathe, KS 66061 www.landworksstudio.com   913.780.6707
in accordance with the provisions of Section 1015.2. Distance to Exits, 2018 IBC Table 1016.2		
The maximum distance of travel from any point to an exterior exit door, horizontal exit, exit passageway or an enclosed stairway in a building equipped with an automatic sprinkler system throughout shall not exceed 200 feet in the I-4		
occupancy and 300 feet in the B Occupancy.		
<ul> <li>Doors, 2018 IBC Section 1008</li> <li>1. Lock or Latch, 2018 IBC 1008.1.9: Exit doors shall be openable from the inside without the use of a key or any special knowledge or effort. Manually</li> </ul>		Seal:
operated edge or surface mounted flush bolts are prohibited. 2. Floor Level at Doors, 2018 IBC 1008.1.5: Regardless of occupant load,		ANNIE COLOR
there shall be a floor or landing on each side of door. Thresholds at doorways shall not exceed 0.5 inches. Thresholds greater than 0.25 inches shall be beveled.		OF MISSO
<ol><li>Landings at Doors, 2018 IBC Section 1008.1.6: Landings shall have a width not less than the width of the stairway or the width of the door, whichever is</li></ol>		MURRAY
the greater. Doors in the fully open position shall not reduce a required dimension by more than 7 inches. When landings serve an occupant load of 50 or more, doors in any position shall not reduce the dimension to less		NUMBER A-2006025507
than one half its required width. Landings shall have a length measured in the direction of travel of not less than 44 inches.		9(78)2023
Exit Signs, 2018 IBC 1011.1 1. Where Required: When two or more exits from a story or area are required		
exit signs shall be installed. Exit signs shall be readily visible from any direction of approach. Exit signs shall be located as necessary to clearly indicate the direction of egress travel. No point shall be more than 100 feet		
from the nearest visible sign. 2. Graphics: The color and design of lettering on exit signs shall be in high		Revisions:
contrast with their background. Words on the sign shall be in block letters 6 inches in height with a stroke of not less than 3/4 inch. 3. Illumination: Signs shall be internally illuminated by two electric lamps or		
shall be of an approved self-luminous type. Exit signs shall be illuminated at all times.		
<ol> <li>Power Source: To ensure continued illumination for a duration of not less than 90 minutes in case of primary power loss, the sign illumination means shall be connected to an emergency power system.</li> </ol>		
shan be connected to an emergency power system.		Issue Date:9/13/2023Reason for Issue:Review
		Reason for Issue:ReviewProject Number:22-056
		Project Phase: <b>Dev Plan Review</b>
		Sheet Title:
		Codo Analysia
		Code Analysis

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Site Overview EXTG

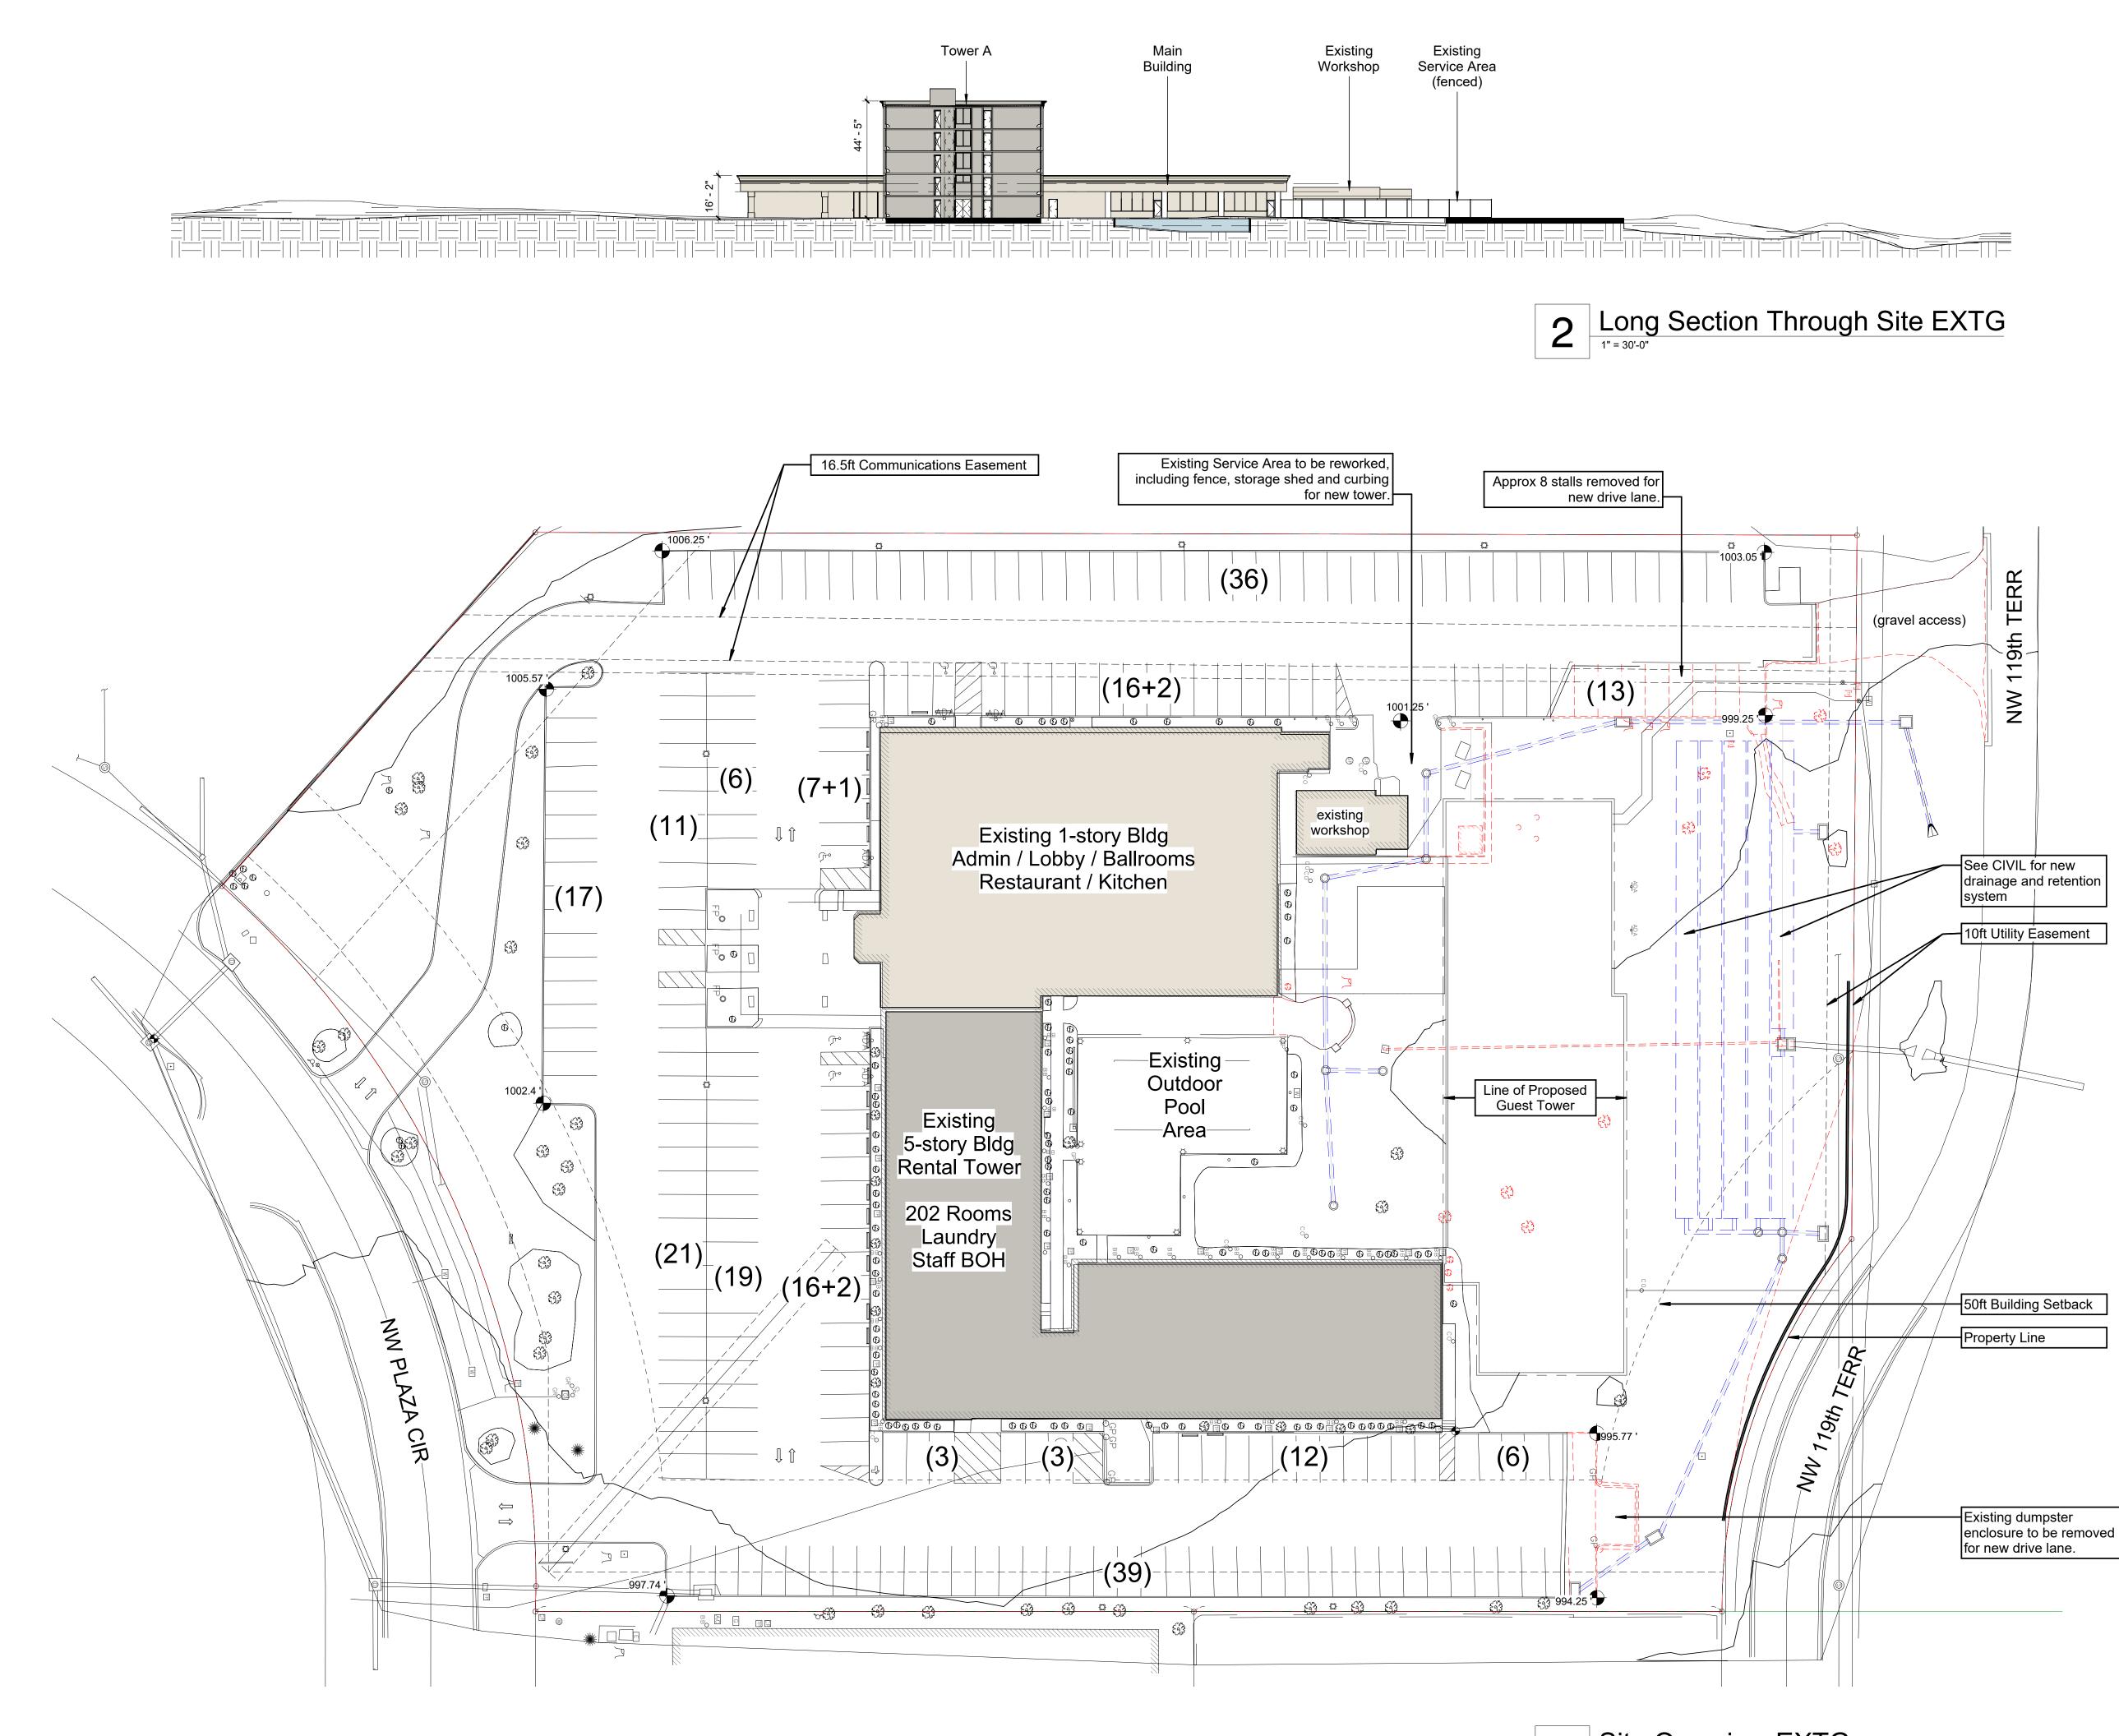




	I Description
діі Т	
PLAT,	HAT PART OF LOT 3, GATEWAY PLAZA, FIRS A SUBDIVISION IN SECTION 23, TOWNSHIP 5
COUN	H, RANGE 34 WEST, KANSAS CITY, PLATTE
1972 /	RDED PLAT THEREOF RECORDED JUNE 21, AS DOCUMENT NO. 37229 IN PLAT BOOK 11,
THE S	10, DESCRIBED AS FOLLOWS; BEGINNING A SOUTHEAST CORNER OF SAID LOT 3; THENC
LINE (	'H 89°43'38" WEST, ALONG THE SOUTHERLY DF SAID LOT 3, 9.57 FEET; THENCE
ALON	HWESTERLY CONTINUING ALONG SAID LINE G A CURVE TO THE LEFT HAVING A RADIUS
DESC	5.00 FEET AND TANGENT TO THE LAST RIBED COURSE, AN ARC DISTANCE OF 300.2
LOT 3	TO THE MOST SOUTHERLY CORNER OF SAI ; THENCE NORTH 48°11'04" WEST, INUING ALONG THE SOUTHERLY LINE OF
SAID I	LOT 3, 179.37 FEET; THENCE NORTH 00°16'22 500.86 FEET TO THE SOUTHERLY RIGHT OF
WAY I	LINE OF U.S. HIGHWAY 71 BY-PASS; THENCE H 89°41'07" EAST ALONG SAID RIGHT OF WA
LINE A	AND ALONG THE NORTHERLY LINE OF SAID , 268.13 FEET; THENCE SOUTHEASTERLY,
CONT	INUING ALONG SAID NORTHERLY LINE, G A CURVE TO THE LEFT HAVING A RADIUS
	5.00 FEET AND AN INITIAL TANGENT BEARIN 'H 50°44'34" EAST, (DEED - 5 50°44'32" E) AN
89°41'	DISTANCE OF 152.93 FEET; THENCE SOUTH 07" EAST, CONTINUING ALONG SAID
CORN	HERLY LINE, 0.02 FEET TO THE NORTHEAST IER OF SAID LOT 3; THENCE SOUTH 00°16'22
FEET	, ALONG THE EAST LINE OF SAID LOT 3, 449 (PER DEED) AND 449.94 FEET (AS
MEAS	ÛRED) TO THE POINT OF BEGINNING.
Zonii	
	ng 3-3
B	
B3 Gros	3-3
B3 Gros 21	3-3 s Land Area 17,795 SF / 5 acres
B3 Gros 21 Righ	3-3 is Land Area 17,795 SF / 5 acres t-of-Way Dedication
B3 Gros 21	3-3 is Land Area 17,795 SF / 5 acres t-of-Way Dedication
B3 Gros 21 Righ N/	3-3 is Land Area 17,795 SF / 5 acres t-of-Way Dedication /A
B3 Gros 21 Righ N/	3-3 is Land Area 17,795 SF / 5 acres t-of-Way Dedication /A _and Area
B3 Gros 21 Righ N/	3-3 is Land Area 17,795 SF / 5 acres t-of-Way Dedication /A
B3 Gros 21 Righ N/	3-3 is Land Area 17,795 SF / 5 acres t-of-Way Dedication /A _and Area
B3 Gros 21 Righ N/ Net I 21	3-3 is Land Area 7,795 SF / 5 acres t-of-Way Dedication /A _and Area 17,795 SF / 5 acres
B3 Gros 21 Righ N/ Net I 21	3-3 is Land Area 7,795 SF / 5 acres t-of-Way Dedication /A _and Area 7,795 SF / 5 acres
B3 Gros 21 Righ N/ Net I 21	3-3 is Land Area 7,795 SF / 5 acres t-of-Way Dedication /A _and Area 17,795 SF / 5 acres
B3 Gros 21 Righ N/ Net I 21 Rear 20	3-3 is Land Area 7,795 SF / 5 acres t-of-Way Dedication /A _and Area 7,795 SF / 5 acres
B3 Gros 21 Righ N/ Net I 21 Rear 20 Front	3-3 is Land Area 7,795 SF / 5 acres t-of-Way Dedication /A _and Area 7,795 SF / 5 acres
B3 Gross 21 Righ N/ Net I 21 Rear 20 Front 20	3-3 Is Land Area 17,795 SF / 5 acres t-of-Way Dedication /A Land Area 17,795 SF / 5 acres Setback 0 ft t Setback 0 ft
B3 Gross 21 Righ N/ Net I 21 Rear 20 Front 20 Side	3-3 is Land Area 17,795 SF / 5 acres t-of-Way Dedication /A _and Area 17,795 SF / 5 acres Setback 0 ft t Setback 0 ft Setback
B3 Gross 21 Righ N/ Net I 21 Rear 20 Front 20	3-3 is Land Area 17,795 SF / 5 acres t-of-Way Dedication /A _and Area 17,795 SF / 5 acres Setback 0 ft t Setback 0 ft Setback
B3 Gross 21 Righ N/ Net I 21 Rear 20 Front Side 20	3-3 is Land Area 17,795 SF / 5 acres t-of-Way Dedication /A _and Area 17,795 SF / 5 acres Setback 0 ft t Setback 0 ft Setback
B3 Gross 21 Righ N/ Net I 21 Rear 20 Front Side 20	3-3 Is Land Area 7,795 SF / 5 acres t-of-Way Dedication /A _and Area 7,795 SF / 5 acres Setback 0 ft t Setback 0 ft Setback 0 ft Setback
B3 Gross 21 Righ N/ Net I 21 Rear 20 Front 20 Side 20 Side	3-3 Is Land Area 7,795 SF / 5 acres t-of-Way Dedication /A _and Area 7,795 SF / 5 acres Setback 0 ft t Setback 0 ft Setback 0 ft Setback
B3 Gross 21 Righ N/ Net I 21 Rear 20 Front 20 Side 20 Side N/	3-3 Is Land Area 7,795 SF / 5 acres t-of-Way Dedication /A _and Area 7,795 SF / 5 acres Setback 0 ft t Setback 0 ft Setback 0 ft Setback
B3 Gross 21 Righ N/ 21 Rear 20 Front 20 Side 20 Side 20 Side 20 Side	3-3 Is Land Area I7,795 SF / 5 acres t-of-Way Dedication /A _and Area I7,795 SF / 5 acres Setback 0 ft t Setback 0 ft Setback 0 ft Setback 0 ft Setback 0 ft Setback 0 ft Setback 0 ft
B3 Gross 21 Righ N/ 21 Rear 20 Front 20 Side 20 Side 20 Side 20 Side	3-3 as Land Area 7,795 SF / 5 acres t-of-Way Dedication /A and Area 7,795 SF / 5 acres Setback 0 ft Setback 0 ft Setback 0 ft Setback 0 ft Setback 0 ft Setback 0 ft Setback 0 ft Setback
B3 Gros 21 Righ N/ Net I 21 Rear 20 Front 20 Side 20 Side 20 Side N/ Side	3-3 Is Land Area 7,795 SF / 5 acres t-of-Way Dedication /A and Area 7,795 SF / 5 acres Setback 0 ft t Setback 0 ft Setback 0 ft Setback 0 ft Setback 0 ft Setback 0 ft Setback 1 ft 1 ft Setback 1 ft 1 f
B3 Gross 21 Righ N/ Net I 21 Rear 20 Front 20 Side 20 Side 20 Side N/ Exist	3-3 Is Land Area 17,795 SF / 5 acres t-of-Way Dedication /A _and Area 17,795 SF / 5 acres Setback 0 ft t Setback 0 ft Setback 0 ft Setback 0 ft Setback 0 ft Setback 0 ft Setback (street) /A ing Heights ing Commercial 1-story approx 16'-0" ing Guest Tower 5-story approx 44'-6"
B3 Gross 21 Righ N/ Net I 21 Rear 20 Front 20 Side 20 Side 20 Side N/ Exist	3-3 Is Land Area 7,795 SF / 5 acres t-of-Way Dedication /A and Area 7,795 SF / 5 acres Setback 0 ft t Setback 0 ft Setback 0 ft Setback 0 ft Setback 0 ft Setback 0 ft Setback 1 ft 1 ft Setback 1 ft 1 f



Pkg:	Sheet Number:
DP	A101

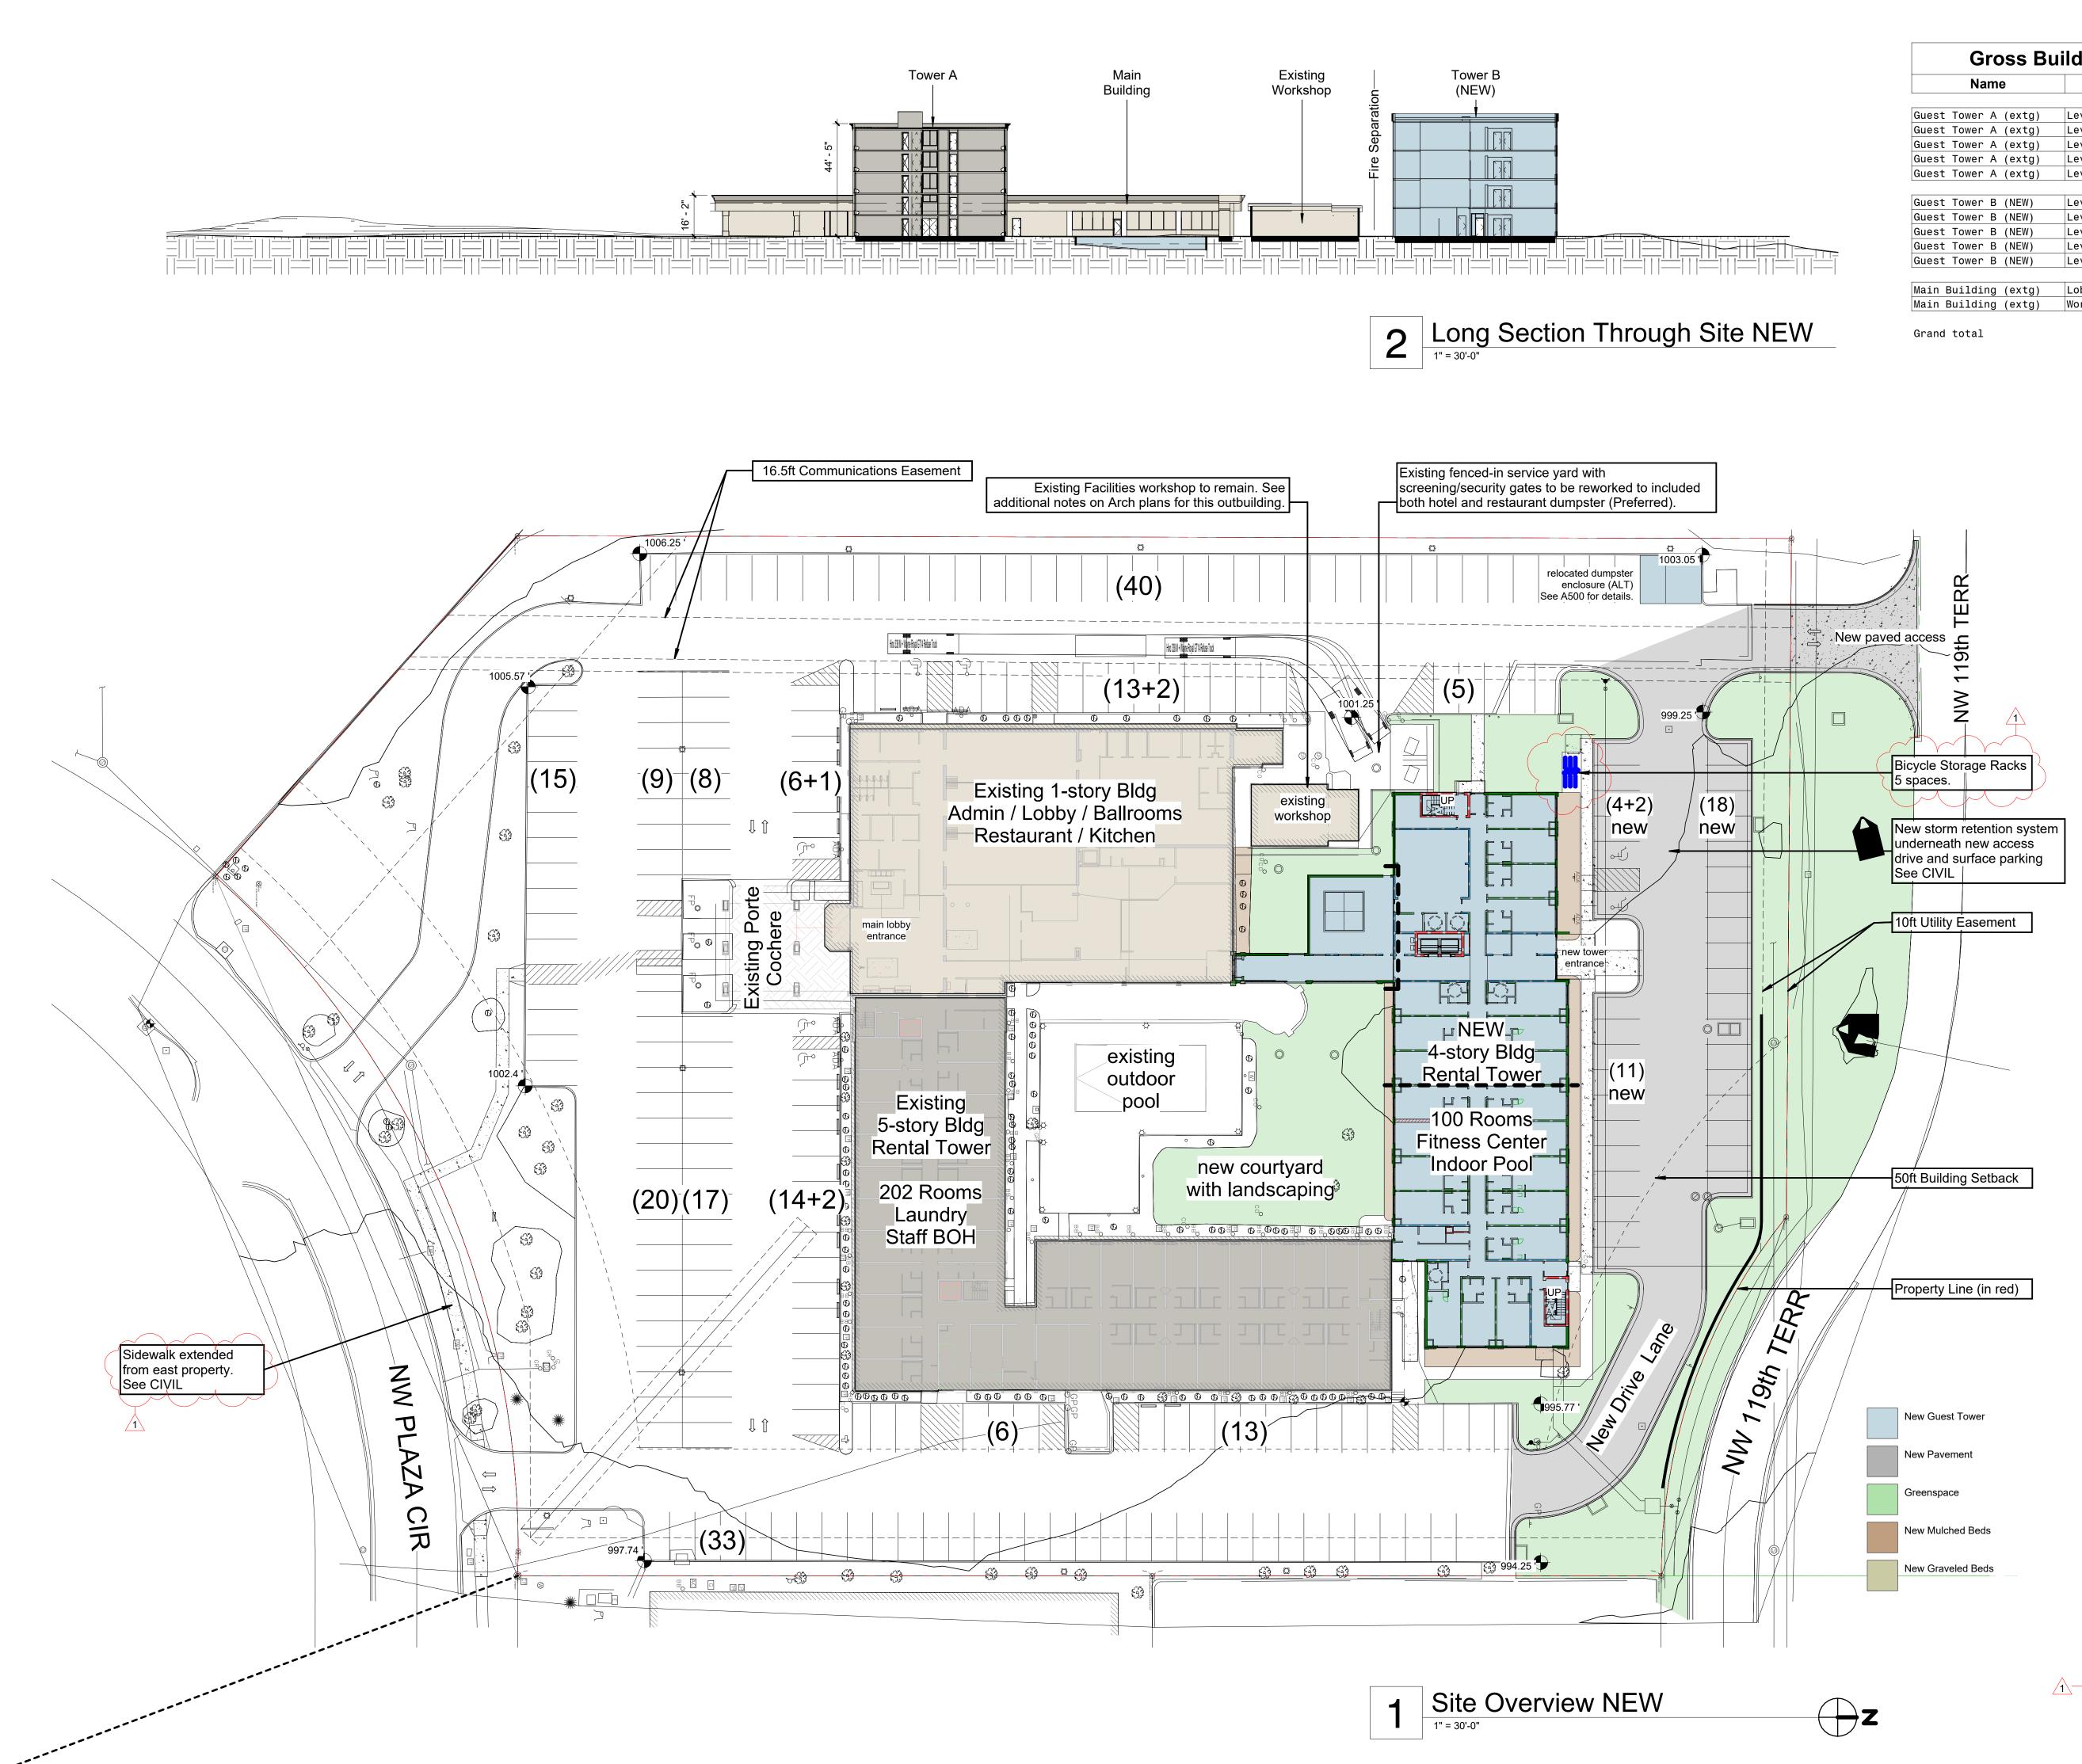

AM

Gross Building Areas (per floor)				
Name	Comments	Area		
Guest Tower A (extg)	Level 1	17710 S		
Guest Tower A (extg)	Level 2	17710 S		
Guest Tower A (extg)	Level 3	17710 S		
Guest Tower A (extg)	Level 4	17710 S		
Guest Tower A (extg)	Level 5	17790 S		
		88650 S		
Guest Tower B (NEW)	Level 1	14720 S		
Guest Tower B (NEW)	Level 1 (Indoor Pool)	1050 S		
Guest Tower B (NEW)	Level 2	14020 S		
Guest Tower B (NEW)	Level 3	14010 S		
Guest Tower B (NEW)	Level 4	14010 S		
		57830 S		
Main Building (extg)	Lobby/Ballrooms/Restaurant	16130 S		
Main Building (extg)	Workshop	980 S		
		17110 S		
Grand total		163590 S		

King	59
King ADA	1
King ADA C	1
King C	30
King NC	12
Queen	56
Queen C	39
Suite	4
Grand total : 203	
Guest Rooms - Ne	ew
Name	Count
Bedroom	2
Guest Room KING	24
Guest Room King (ADA)	4
Guest Room King STAY (ADA)	3
Guest Room King Suite (ADA)	2
Guest Room QQ	31
Guest Room QQ (ADA)	7
Guest Room STAY	28
Guest Room STAY (ADA)	1
Grand total : 102	
Building Area	
Building Area	
<u>Gross Area (Existing)</u>	<u>34,820 SF</u>
Extg Guest Tower (202 rooms	
Extg Main Service	16,130 SF
Extg Maintenance Shop	980 SF
<u>Extg Assembly (Total)</u>	<u>11,980 SF</u>
Restaurant/Bar	5,830 SF
Ballrooms	3,000 SF
Lobby	3,150 SF
<u>Proposed Guest Tower</u>	<u>15,770 SF</u>
Guest Rooms (100 rms) R-1	14,720 SF
Indoor Pool A-3	

**Guest Rooms - Existing** 

Count

Name

Exec Ste

Floor Area Ratio	
75%	
F.A.R. (GTA/GLA)	0.711
<u>Gross Total Areas</u> Extg Guest Tower (5-story) Extg Main Service Extg Maintenance Shop NEW Guest Tower (4-story)	<u>163,590 SF</u> 88,650 SF 16,130 SF 980 SF 57,830 SF
<u>Gross Land Area</u>	<u>217,795 SF</u>

Parking		
PARKING (CALCULATED PER KCMO)		
Required Calculated	197	stalls
Existing Assembly 11.98X10=		
Existing Guest $41+(163/6)=$		
New Guest (64/6)=	10	
Actual Existing* (@ 9ft spacing)	242	stalls
Total Proposed	258	stalls
Existing Restripped		
(0, 10ft, an a a f m m)	001	
(	221	
Proposed New	37	
Proposed New	37	
Proposed New *original count excess due to	37 in-h	
Proposed New	37 in-h	
Proposed New *original count excess due to	37 in-h	


Lodging (CALCULATED PER KCMO)


Required Calculated 5 spaces 1 space plus 1 for every 30 units 100 rooms/30 = 3.33 >> 4 spaces



Number	Name	Area
000	Vest	181 SF
000	Porte Cochere	1468 SF
Assembly		
000	Plaza 1	1026 SF
000	Plaza 2	1025 SF
000	Plaza 3	1025 SF
000	Pre-Meeting	631 SF
BOH 000	IT Server	119 SF
000	Table Storage	173 SF
000	Storage	78 SF
000	Kitchen Off	189 SF
000	Shop	938 SF
000	Dellasen Ounsent	0.40.05

Number	Name	Area		Number	Nai
Core				Guest Servi	ces
000	WC Womens	247	SF	000	Ambassador R
000	WC Mens	247	SF		(Fitness)
000	Lobby	1336	SF	000	Front Desk
000	WC ADA	43	SF		
000	Elect.	125	SF	Restaurant	
000	Hallway	788	SF	000	Private Dini
				000	Restaurant S
FOH				000	Bar
000	Office 3	94	SF	000	Breakfast Bu
000	Office 2	82	SF	000	POS
000	Janitor	63	SF	000	Lounge
000	Office 1	113	SF		
000	Front Desk Support	228	SF		

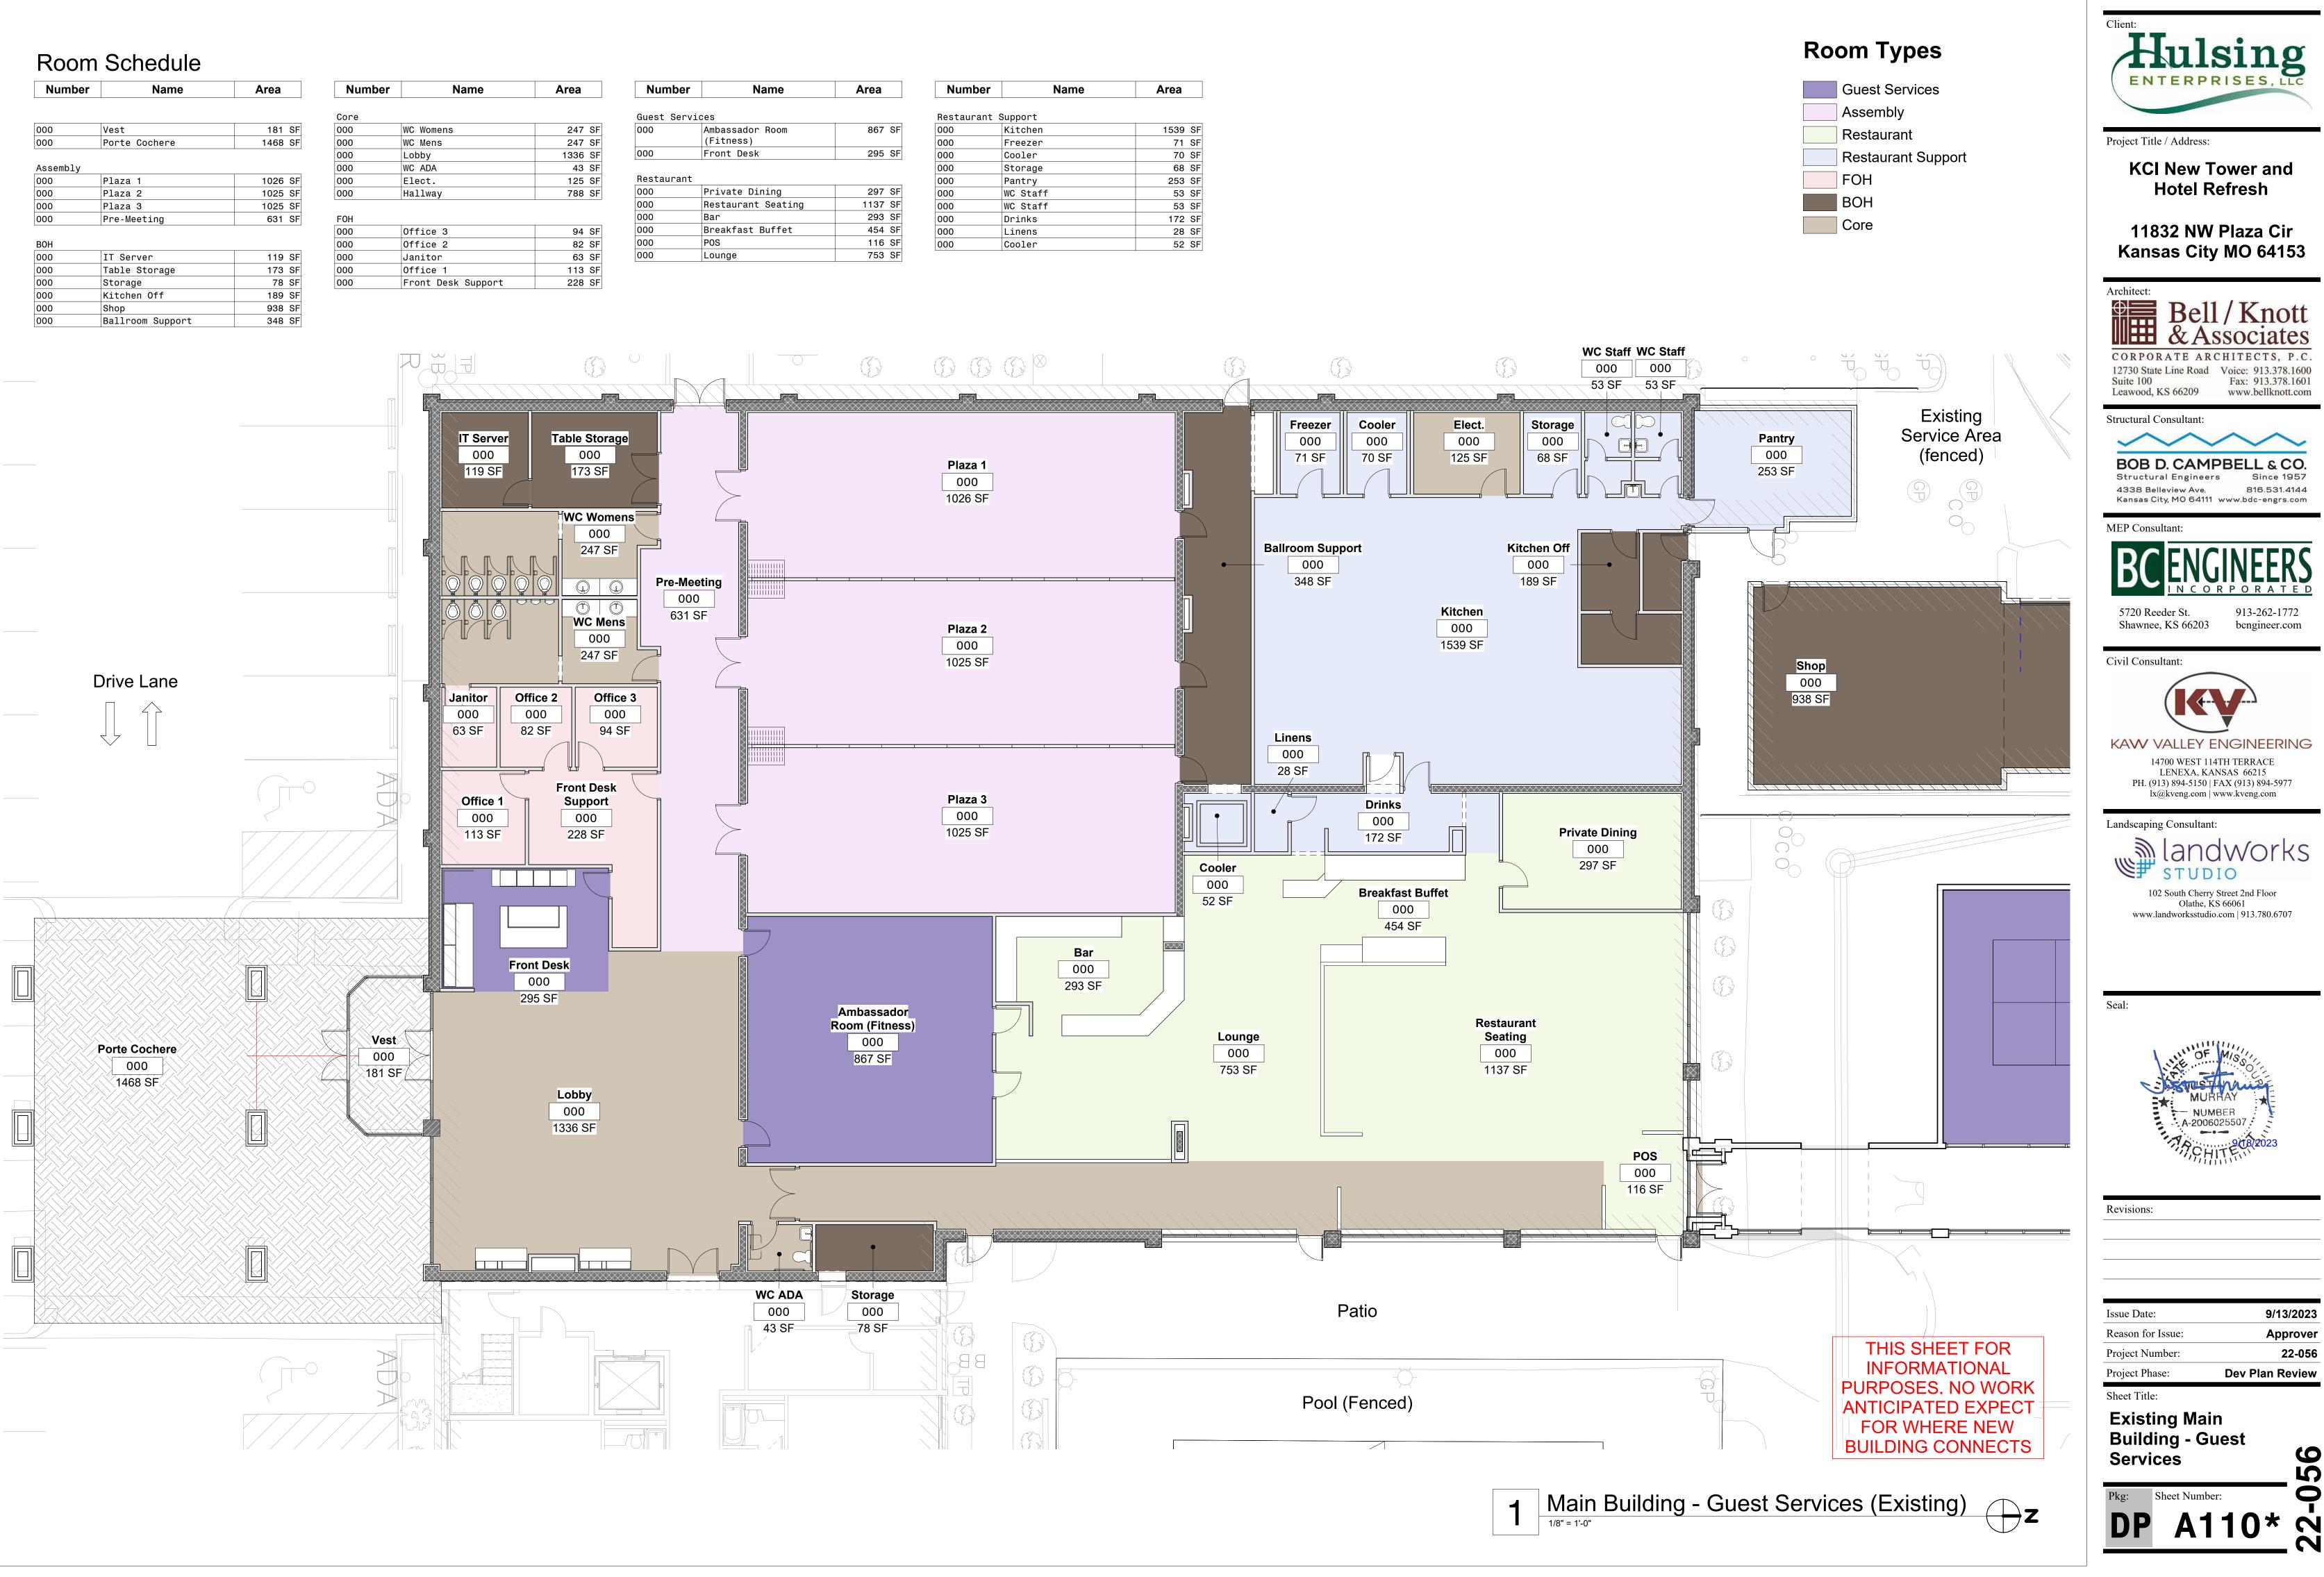

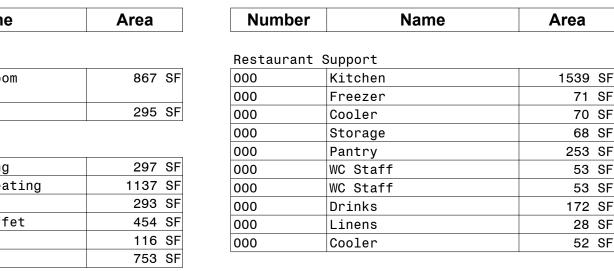



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Name	Area
torge	106 SF
ool Eqp	55 SF
ach. Rm	78 SF
ump Rm	242 SF
ockers	25 SF
taff WC	28 SF
00	302 SF
torage	72 SF
aundry	294 SF
ryers	303 SF
taff	224 SF
gr	72 SF
olding	310 SF
LEC	300 SF
allway	2209 SF

lallway	2209 SF
intry	58 SF
LEV	59 SF
LEV	66 SF
Stair No. 1	114 SF
Stair No. 2	122 SF
Stair No. 3	117 SF

Number	Name	Area
Guest Rm -	Dbl Queen	
103	Queen C	302 SF
111	Queen C	302 SF
113	Queen C	302 SF
115	Queen	302 SF
117	Queen	302 SF
119	Queen	302 SF
121	Queen	302 SF
135	Queen	302 SF
136	Queen C	302 SF
137	Queen C	302 SF
138	Queen C	302 SF
139	Queen C	302 SF
140	Queen	302 SF
141	Queen	302 SF
142	Queen	302 SF
143	Queen	302 SF
144	Queen C	302 SF
145	Queen C	302 SF
146	Queen C	303 SF
147	Queen C	302 SF
148	Queen	302 SF
149	Queen	302 SF

Number	Name	Area
Guest Rm -	King	
102	King	302 SF
104	King	302 SF
107	King	302 SF
109	King	302 SF
110	King	302 SF
112	King	302 SF
134	King ADA	
105 134	King ADA C King ADA	310 SF 310 SF
Guest Rm -	King NC	
	King NC King NC	
Guest Rm -		302 SF
Guest Rm - 130	King NC	302 SF
Guest Rm - 130 132	King NC King NC	302 SF 302 SF 258 SF
Guest Rm - 130 132 150	King NC King NC King NC King NC	302 SF 302 SF 258 SF
Guest Rm - 130 132 150 151	King NC King NC King NC King NC	302 SF 302 SF 258 SF 249 SF
Guest Rm - 130 132 150 151 Guest Rm -	King NC King NC King NC King NC Suite Exec Ste	302 SF 302 SF 258 SF 249 SF

	Ν
Exec Bdrm	
Exec Ste	
King	
King ADA	
King ADA C	
King NC	
Queen	
Queen C	
Grand total	:



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Number	Name	Area	Number	Name	Area	Number	Name
вон						1xx	Guest Room QQ
1XX	Housekeeping	199 SF	TB Guest Rn	n - STAY		1xx	Guest Room KING
1XX	Mech. Rm	86 SF	1XX	Guest Room STAY	414 SF	1xx	Guest Room KING
1xx	Electrical Rm	197 SF	1XX	Guest Room STAY	455 SF	1xx	Guest Room KING
1xx	ВОН	110 SF	1xx	Guest Room STAY	414 SF	1xx	Guest Room KING
1xx	Pump Rm	60 SF	1xx	Guest Room STAY	414 SF	1xx	Guest Room QQ
		,	1xx	Guest Room STAY	424 SF	1xx	Guest Room QQ
Core			1xx	Guest Room STAY	424 SF	1xx	Guest Room QQ
1XX	Lobby	293 SF	1xx	Guest Room STAY	414 SF	1xx	Guest Room QQ
1XX	Stair	158 SF	1xx	Guest Room STAY	414 SF		·
1XX	Stair	152 SF	1xx	Guest Room STAY	414 SF	TB Guest Rms - ADA	
1XX	Breezeway	597 SF				1xx	Guest Room ADA Acc.
1XX	Elev Vest	282 SF	TB Guest Rn	ıs		1xx	Guest Room ADA Acc.
1xx	Hallway	1525 SF	1XX	Guest Room KING	349 SF		
1xx	Crossover	251 SF	1XX	Guest Room KING	349 SF		
Guest Servi	ces						
1XX	Fitness Room	1059 SF					

Room	Types
	- , , , , , , , , , , , , , , , , , , ,

Area
375 SF
349 SF
349 SF
349 SF
349 SF
376 SF
375 SF
376 SF
375 SF
375 SF
375 SF

Guest Room Count - Tow			
Name	Count		
Guest Room ADA Acc.	8		
Guest Room ADA King STAY	3		
Guest Room KING	31		
Guest Room QQ	22		
Guest Room STAY	36		
Grand total · 100			



Client:

Project Title / Address:

Hulsing

ENTERPRISES, LLC

KCI New Tower and

**Hotel Refresh** 

11832 NW Plaza Cir

Issue Date:	9/13/2023
Reason for Issue:	Approver
Project Number:	22-056
Project Phase:	Dev Plan Review
Sheet Title:	

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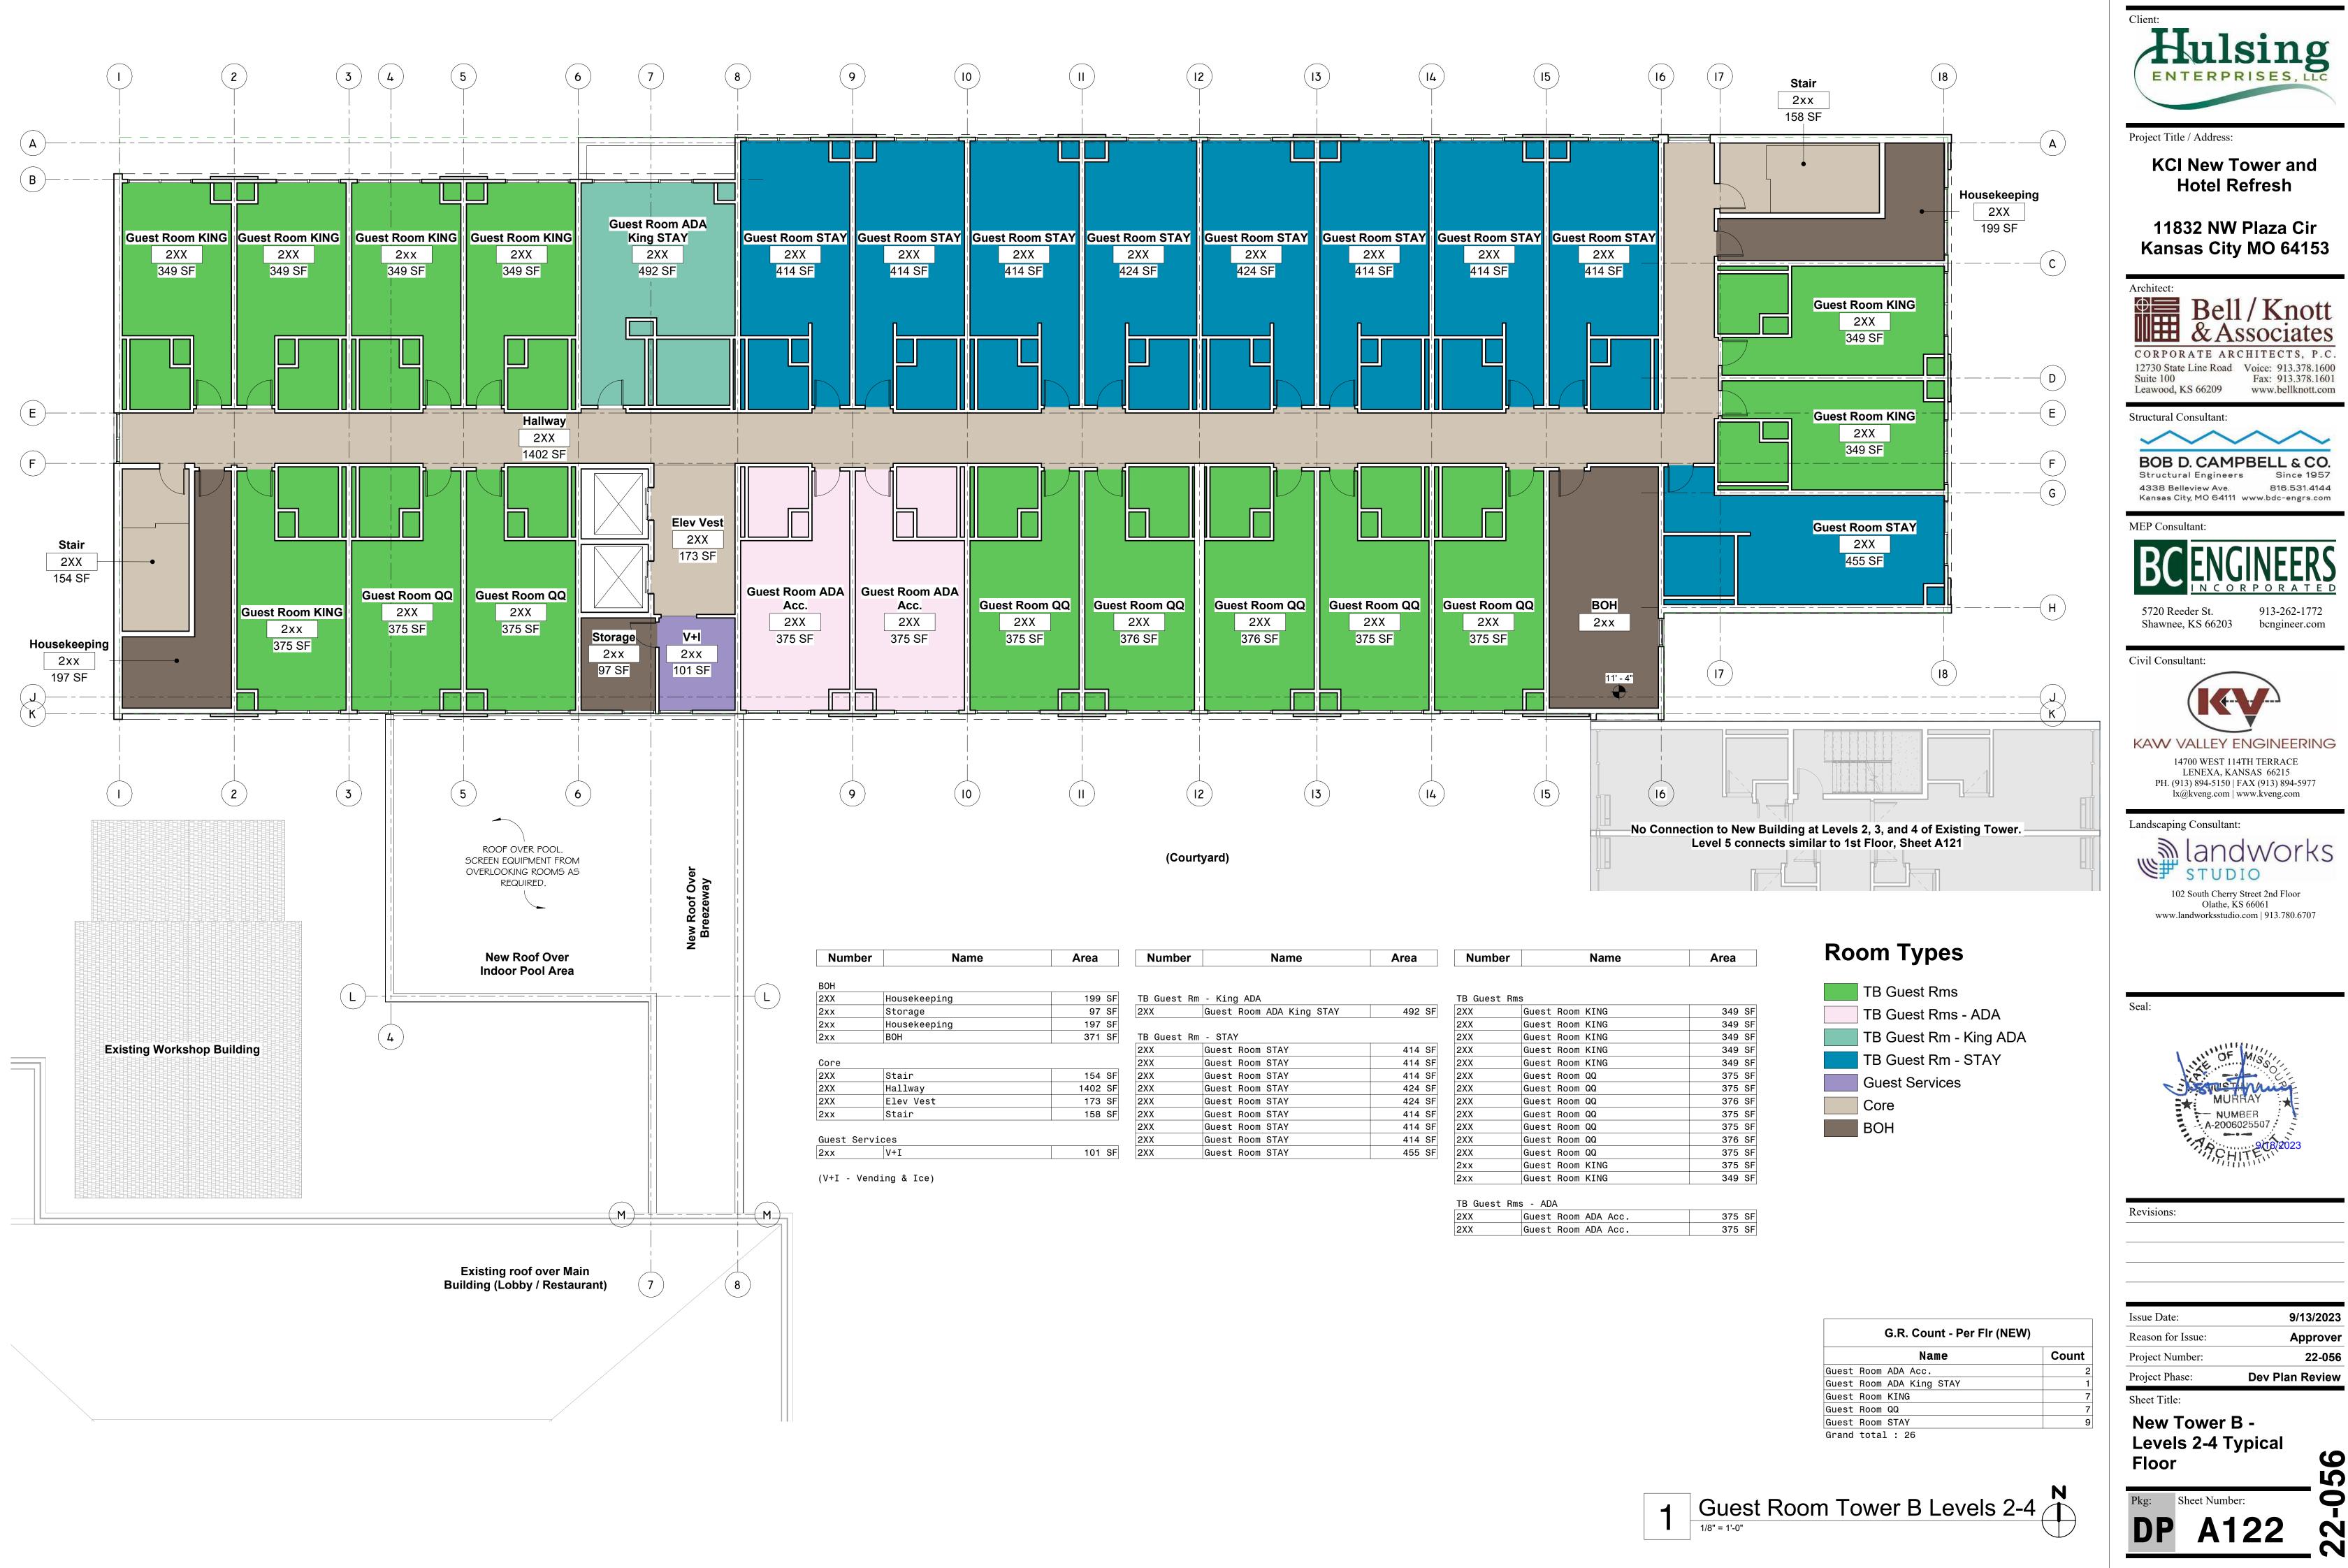
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New Tower B -Level 1 Guest Rooms












Number	Name	Area	Number	Name	Area	Number	Name
вон							
2XX	Housekeeping	199 SF	TB Guest R	n - King ADA		TB Guest Rm	IS
2xx	Storage	97 SF	2XX	Guest Room ADA King STAY	492 SF	2XX	Guest Room KING
2xx	Housekeeping	197 SF	L			2XX	Guest Room KING
2xx	ВОН	371 SF	TB Guest R	n - STAY		2XX	Guest Room KING
			2XX	Guest Room STAY	414 SF	2XX	Guest Room KING
Core			2XX	Guest Room STAY	414 SF	2XX	Guest Room KING
2XX	Stair	154 SF	2XX	Guest Room STAY	414 SF	2XX	Guest Room QQ
2XX	Hallway	1402 SF	2XX	Guest Room STAY	424 SF	2XX	Guest Room QQ
2XX	Elev Vest	173 SF	2XX	Guest Room STAY	424 SF	2XX	Guest Room QQ
2xx	Stair	158 SF	2XX	Guest Room STAY	414 SF	2XX	Guest Room QQ
			2XX	Guest Room STAY	414 SF	2XX	Guest Room QQ
Guest Servi	ices		2XX	Guest Room STAY	414 SF	2XX	Guest Room QQ
2xx	V+I	101 SF	2XX	Guest Room STAY	455 SF	2XX	Guest Room QQ
			<b>.</b>			2xx	Guest Room KING

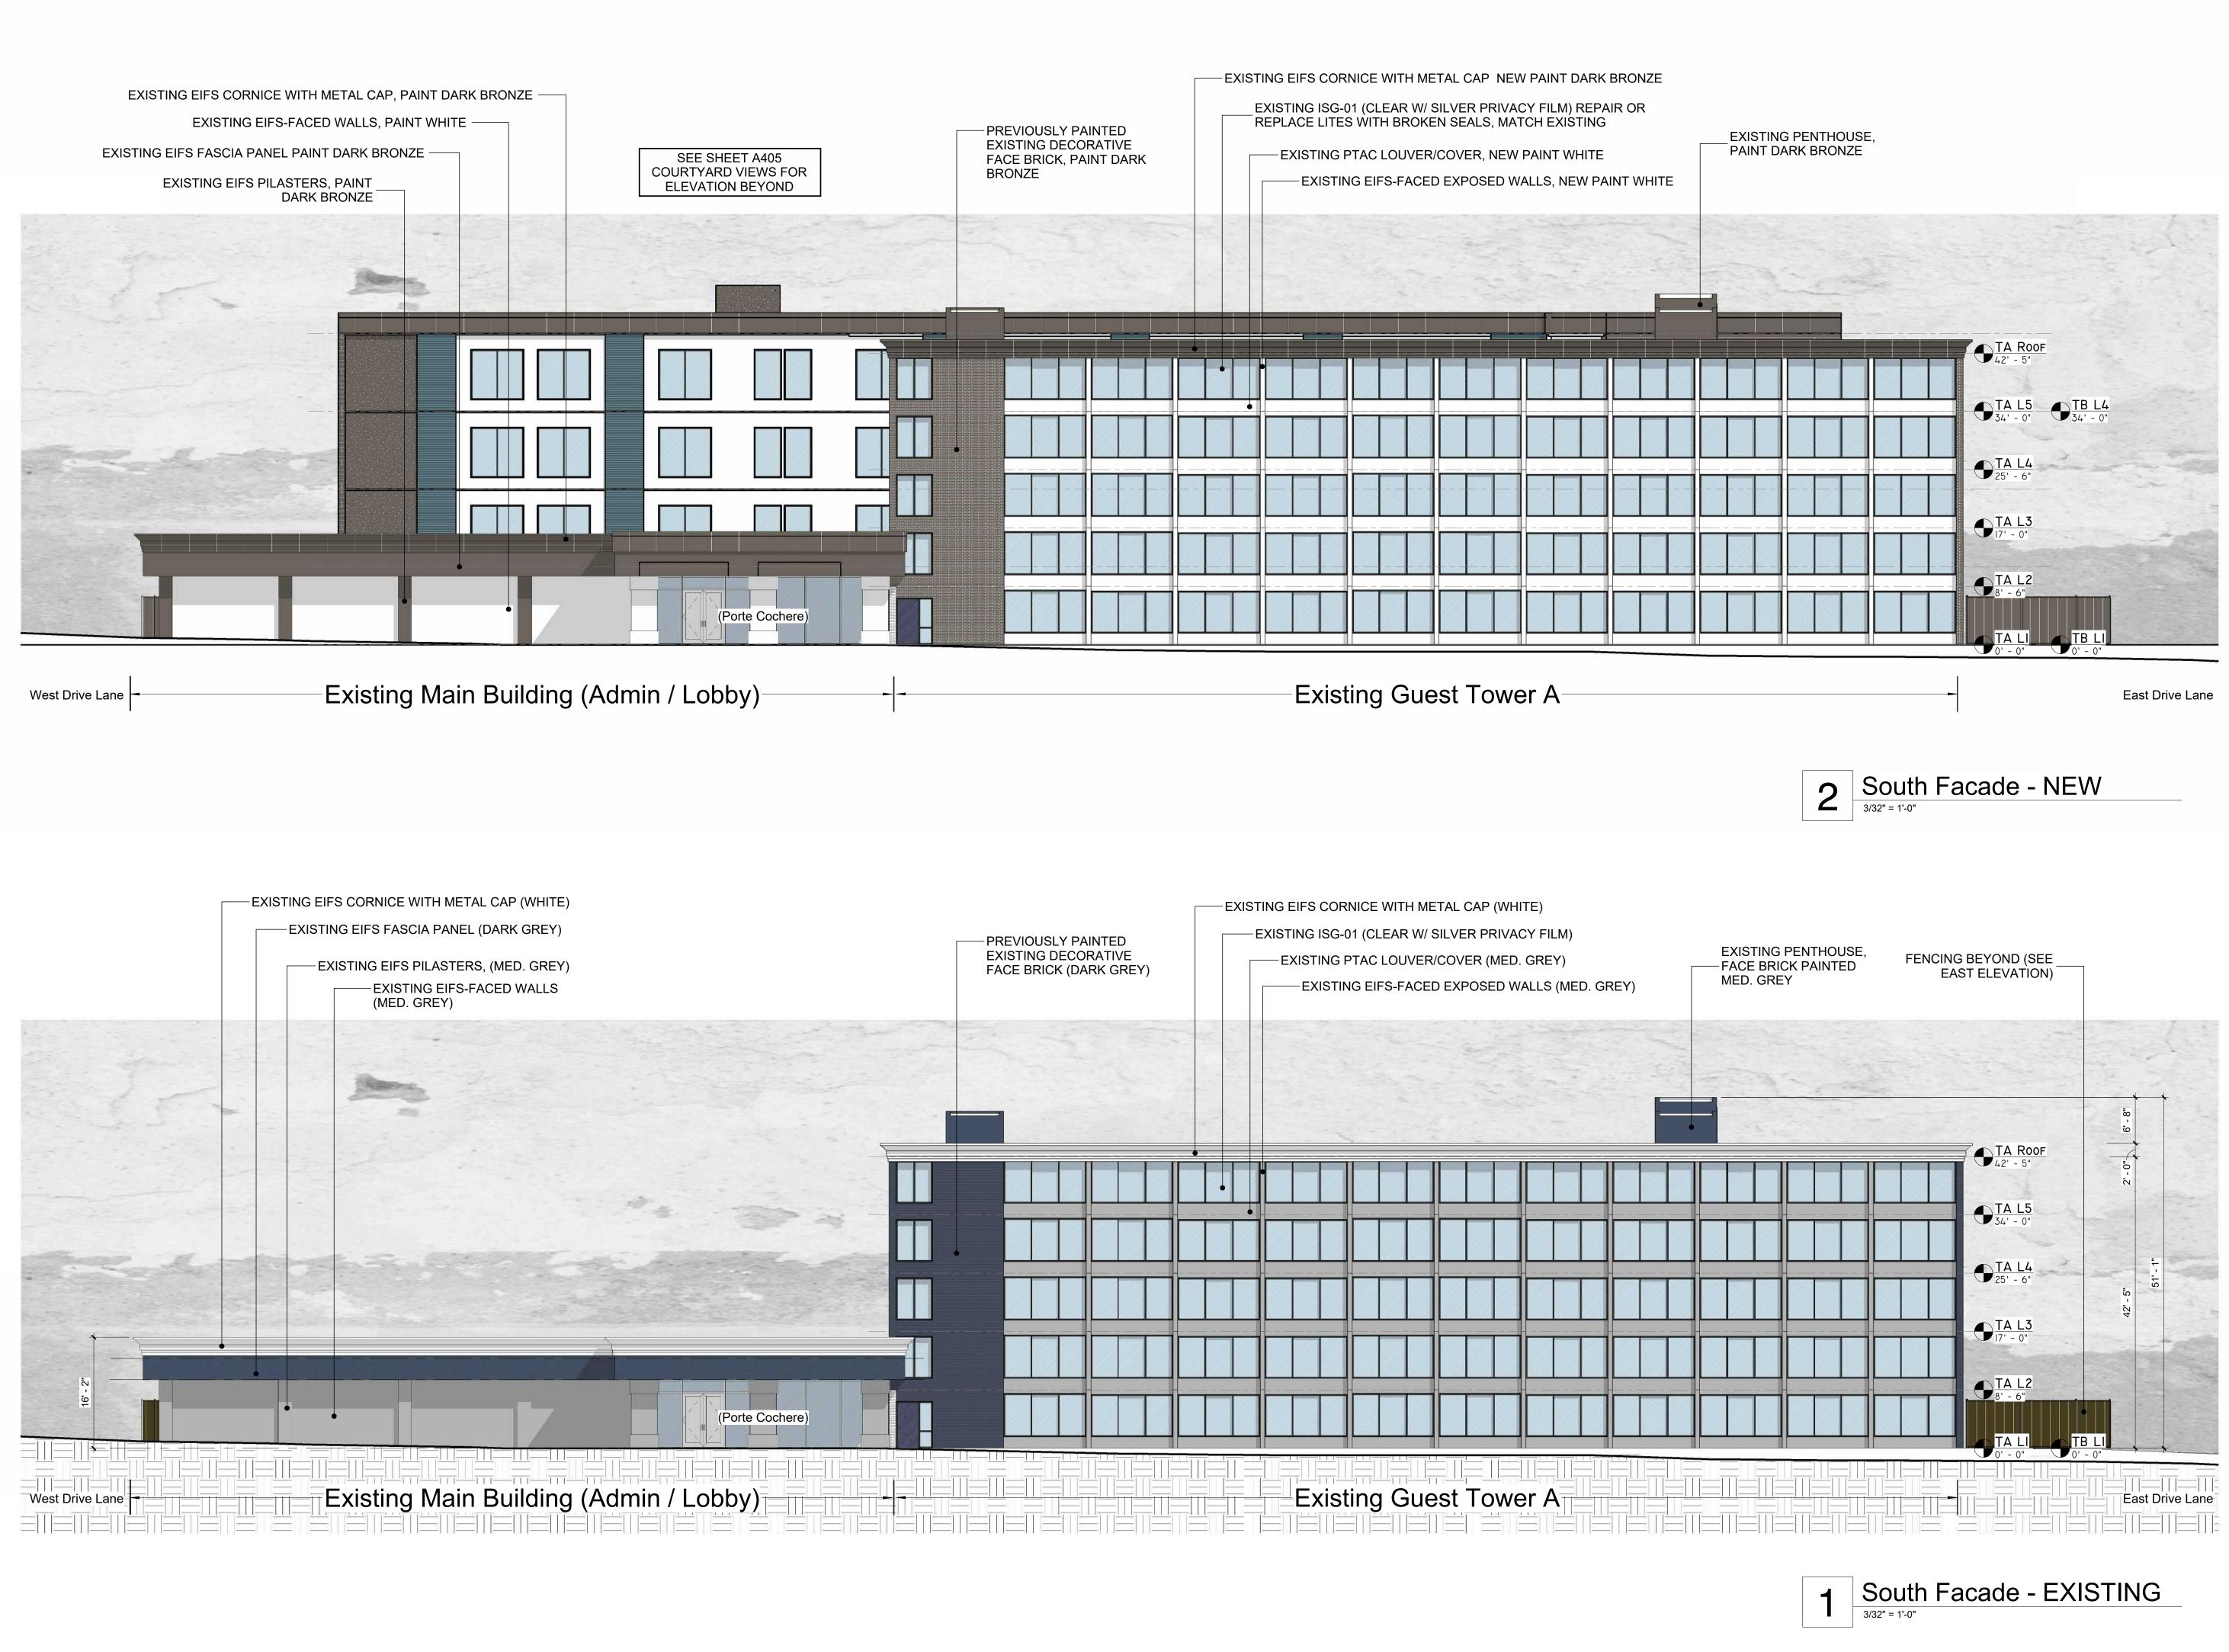




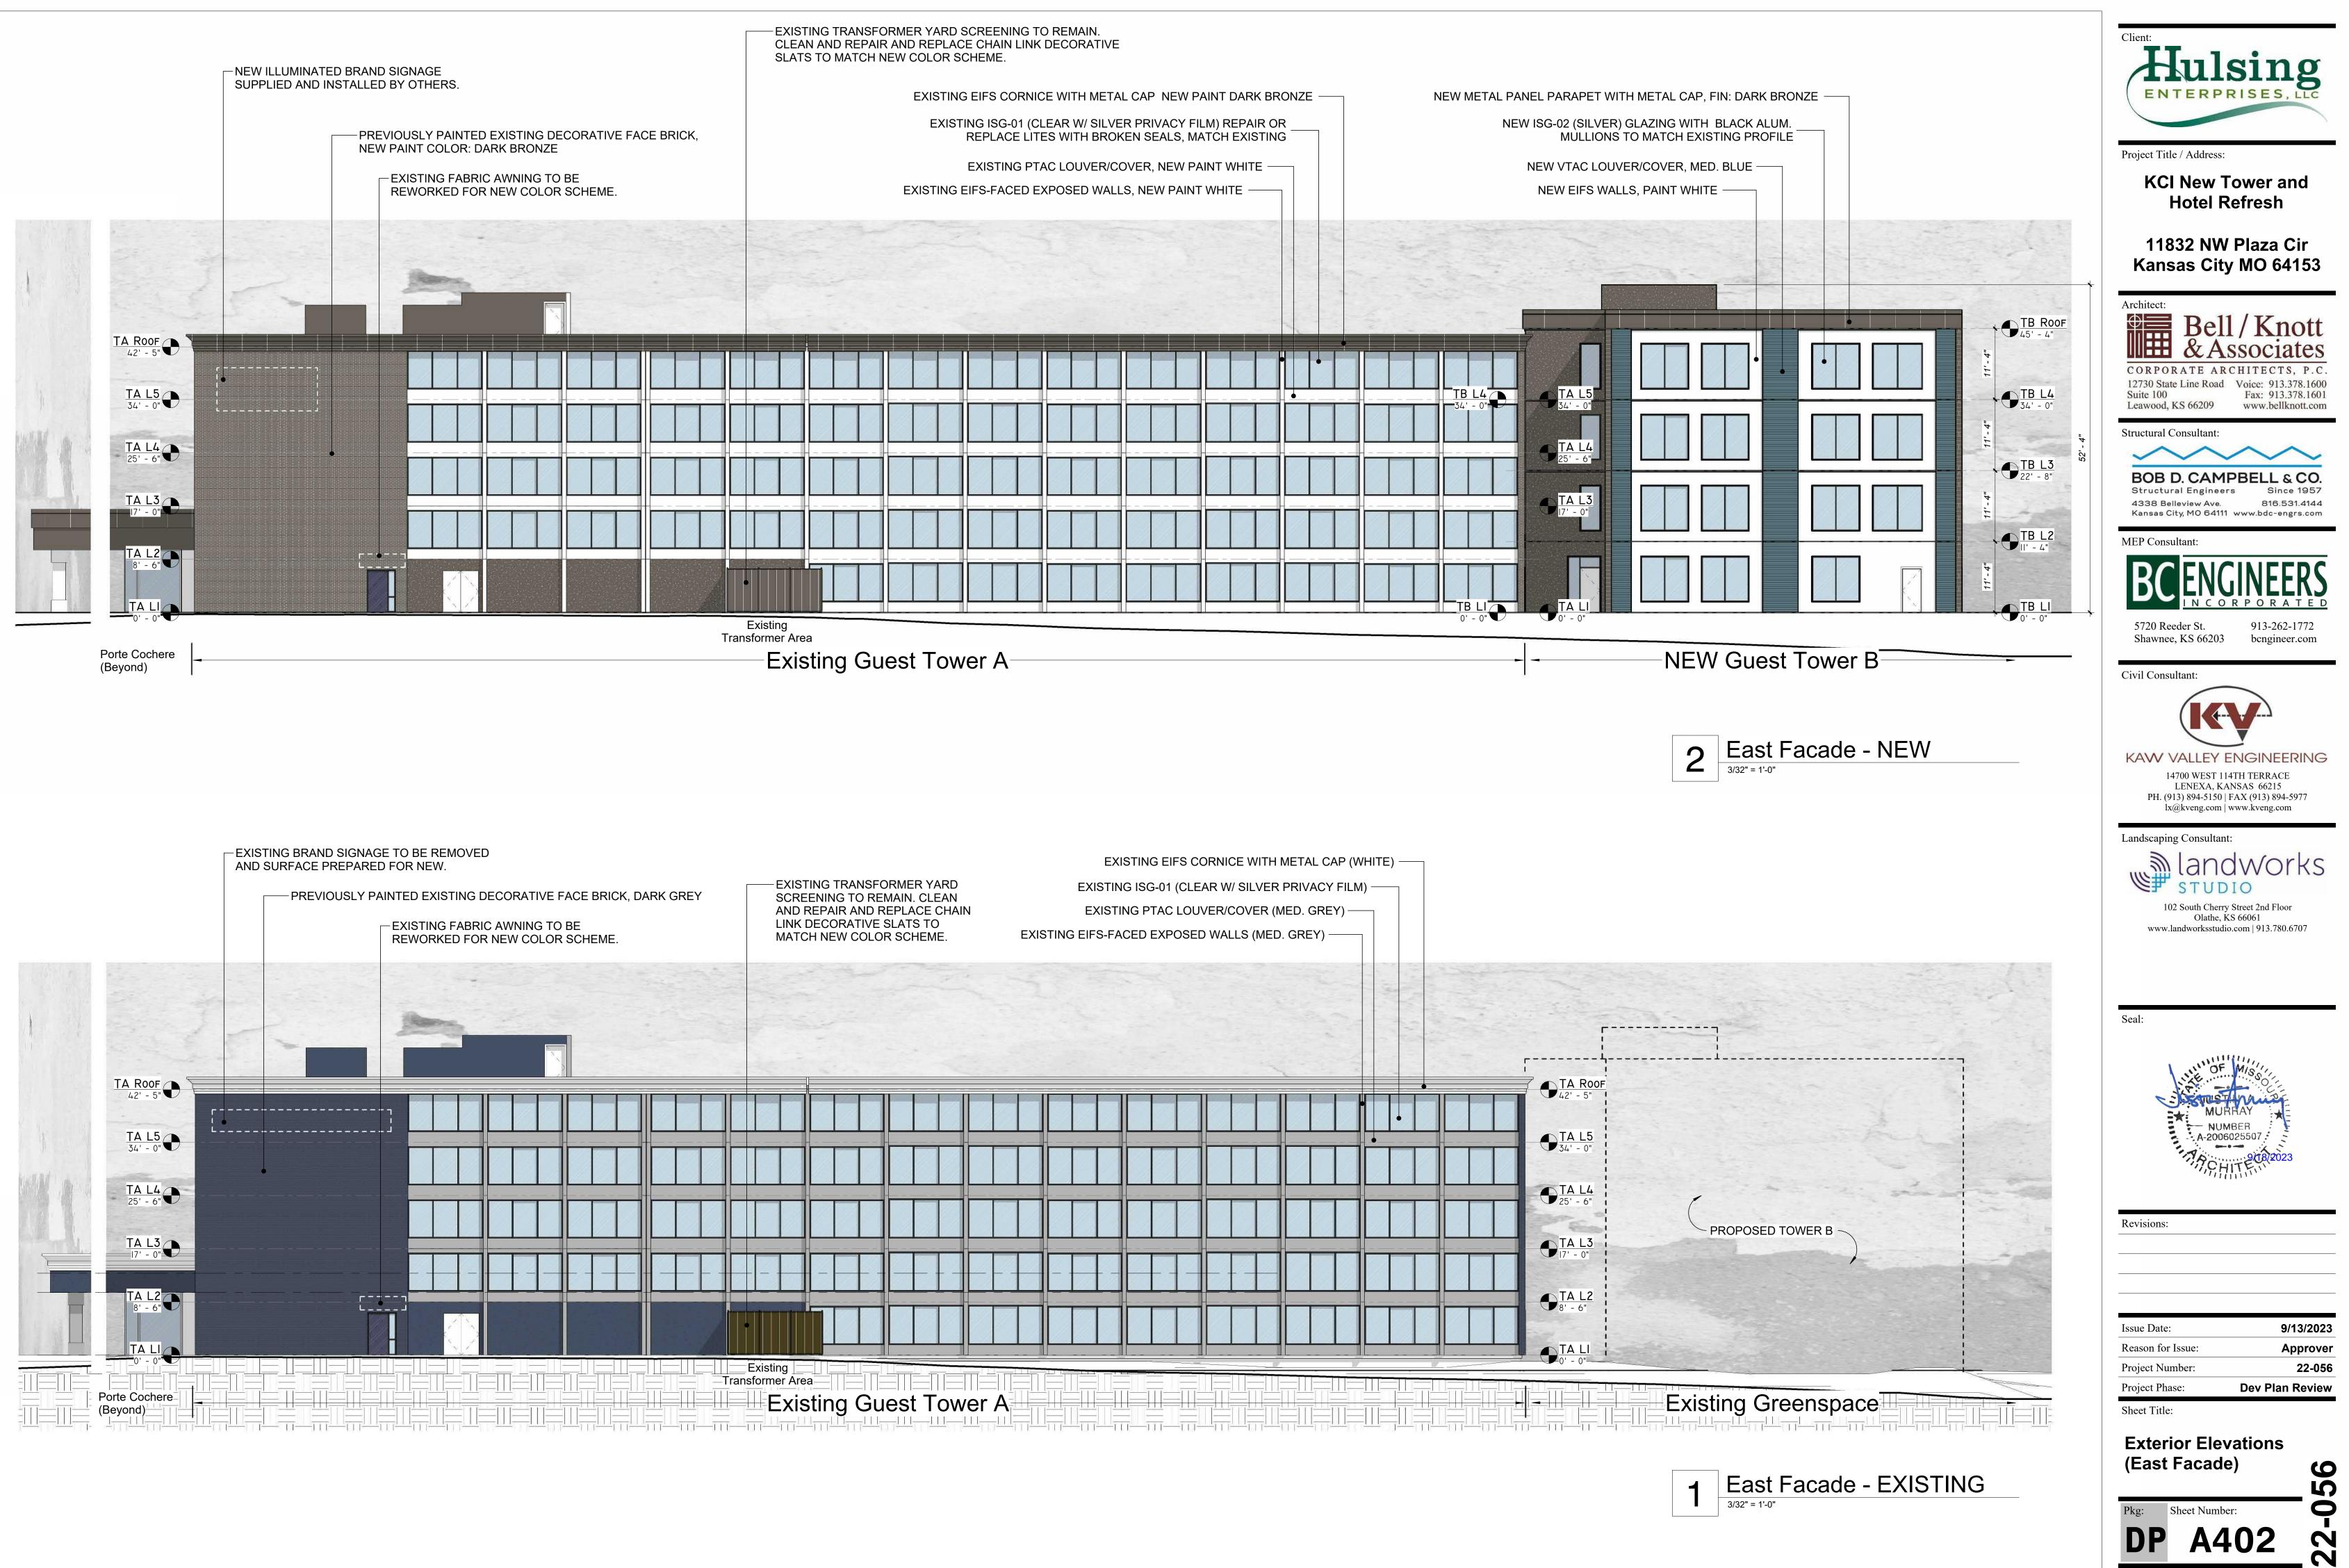


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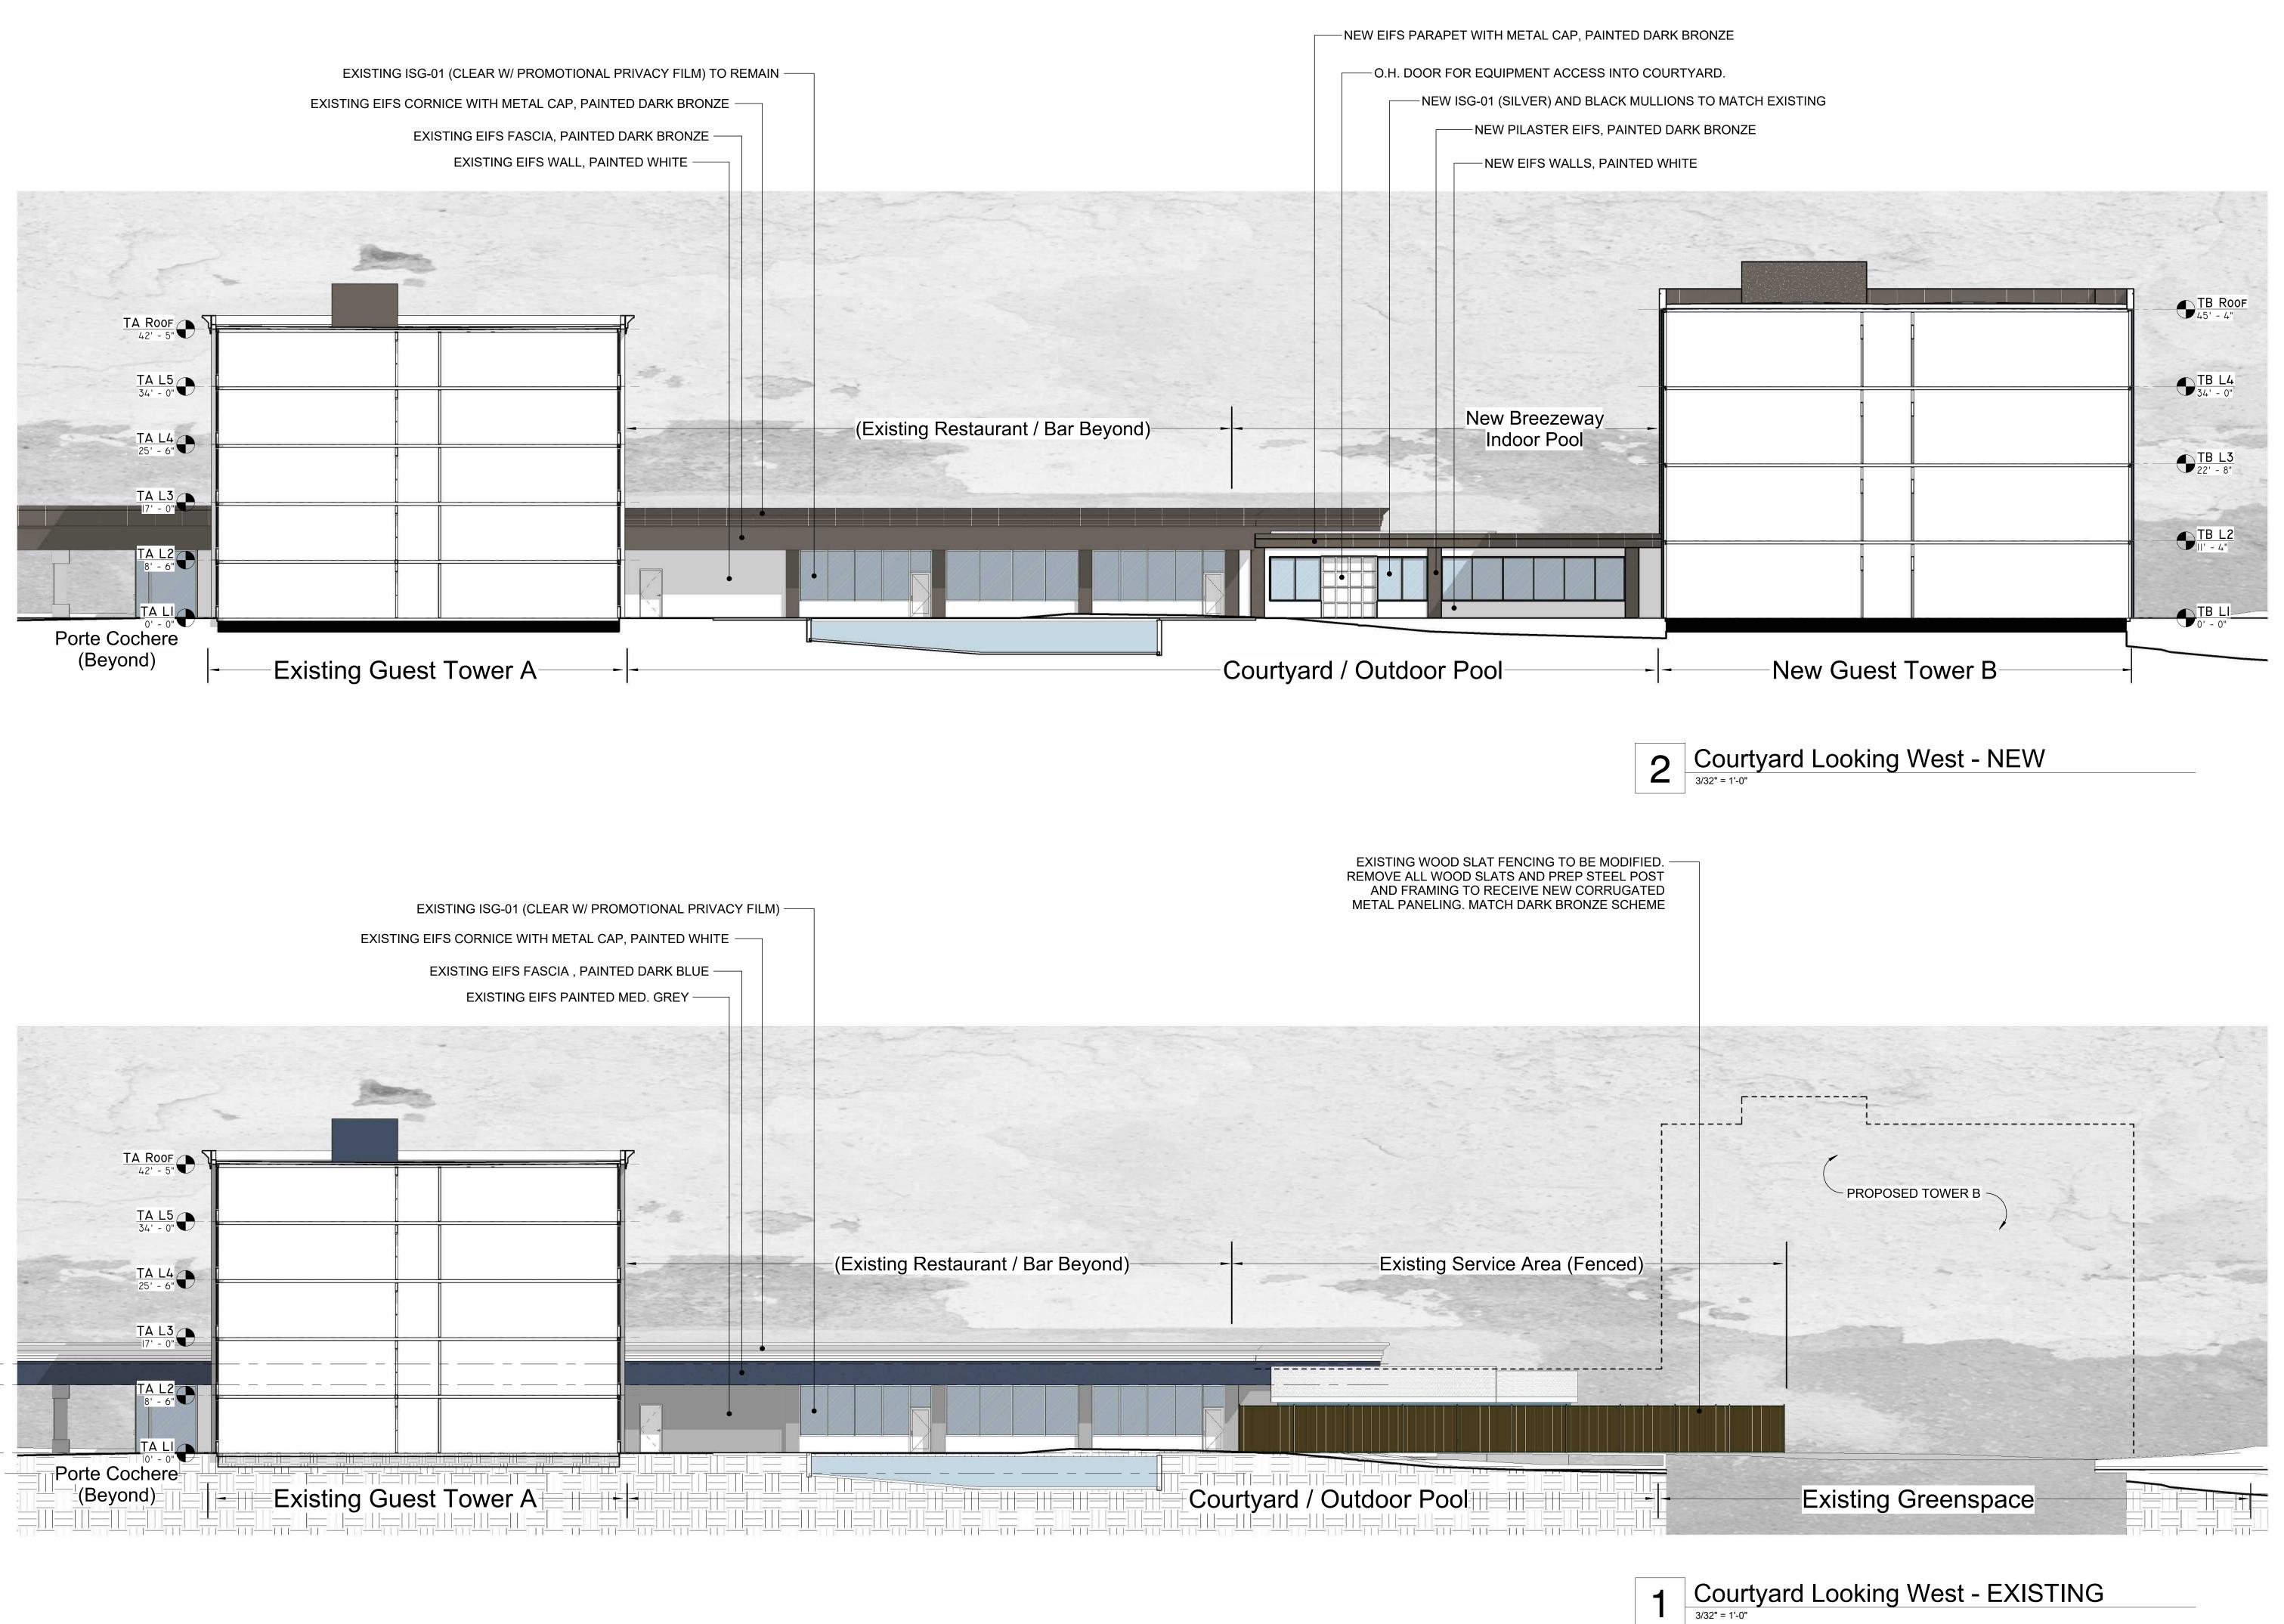


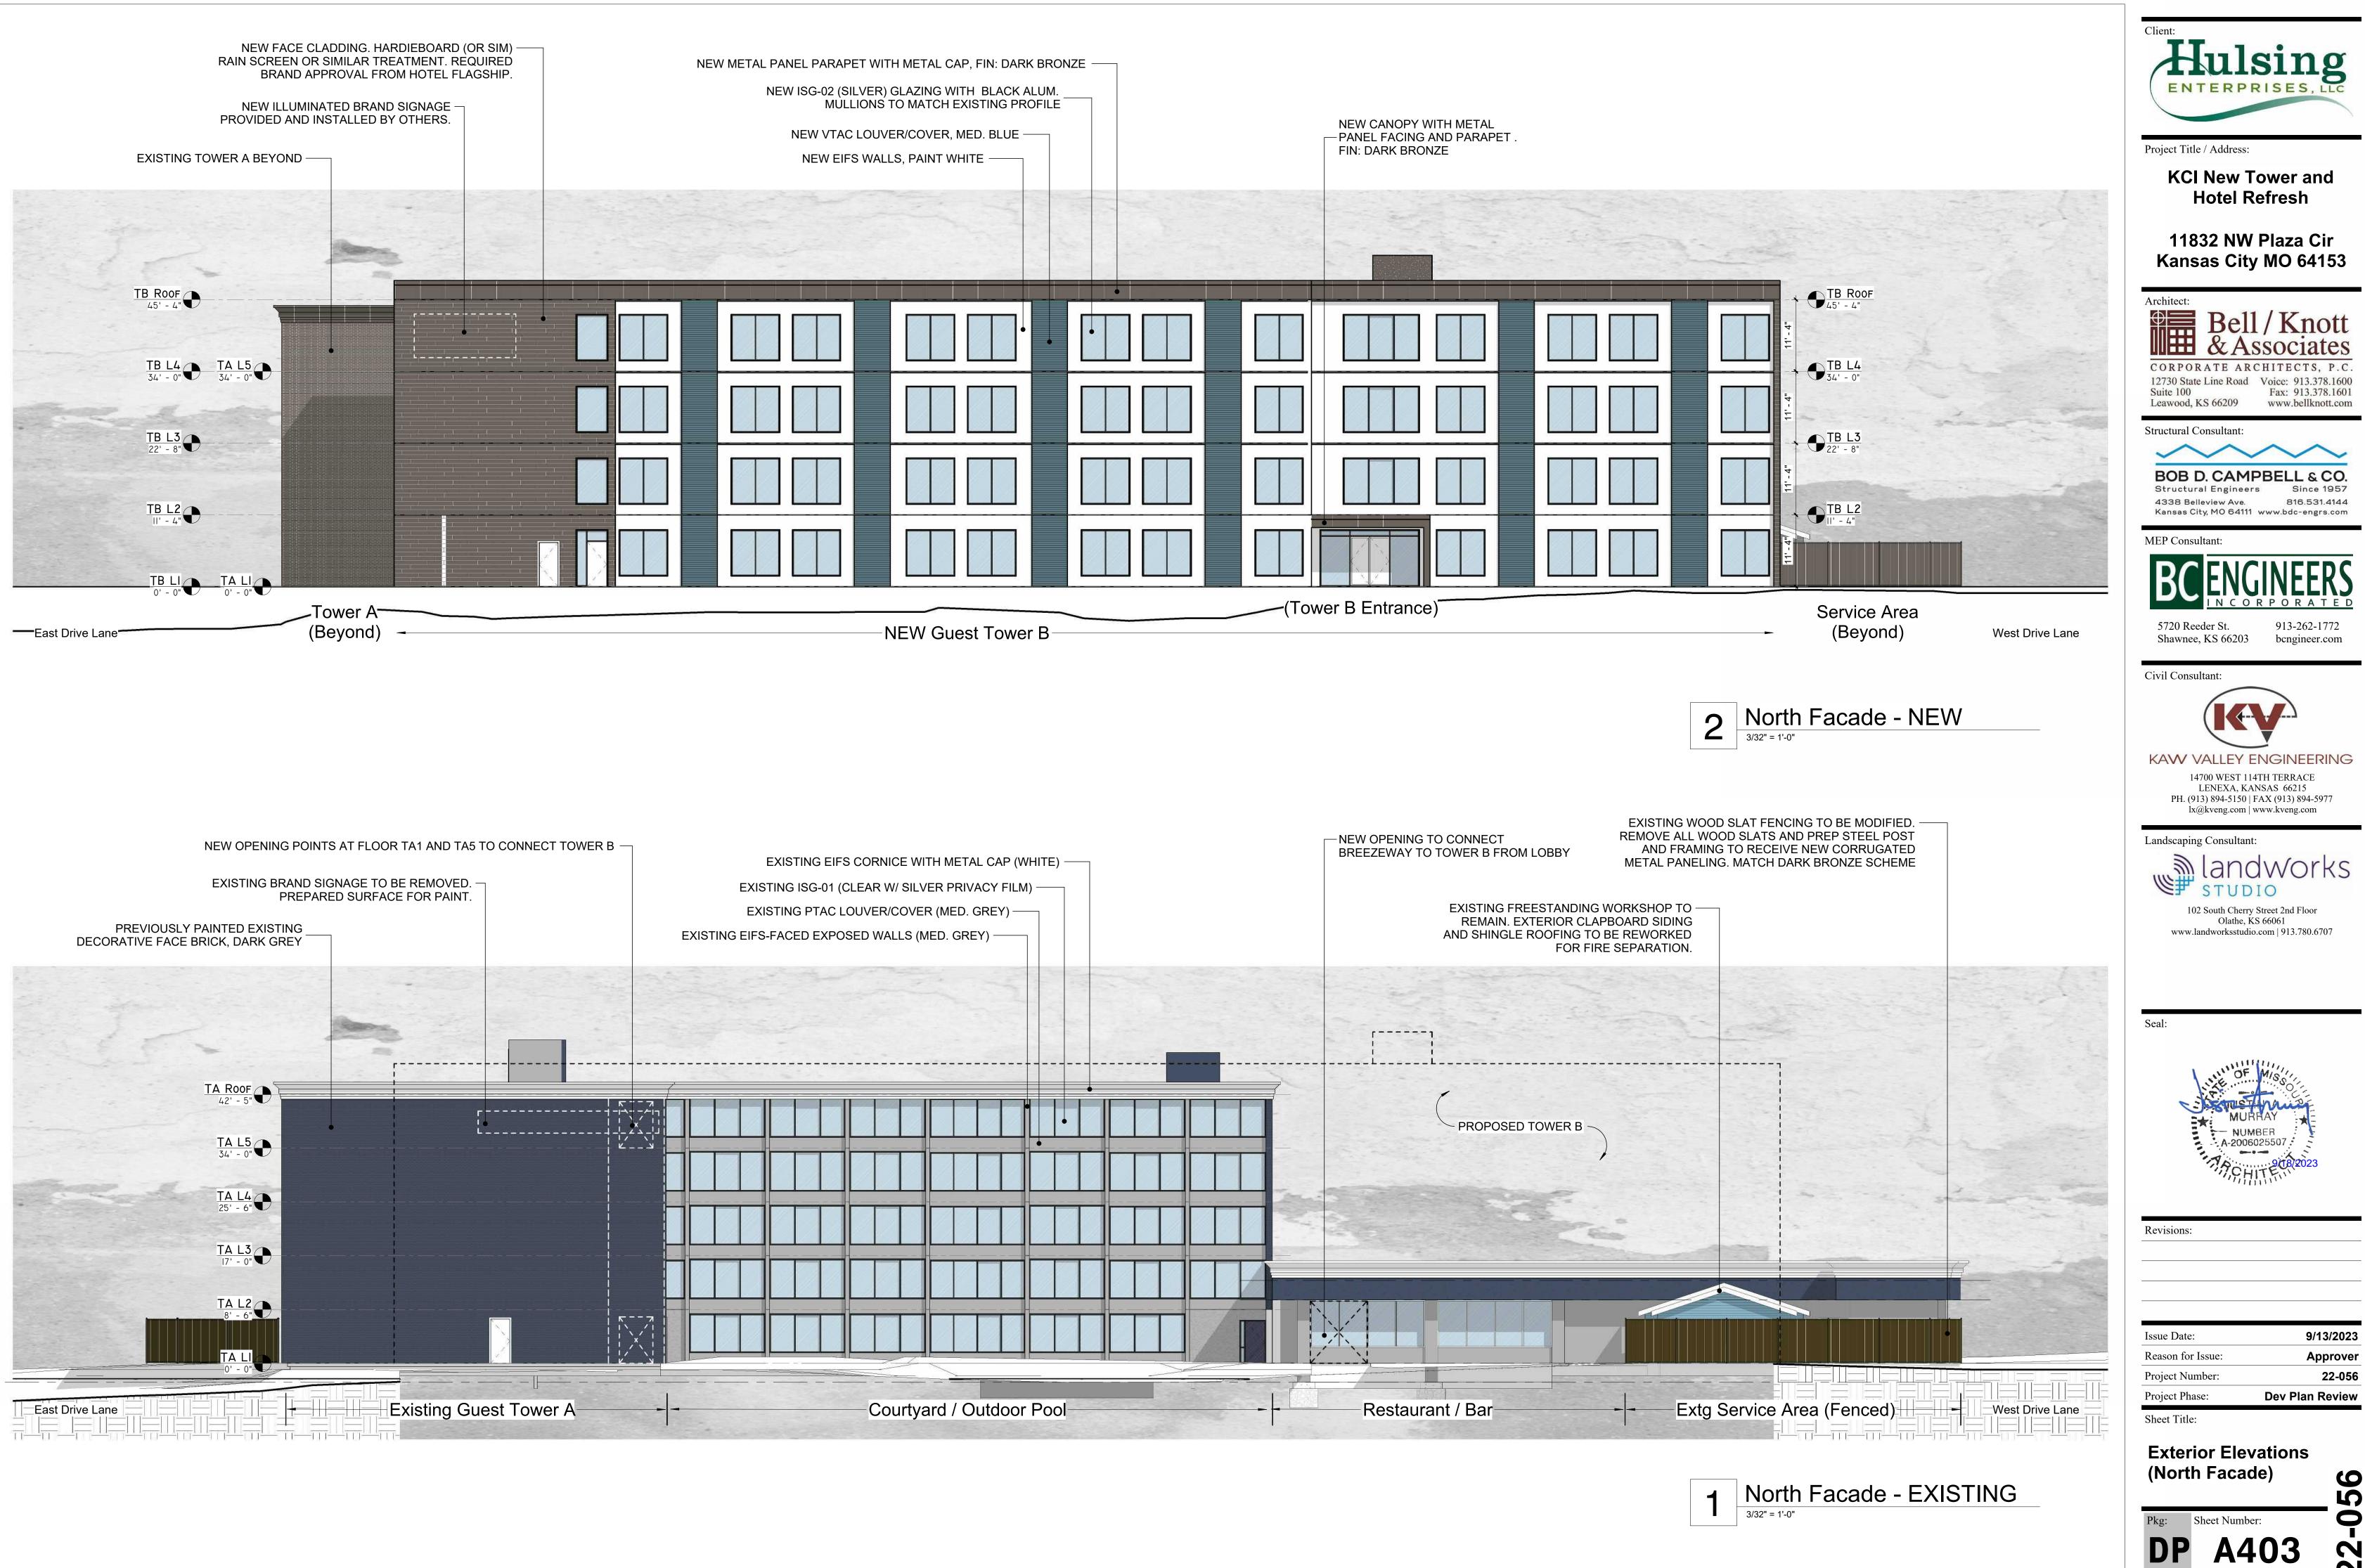

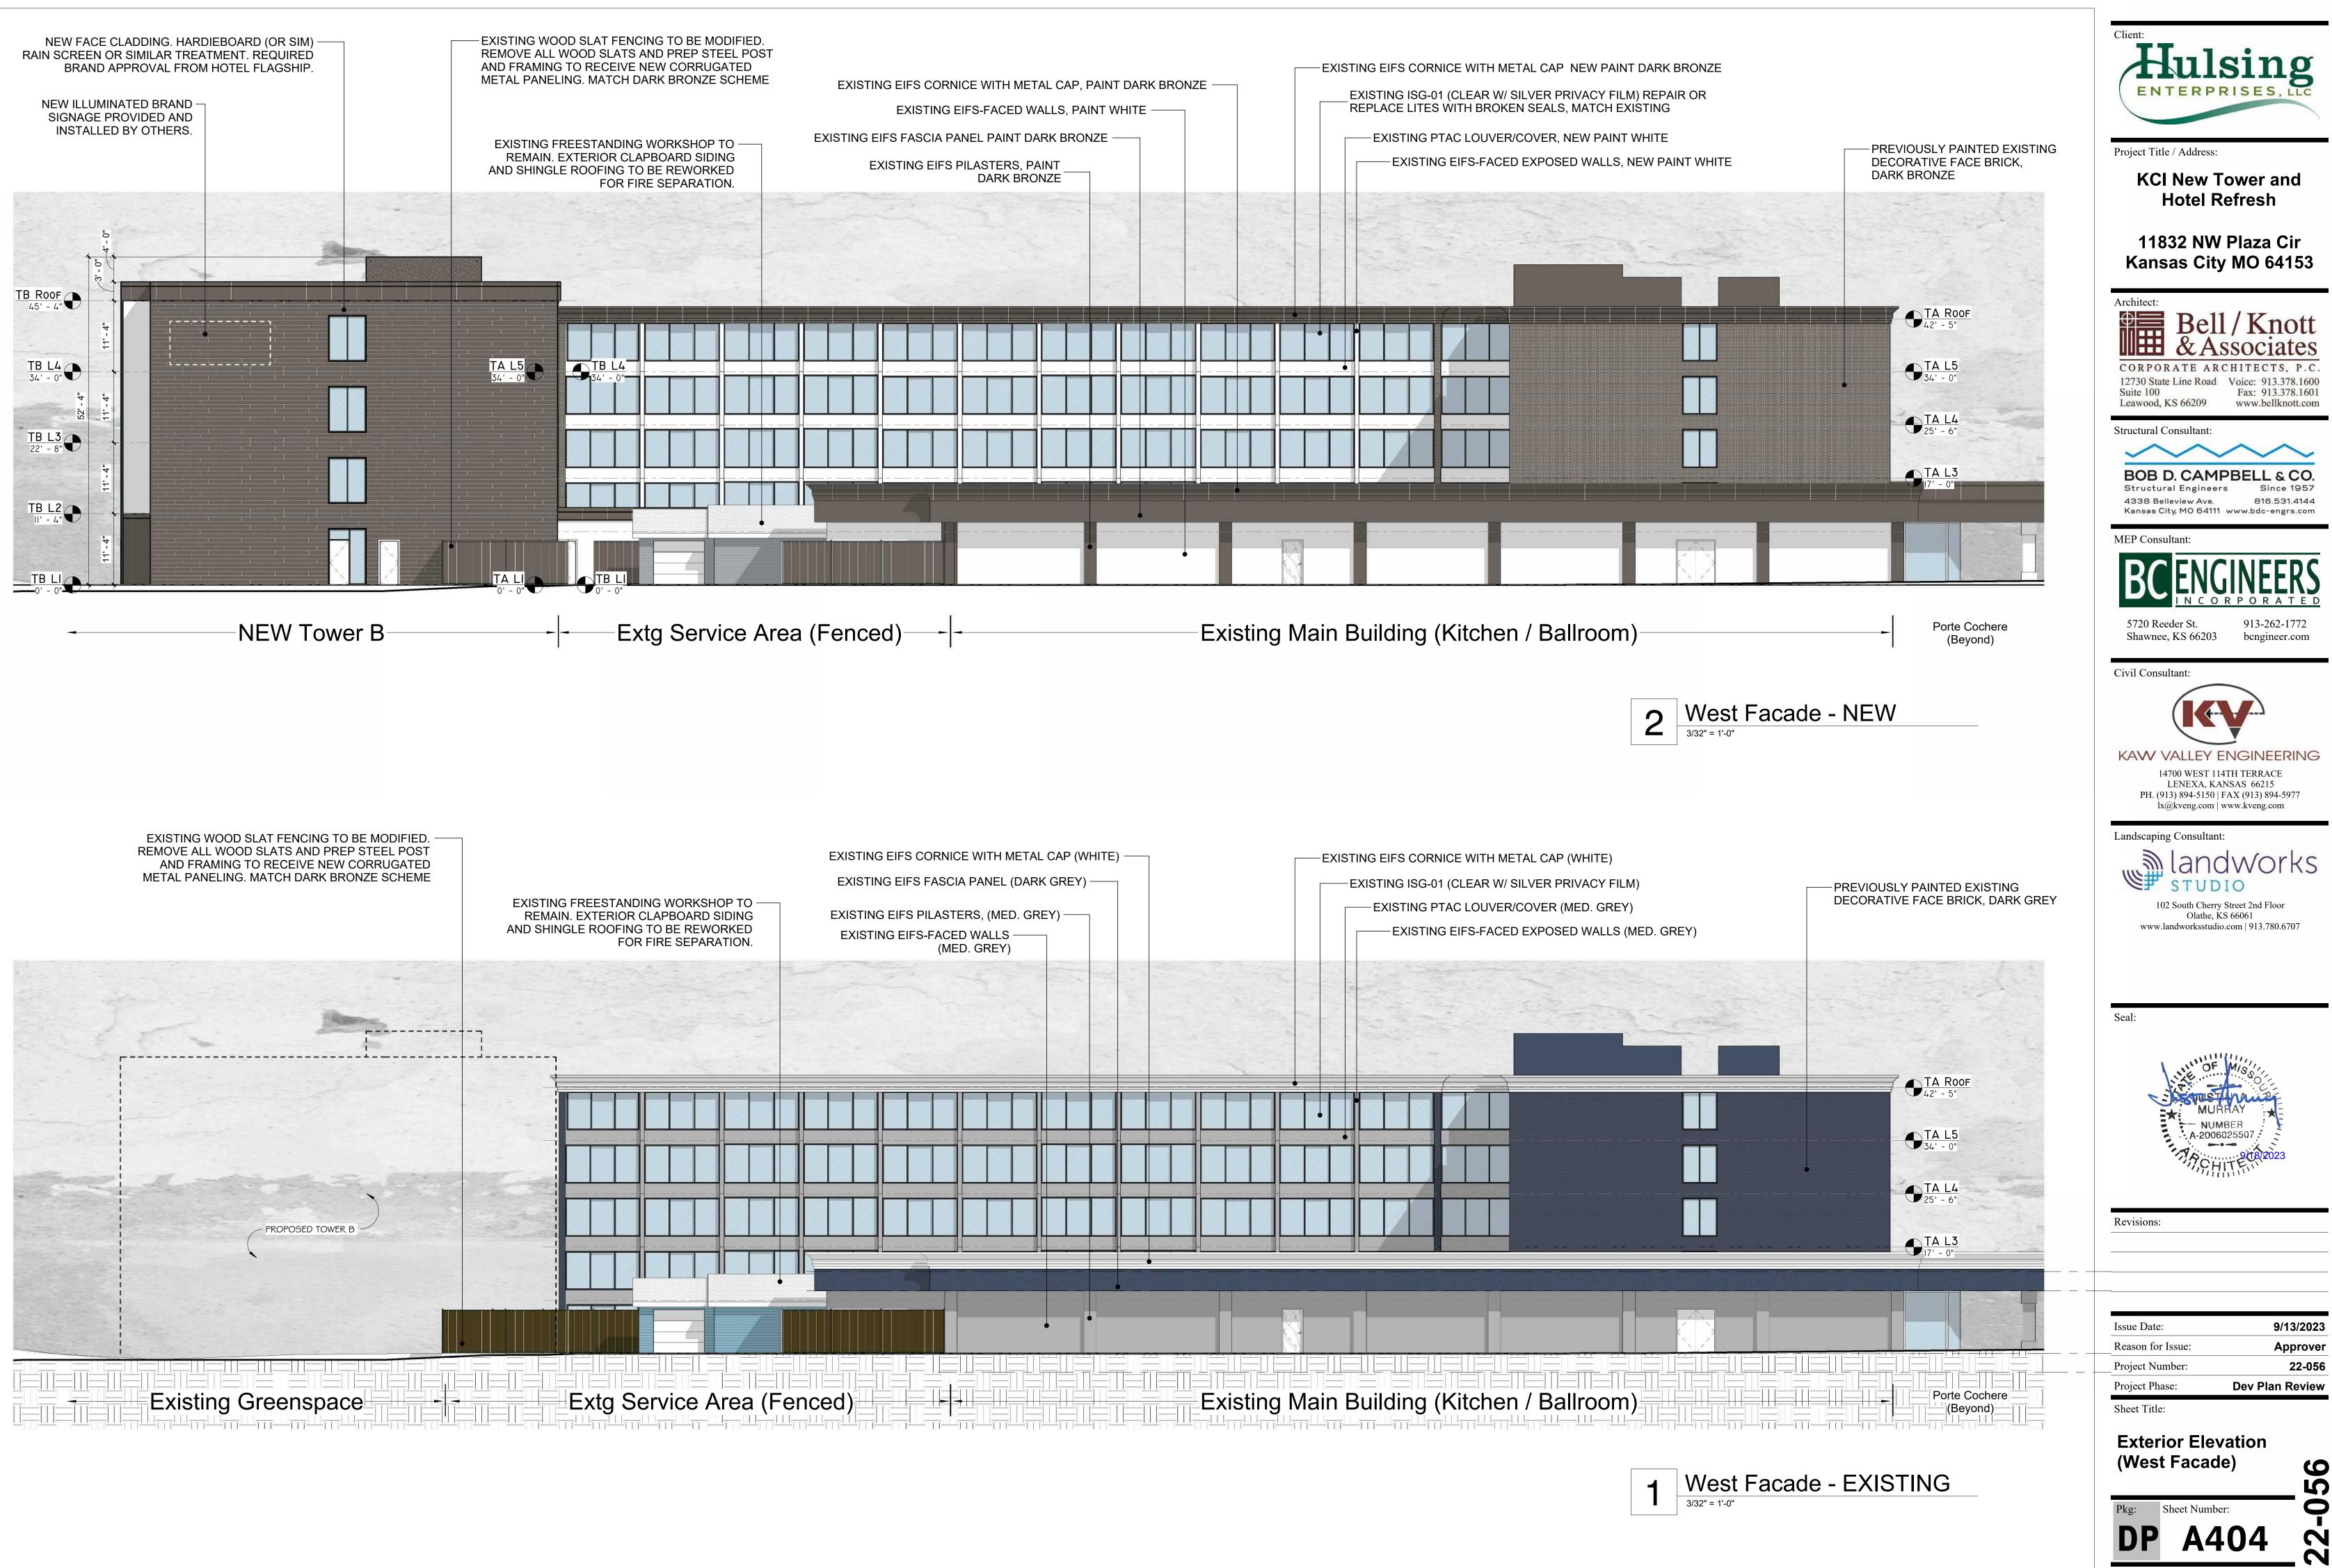EXISTING EIFS CORNICE WITH METAL CAP, PA	AINT DARK BRONZE	
EXISTING EIFS-FACED WALLS, PAIN		EXISTING ISG-01 (CLEAR W/ SILVER PRIVACY F REPLACE LITES WITH BROKEN SEALS, MATCH
EXISTING EIFS FASCIA PANEL PAINT DARK BRONZ	ze —	EXISTING PTAC LOUVER/COVER, NEW PAIN
EXISTING EIFS PILASTERS, PAINT DARK BRONZE		EXISTING EIFS-FACED EXPOSED WALLS
	• • • • • • • • • • • • • • • • • • •	

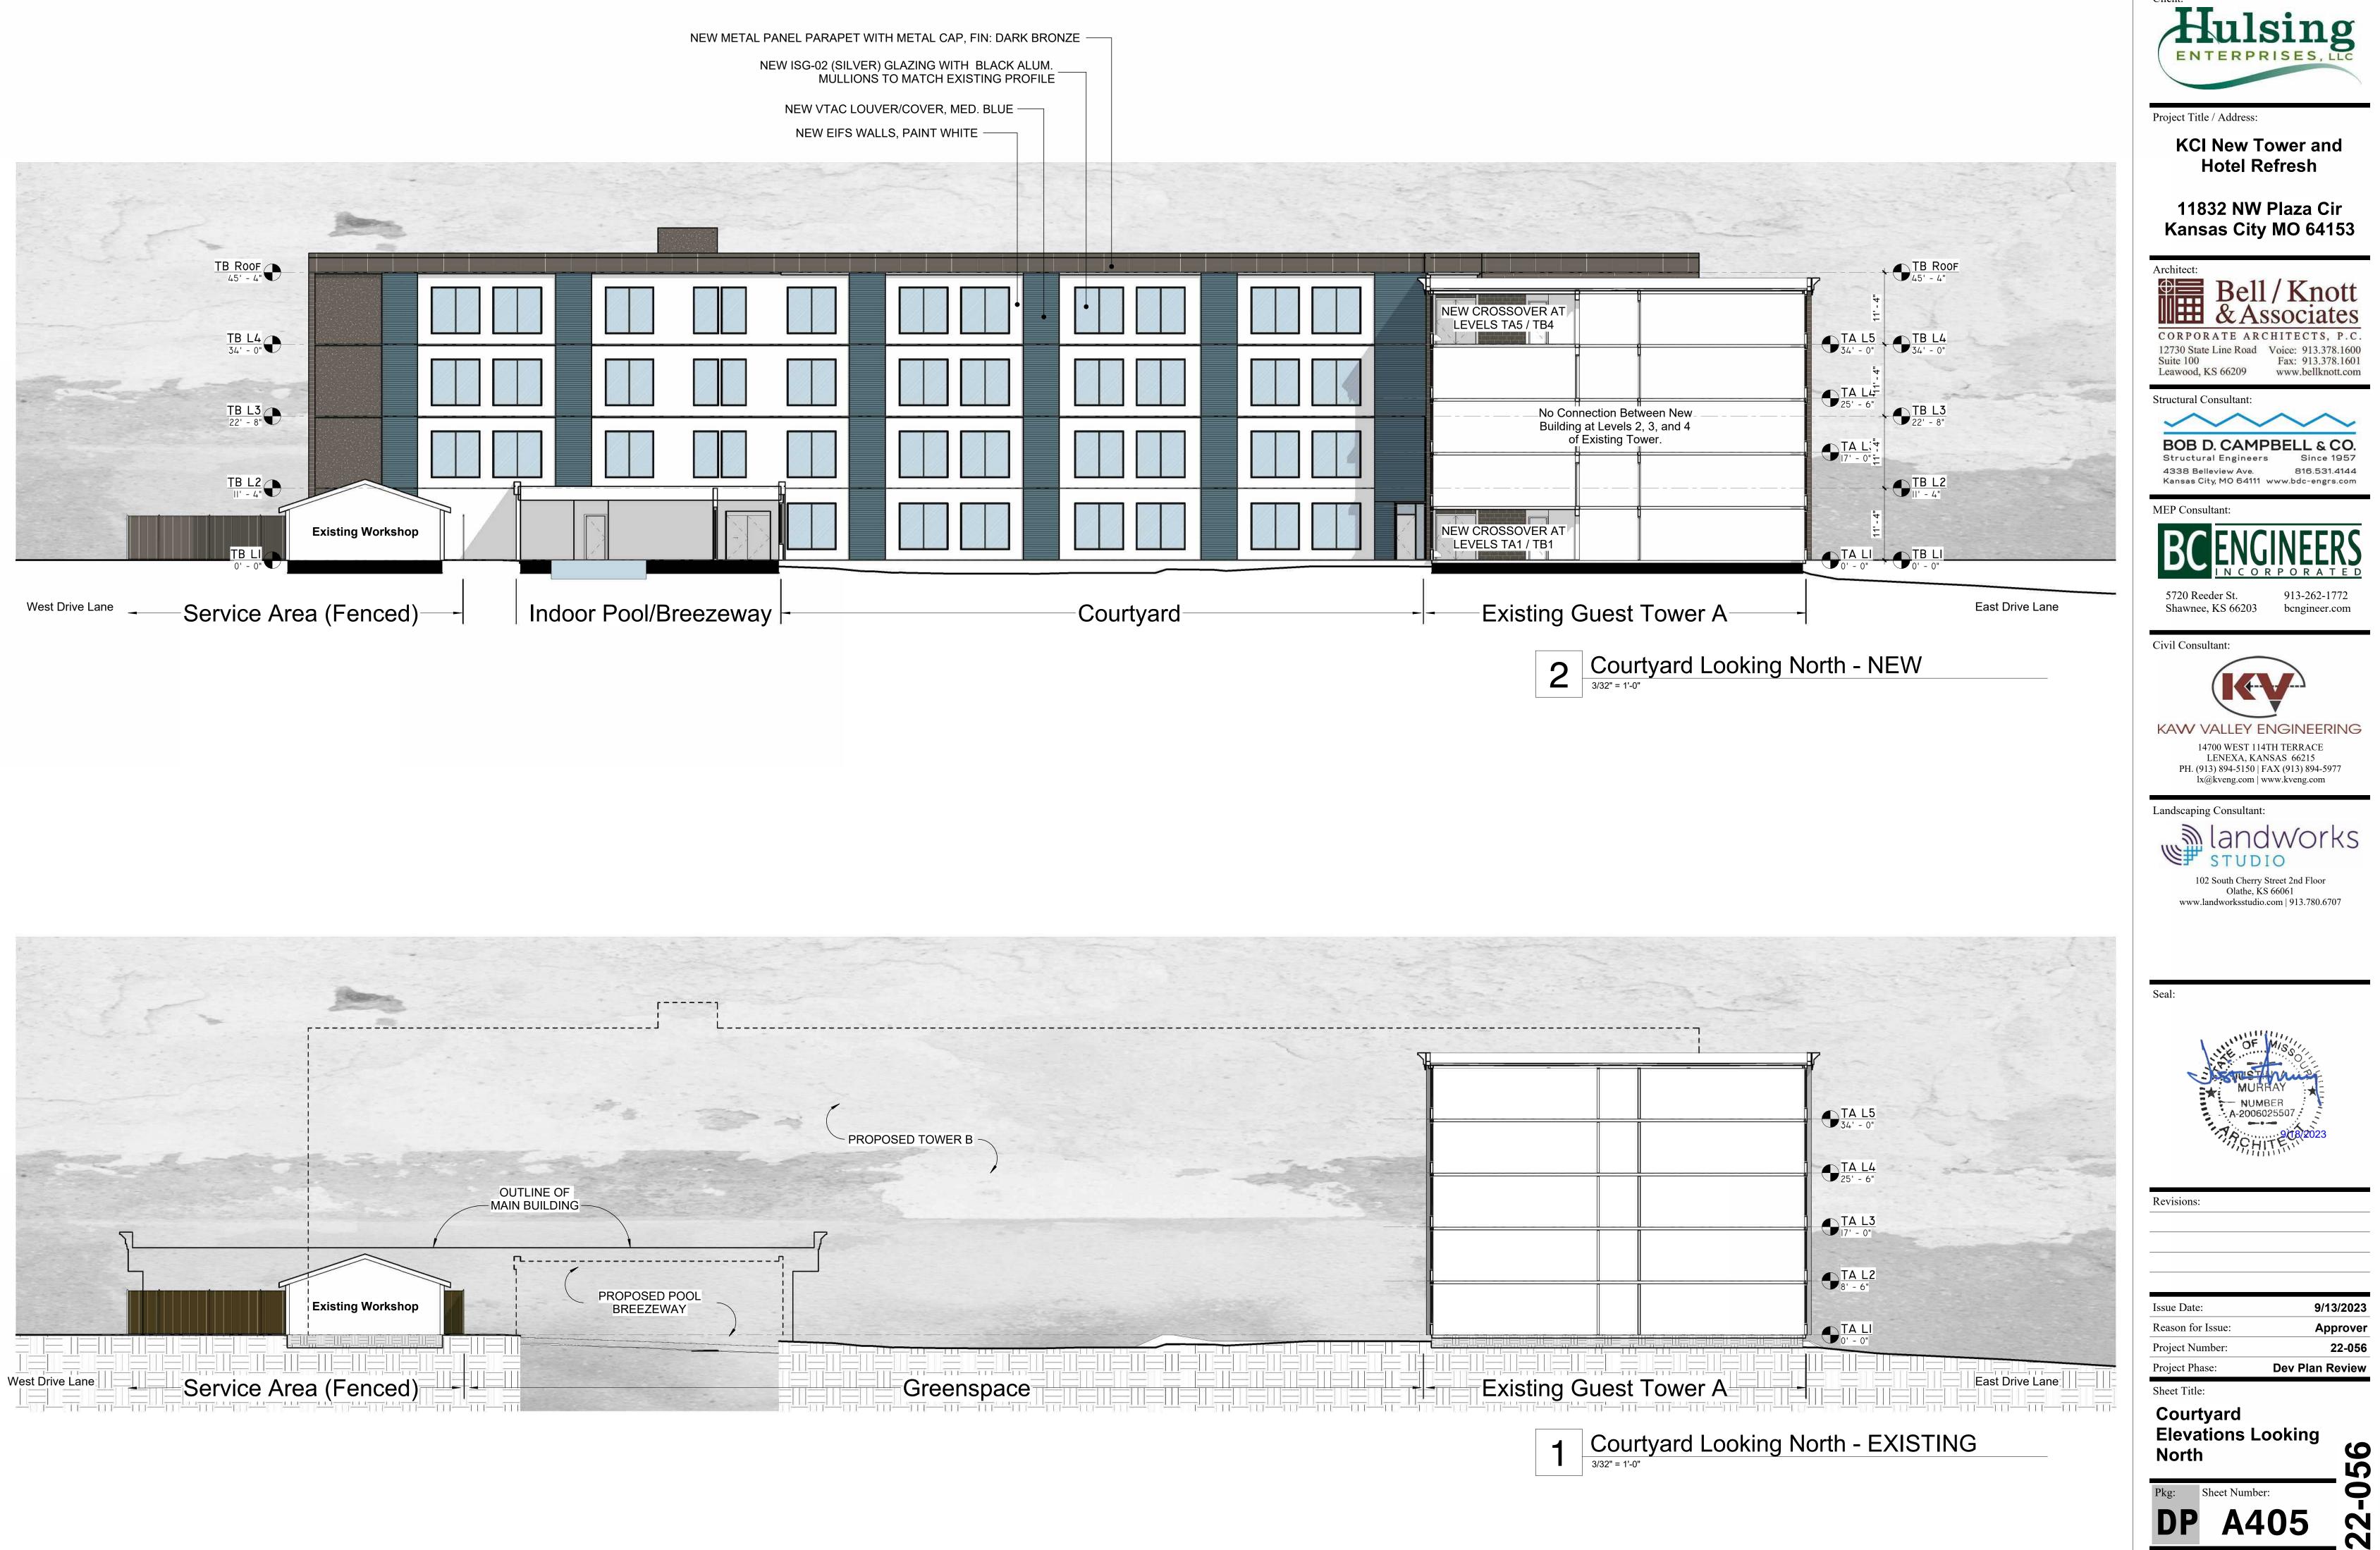


Client:







Pkg: Sheet Number DP A406

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WITH METAL CAP NEW PAINT DARK BRONZE R W/ SILVER PRIVACY FILM) REPAIR OR WITH BROKEN SEALS, MATCH EXISTING	
LOUVER/COVER, NEW PAINT WHITE	
urtvard / Outdoor Dool	Main Build

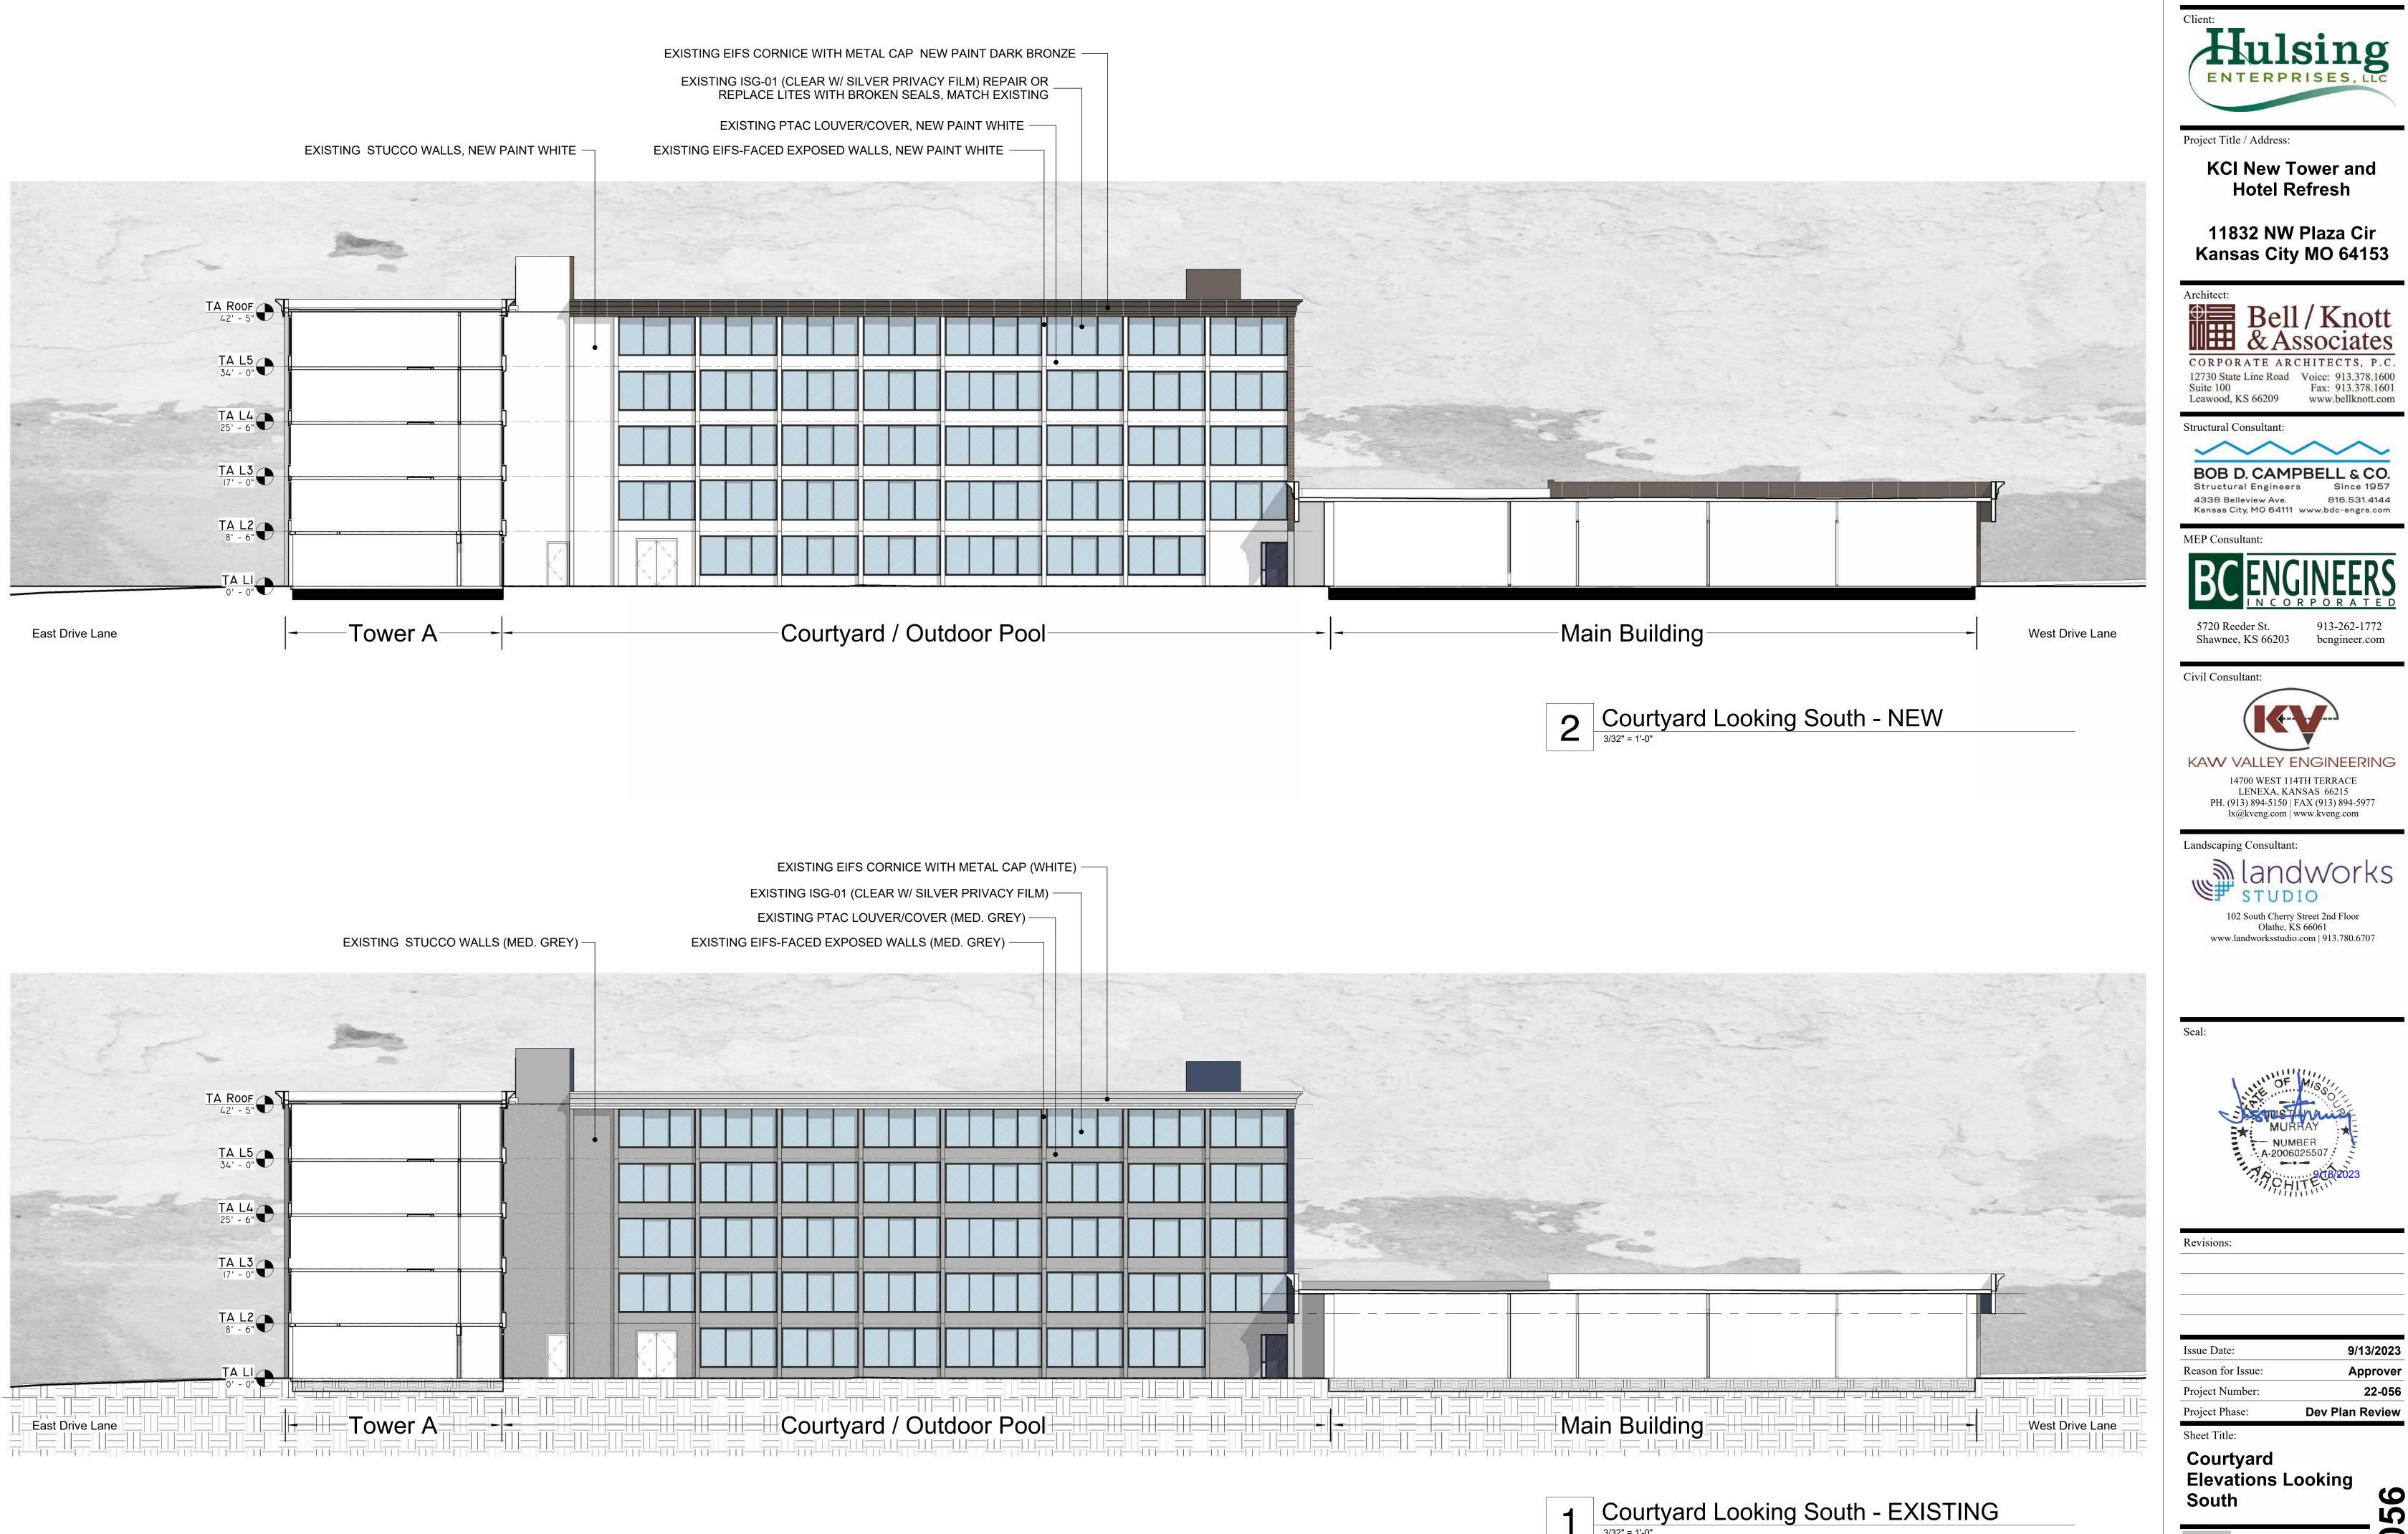


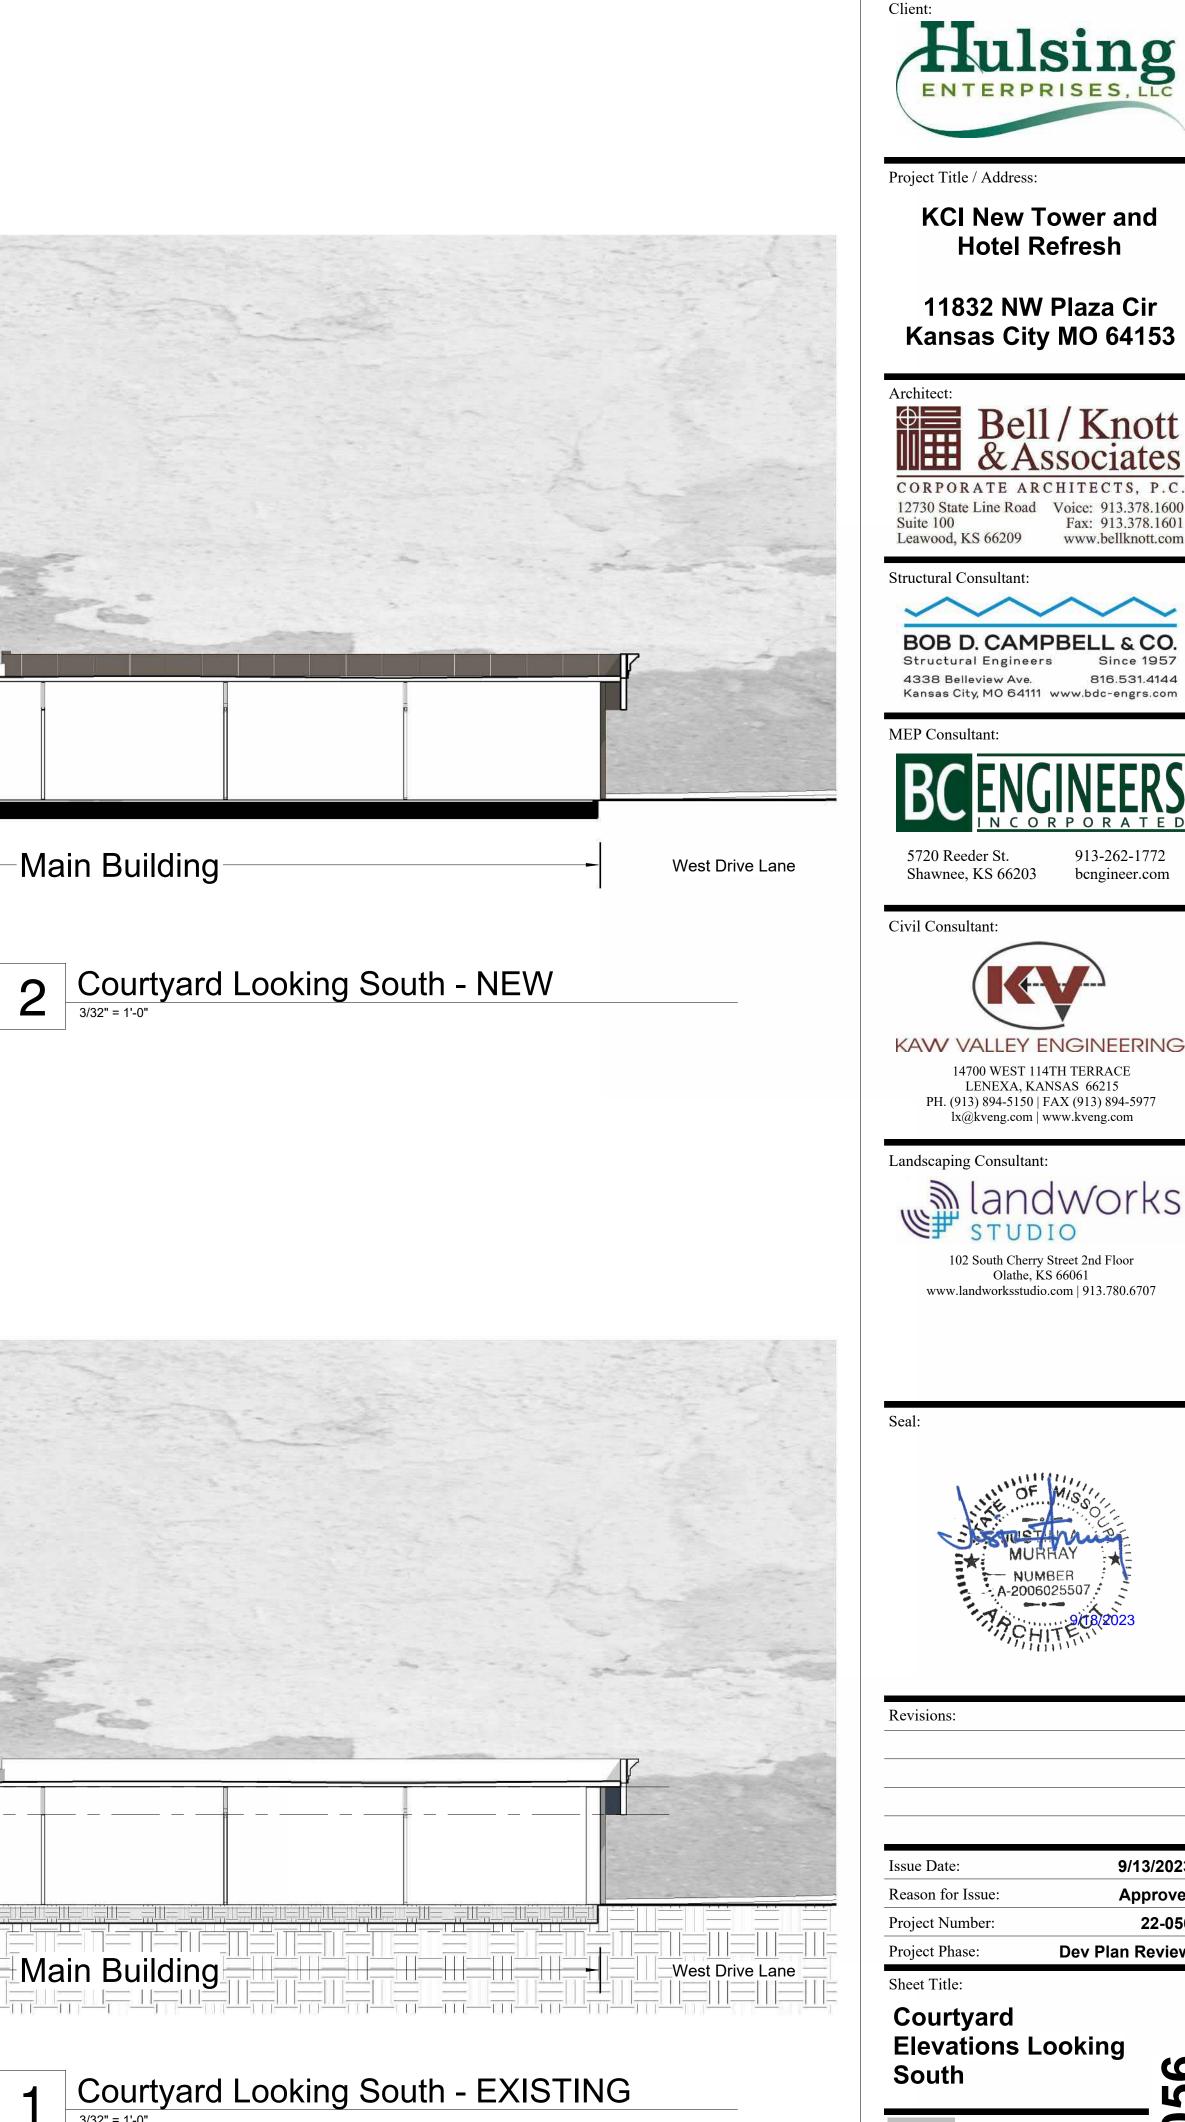

DP

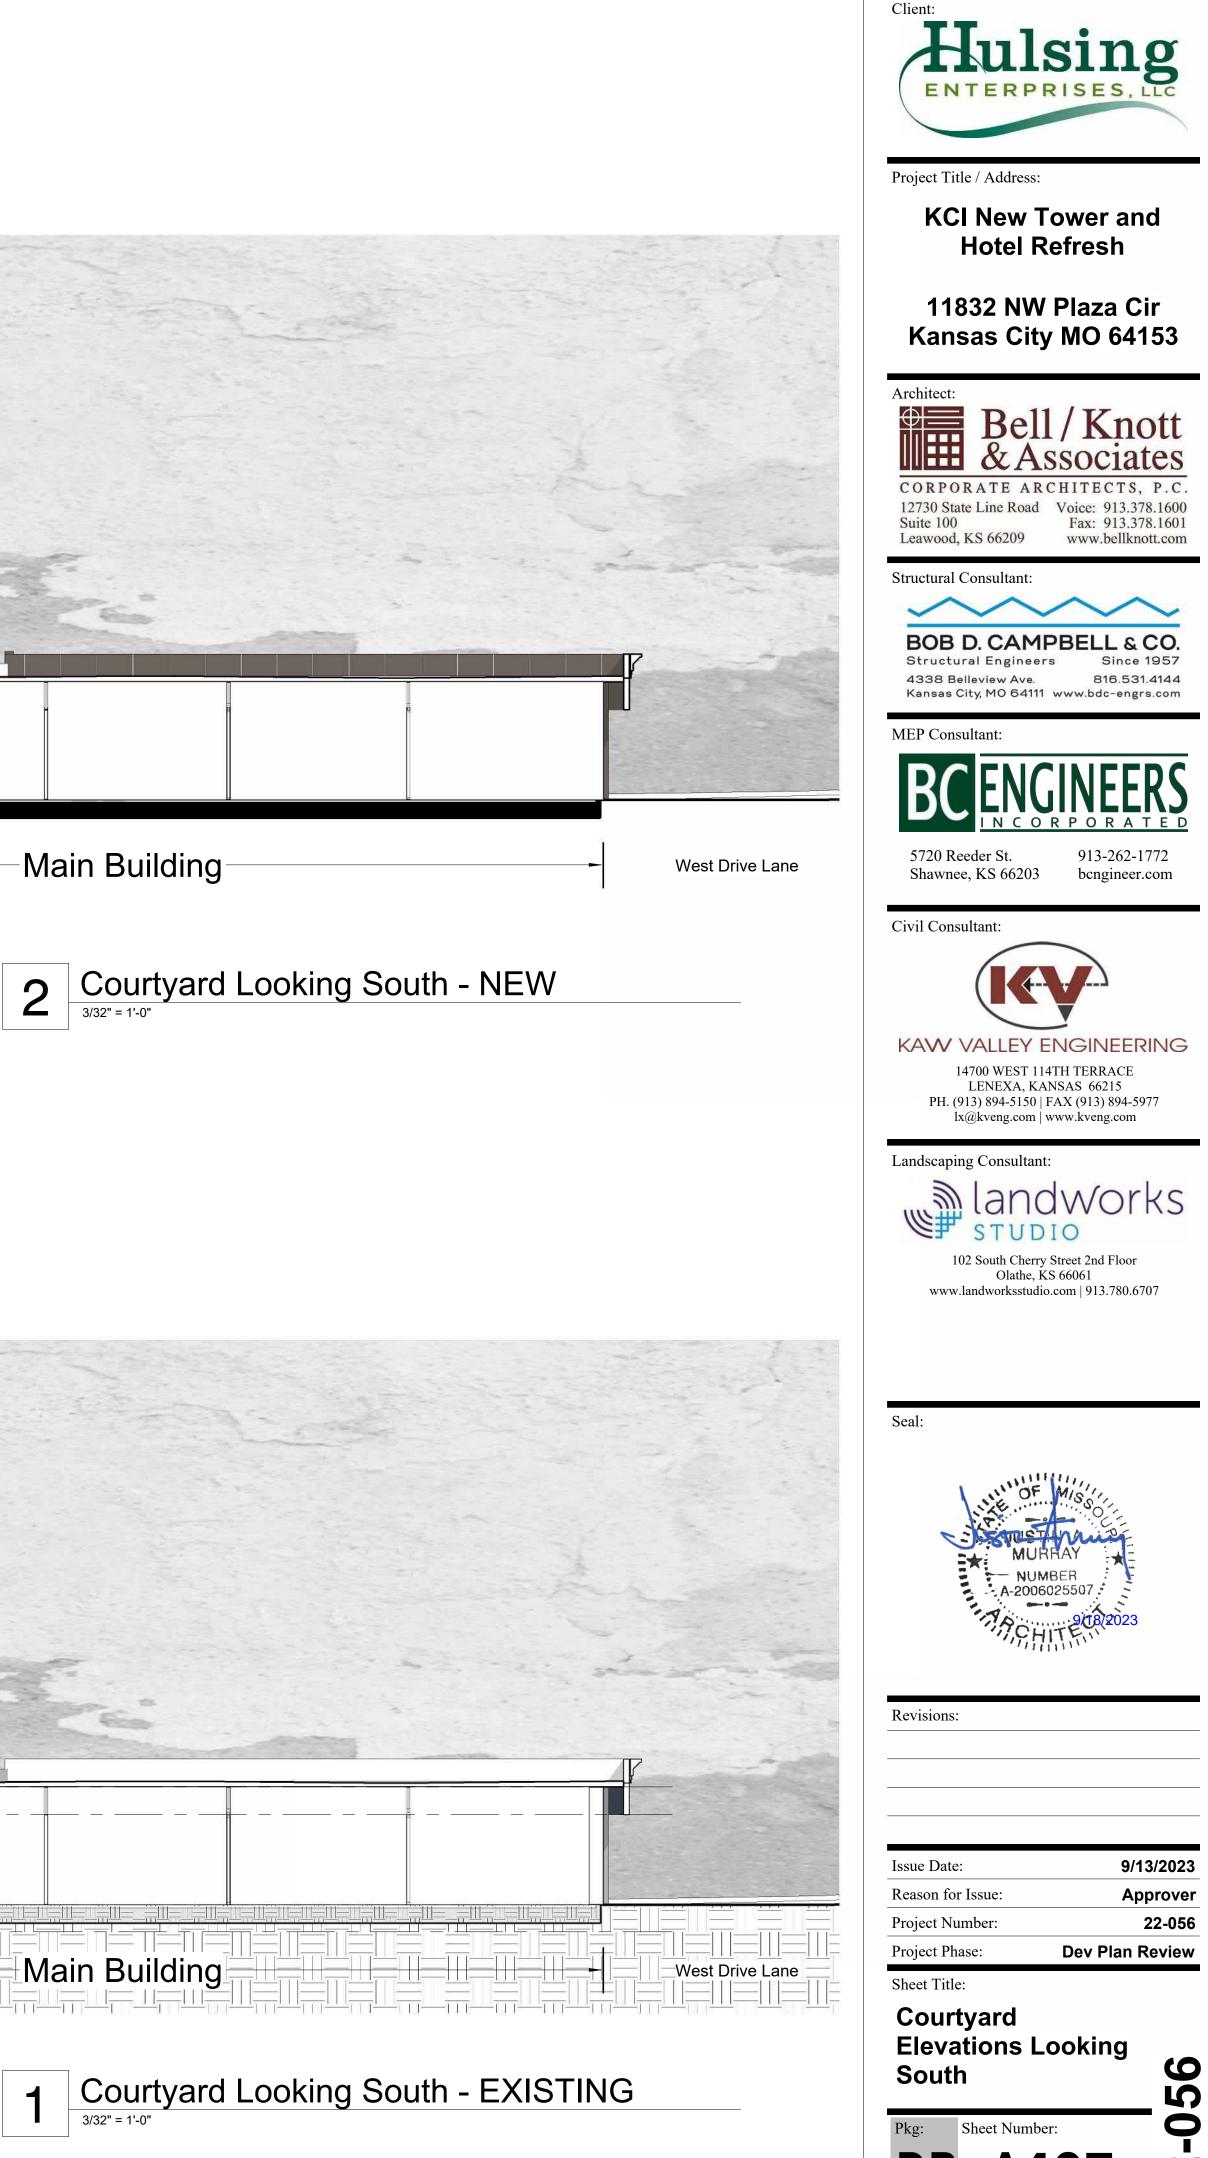A40


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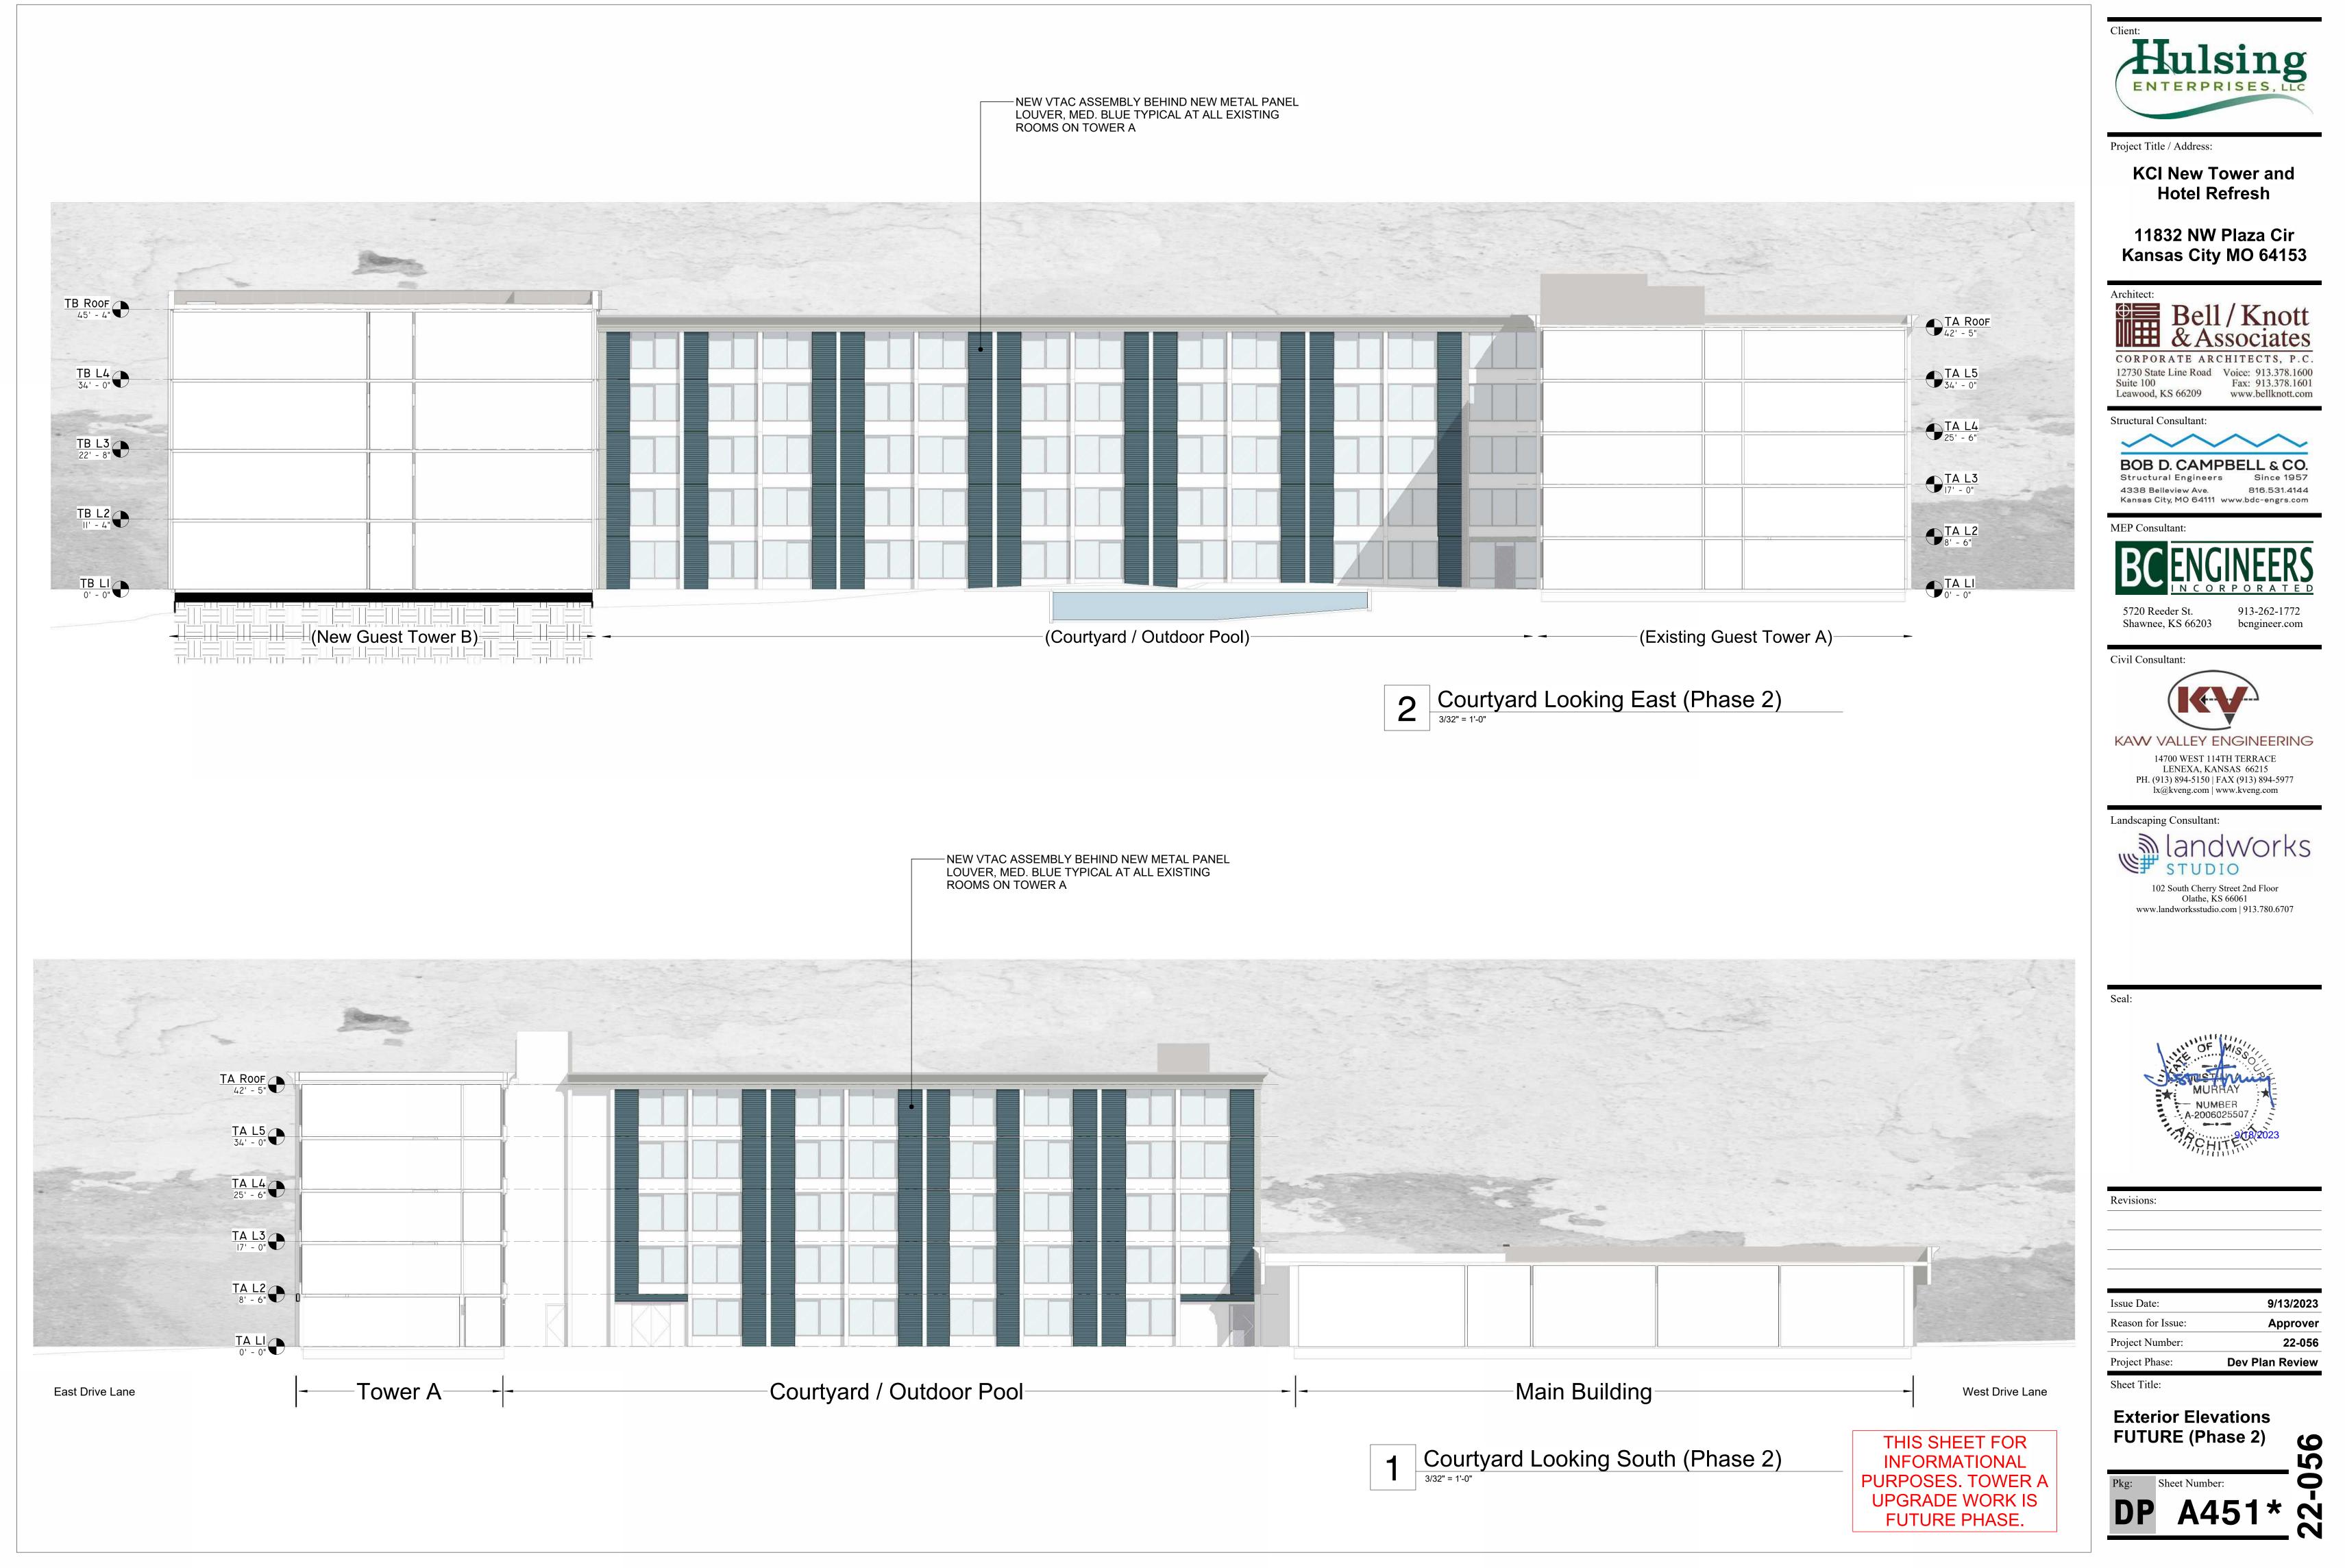


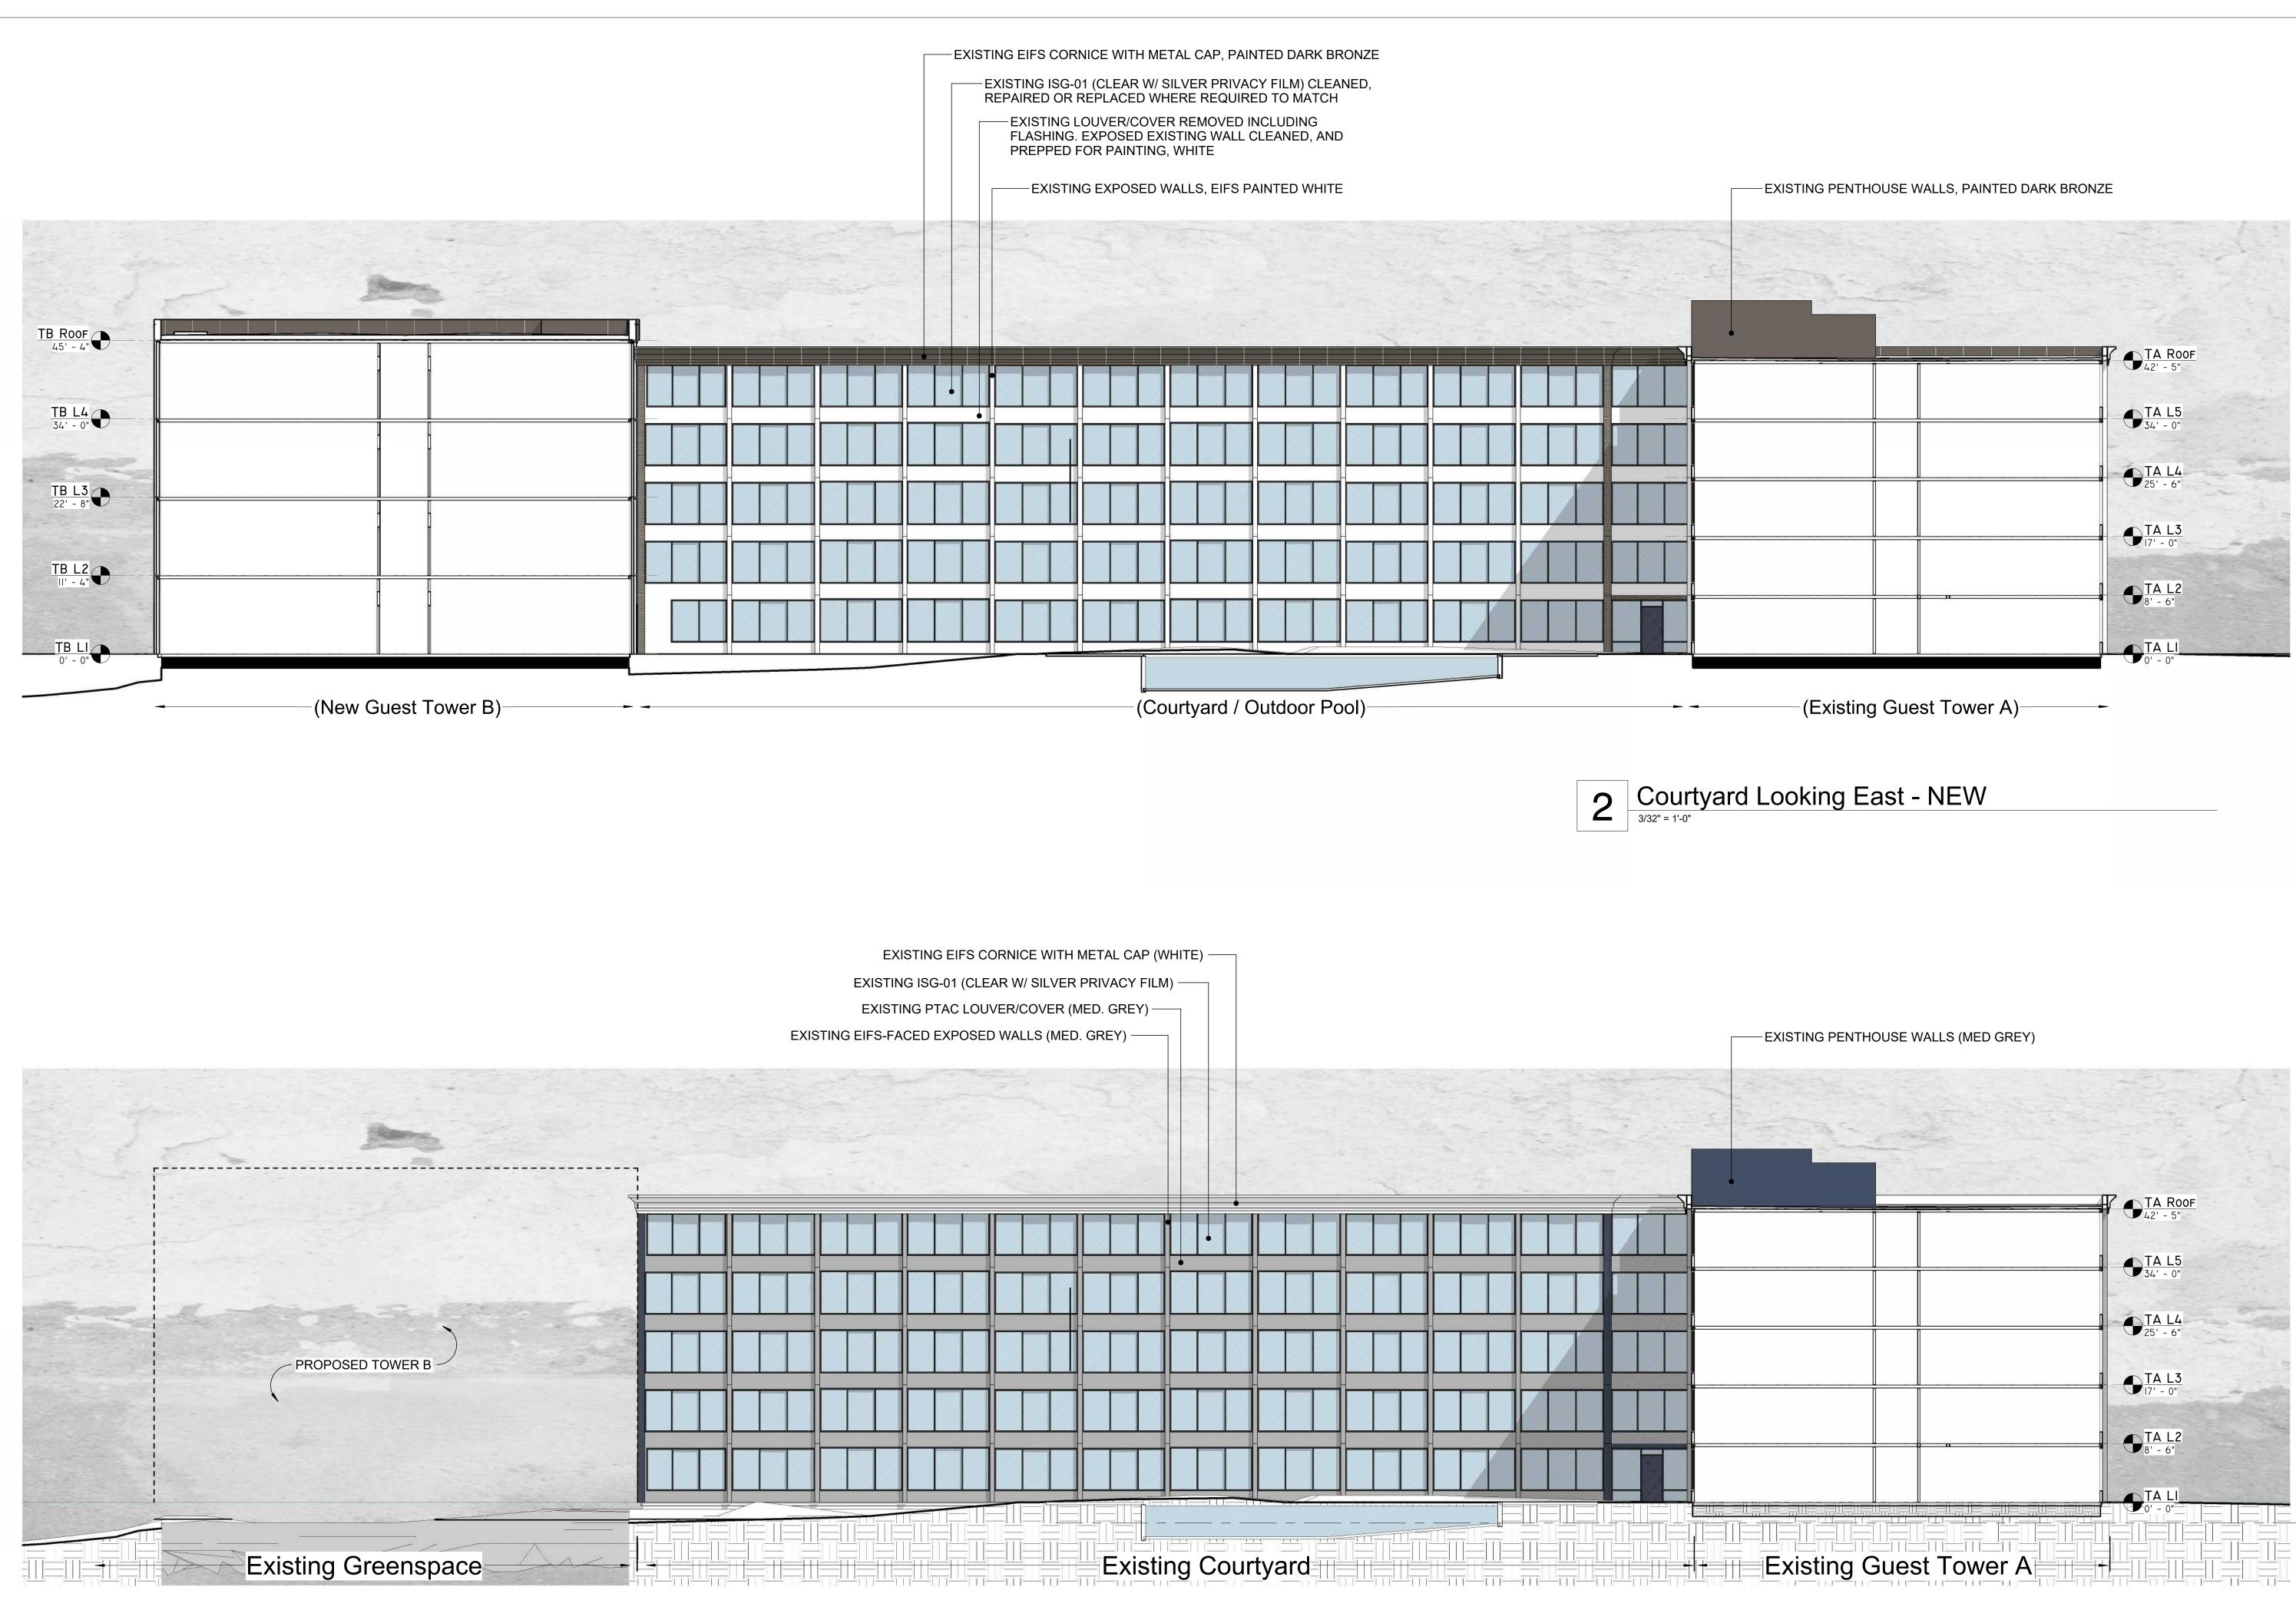


**UPGRADE WORK IS** 

FUTURE PHASE.



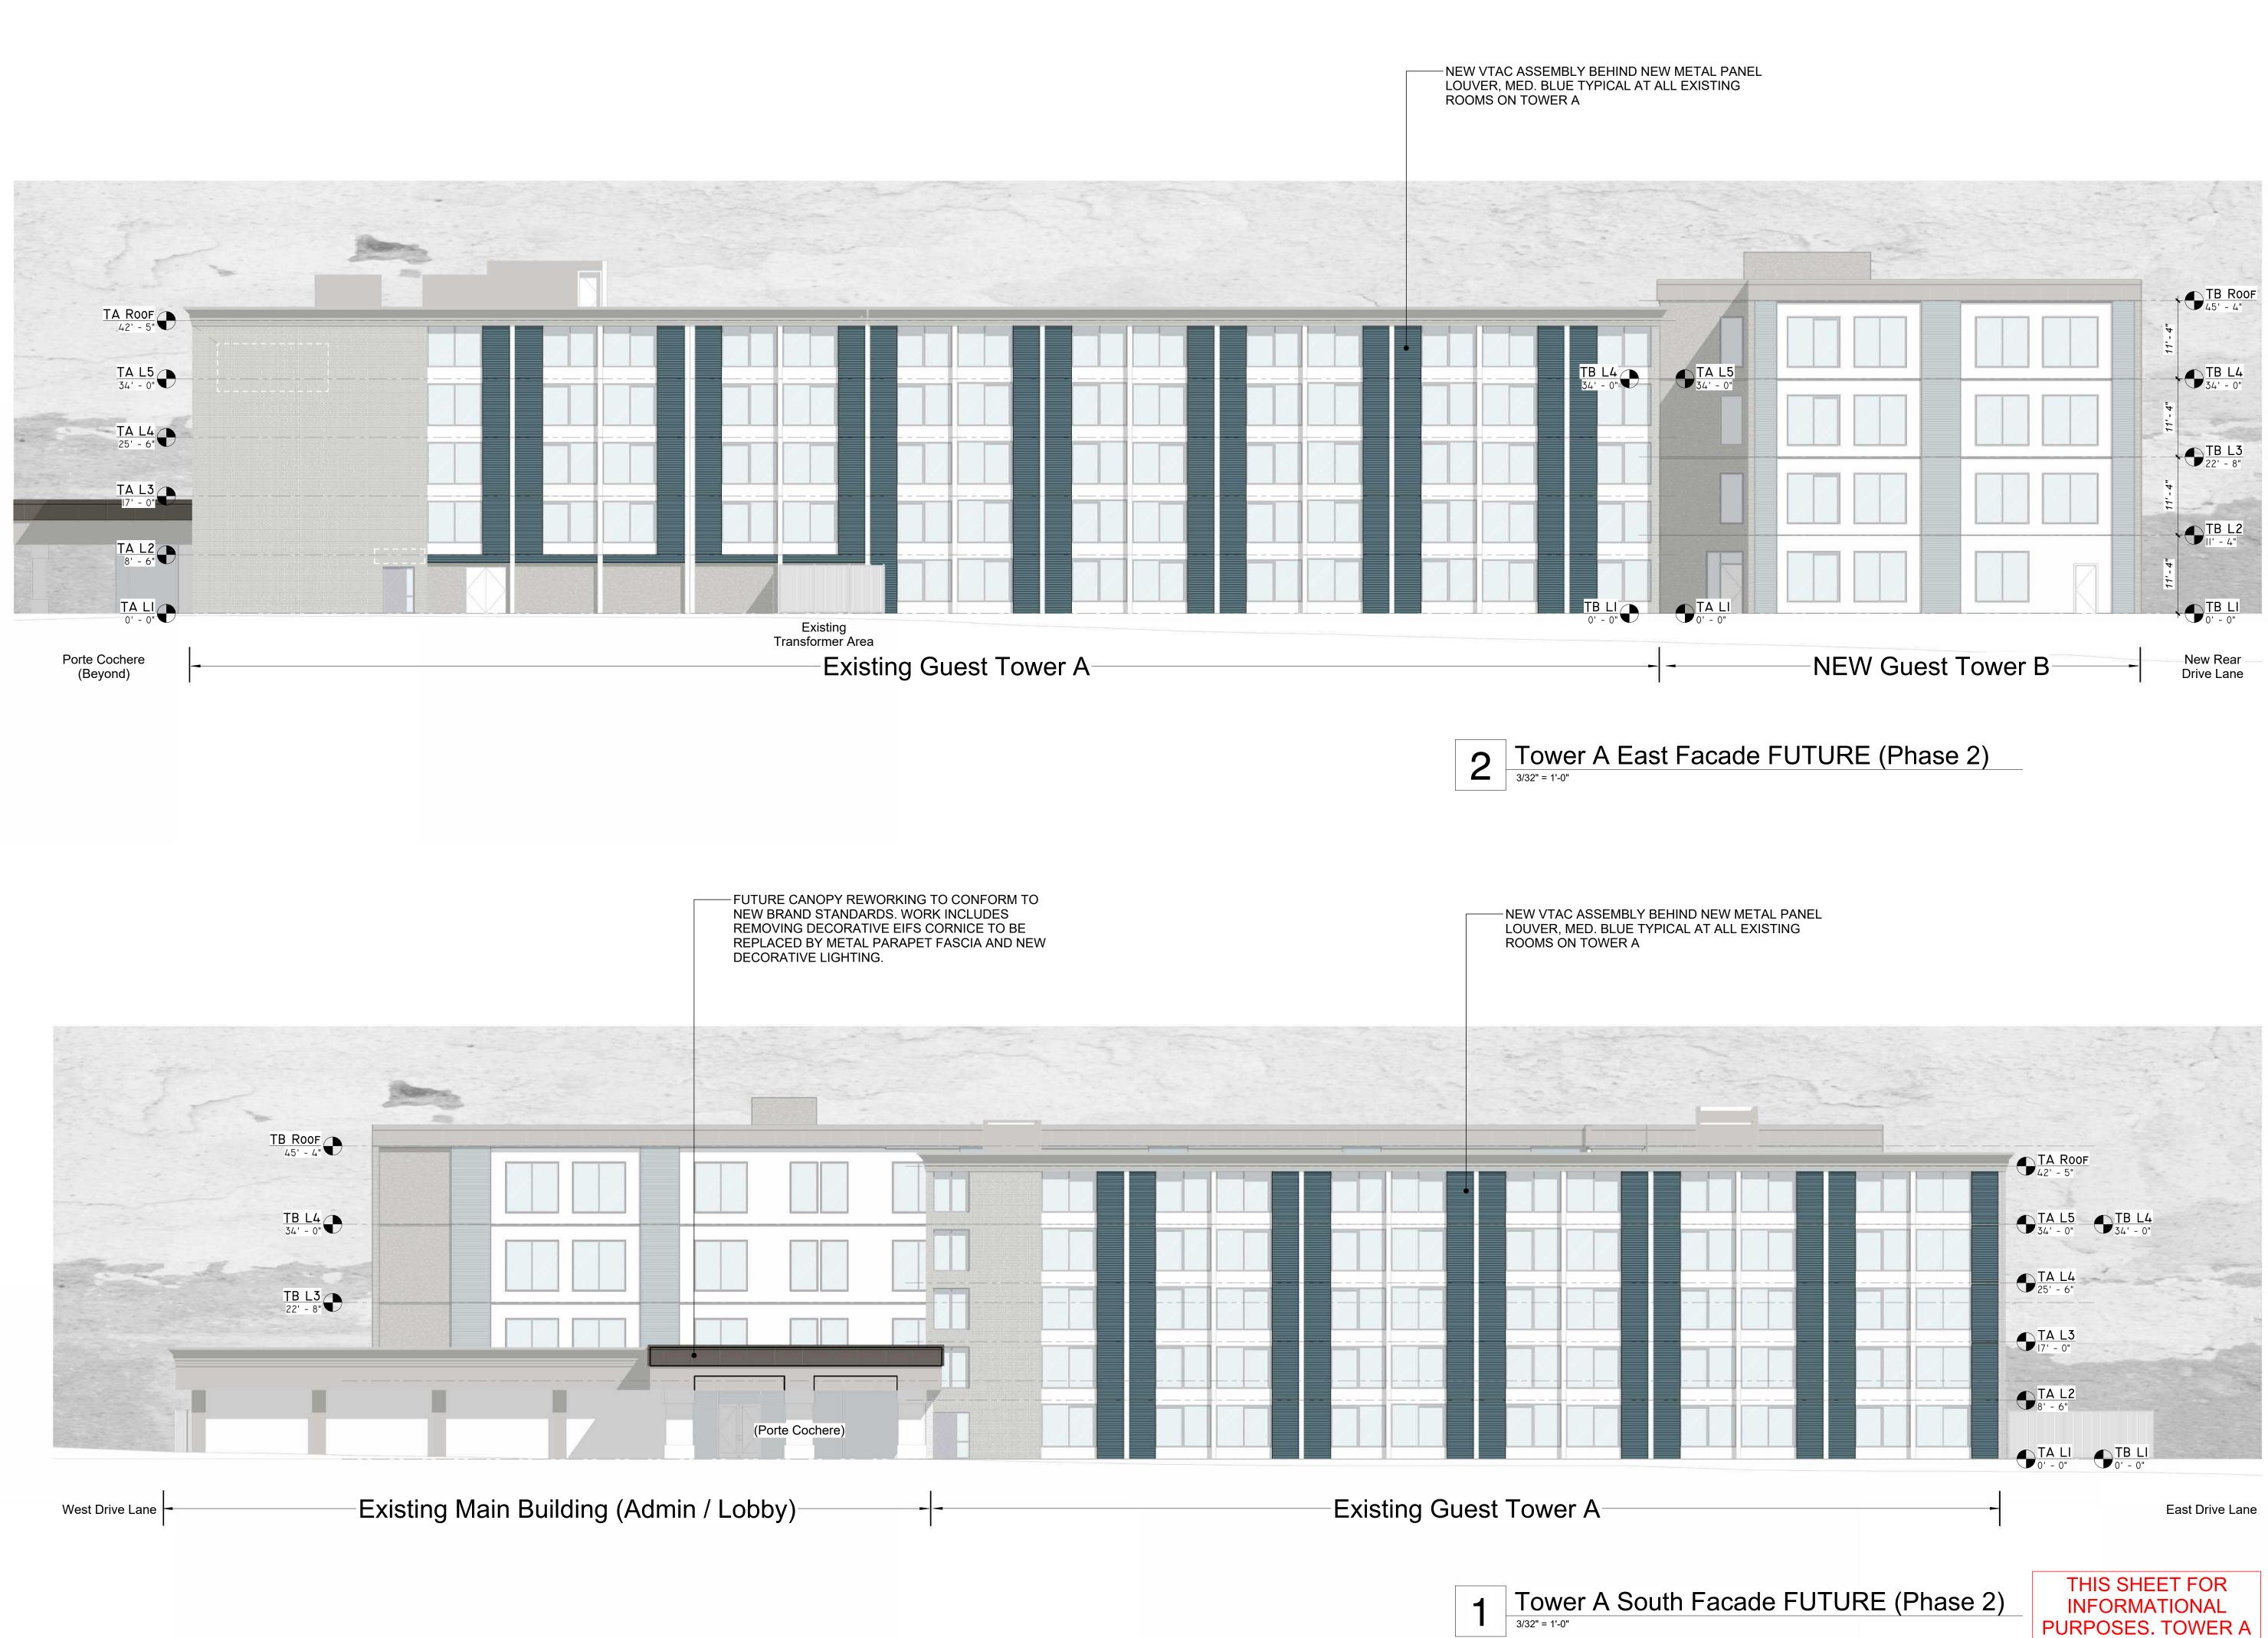

9/13/2023 1:36:24 PM

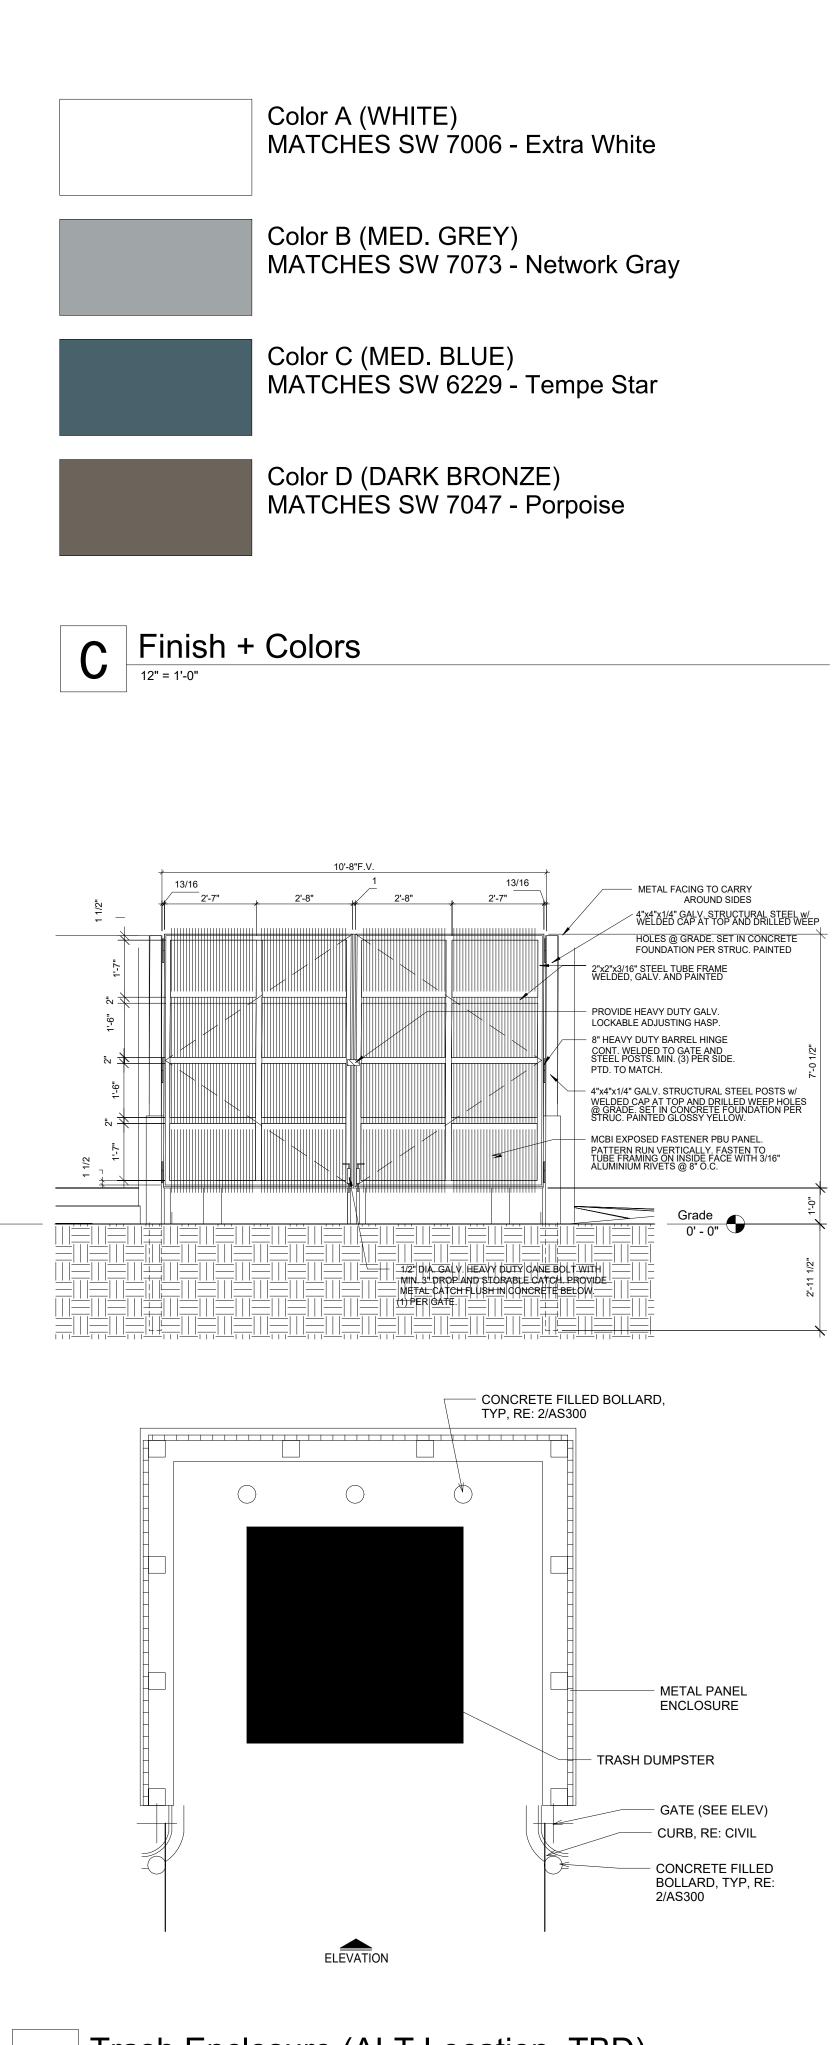

B Trash Enclosure (ALT Location, TBD)



VIEW LOOKING WEST TOWARD PORT COCHERE IN THE DISTANCE AND SOUTH FACADE OF THE EXISTING GUEST TOWER "A"



SCREENING FENCE AROUND TRANSFORMER YARD.



ENCLOSURE (TO BE REMOVED FOR NEW REAR DRIVE LANE) AND EXISTING GREENSPACE WHERE NEW TOWER "B" WILL BE LOCATED.



VIEW FROM NORTHWEST CORNER OF PROPERTY LOOKING EAST TOWARD EXISTING GREENSPACE WHERE NEW TOWER "B" WILL BE LOCATED AND CONNECTING REAR DRIVE.


# A Existing Site Photos



VIEW FROM SOUTHEAST CORNER OF PARKING LOT LOOKING TOWARD EXISTING GUEST TOWER "A" WITH PORT COCHERE IN THE DISTANCE.



VIEW LOOKING EAST TOWARD GUEST TOWER "A" (NORTH END) WITH EXISTING GREENSPACE WHERE NEW TOWER WILL CONNECT.

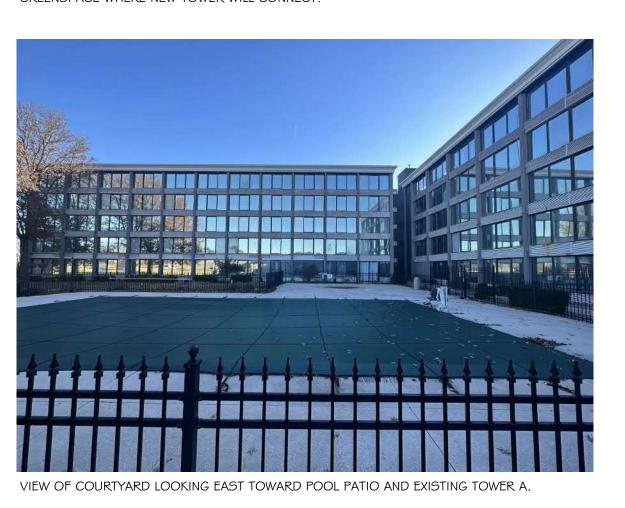




SERVICE AREA LOOKING NORTH WITH EXISTING WORKSHOP (RIGHT) AND ENCLOSING FENCE TO BE REWORK FOR NEW TOWER "B"





9 22

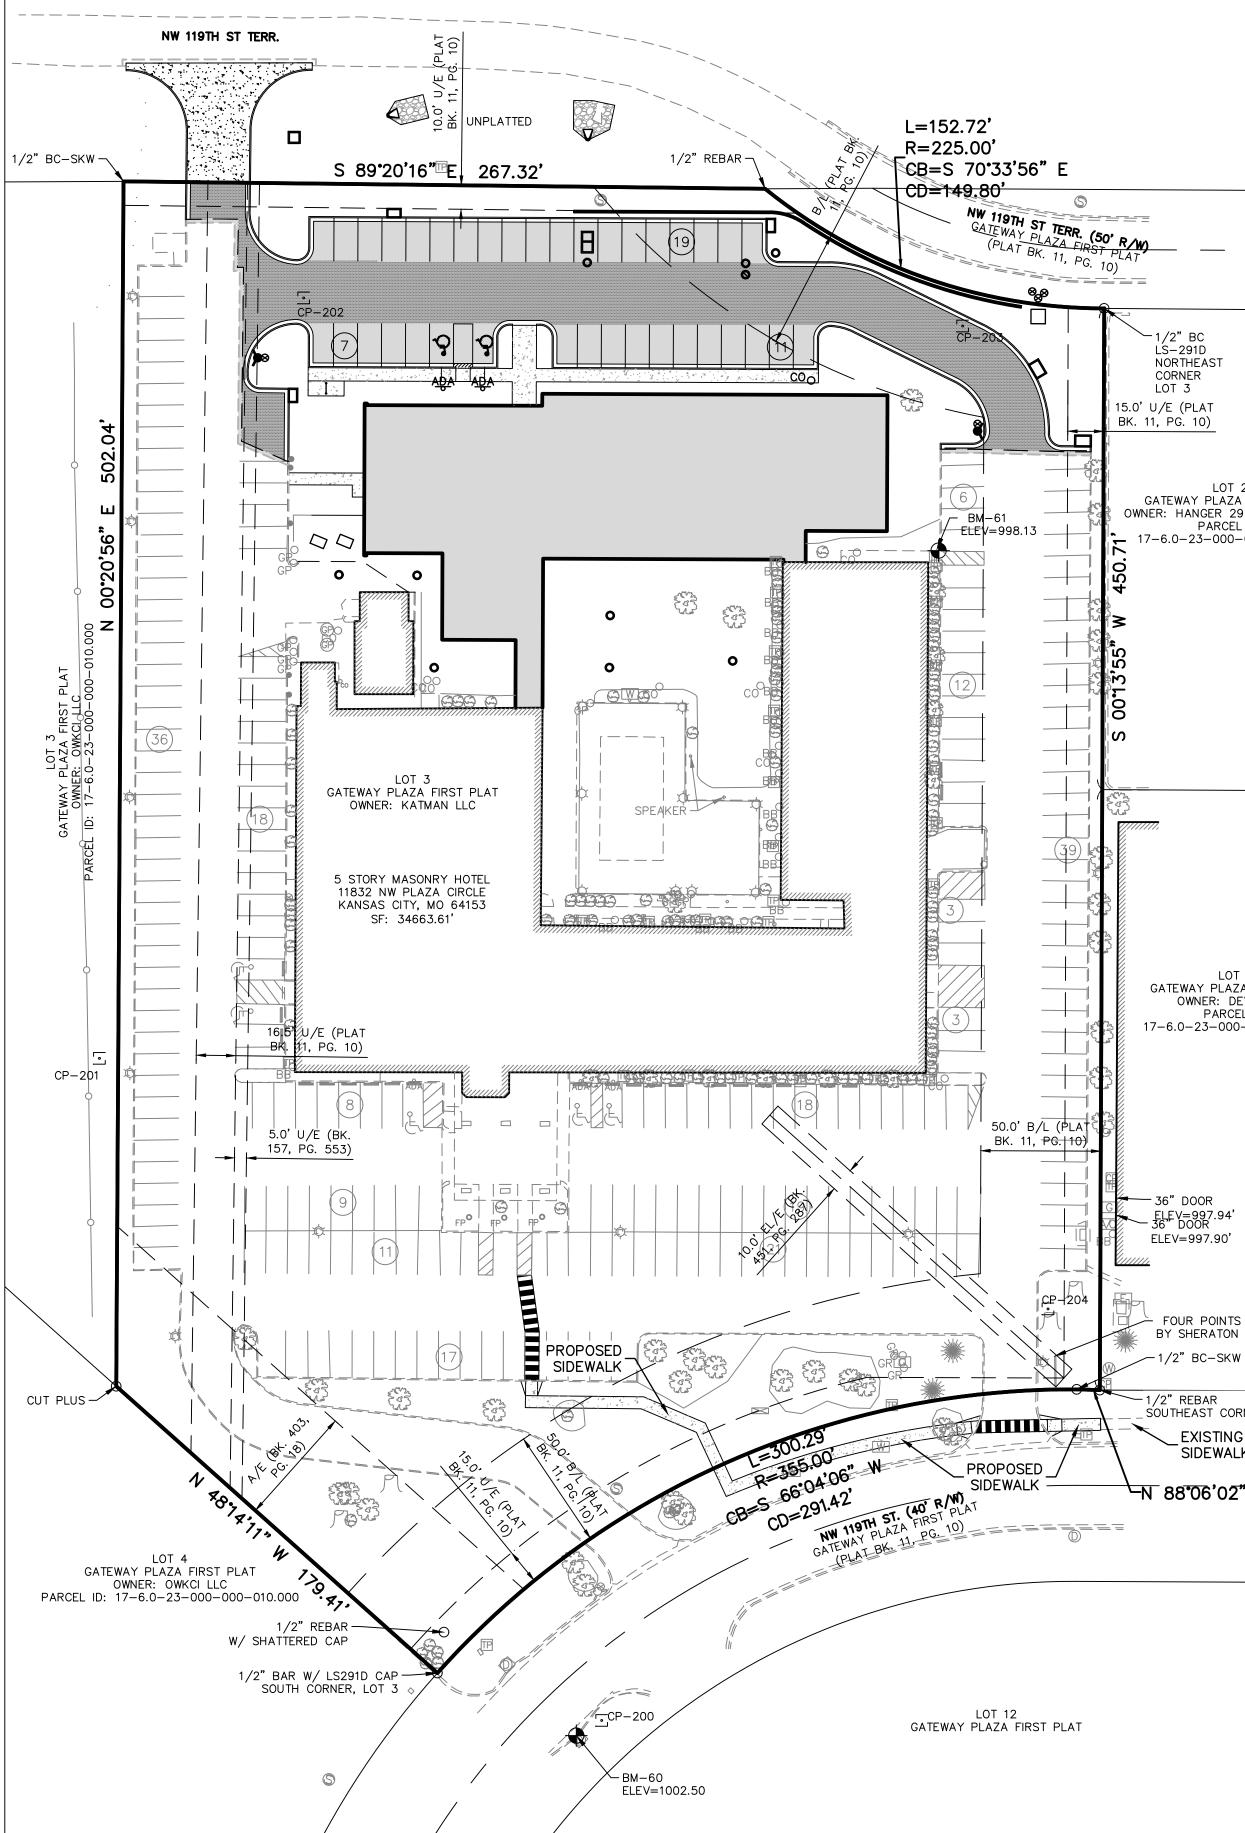

### WARRANTY / DISCLAIMER

THE DESIGNS REPRESENTED IN THESE PLANS ARE IN ACCORDANCE WITH ESTABLISHED PRACTICES OF CIVIL ENGINEERING FOR THE DESIGN FUNCTIONS AND USES INTENDED BY THE OWNER AT THIS TIME. HOWEVER, NEITHER KAW VALLEY ENGINEERING, INC NOR ITS PERSONNEL CAN OR DO WARRANTY THESE DESIGNS OR PLANS AS CONSTRUCTED, EXCEPT IN THE SPECIFIC CASES WHERE KAW VALLEY ENGINEERING PERSONNEL INSPECT AND CONTROL THE PHYSICAL CONSTRUCTION ON A CONTEMPORARY BASIS AT THE SITE.

### CAUTION - NOTICE TO CONTRACTOR

THE CONTRACTOR IS SPECIFICALLY CAUTIONED THAT THE LOCATION AND/OR ELEVATION OF EXISTING UTILITIES AS SHOWN ON THESE PLANS IS BASED ON RECORDS OF THE VARIOUS UTILITY COMPANIES AND, WHERE POSSIBLE, MEASUREMENTS TAKEN IN THE FIELD. THE INFORMATION IS NOT TO BE RELIED ON AS BEING EXACT OR COMPLETE. THE CONTRACTOR MUST CALL THE APPROPRIATE UTILITY COMPANY AT LEAST 72 HOURS BEFORE ANY EXCAVATION TO REQUEST EXACT FIELD LOCATION OF UTILITIES. IT SHALL BE THE RESPONSIBILITY OF THE CONTRACTOR TO RELOCATE ALL EXISTING UTILITIES WHICH CONFLICT WITH PROPOSED IMPROVEMENTS SHOWN ON THE PLANS. THE CONTRACTOR SHALL EXPOSE EXISTING UTILITIES AT LOCATIONS OF POSSIBLE CONFLICTS PRIOR TO ANY CONSTRUCTION.

SAFETY NOTICE TO CONTRACTOR


IN ACCORDANCE WITH GENERALLY ACCEPTED CONSTRUCTION PRACTICES, THE CONTRACTOR WILL BE SOLELY AND COMPLETELY RESPONSIBLE FOR CONDITIONS OF THE JOB SITE, INCLUDING SAFETY OF ALL PERSONS AND PROPERTY DURING PERFORMANCE OF THE WORK. THIS REQUIREMENT WILL APPLY CONTINUOUSLY AND NOT BE LIMITED TO NORMAL WORKING HOURS.


UTILITY STATEMENT:

MISSOURI ONE CALL TICKET #231732017

# KCI NEW TOWER AND HOTEL REFRESH SITE PLAN 11832 NW PLAZA CIR **KANSAS CITY, MISSOURI 64153 PROJECT NUMBER:** FILE NUMBER:

1 OT 2 GATEWAY PLAZA FIRST PLAT OWNER: HANGER 29 VENTURES LLC PARCEL ID: 17-6.0-23-000-000-004.000

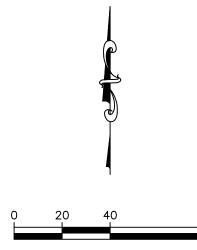

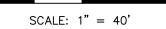

## SITE DATA: 1. SITE DATA:

Site Data	Existing	Proposed	Variance Requested	Approved
Zoning	B3-3	B3-3	No	
Gross Land Area			4	
in square feet	217,796	No Change	No	
in acres	5.0	No Change	No	
Right-of-Way Dedication		•		
in square feet	0	No Change	No	
in acres	0	No Change	No	
Net Land Area				
in square feet	217,796	No Change	No	
in acres	5.0	No Change	No	
Building Area (sq. ft.)			No	
5 Story Hotel	34,664			
Maintenance Building	989			
North Addition		15,872		
Future Additions		No		
Floor Area Ratio (Non Permanent Structures N.I.C.)	16.4%	23.7%	No	

#### LOT 2 GATEWAY PLAZA FIRST PLAT OWNER: DEVIKA INC PARCEL ID: 17-6.0-23-000-000-005.000

SOUTHEAST CORNER, LOT 3

SIDEWALK

<u>-N 88°06'02" W 9.66'</u>

### MINIMUM LOT AREA: NONE

C. LAND USE: HOTEL (PERMITTED)

2. BUILDING DATA TABLE

Building Data	Existing	Proposed	Variance Requested	Approved
Front Setback	50' (Platted)	See Plan	No	
Rear Setback, Northeast Line	50' (Platted)	See Plan	No	
Rear Setback, North Line	N/A (Platted)	N/A	No	
East Side Setback	N/A (Platted)	N/A	No	
West Side Setback	N/A (Platted)	N/A	No	
Height	35'	See Plan	No	

3. LAND COVER EXISTING/PROPOSED RIGHT-OF-WAY: NA EXISTING IMPERVIOUS COVERAGE: 3.06 AC HARDSCAPE PROPOSED IMPERVIOUS COVERAGE: 3.80 AC HARDSCAPE INCREASE: 0.74 AC  $\pm$ 

4. PARKING TABLE

A. VEHICLE PARKING (88–420.06): SEE ARCHITECTURAL PLAN BICYCLE PARKING (88–420.09): SEE ARCHITECTURAL PLAN

OTHER DEVELOPMENT STANDARDS . 88

-425 - Other Development Standards	Method of Compliance
-408 Parkland Dedication	N/A
-415 Stream Buffers	N/A
-430 Outdoor Lighting	See Photometric Plan
-435 Outdoor Display, Storage and Work Areas	N/A
-445 Signs	Existing Monument Sign to Remain. No Additional Signage
-445 519115	Proposed at this time.
-450 Pedestrian Standards	Existing sidewalk in NWPlaza Circle. No existing sidewalk on NW
	119th Terrace. No existing pedestrian access to site.

THE UNDERGROUND UTILITIES SHOWN HEREON ARE FROM FIELD SURVEY INFORMATION OF ONE-CALL LOCATED UTILITIES, FIELD SURVEY INFORMATION OF ABOVE GROUND OBSERVABLE EVIDENCE, AND/OR THE SCALING AND PLOTTING OF EXISTING UTILITY MAPS AND DRAWINGS AVAILABLE TO THE SURVEYOR AT THE TIME OF SURVEY. THE SURVEYOR MAKES NO GUARANTEE THAT THE UNDERGROUND UTILITIES SHOWN COMPRISE ALL SUCH UTILITIES IN THE AREA, EITHER IN SERVICE OR ABANDONED. FURTHERMORE, THE SURVEYOR DOES NOT WARRANT THAT THE UNDERGROUND UTILITIES SHOWN ARE IN THE EXACT LOCATION INDICATED ALTHOUGH HE DOES CERTIFY THAT THEY ARE LOCATED AS ACCURATELY AS POSSIBLE FROM INFORMATION AVAILABLE. THE SURVEYOR HAS NOT PHYSICALLY LOCATED THE UNDERGROUND UTILITIES BY EXCAVATION UNLESS OTHERWISE NOTED ON THIS SURVEY.

E ELECTRIC METER G GAS METER GRO GAS LINE RISER W WATER METER ⊗ WATER LINE GATE VALVE ♥ FIRE HYDRANT SPRINKLER CONTROL BOX WATER SPIGOT CABLE TV PEDESTAL (3) PARKING STALL COUNT 😔 BUSH BOLLARD 了 STUMP TREE LINE ----- WOOD FENCE GPO GATE POST WHEEL STOP B/B BACK TO BACK OF CURB ELECTRIC OUTLET ΕO (D) DEED VALUE (M) MEASURED VALUE (P) PLAT VALUE

LEGEND: MONUMENT FOUND ORIGIN UNKNOWN UNLESS OTHERWISE NOTED BENCHMARK CONTROL POINT UNDERGROUND ELECTRIC

0

CALIGHT POLE NO VISIBLE # UNLESS STATED

BREAKER BOX UNDERGROUND GAS

WATER MANHOLE

-FOC----- UNDERGROUND FIBER OPTIC CABLE 

TELEPHONE PEDESTAL OWNER UNKNOWN UNLESS STATED SANITARY SEWER MANHOLE SANITARY SEWER CLEAN OUT VCP VITRIFIED CLAY PIPE PVC POLYVINYL CHLORIDE PIPE HDPE HIGH DENSITY POLYETHYLENE RCP REINFORCED CONCRETE PIPE

STORM SEWER MANHOLE

ADA HANDICAP SIGN

HANDICAP SYMBOL - STREET/TRAFFIC SIGN

~ \_ 950 - EXISTING GRADE 5' CONTOUR ~ 939 -- EXISTING GRADE 1' CONTOUR を引き DECIDUOUS TREE

CONIFEROUS TREE

AIR CONDITIONER UNIT 


T/E TRASH ENCLOSURE

A/E ACCESS EASEMENT

EL/E ELECTRIC EASEMENT

MEASUREMENT © GREASE PIT MANHOLE

E/E EDGE TO EDGE OF ASPHALT

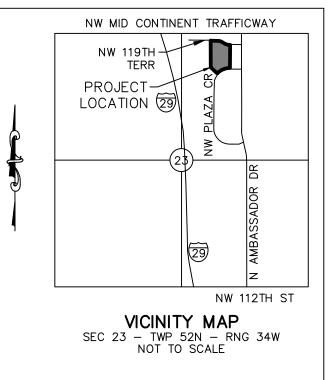

## HORIZONTAL AND VERTICAL DATUM: THE COORDINATES SHOWN HEREON ARE GROUND COORDINATES

BASED ON THE MISSOURI STATE PLANE, WEST ZONE (NAD 1983), (HARN), (NAVD 1988/97) CAF: 0.9999009

1 METER = 3.28083333 U.S. SURVEY FEET GROUND COORDINATES X COMBINED ADJUSTMENT FACTOR (CAF) = GRID COORDINATES SCALED AROUND 0,0

### KC-66 (PID-165301)

NORTHING: 348931.906 (GRID)(METERS) 1144900.875 (GROUND)(U.S. SURVEY FEET) EASTING: 833957.998 (GRID)(METERS) 2736348.341 (GROUND)(U.S. SURVEY FEET) ELEV = 309.4 (METERS) 1015.09 (U.S. SURVEY FEET)

## **PROJECT BENCH MARK:**

BM-60 CHISELED SQUARE ON THE CENTER FRONT FACE OF THE CURB INLET ON THE SOUTHERLY SIDE OF PLAZA CIRCLE AND SOUTHWEST OF THE WEST ENTRY DRIVE TO THE MICROTEL INN. ELEV = 1002.50

CHISELED SQUARE ON THE NORTHEAST CORNER OF THE FIRST STEP UP FROM THE CURB AT THE BUILDING NORTHEAST CORNER. ELEV = 998.13

### PROJECT CONTROL:

CP #200 1/2"x24" REBAR W/ CONTROL POINT CAP BETWEEN WALK AND CURB ON THE SOUTHERLY SIDE OF PLAZA CIRCLE AND SOUTHWEST OF THE MICROTEL INN WEST ENTRY DRIVE. NORTHING: 1144271.966 (GROUND) EASTING: 2737016.275 (GROUND) ELEV = 1002.20

CP #201 1/2"x24" REBAR W/ CONTROL POINT CAP ON THE TOP OF THE SLOPE AT THE SOUTH FACE OF THE BUILDING EXTENDED WEST. NORTHING: 1144547.832 (GROUND) EASTING: 2736806.996 (GROUND) ELEV = 1009.98

 $\frac{\text{CP} \# 202}{1/2" x 24"}$  REBAR W/ CONTROL POINT CAP IN THE GRASS AT THE NORTHEAST CORNER ON THE WEST PARKING AREA NORTHING: 1144864.678 (GROUND) EASTING: 2736892.097 (GROUND)

ELEV = 999.57

<u>CP #203</u> 1/2"x24" REBAR W/ CONTROL POINT CAP ON THE TOP OF THE GRASS DRAINAGE SWALE NORTH OF THE TRASH ENCLOSURE AND THE EAST PARKING AREA. NORTHING: 1144852.954 (GROUND) EASTING: 2737166.669 (GROUND) ELEV = 994.94<u>CP #204</u> 1/2"x24" REBAR W/ CONTROL POINT CAP EAST OF THE SITE EAST


ENTRY DRIVE AND SOUTH OF THE EAST SIDE OF THE EAST PARKING AREA. NORTHING: 1144443.432 (GROUND) EASTING: 2737202.226 (GROUND) ELEV = 998.30



## LIGHT DUTY ASPHALT

- HEAVY DUTY ASPHALT
- L LANDING
- RAMP R TRANSITION
- PROJECT AREA (APPROXIMATE LIMITS OF DISTURBANCE)
- (14)PROPOSED PARKING COUNT
- PARKING LOT/ SITE LIGHTING

SEED/SOD

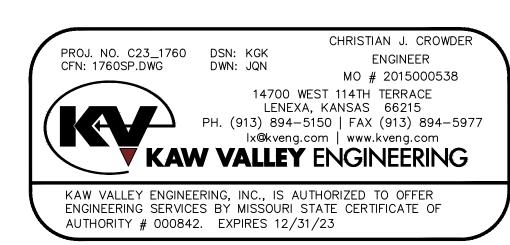

Client: Hulsing ENTERPRISES, LLC

Project Title / Address:

## KCI New Tower and **Hotel Refresh**

## 11832 NW Plaza Cir Kansas City MO 64153




Leawood, KS 66209

www.bellknott.com

Structural Consultant:

MEP Consultant:

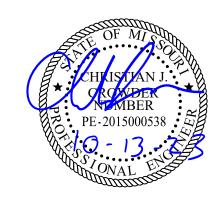

Revisions:

CITY REVIEW RESPONSE 10/13/23 1

09/18/23 Issue Date: **Initial Submittal** Reason for Issue: Project Number 22-056 DD Project Phase:


Sheet Title:

## **OVERALL SITE PLAN**

Pkg: Sheet Number:

C100

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UTILITIES. IT SHALL BE THE RESPONSIBILITY OF THE CONTRACTOR TO RELOCATE ALL EXISTING UTILITIES WHICH CONFLICT WITH PROPOSED IMPROVEMENTS SHOWN ON THE PLANS. THE CONTRACTOR SHALL EXPOSE EXISTING UTILITIES AT LOCATIONS OF POSSIBLE CONFLICTS PRIOR TO ANY CONSTRUCTION.
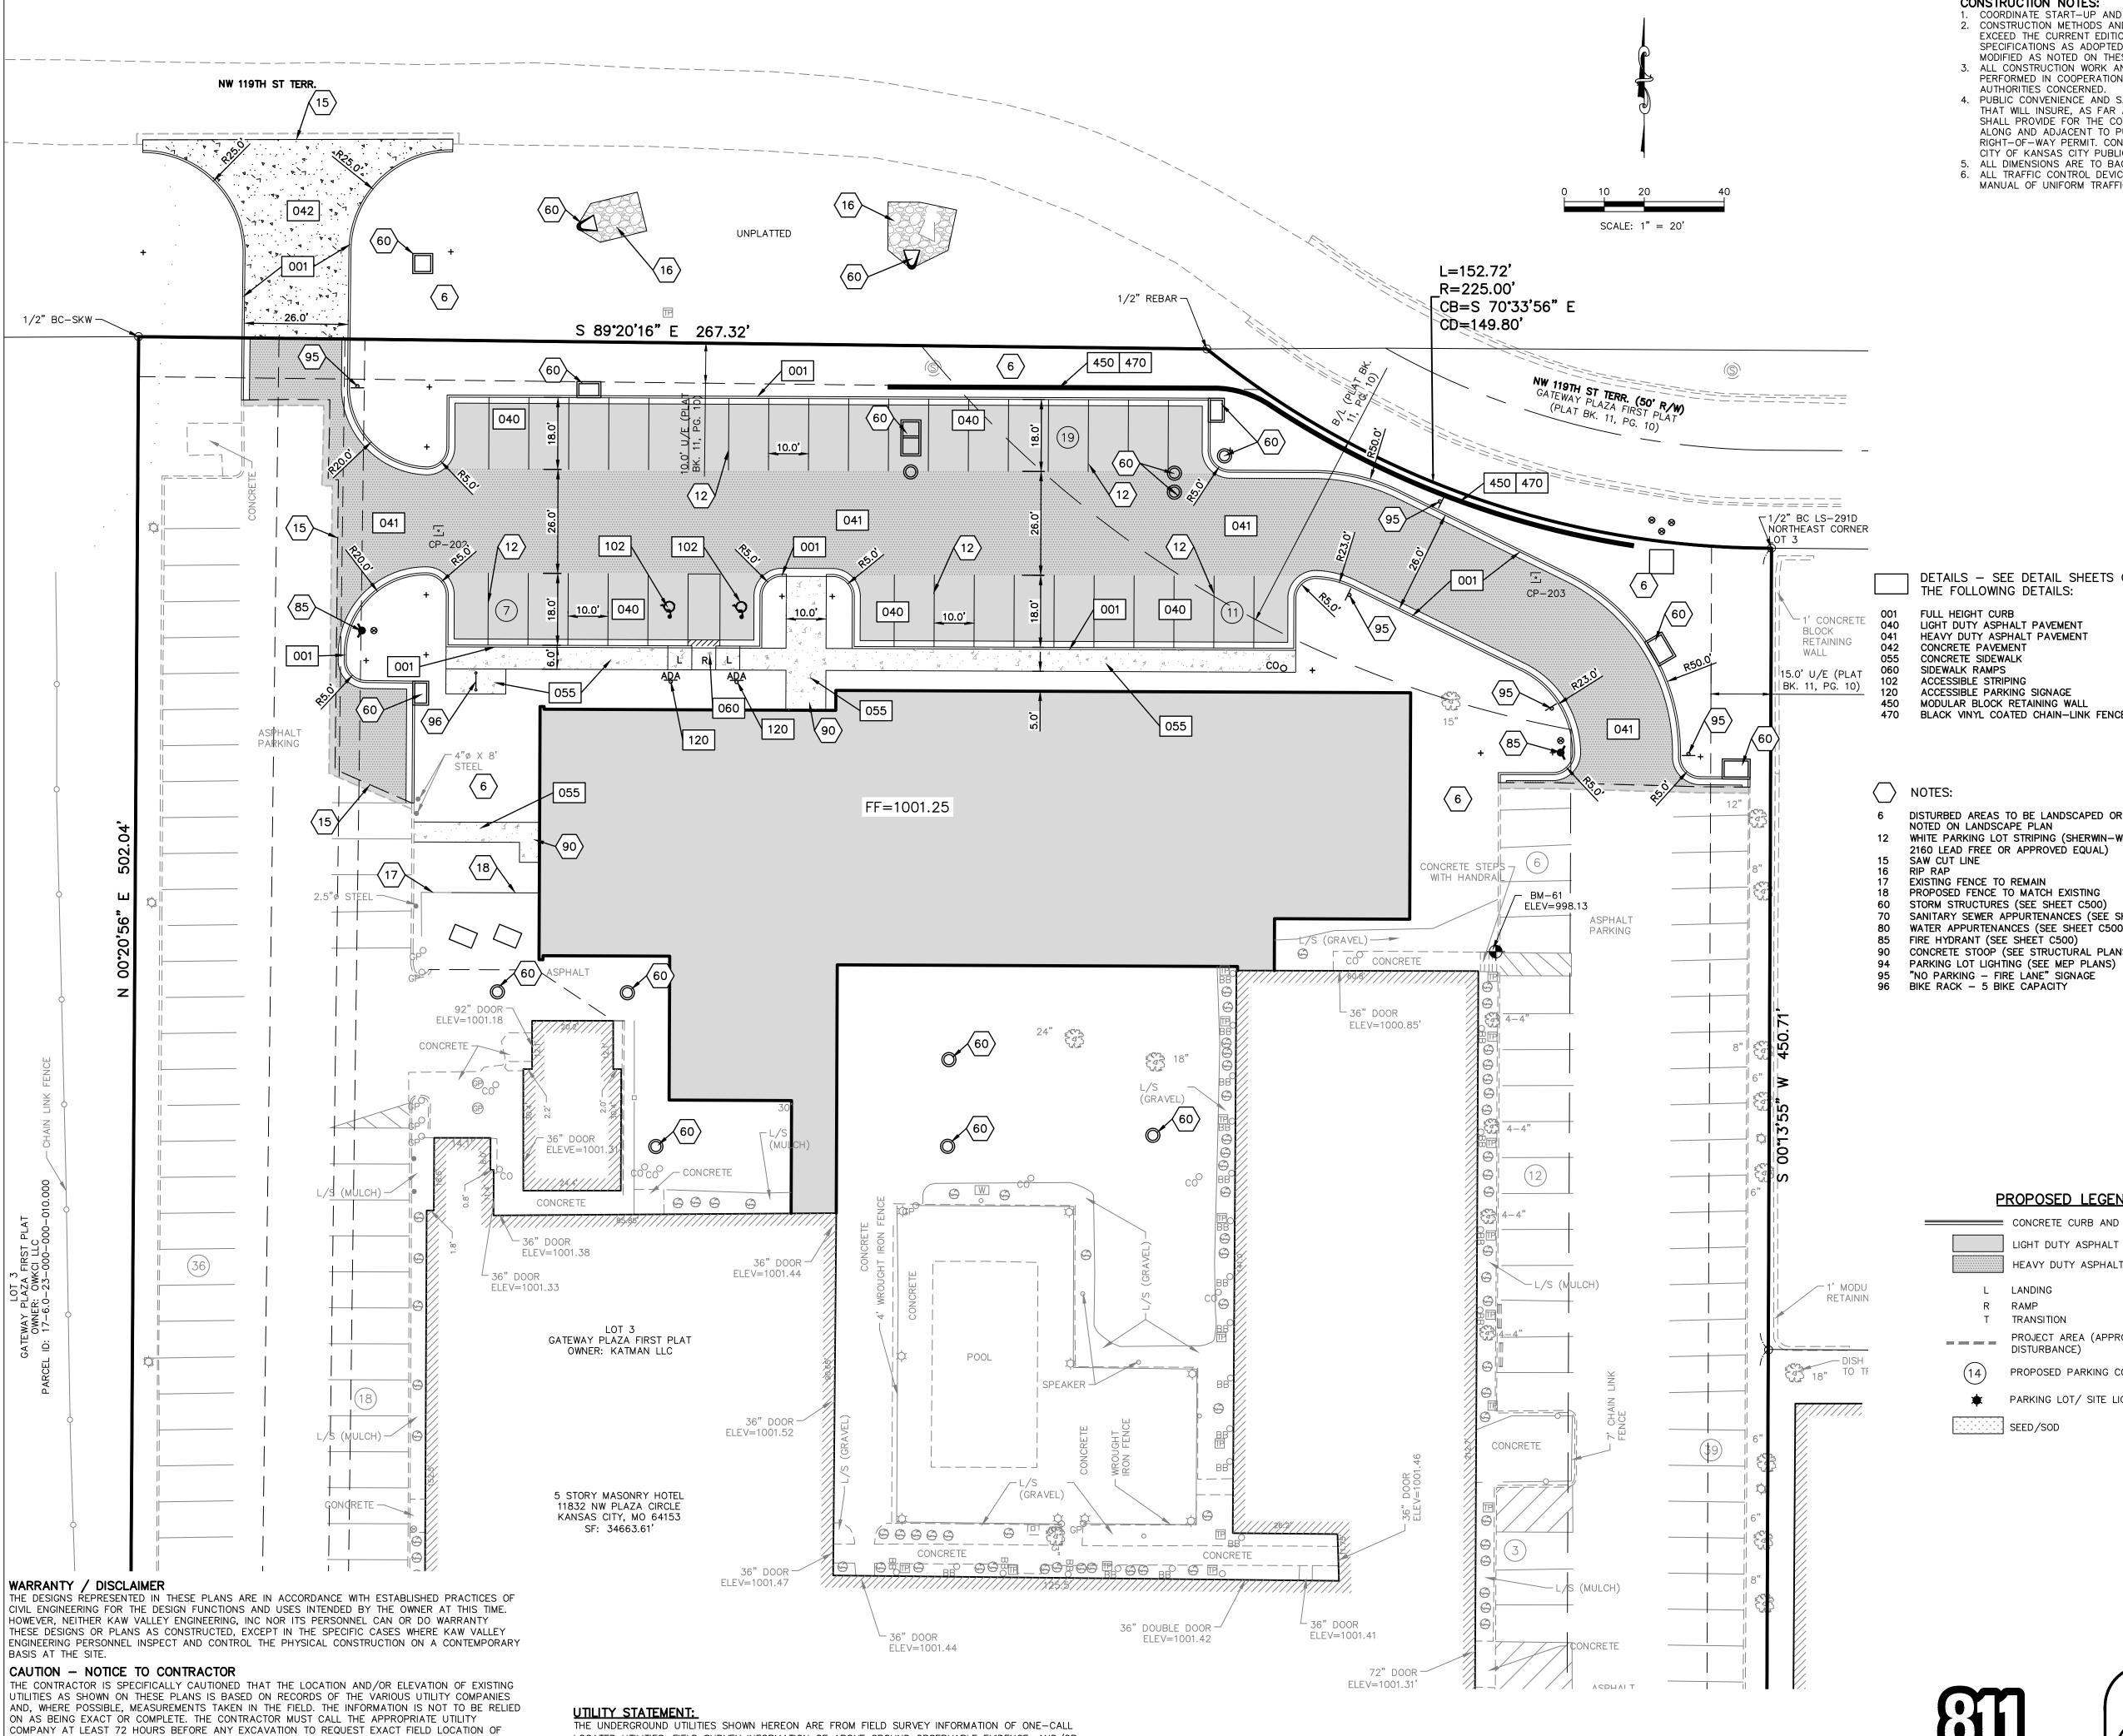
### SAFETY NOTICE TO CONTRACTOR

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LOCATED UTILITIES, FIELD SURVEY INFORMATION OF ABOVE GROUND OBSERVABLE EVIDENCE, AND/OR THE SCALING AND PLOTTING OF EXISTING UTILITY MAPS AND DRAWINGS AVAILABLE TO THE SURVEYOR AT THE TIME OF SURVEY. THE SURVEYOR MAKES NO GUARANTEE THAT THE UNDERGROUND UTILITIES SHOWN COMPRISE ALL SUCH UTILITIES IN THE AREA, EITHER IN SERVICE OR ABANDONED. FURTHERMORE, THE SURVEYOR DOES NOT WARRANT THAT THE UNDERGROUND UTILITIES SHOWN ARE IN THE EXACT LOCATION INDICATED ALTHOUGH HE DOES CERTIFY THAT THEY ARE LOCATED AS ACCURATELY AS POSSIBLE FROM INFORMATION AVAILABLE. THE SURVEYOR HAS NOT PHYSICALLY LOCATED THE UNDERGROUND UTILITIES BY EXCAVATION UNLESS OTHERWISE NOTED ON THIS SURVEY. MISSOURI ONE CALL TICKET #231732017

### CONSTRUCTION NOTES:

MANUAL OF UNIFORM TRAFFIC CONTROL DEVICES.

COORDINATE START-UP AND ALL CONSTRUCTION ACTIVITIES WITH THE OWNER. 2. CONSTRUCTION METHODS AND MATERIALS NOT SPECIFIED IN THESE PLANS ARE TO MEET OR EXCEED THE CURRENT EDITION OF THE KANSAS CITY METROPOLITAN CHAPTER OF APWA SPECIFICATIONS AS ADOPTED AND AMENDED BY THE CITY OF KANSAS CITY, MISSOURI AND MODIFIED AS NOTED ON THESE PLANS. 3. ALL CONSTRUCTION WORK AND UTILITY WORK OUTSIDE OF PROPERTY BOUNDARIES SHALL BE

PERFORMED IN COOPERATION WITH AND IN ACCORDANCE WITH REGULATIONS OF THE

AUTHORITIES CONCERNED. 4. PUBLIC CONVENIENCE AND SAFETY: THE CONTRACTOR SHALL CONDUCT THE WORK IN A MANNER THAT WILL INSURE, AS FAR AS PRACTICABLE, THE LEAST OBSTRUCTION TO TRAFFIC, AND SHALL PROVIDE FOR THE CONVENIENCE AND SAFETY OF THE GENERAL PUBLIC AND RESIDENTS ALONG AND ADJACENT TO PUBLIC ROADWAYS. CONTRACTOR IS RESPONSIBLE TO OBTAIN RIGHT-OF-WAY PERMIT. CONTRACTOR SHALL PROVIDE TRAFFIC CONTROL AS REQUIRED BY THE CITY OF KANSAS CITY PUBLIC WORKS DEPARTMENT. REFERENCE MUTCD STANDARD DRAWINGS. 5. ALL DIMENSIONS ARE TO BACK OF CURB UNLESS OTHERWISE SHOWN 6. ALL TRAFFIC CONTROL DEVICES, INSTALLATION AND OPERATIONS SHALL CONFORM WITH THE

DETAILS - SEE DETAIL SHEETS C190 FOR THE FOLLOWING DETAILS:

Y ASPHALT PAVEMENT PAVEMENT SIDEWALK RAMPS E STRIPING E PARKING SIGNAGE BLOCK RETAINING WALL YL COATED CHAIN—LINK FENCE	
REAS TO BE LANDSCAPED OR SODDED AS NDSCAPE PLAN IG LOT STRIPING (SHERWIN-WILLIAMS TM REE OR APPROVED EQUAL) E	
CE TO REMAIN ENCE TO MATCH EXISTING CTURES (SEE SHEET C500) WER APPURTENANCES (SEE SHEET C500) RTENANCES (SEE SHEET C500) T (SEE SHEET C500) TOOP (SEE STRUCTURAL PLANS) LIGHTING (SEE MEP PLANS)	

P	ROPOSED LEGEND
	CONCRETE CURB AND GUTTER
	LIGHT DUTY ASPHALT
	HEAVY DUTY ASPHALT
L	LANDING
R	RAMP
Т	TRANSITION
	PROJECT AREA (APPROXIMATE LIMITS OF DISTURBANCE)
4	PROPOSED PARKING COUNT
¢	PARKING LOT/ SITE LIGHTING
· · · · · · ·	SEED/SOD

	LEGEND:
0	MONUMENT FOUND ORIGIN UNKNOWN UNLESS OTHERWISE NOTED
<b>•</b>	BENCHMARK
' <u>-</u> ——E——	CONTROL POINT UNDERGROUND ELECTRIC
¢	LIGHT POLE NO VISIBLE # UNLESS STATED
E	ELECTRIC METER
вв <sup>о</sup> —G	BREAKER BOX UNDERGROUND GAS
G	GAS METER
GRO	GAS LINE RISER
	WATER LINE WATER METER
8	WATER LINE GATE VALVE
V	FIRE HYDRANT
×	SPRINKLER CONTROL BOX WATER MANHOLE
ws <sup>O</sup>	WATER SPIGOT
——FOC——	UNDERGROUND FIBER OPTIC CABLE
TV	UNDERGROUND TELEVISION CABLE TV PEDESTAL
Ē	TELEPHONE PEDESTAL OWNER
S	UNKNOWN UNLESS STATED SANITARY SEWER MANHOLE
со <sup>О</sup>	SANITARY SEWER CLEAN OUT
	SANITARY SEWER LINE
VCP PVC	VITRIFIED CLAY PIPE POLYVINYL CHLORIDE PIPE
HDPE	HIGH DENSITY POLYETHYLENE
	REINFORCED CONCRETE PIPE
(3)	STORM SEWER MANHOLE PARKING STALL COUNT
ADA	HANDICAP SIGN
بل	
~~ <u>950</u> —	STREET/TRAFFIC SIGN EXISTING GRADE 5' CONTOUR
	EXISTING GRADE 1' CONTOUR
	DECIDUOUS TREE
1 1 1 1 1	CONIFEROUS TREE BUSH
•	BOLLARD
	STUMP
A/0	TREE LINE AIR CONDITIONER UNIT
o	CHAIN LINK FENCE
	WOOD FENCE
GF	GATE POST WHEEL STOP
•	TRASH ENCLOSURE
	ACCESS EASEMENT ELECTRIC EASEMENT
B/B	BACK TO BACK OF CURB
GP	MEASUREMENT GREASE PIT MANHOLE
E/E	EDGE TO EDGE OF ASPHALT
	ELECTRIC OUTLET DEED VALUE
	MEASURED VALUE
(P)	PLAT VALUE



PROJ. NO. C23_1760 CFN: 1760SP.DWG	LENE> PH. (913) 894- Ix@kveng	CHRISTIAN J. CROWDER ENGINEER MO # 2015000538 WEST 114TH TERRACE (A, KANSAS 66215 -5150   FAX (913) 894–5977 g.com   www.kveng.com ENGINEERING
	ES BY MISSOURI	UTHORIZED TO OFFER STATE CERTIFICATE OF 31/23

Client: Hulsing ENTERPRISES, LLC

Project Title / Address:

### **KCI New Tower and Hotel Refresh**


## 11832 NW Plaza Cir Kansas City MO 64153



Structural Consultant:

MEP Consultant:

Seal:

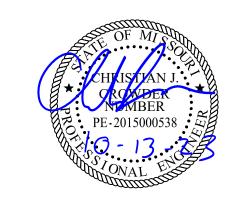

Revisions:

CITY REVIEW RESPONSE 10/13/23 1


09/18/23 Issue Date: Reason for Issue: Initial Submittal 22-056 Project Number: DD Project Phase:

Sheet Title:

## SITE PLAN

Sheet Number: Pkg:

C110

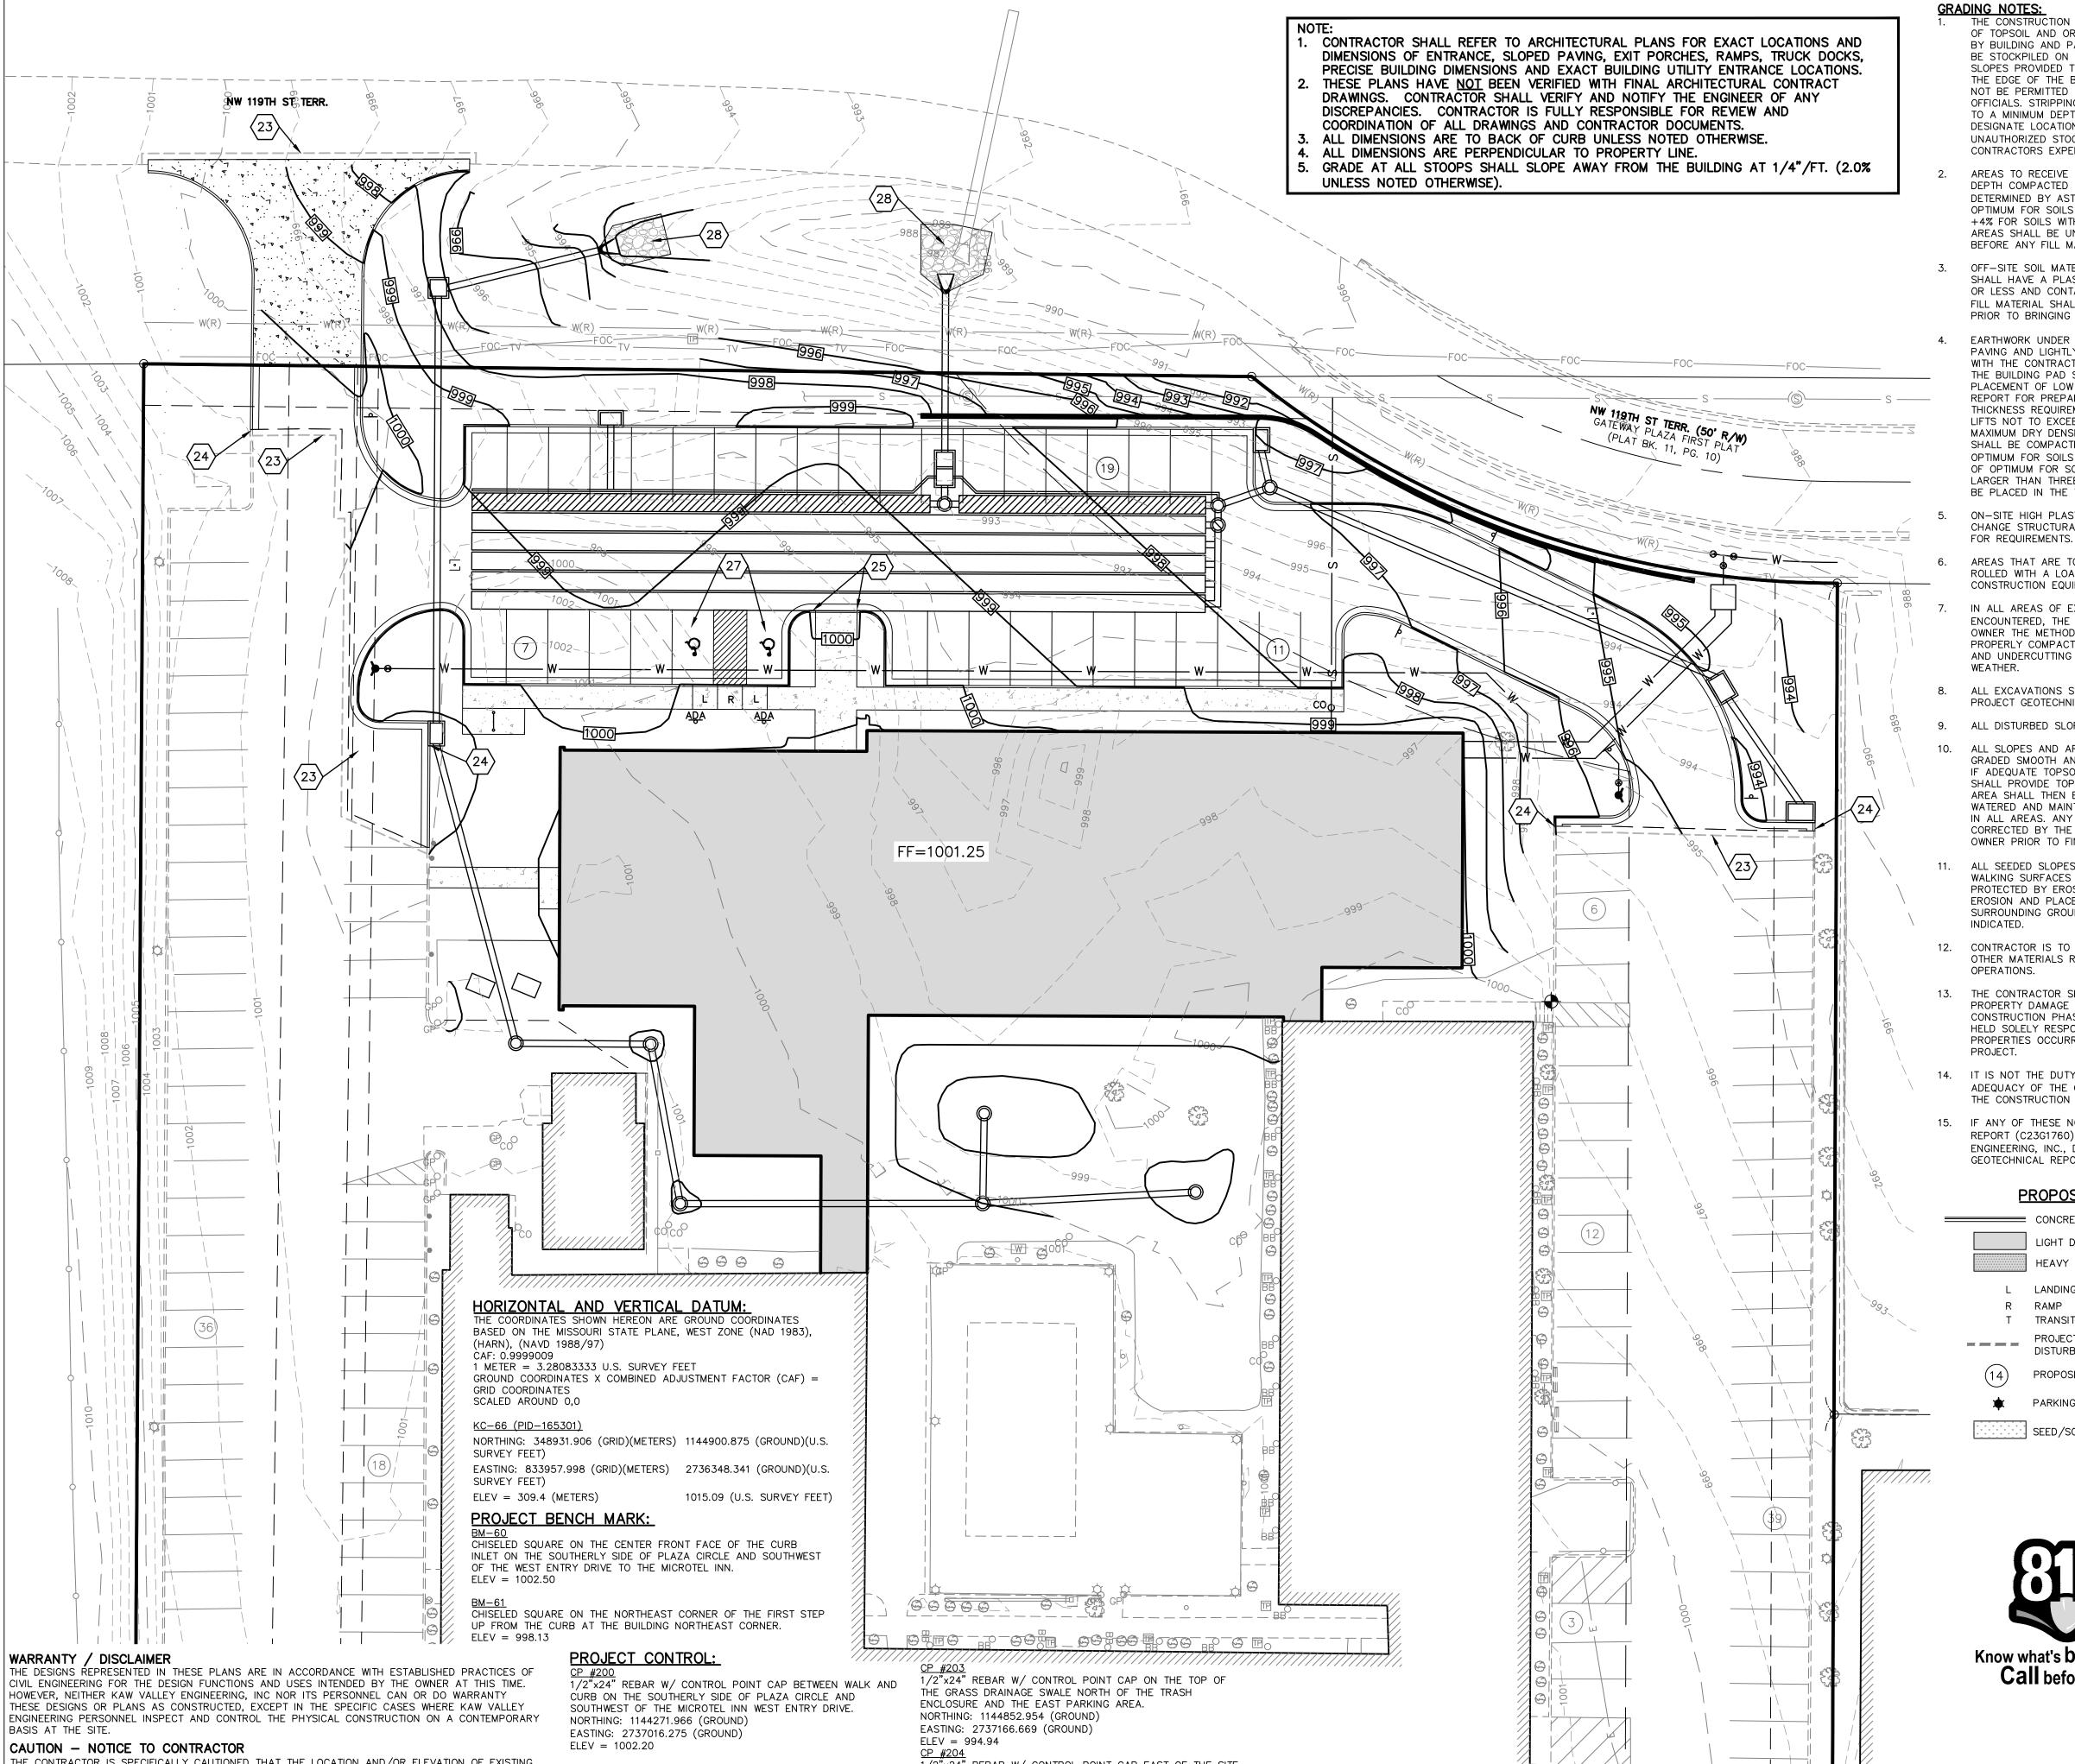

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1/2"x24" REBAR W/ CONTROL POINT CAP ON THE TOP OF THE SLOPE AT THE SOUTH FACE OF THE BUILDING EXTENDED WEST.

NORTHING: 1144547.832 (GROUND) EASTING: 2736806.996 (GROUND) ELEV = 1009.98

1/2"x24" REBAR W/ CONTROL POINT CAP IN THE GRASS AT THE NORTHEAST CORNER ON THE WEST PARKING AREA NORTHING: 1144864.678 (GROUND) EASTING: 2736892.097 (GROUND) ELEV = 999.57

1/2"x24" REBAR W/ CONTROL POINT CAP EAST OF THE SITE EAST ENTRY DRIVE AND SOUTH OF THE EAST SIDE OF THE EAST PARKING AREA.

NORTHING: 1144443.432 (GROUND)

EASTING: 2737202.226 (GROUND)

ELEV = 998.30

UTILITY STATEMENT: THE UNDERGROUND UTILITIES SHOWN HEREON ARE FROM FIELD SURVEY INFORMATION OF ONE-CALL LOCATED UTILITIES, FIELD SURVEY INFORMATION OF ABOVE GROUND OBSERVABLE EVIDENCE, AND/OR THE SCALING AND PLOTTING OF EXISTING UTILITY MAPS AND DRAWINGS AVAILABLE TO THE SURVEYOR AT THE TIME OF SURVEY. THE SURVEYOR MAKES NO GUARANTEE THAT THE UNDERGROUND UTILITIES SHOWN COMPRISE ALL SUCH UTILITIES IN THE AREA, EITHER IN SERVICE OR ABANDONED. FURTHERMORE, THE SURVEYOR DOES NOT WARRANT THAT THE UNDERGROUND UTILITIES SHOWN ARE IN THE EXACT LOCATION INDICATED ALTHOUGH HE DOES CERTIFY THAT THEY ARE LOCATED AS ACCURATELY AS POSSIBLE FROM INFORMATION AVAILABLE. THE SURVEYOR HAS NOT PHYSICALLY LOCATED THE UNDERGROUND UTILITIES BY EXCAVATION UNLESS OTHERWISE NOTED ON THIS SURVEY. MISSOURI ONE CALL TICKET #231732017

ADA SLOPE REQUIREMENTS FOR AREAS OVERLAID OR REPLACED: . STALLS SHALL NOT EXCEED 1:50 (2%) IN ALL DIRECTIONS

- 2. ACCESSIBLE PATH SHALL NOT EXCEED 1:20 (5%) NOR HAVE A CROSS SLOPE IN EXCESS OF 2%.
- CONTRACTOR IS SOLELY RESPONSIBLE TO ADEQUATELY SURVEY THOSE AREAS DURING CONSTRUCTION TO ENSURE COMPLIANCE.

THE CONSTRUCTION AREA SHALL BE CLEARED, GRUBBED, AND STRIPPED OF TOPSOIL AND ORGANIC MATTER FROM ALL AREAS TO BE OCCUPIED BY BUILDING AND PAVING. TOPSOIL FOR REPLACEMENT ON SLOPES MAY BE STOCKPILED ON SITE. EXCESS TOPSOIL MAY BE WASTED IN FILL SLOPES PROVIDED THAT NO TOPSOIL WILL BE WASTED WITHIN 10 FEET OF THE EDGE OF THE BUILDING OR PARKING AREA. BURNING OF TIMBER WILL NOT BE PERMITTED UNLESS APPROVAL IS OBTAINED FROM GOVERNING OFFICIALS. STRIPPING EXISTING TOPSOIL AND ORGANIC MATTER S TO A MINIMUM DEPTH OF 6 INCHES. CONSTRUCTION MANAGER S DESIGNATE LOCATION OF STOCKPILE AREAS DURING CONSTRUCTION UNAUTHORIZED STOCKPILE SHALL BE REMOVE/RELOACTED AT TH CONTRACTORS EXPENSE.

AREAS TO RECEIVE FILL SHALL BE SCARIFIED AND THE TOP 12-DEPTH COMPACTED TO 95% OF THE MAXIMUM DRY DENSITY AS DETERMINED BY ASTM D 698 WITH A MOISTURE CONTENT OF +, OPTIMUM FOR SOILS WITH A LIQUID LIMIT OF LESS THAN 40 AN +4% FOR SOILS WITH A LIQUID LIMIT GREATER THAN 40. ANY UN AREAS SHALL BE UNDERCUT AND REPLACED WITH SUITABLE MAT BEFORE ANY FILL MATERIAL CAN BE APPLIED.

OFF-SITE SOIL MATERIAL FOR USE UNDER BUILDING AND PAVED SHALL HAVE A PLASTICITY INDEX OF 25 OR LESS. A LIQUID LIMI OR LESS AND CONTAIN NO ROCK LARGER THAN THREE INCHES. FILL MATERIAL SHALL BE APPROVED BY THE OWNER'S TESTING PRIOR TO BRINGING ON SITE.

EARTHWORK UNDER AND 10' LATERALLY FROM THE BUILDING ANI PAVING AND LIGHTLY LOADED STRUCTURAL FEATURES SHALL CO WITH THE CONTRACT DOCUMENTS AND PROJECT GEOTECHNICAL THE BUILDING PAD SHALL BE EXCAVATED AS REQUIRED TO ALLO PLACEMENT OF LOW VOLUME CHANGE MATERIAL. REFER TO GEOT REPORT FOR PREPARING BUILDING PAD AND LOW VOLUME CHAN( THICKNESS REQUIREMENTS. OTHER FILL MATERIAL SHALL BE MAD LIFTS NOT TO EXCEED EIGHT INCHES DEPTH COMPACTED TO 95% MAXIMUM DRY DENSITY AS DETERMINED BY ASTM D 698. LVC SHALL BE COMPACTED AT A MOISTURE CONTENT OF 0 TO +4% OPTIMUM FOR SOILS WITH A LIQUID LIMIT GREATER THAN 40 AND OF OPTIMUM FOR SOILS WITH A LIQUID LIMIT LESS THAN 40. NO LARGER THAN THREE INCHES IN ANY DIMENSION NOR ANY SHALL BE PLACED IN THE TOP 24 INCHES OF EMBANKMENT.

ON-SITE HIGH PLASTICITY CLAYS MAY BE USED FOR LOW VOLUM CHANGE STRUCTURAL FILL. REFER TO PROJECT GEOTECHNICAL R

AREAS THAT ARE TO BE CUT TO SUBGRADE LEVELS SHALL BE ROLLED WITH A LOADED DUMP TRUCK OR SIMILAR APPROVED CONSTRUCTION EQUIPMENT TO DETECT UNSUITABLE SOIL CONDITI

IN ALL AREAS OF EXCAVATION, IF UNSUITABLE SOIL CONDITIONS ENCOUNTERED. THE OWNER'S ENGINEER SHALL RECOMMEND TO OWNER THE METHODS OF UNDERCUTTING AND REPLACEMENT OF PROPERLY COMPACTED, APPROVED FILL MATERIAL. ALL PROOFRO AND UNDERCUTTING SHOULD BE PERFORMED DURING A PERIOD

8. ALL EXCAVATIONS SHALL BE CONSIDERED AS UNCLASSIFIED. REF PROJECT GEOTECHNICAL REPORT.

ALL DISTURBED SLOPES ARE TO BE 3:1 OR FLATTER.

ALL SLOPES AND AREAS DISTURBED BY CONSTRUCTION SHALL B GRADED SMOOTH AND A MINIMUM OF FOUR INCHES OF TOPSOIL IF ADEQUATE TOPSOIL IS NOT AVAILABLE ON-SITE, THE CONTRA SHALL PROVIDE TOPSOIL, APPROVED BY THE OWNER, AS NEEDED AREA SHALL THEN BE SODDED OR SEEDED, FERTILIZED, MULCHEI WATERED AND MAINTAINED UNTIL HARDY GRASS GROWTH IS EST, IN ALL AREAS. ANY AREAS DISTURBED FOR ANY REASON SHALL CORRECTED BY THE CONTRACTOR AT NO ADDITIONAL COST TO OWNER PRIOR TO FINAL ACCEPTANCE OF THE PROJECT.

ALL SEEDED SLOPES 4:1 AND STEEPER. AREAS WITHIN 10' OF P. WALKING SURFACES AND OTHER AREAS NOTED ON PLANS SHALL PROTECTED BY EROSION CONTROL BLANKETS THAT WILL PREVEN EROSION AND PLACED SUCH THAT THE SURFACE IS FLUSH WITH SURROUNDING GROUND AND SHAPED TO CHANNEL WATER IN DIR

CONTRACTOR IS TO REMOVE AND DISPOSE OF ALL DEBRIS, RUBE OTHER MATERIALS RESULTING FROM PREVIOUS AND CURRENT DE

13. THE CONTRACTOR SHALL TAKE ALL PRECAUTIONS NECESSARY T PROPERTY DAMAGE TO ADJACENT PROPERTIES DURING THE CONSTRUCTION PHASES OF THIS PROJECT. THE CONTRACTOR WI HELD SOLELY RESPONSIBLE FOR ANY DAMAGES TO THE ADJACEN PROPERTIES OCCURRING DURING THE CONSTRUCTION PHASES OF

14. IT IS NOT THE DUTY OF THE ENGINEER OR THE OWNER TO REVIE ADEQUACY OF THE CONTRACTOR'S SAFETY MEASURES. IN. ON OF THE CONSTRUCTION SITE AT ANY TIME DURING CONSTRUCTION.

15. IF ANY OF THESE NOTES CONFLICT WITH THE PROJECT GEOTECHI REPORT (C23G1760) AND ALL ADDENDUMS PREPARED BY KAW ENGINEERING, INC., DATED 8/30/2023 RECOMMENDATIONS IN GEOTECHNICAL REPORT SHALL GOVERN.

RE REPORT SHALL GOVERN.	$\langle \rangle$	NOTES:
ROPOSED LEGEND	22 23	MATCH EXISTING SIDEWALK ELEVATION.
CONCRETE CURB AND GUTTER	23 24	MATCH EXISTING PAVEMENT ELEVATION. MATCH EXISTING CURB ELEVATION.
LIGHT DUTY ASPHALT	25	
HEAVY DUTY ASPHALT	27	2% MAX SLOPE
LANDING	28	RIP RAP
RAMP		

TRANSITION PROJECT AREA (APPROXIMATE LIMITS OF DISTURBANCE) PROPOSED PARKING COUNT

PARKING LOT/ SITE LIGHTING 96 SEED/SOD



PR

Call before you dig.

SHALL BE	——Е——	UNDERGROUND ELECTRIC
SHALL ION. ANY	¢	LIGHT POLE NO VISIBLE
HE		# UNLESS STATED
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ND 0 TO	G	
NSUITABLE TERIAL	GR <sup>O</sup>	GAS LINE RISER
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AREAS	₩ ⊗	WATER METER WATER LINE GATE VALVE
IT OF 45	v	FIRE HYDRANT
OFF-SITE AGENCY		SPRINKLER CONTROL BOX
	<b>1</b>	WATER MANHOLE
ID UNDER	ws <sup>o</sup>	WATER SPIGOT
MPLY		UNDERGROUND FIBER OPTIC CABLE
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D + / -2%	s	SANITARY SEWER LINE
IO ROCK _E SHALL	VCP	VITRIFIED CLAY PIPE
	PVC	POLYVINYL CHLORIDE PIPE
ME	HDPE	HIGH DENSITY POLYETHYLENE
REPORT	RCP	REINFORCED CONCRETE PIPE
		STORM SEWER MANHOLE
PROOF	(3) A <u>D</u> A	PARKING STALL COUNT HANDICAP SIGN
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ARE	<u>م</u>	STREET/TRAFFIC SIGN
THE		EXISTING GRADE 5' CONTOUR
OLLING		EXISTING GRADE 1' CONTOUR
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LEGEND:

OTHERWISE NOTED

ORIGIN UNKNOWN UNLESS

MONUMENT FOUND

BENCHMARK

CONTROL POINT

0

SCALE: 1'' = 20'

CHRISTIAN J. CROWDER DSN: KGK ENGINEER DWN: JQN MO # 2015000538 14700 WEST 114TH TERRACE LENEXA, KANSAS 66215 PH. (913) 894-5150 | FAX (913) 894-5977

lx@kveng.com | www.kveng.com **KAW VALLEY** ENGINEERING

KAW VALLEY ENGINEERING, INC., IS AUTHORIZED TO OFFER ENGINEERING SERVICES BY MISSOURI STATE CERTIFICATE OF AUTHORITY # 000842. EXPIRES 12/31/23

PROJ. NO. C23\_1760

CFN: 1760GP.DWG



Project Title / Address:


### **KCI New Tower and Hotel Refresh**

### 11832 NW Plaza Cir Kansas City MO 64153



Structural Consultant:

MEP Consultant:

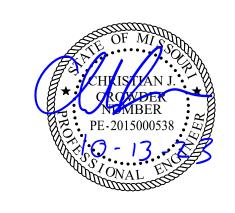

Revisions


CITY REVIEW RESPONSE 10/13/23 1

09/18/23 Issue Date: **Initial Submittal** Reason for Issue: Project Number 22-056 DD Project Phase:

Sheet Title:

## **GRADING PLAN**

Sheet Number: Pkg:

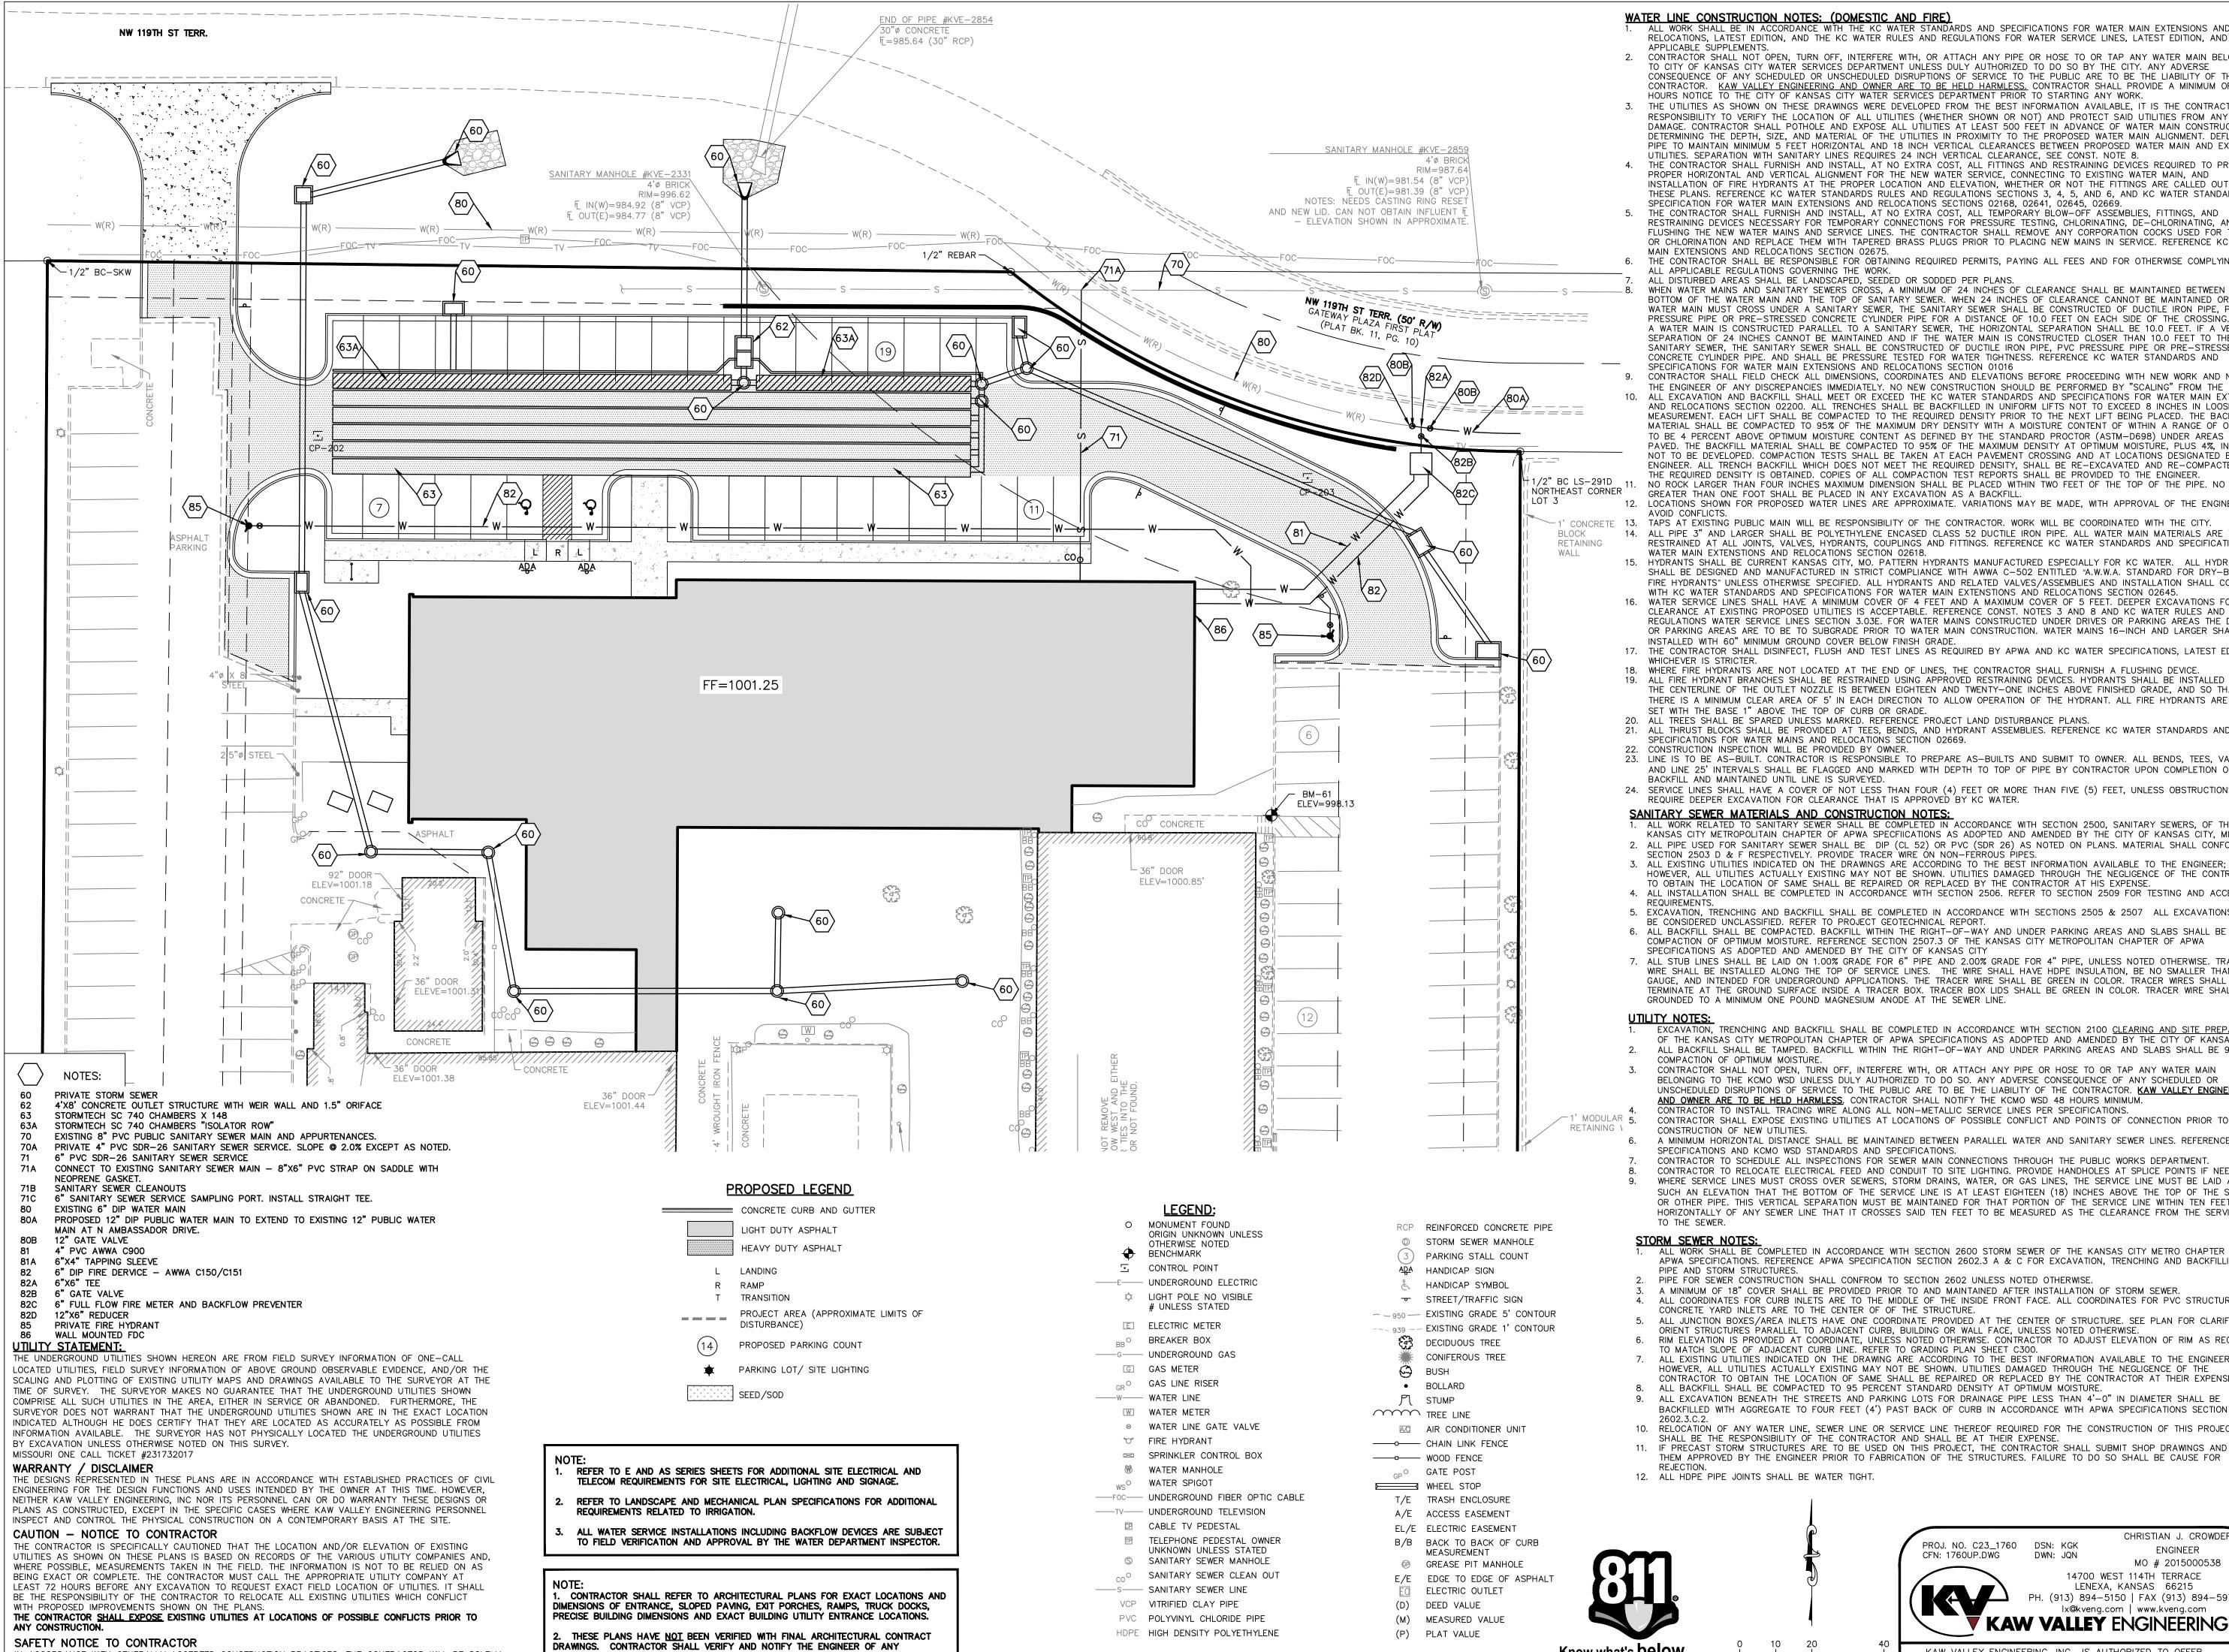

IN ACCORDANCE WITH GENERALLY ACCEPTED CONSTRUCTION PRACTICES, THE CONTRACTOR WILL BE SOLELY AND COMPLETELY RESPONSIBLE FOR CONDITIONS OF THE JOB SITE, INCLUDING SAFETY OF ALL PERSONS AND PROPERTY DURING PERFORMANCE OF THE WORK. THIS REQUIREMENT WILL APPLY CONTINUOUSLY AND NOT BE LIMITED TO NORMAL WORKING HOURS.

DISCREPANCIES. CONTRACTOR IS FULLY RESPONSIBLE FOR REVIEW AND COORDINATION OF ALL DRAWINGS AND CONTRACTOR DOCUMENTS.

Know what's **below**. Call before you dig.

### WATER LINE CONSTRUCTION NOTES: (DOMESTIC AND FIRE)

WORK SHALL BE IN ACCORDANCE WITH THE KC WATER STANDARDS AND SPECIFICATIONS FOR WATER MAIN EXTENSIONS AND RELOCATIONS, LATEST EDITION, AND THE KC WATER RULES AND REGULATIONS FOR WATER SERVICE LINES, LATEST EDITION, AND THEIR

CONTRACTOR SHALL NOT OPEN. TURN OFF, INTERFERE WITH, OR ATTACH ANY PIPE OR HOSE TO OR TAP ANY WATER MAIN BELONGING TO CITY OF KANSAS CITY WATER SERVICES DEPARTMENT UNLESS DULY AUTHORIZED TO DO SO BY THE CITY. ANY ADVERSE CONSEQUENCE OF ANY SCHEDULED OR UNSCHEDULED DISRUPTIONS OF SERVICE TO THE PUBLIC ARE TO BE THE LIABILITY OF THE CONTRACTOR. <u>KAW VALLEY ENGINEERING AND OWNER ARE TO BE HELD HARMLESS.</u> CONTRACTOR SHALL PROVIDE A MINIMUM OF 72 HOURS NOTICE TO THE CITY OF KANSAS CITY WATER SERVICES DEPARTMENT PRIOR TO STARTING ANY WORK. THE UTILITIES AS SHOWN ON THESE DRAWINGS WERE DEVELOPED FROM THE BEST INFORMATION AVAILABLE, IT IS THE CONTRACTOR'S RESPONSIBILITY TO VERIFY THE LOCATION OF ALL UTILITIES (WHETHER SHOWN OR NOT) AND PROTECT SAID UTILITIES FROM ANY DAMAGE. CONTRACTOR SHALL POTHOLE AND EXPOSE ALL UTILITIES AT LEAST 500 FEET IN ADVANCE OF WATER MAIN CONSTRUCTION, DETERMINING THE DEPTH, SIZE, AND MATERIAL OF THE UTILITIES IN PROXIMITY TO THE PROPOSED WATER MAIN ALIGNMENT. DEFLECT PIPE TO MAINTAIN MINIMUM 5 FEET HORIZONTAL AND 18 INCH VERTICAL CLEARANCES BETWEEN PROPOSED WATER MAIN AND EXISTING UTILITIES. SEPARATION WITH SANITARY LINES REQUIRES 24 INCH VERTICAL CLEARANCE, SEE CONST. NOTE 8. THE CONTRACTOR SHALL FURNISH AND INSTALL, AT NO EXTRA COST, ALL FITTINGS AND RESTRAINING DEVICES REQUIRED TO PROVIDE PROPER HORIZONTAL AND VERTICAL ALIGNMENT FOR THE NEW WATER SERVICE, CONNECTING TO EXISTING WATER MAIN, AND INSTALLATION OF FIRE HYDRANTS AT THE PROPER LOCATION AND ELEVATION, WHETHER OR NOT THE FITTINGS ARE CALLED OUT ON THESE PLANS. REFERENCE KC WATER STANDARDS RULES AND REGULATIONS SECTIONS 3, 4, 5, AND 6, AND KC WATER STANDARDS AND

SPECIFICATION FOR WATER MAIN EXTENSIONS AND RELOCATIONS SECTIONS 02168, 02641, 02645, 02669. THE CONTRACTOR SHALL FURNISH AND INSTALL, AT NO EXTRA COST, ALL TEMPORARY BLOW-OFF ASSEMBLIES, FITTINGS, AND RESTRAINING DEVICES NECESSARY FOR TEMPORARY CONNECTIONS FOR PRESSURE TESTING, CHLORINATING, DE-CHLORINATING, AND FLUSHING THE NEW WATER MAINS AND SERVICE LINES. THE CONTRACTOR SHALL REMOVE ANY CORPORATION COCKS USED FOR TESTING

OR CHLORINATION AND REPLACE THEM WITH TAPERED BRASS PLUGS PRIOR TO PLACING NEW MAINS IN SERVICE. REFERENCE KC WATER MAIN EXTENSIONS AND RELOCATIONS SECTION 02675. THE CONTRACTOR SHALL BE RESPONSIBLE FOR OBTAINING REQUIRED PERMITS, PAYING ALL FEES AND FOR OTHERWISE COMPLYING WITH ALL APPLICABLE REGULATIONS GOVERNING THE WORK. ALL DISTURBED AREAS SHALL BE LANDSCAPED, SEEDED OR SODDED PER PLANS.

WHEN WATER MAINS AND SANITARY SEWERS CROSS, A MINIMUM OF 24 INCHES OF CLEARANCE SHALL BE MAINTAINED BETWEEN THE BOTTOM OF THE WATER MAIN AND THE TOP OF SANITARY SEWER. WHEN 24 INCHES OF CLEARANCE CANNOT BE MAINTAINED OR WHEN A WATER MAIN MUST CROSS UNDER A SANITARY SEWER, THE SANITARY SEWER SHALL BE CONSTRUCTED OF DUCTILE IRON PIPE, PVC PRESSURE PIPE OR PRE-STRESSED CONCRETE CYLINDER PIPE FOR A DISTANCE OF 10.0 FEET ON EACH SIDE OF THE CROSSING. WHEN A WATER MAIN IS CONSTRUCTED PARALLEL TO A SANITARY SEWER, THE HORIZONTAL SEPARATION SHALL BE 10.0 FEET. IF A VERTICAL SEPARATION OF 24 INCHES CANNOT BE MAINTAINED AND IF THE WATER MAIN IS CONSTRUCTED CLOSER THAN 10.0 FEET TO THE SANITARY SEWER, THE SANITARY SEWER SHALL BE CONSTRUCTED OF DUCTILE IRON PIPE, PVC PRESSURE PIPE OR PRE-STRESSED CONCRETE CYLINDER PIPE. AND SHALL BE PRESSURE TESTED FOR WATER TIGHTNESS. REFERENCE KC WATER STANDARDS AND SPECIFICATIONS FOR WATER MAIN EXTENSIONS AND RELOCATIONS SECTION 01016

CONTRACTOR SHALL FIELD CHECK ALL DIMENSIONS, COORDINATES AND ELEVATIONS BEFORE PROCEEDING WITH NEW WORK AND NOTIFY THE ENGINEER OF ANY DISCREPANCIES IMMEDIATELY. NO NEW CONSTRUCTION SHOULD BE PERFORMED BY "SCALING" FROM THE PLANS. 10. ALL EXCAVATION AND BACKFILL SHALL MEET OR EXCEED THE KC WATER STANDARDS AND SPECIFICATIONS FOR WATER MAIN EXTENSIONS AND RELOCATIONS SECTION 02200. ALL TRENCHES SHALL BE BACKFILLED IN UNIFORM LIFTS NOT TO EXCEED 8 INCHES IN LOOSE MEASUREMENT. EACH LIFT SHALL BE COMPACTED TO THE REQUIRED DENSITY PRIOR TO THE NEXT LIFT BEING PLACED. THE BACKFILL MATERIAL SHALL BE COMPACTED TO 95% OF THE MAXIMUM DRY DENSITY WITH A MOISTURE CONTENT OF WITHIN A RANGE OF OPTIMUM TO BE 4 PERCENT ABOVE OPTIMUM MOISTURE CONTENT AS DEFINED BY THE STANDARD PROCTOR (ASTM-D698) UNDER AREAS TO BE PAVED. THE BACKFILL MATERIAL SHALL BE COMPACTED TO 95% OF THE MAXIMUM DENSITY AT OPTIMUM MOISTURE, PLUS 4%, IN AREAS NOT TO BE DEVELOPED. COMPACTION TESTS SHALL BE TAKEN AT EACH PAVEMENT CROSSING AND AT LOCATIONS DESIGNATED BY THE ENGINEER. ALL TRENCH BACKFILL WHICH DOES NOT MEET THE REQUIRED DENSITY, SHALL BE RE-EXCAVATED AND RE-COMPACTED UNTIL THE REQUIRED DENSITY IS OBTAINED. COPIES OF ALL COMPACTION TEST REPORTS SHALL BE PROVIDED TO THE ENGINEER. NO ROCK LARGER THAN FOUR INCHES MAXIMUM DIMENSION SHALL BE PLACED WITHIN TWO FEET OF THE TOP OF THE PIPE. NO ROCK GREATER THAN ONE FOOT SHALL BE PLACED IN ANY EXCAVATION AS A BACKFILL. 12. LOCATIONS SHOWN FOR PROPOSED WATER LINES ARE APPROXIMATE. VARIATIONS MAY BE MADE, WITH APPROVAL OF THE ENGINEER TO

13. TAPS AT EXISTING PUBLIC MAIN WILL BE RESPONSIBILITY OF THE CONTRACTOR. WORK WILL BE COORDINATED WITH THE CITY. 14. ALL PIPE 3" AND LARGER SHALL BE POLYETHYLENE ENCASED CLASS 52 DUCTILE IRON PIPE. ALL WATER MAIN MATERIALS ARE TO BE RESTRAINED AT ALL JOINTS, VALVES, HYDRANTS, COUPLINGS AND FITTINGS. REFERENCE KC WATER STANDARDS AND SPECIFICATIONS FOF

15. HYDRANTS SHALL BE CURRENT KANSAS CITY, MO. PATTERN HYDRANTS MANUFACTURED ESPECIALLY FOR KC WATER. ALL HYDRANTS SHALL BE DESIGNED AND MANUFACTURED IN STRICT COMPLIANCE WITH AWWA C-502 ENTITLED "A.W.W.A. STANDARD FOR DRY-BARREL FIRE HYDRANTS" UNLESS OTHERWISE SPECIFIED. ALL HYDRANTS AND RELATED VALVES/ASSEMBLIES AND INSTALLATION SHALL COMPLY WITH KC WATER STANDARDS AND SPECIFICATIONS FOR WATER MAIN EXTENSIONS AND RELOCATIONS SECTION 02645. 16. WATER SERVICE LINES SHALL HAVE A MINIMUM COVER OF 4 FEET AND A MAXIMUM COVER OF 5 FEET. DEEPER EXCAVATIONS FOR CLEARANCE AT EXISTING PROPOSED UTILITIES IS ACCEPTABLE. REFERENCE CONST. NOTES 3 AND 8 AND KC WATER RULES AND REGULATIONS WATER SERVICE LINES SECTION 3.03E. FOR WATER MAINS CONSTRUCTED UNDER DRIVES OR PARKING AREAS THE DRIVES OR PARKING AREAS ARE TO BE TO SUBGRADE PRIOR TO WATER MAIN CONSTRUCTION. WATER MAINS 16-INCH AND LARGER SHALL BE INSTALLED WITH 60" MINIMUM GROUND COVER BELOW FINISH GRADE. 17. THE CONTRACTOR SHALL DISINFECT, FLUSH AND TEST LINES AS REQUIRED BY APWA AND KC WATER SPECIFICATIONS, LATEST EDITIONS.

WHERE FIRE HYDRANTS ARE NOT LOCATED AT THE END OF LINES, THE CONTRACTOR SHALL FURNISH A FLUSHING DEVICE. 19. ALL FIRE HYDRANT BRANCHES SHALL BE RESTRAINED USING APPROVED RESTRAINING DEVICES. HYDRANTS SHALL BE INSTALLED SO THAT THE CENTERLINE OF THE OUTLET NOZZLE IS BETWEEN EIGHTEEN AND TWENTY-ONE INCHES ABOVE FINISHED GRADE, AND SO THAT THERE IS A MINIMUM CLEAR AREA OF 5' IN EACH DIRECTION TO ALLOW OPERATION OF THE HYDRANT. ALL FIRE HYDRANTS ARE TO BE SET WITH THE BASE 1" ABOVE THE TOP OF CURB OR GRADE.

20. ALL TREES SHALL BE SPARED UNLESS MARKED. REFERENCE PROJECT LAND DISTURBANCE PLANS. 21. ALL THRUST BLOCKS SHALL BE PROVIDED AT TEES, BENDS, AND HYDRANT ASSEMBLIES. REFERENCE KC WATER STANDARDS AND SPECIFICATIONS FOR WATER MAINS AND RELOCATIONS SECTION 02669.

23. LINE IS TO BE AS-BUILT. CONTRACTOR IS RESPONSIBLE TO PREPARE AS-BUILTS AND SUBMIT TO OWNER. ALL BENDS, TEES, VALVES AND LINE 25' INTERVALS SHALL BE FLAGGED AND MARKED WITH DEPTH TO TOP OF PIPE BY CONTRACTOR UPON COMPLETION OF BACKFILL AND MAINTAINED UNTIL LINE IS SURVEYED.

24. SERVICE LINES SHALL HAVE A COVER OF NOT LESS THAN FOUR (4) FEET OR MORE THAN FIVE (5) FEET, UNLESS OBSTRUCTIONS REQUIRE DEEPER EXCAVATION FOR CLEARANCE THAT IS APPROVED BY KC WATER.

ALL WORK RELATED TO SANITARY SEWER SHALL BE COMPLETED IN ACCORDANCE WITH SECTION 2500, SANITARY SEWERS, OF THE KANSAS CITY METROPOLITAIN CHAPTER OF APWA SPECFIICATIONS AS ADOPTED AND AMENDED BY THE CITY OF KANSAS CITY, MISSOURI. 2. ALL PIPE USED FOR SANITARY SEWER SHALL BE DIP (CL 52) OR PVC (SDR 26) AS NOTED ON PLANS. MATERIAL SHALL CONFORM TO SECTION 2503 D & F RESPECTIVELY. PROVIDE TRACER WIRE ON NON-FERROUS PIPES. 3. ALL EXISTING UTILITIES INDICATED ON THE DRAWINGS ARE ACCORDING TO THE BEST INFORMATION AVAILABLE TO THE ENGINEER; HOWEVER, ALL UTILITIES ACTUALLY EXISTING MAY NOT BE SHOWN. UTILITIES DAMAGED THROUGH THE NEGLIGENCE OF THE CONTRACTOR LOCATION OF SAME SHALL BE REPAIRED OR REPLACED BY THE CONTRACTOR AT HIS EXPENS

4. ALL INSTALLATION SHALL BE COMPLETED IN ACCORDANCE WITH SECTION 2506. REFER TO SECTION 2509 FOR TESTING AND ACCEPTANCE 5. EXCAVATION, TRENCHING AND BACKFILL SHALL BE COMPLETED IN ACCORDANCE WITH SECTIONS 2505 & 2507 ALL EXCAVATIONS SHALL BE CONSIDERED UNCLASSIFIED. REFER TO PROJECT GEOTECHNICAL REPORT. 6. ALL BACKFILL SHALL BE COMPACTED. BACKFILL WITHIN THE RIGHT-OF-WAY AND UNDER PARKING AREAS AND SLABS SHALL BE 95% COMPACTION OF OPTIMUM MOISTURE. REFERENCE SECTION 2507.3 OF THE KANSAS CITY METROPOLITAN CHAPTER OF APWA SPECIFICATIONS AS ADOPTED AND AMENDED BY THE CITY OF KANSAS CITY

7. ALL STUB LINES SHALL BE LAID ON 1.00% GRADE FOR 6" PIPE AND 2.00% GRADE FOR 4" PIPE, UNLESS NOTED OTHERWISE. TRACER WIRE SHALL BE INSTALLED ALONG THE TOP OF SERVICE LINES. THE WIRE SHALL HAVE HDPE INSULATION, BE NO SMALLER THAN 12 GAUGE, AND INTENDED FOR UNDERGROUND APPLICATIONS. THE TRACER WIRE SHALL BE GREEN IN COLOR. TRACER WIRES SHALL TERMINATE AT THE GROUND SURFACE INSIDE A TRACER BOX. TRACER BOX LIDS SHALL BE GREEN IN COLOR. TRACER WIRE SHALL BE GROUNDED TO A MINIMUM ONE POUND MAGNESIUM ANODE AT THE SEWER LINE.

OF THE KANSAS CITY METROPOLITAN CHAPTER OF APWA SPECIFICATIONS AS ADOPTED AND AMENDED BY THE CITY OF KANSAS CITY. ALL BACKFILL SHALL BE TAMPED. BACKFILL WITHIN THE RIGHT-OF-WAY AND UNDER PARKING AREAS AND SLABS SHALL BE 95%

CONTRACTOR SHALL NOT OPEN, TURN OFF, INTERFERE WITH, OR ATTACH ANY PIPE OR HOSE TO OR TAP ANY WATER MAIN BELONGING TO THE KCMO WSD UNLESS DULY AUTHORIZED TO DO SO. ANY ADVERSE CONSEQUENCE OF ANY SCHEDULED OR UNSCHEDULED DISRUPTIONS OF SERVICE TO THE PUBLIC ARE TO BE THE LIABILITY OF THE CONTRACTOR. KAW VALLEY ENGINEERING AND OWNER ARE TO BE HELD HARMLESS. CONTRACTOR SHALL NOTIFY THE KCMO WSD 48 HOURS MINIMUM. CONTRACTOR TO INSTALL TRACING WIRE ALONG ALL NON-METALLIC SERVICE LINES PER SPECIFICATIONS.

CONTRACTOR SHALL EXPOSE EXISTING UTILITIES AT LOCATIONS OF POSSIBLE CONFLICT AND POINTS OF CONNECTION PRIOR TO ANY A MINIMUM HORIZONTAL DISTANCE SHALL BE MAINTAINED BETWEEN PARALLEL WATER AND SANITARY SEWER LINES. REFERENCE APWA

SPECIFICATIONS AND KCMO WSD STANDARDS AND SPECIFICATIONS. CONTRACTOR TO SCHEDULE ALL INSPECTIONS FOR SEWER MAIN CONNECTIONS THROUGH THE PUBLIC WORKS DEPARTMENT CONTRACTOR TO RELOCATE ELECTRICAL FEED AND CONDUIT TO SITE LIGHTING. PROVIDE HANDHOLES AT SPLICE POINTS IF NEEDED. WHERE SERVICE LINES MUST CROSS OVER SEWERS, STORM DRAINS, WATER, OR GAS LINES, THE SERVICE LINE MUST BE LAID AT SUCH AN ELEVATION THAT THE BOTTOM OF THE SERVICE LINE IS AT LEAST EIGHTEEN (18) INCHES ABOVE THE TOP OF THE SEWER OR OTHER PIPE. THIS VERTICAL SEPARATION MUST BE MAINTAINED FOR THAT PORTION OF THE SERVICE LINE WITHIN TEN FEET HORIZONTALLY OF ANY SEWER LINE THAT IT CROSSES SAID TEN FEET TO BE MEASURED AS THE CLEARANCE FROM THE SERVICE LINE


STORM SEWER NOTES: 1. ALL WORK SHALL BE COMPLETED IN ACCORDANCE WITH SECTION 2600 STORM SEWER OF THE KANSAS CITY METRO CHAPTER OF APWA SPECIFICATIONS. REFERENCE APWA SPECIFICATION SECTION 2602.3 A & C FOR EXCAVATION, TRENCHING AND BACKFILLING FOR PIPE FOR SEWER CONSTRUCTION SHALL CONFROM TO SECTION 2602 UNLESS NOTED OTHERWISE

3. A MINIMUM OF 18" COVER SHALL BE PROVIDED PRIOR TO AND MAINTAINED AFTER INSTALLATION OF STORM SEWER. 4. ALL COORDINATES FOR CURB INLETS ARE TO THE MIDDLE OF THE INSIDE FRONT FACE. ALL COORDINATES FOR PVC STRUCTURES AND CONCRETE YARD INLETS ARE TO THE CENTER OF OF THE STRUCTURE. 5. ALL JUNCTION BOXES/AREA INLETS HAVE ONE COORDINATE PROVIDED AT THE CENTER OF STRUCTURE. SEE PLAN FOR CLARIFICATION.

ORIENT STRUCTURES PARALLEL TO ADJACENT CURB, BUILDING OR WALL FACE, UNLESS NOTED OTHERWISE. RIM ELEVATION IS PROVIDED AT COORDINATE, UNLESS NOTED OTHERWISE. CONTRACTOR TO ADJUST ELEVATION OF RIM AS REQUIRED TO MATCH SLOPE OF ADJACENT CURB LINE. REFER TO GRADING PLAN SHEET C300. ALL EXISTING UTILITIES INDICATED ON THE DRAWING ARE ACCORDING TO THE BEST INFORMATION AVAILABLE TO THE ENGINEER; HOWEVER, ALL UTILITIES ACTUALLY EXISTING MAY NOT BE SHOWN. UTILITIES DAMAGED THROUGH THE NEGLIGENCE OF THE CONTRACTOR TO OBTAIN THE LOCATION OF SAME SHALL BE REPAIRED OR REPLACED BY THE CONTRACTOR AT THEIR EXPENSE. 8. ALL BACKFILL SHALL BE COMPACTED TO 95 PERCENT STANDARD DENSITY AT OPTIMUM MOISTURE. 9. ALL EXCAVATION BENEATH THE STREETS AND PARKING LOTS FOR DRAINAGE PIPE LESS THAN 4'-0" IN DIAMETER SHALL BE

10. RELOCATION OF ANY WATER LINE, SEWER LINE OR SERVICE LINE THEREOF REQUIRED FOR THE CONSTRUCTION OF THIS PROJECT SHALL BE THE RESPONSIBILITY OF THE CONTRACTOR AND SHALL BE AT THEIR EXPENSE. 11. IF PRECAST STORM STRUCTURES ARE TO BE USED ON THIS PROJECT, THE CONTRACTOR SHALL SUBMIT SHOP DRAWINGS AND HAVE THEM APPROVED BY THE ENGINEER PRIOR TO FABRICATION OF THE STRUCTURES. FAILURE TO DO SO SHALL BE CAUSE FOR

AUTHORITY # 000842. EXPIRES 12/31/23

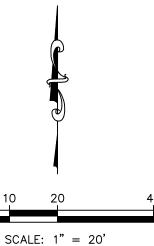

PROJ. NO. C23_1760 CFN: 1760UP.DWG	LENEX PH. (913) 894- Ix@kveng	CHRISTIAN J. CROWDER ENGINEER MO # 2015000538 WEST 114TH TERRACE XA, KANSAS 66215 -5150   FAX (913) 894-5977 g.com   www.kveng.com
		<b>r</b> Engineering
		AUTHORIZED TO OFFER STATE CERTIFICATE OF



Project Title / Address:

### **KCI New Tower and Hotel Refresh**

### 11832 NW Plaza Cir Kansas City MO 64153



Structural Consultant:

MEP Consultant:



Revisions


CITY REVIEW RESPONSE 10/13/23 1

09/18/23 Issue Date: Initial Submittal Reason for Issue: 22-056 Project Number DD Project Phase:

Sheet Title:

## UTILITY PLAN

Sheet Number: Pkg:

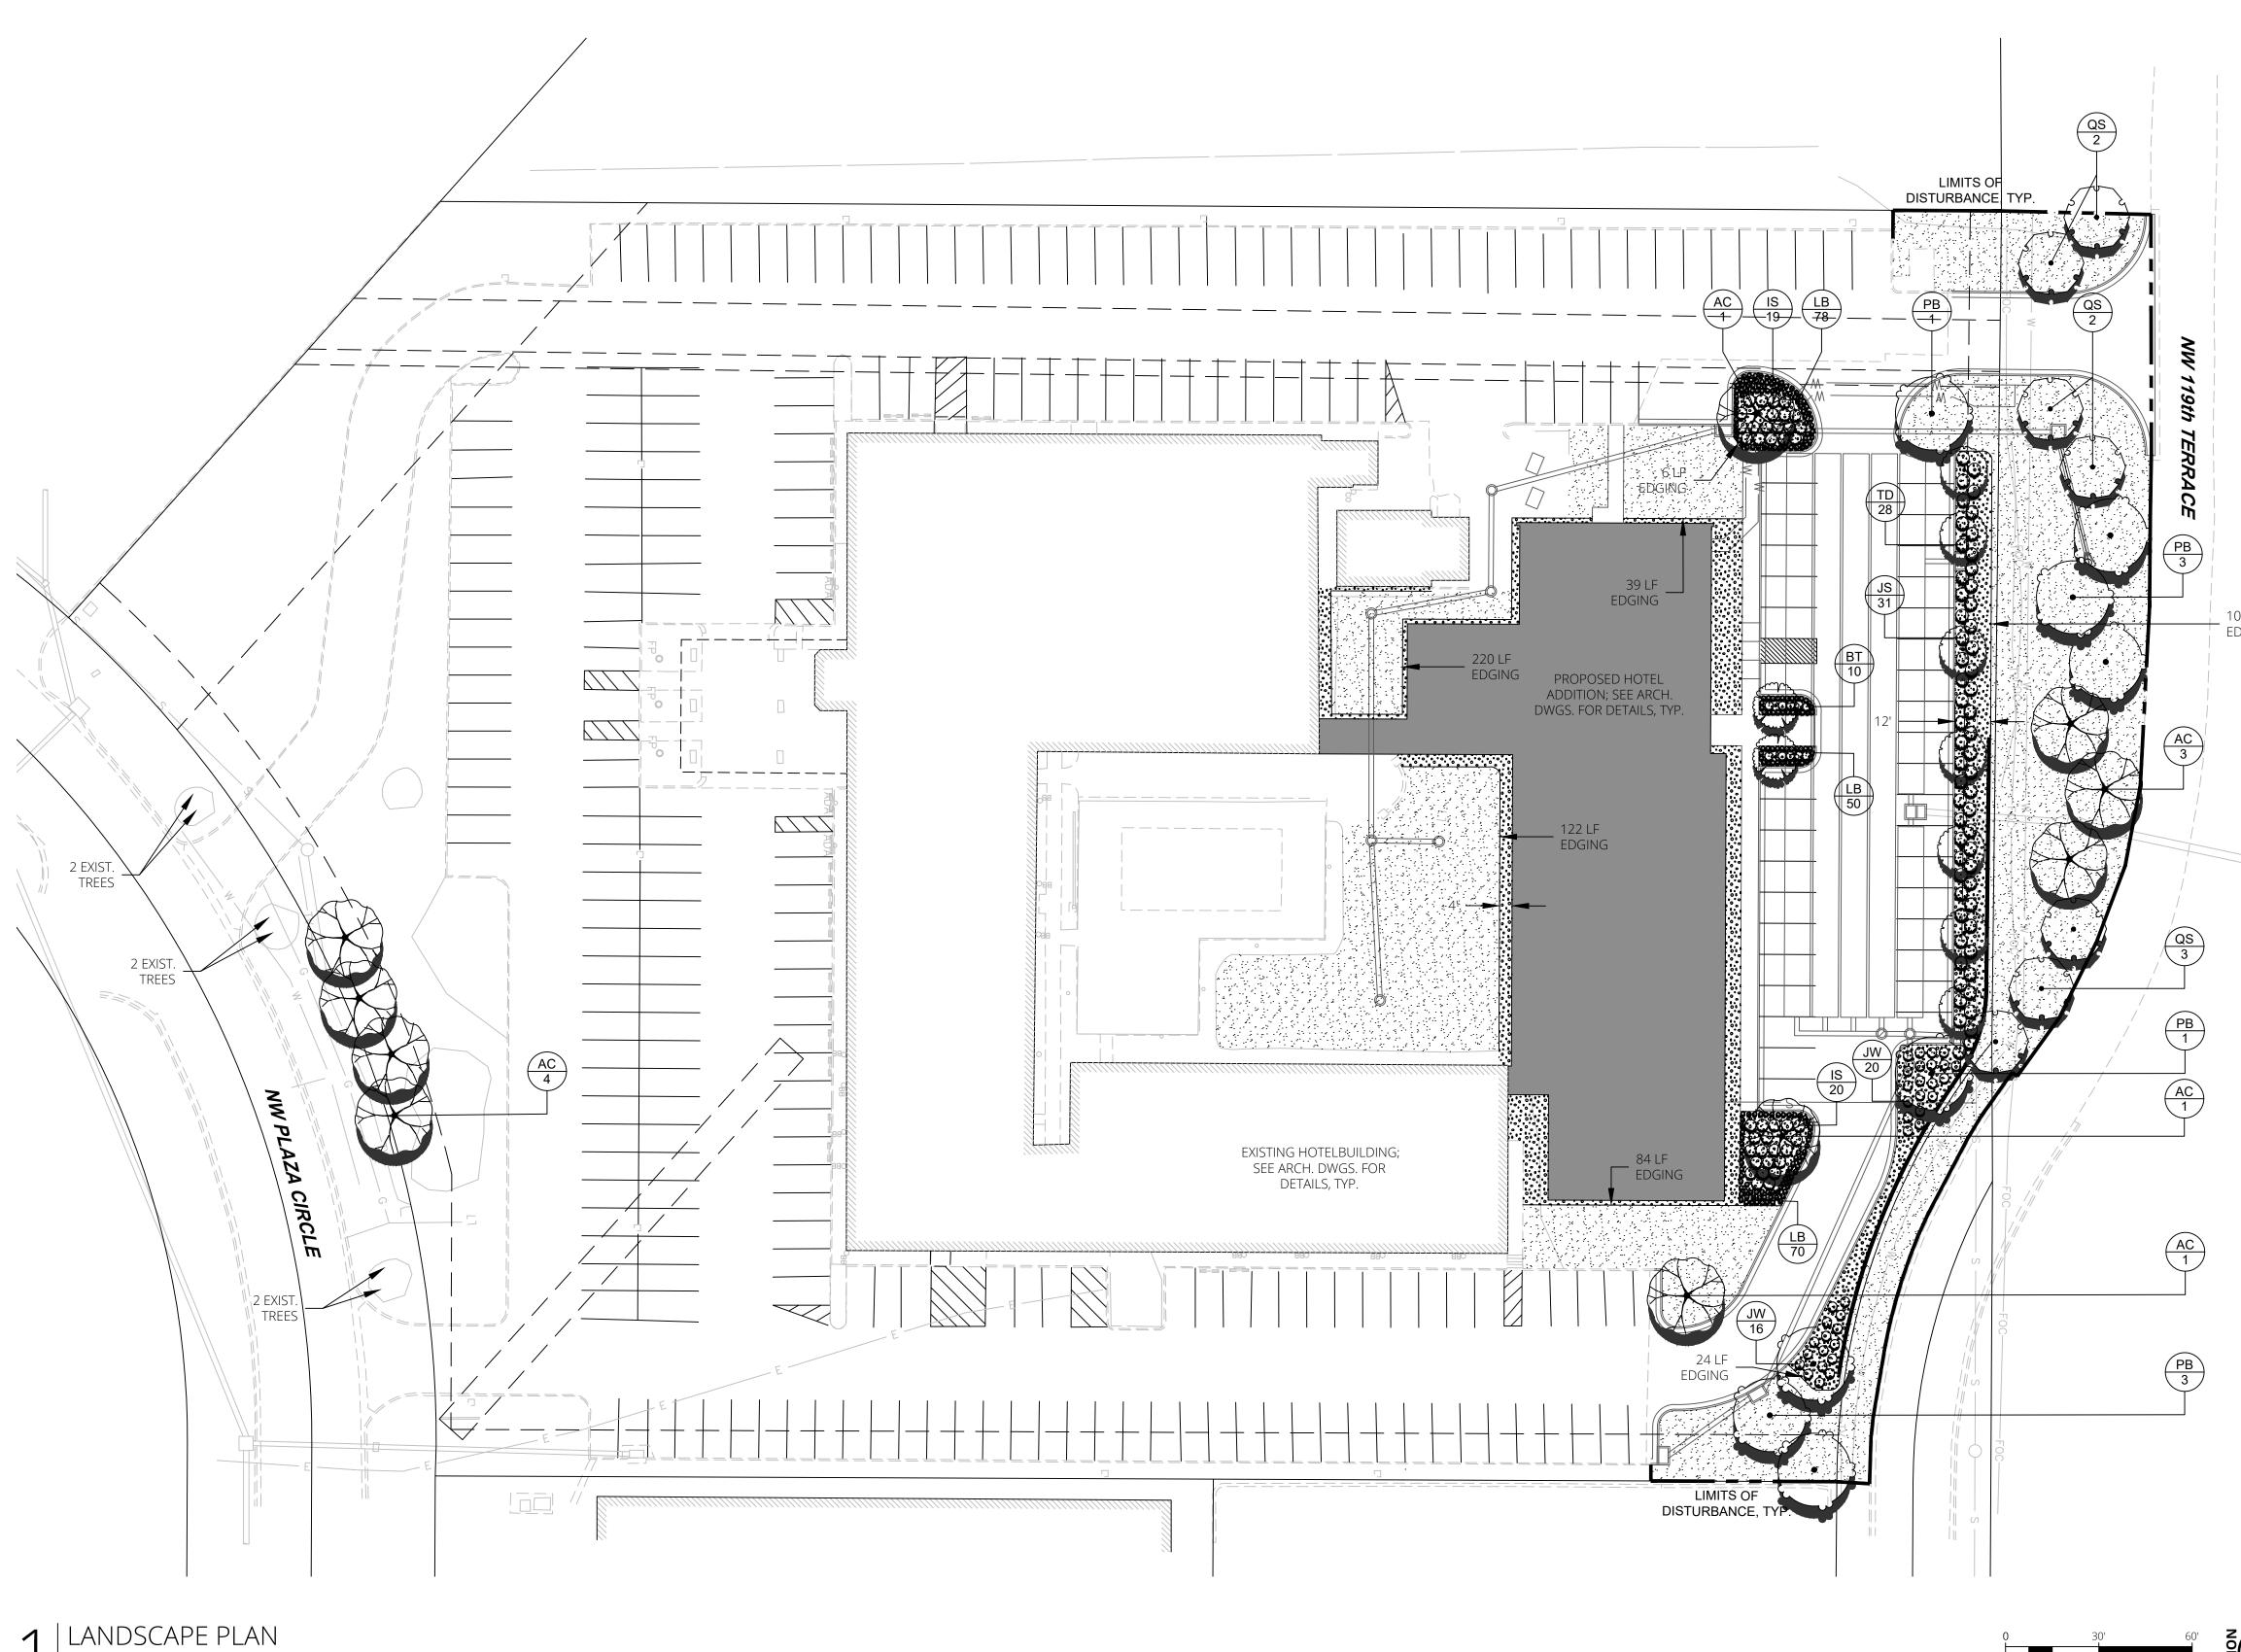

SCALE = 1" = 30'

## LANDSCAPE SCHEDULE

DECIDUOUS TR	REES <u>C</u>	DDE QTY	COMMON / BOTANICAL NAME	CONT CAL	SHRUBS	CODE	QTY	COMMON / BOTANICAL NAME	CONT	GROUND COVERS	CODE	QTY	COMMON / BOTANICAL NAME	CONT
	A	C 10	CADDO SUGAR MAPLE / ACER SACCHARUM `CADDO`	B&B 2"CAL		BT	10	SUNJOY TANGELO BARBERRY / BERBERIS THUNBERGII `SUNJOY TANGELO`	#3		DG	6,721 SF	DECORATIVE GRAVEL / 1" - 3" MISSOURI RAINBOW	ROCK
	PE	8 8	BLOODGOOD LONDON PLANE TREE / PLATANUS X ACERIFOLIA 'BLOODGOOD'	B&B 2"CAL	$\odot$	IS	39	SHAMROCK INKBERRY HOLLY / ILEX GLABRA 'SHAMROCK'	#3					
p · ·	Q	67	SHUMARD OAK / QUERCUS SHUMARDII	B&B 2"CAL	$\odot$	JW	36	BLUE RUG JUNIPER / JUNIPERUS HORIZONTALIS 'WILTONII'	#3		TS	25,668 SF	TURF SOD / DROUGHT TOLERANT FESCUE BLEND	SOD
ORNAMENTAL 1	TREES CO	DDE <u>QTY</u>	COMMON / BOTANICAL NAME	<u>CONT</u> <u>CAL</u>	$\odot$	JS	31	SEA GREEN PFITZER JUNIPER / JUNIPERUS X PFITZERIANA `SEA GREEN`	#3					
$\langle \cdot \rangle$	C		EASTERN REDBUD / CERCIS CANADENSIS	B&B 2"CAL	$\odot$	TD	28	DENSIFORMIS YEW / TAXUS X MEDIA `DENSIFORMIS`	#5					
£.3	M	G 2	GALAXY MAGNOLIA / MAGNOLIA X 'GALAXY'	B&B 2"CAL	GRASSES & PERENNIALS		<u>QTY</u>	COMMON / BOTANICAL NAME	<u>CONT</u>					
E. Lund					i.J	LB	198	BIG BLUE LILYTURF / LIRIOPE MUSCARI 'BIG BLUE'	#1					

## LANDSCAPE REQUIREMENTS

88-425 – LANDSCAPE REQUIREMENTS	Required	Proposed	Alternative Requested?	Approved
88-425-03 Street Trees	25	25		
88-425-04 General	11	52		
88-425-05 Perimeter Vehicular Use Area Adjacent to Streets	10	10		
Buffer Width Trees	10 7	12 7		
Shrubs/Wall/Berm	N/A	59		
Adjacent to Residential Zones Buffer Width Shrubs/Berm/Fence/Wall	N/A N/A N/A	N/A N/A N/A		
88-425-06 Interior Vehicular Use Area Interior Area Trees Shrubs	1,295 SF 8 37	3,700 SF 8 69		
88-425-07 Parking Garage Screening	Describe			
88-425-08 Mechanical/Utility Equipment Screening	Describe			
88-425-09 Outdoor Use Screening	Describe			

103 LF EDGING

NORTH





Issue Date:	09/13/23
Reason for Issue:	Review
Project Number:	22-056
Project Phase:	Dev Plan Review


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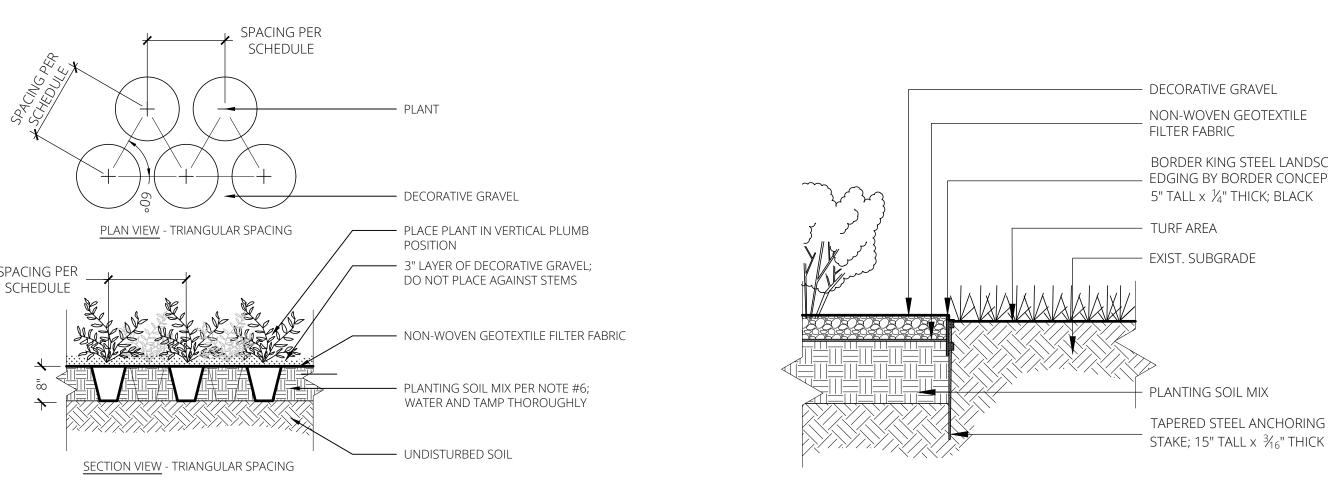
## Landscape Plan




## LANDSCAPE NOTES

- 1. CONTRACTOR SHALL LOCATE ALL UTILITIES BEFORE COMMENCING WORK. CONTACT THE MISSOURI ONE CALL SYSTEM AT 1-800-DIG-RITE OR 811 TO FILE A LOCATE REQUEST PRIOR TO ANY EXCAVATION. CONTRACTOR SHALL BE RESPONSIBLE FOR THE REPAIR OF ANY DAMAGE TO UTILITIES RESULTING FROM LANDSCAPE OPERATIONS. ANY UTILITIES SHOWN ON THIS PLAN ARE FOR REFERENCE ONLY AND MAY OR MAY NOT DEPICT THE ACTUAL LOCATION OF SERVICES.
- 2. QUANTITIES OF MATERIALS SHOWN ON THE LANDSCAPE PLAN TAKE PRECEDENCE OVER QUANTITIES SHOWN ON THE PLANT SCHEDULE. CONTRACTOR SHALL BE RESPONSIBLE FOR VERIFYING ALL QUANTITIES ON THE LANDSCAPE PLAN PRIOR TO BIDDING.
- REPORT ANY DISCREPANCIES IN THE LANDSCAPE PLAN TO THE LANDSCAPE ARCHITECT, PRIOR TO PURCHASING MATERIALS OR STARTING CONSTRUCTION.
- 4. ALL DISTURBED AREAS NOT COVERED BY BUILDING OR PAVEMENT SHALL BE BROUGHT TO FINISH GRADE AND SODDED IN TURF-TYPE TALL FESCUE OR OTHER APPROPRIATE GROUND COVERS, AS DEPICTED ON SHEET L1.01.
- CONTRACTOR SHALL PROVIDE OWNER'S REPRESENTATIVE WITH SOIL TEST ANALYSIS REPORTS FOR EACH SAMPLE OF EXISTING SOIL, TOPSOIL, COMPOST, AND PLANTING SOIL MIX PRIOR TO PLANTING PREPARATION. ANALYSES SHALL BE CONDUCTED BY A QUALIFIED SOIL-TESTING LABORATORY AND INCLUDE, BUT NOT BE LIMITED TO, THE FOLLOWING PARAMETERS: PARTICLE SIZE ANALYSIS (% DRY WEIGHT), USDA SOIL TEXTURE, pH AND BUFFER pH, ORGANIC CONTENT (% DRY WEIGHT), MOISTURE CONTENT (% WET WEIGHT), PHYSICAL CONTAMINANTS (% DRY WEIGHT), AND NUTRIENT LEVELS (NITROGEN, PHOSPHORUS, POTASSIUM).
- ALL PLANTING BEDS SHALL BE AMENDED WITH A PLANTING SOIL MIX CONSISTING OF EXISTING SOIL, TOPSOIL, AND COMPOST TO MAKE A NEW SOIL WHICH MEETS THE PROJECT GOALS FOR THE INDICATED PLANTING AREAS. THESE COMPONENTS WILL BE MIXED ON-SITE IN THE FOLLOWING RATION (BY MOIST VOLUME): EXISTING SOIL, 65-70%; TOPSOIL (UNSCREENED), 25-30%; AND COMPOST, 5%. MIX THE TOPSOIL AND COMPOST TOGETHER FIRST AND THEN ADD TO THE EXISTING SOIL. MIX WITH A LOADER BUCKET TO LOOSELY INCORPORATE THE TOPSOIL/COMPOST MIX INTO THE EXISTING SOIL. DO NOT OVER MIX. DO NOT MIX WITH A SOIL BLENDING MACHINE. DO NOT SCREEN THE SOIL. CLUMPS OF TOPSOIL, COMPOST AND EXISTING SOIL WILL BE PERMITTED IN THE OVERALL MIX. AT THE TIME OF FINAL GRADING, ADD LIME OR OTHER INORGANIC AMENDMENTS, ONLY IF REQUIRED, AT RATES RECOMMENDED BY THE SOIL TESTING ANALYSES FOR THE PLANTS TO BE GROWN. PROVIDE A ONE-GALLON SAMPLE WITH TESTING DATA THAT INCLUDES RECOMMENDATIONS FOR CHEMICAL ADDITIVES FOR THE TYPES OF PLANTS TO BE GROWN. SAMPLES AND TESTING DATA SHALL BE SUBMITTED AT THE SAME TIME.
- 7. PLANT PIT BACKFILL FOR TREES AND SHRUBS SHALL BE PLANTING SOIL MIX, AS DESCRIBED IN ABOVE NOTE. 8. ALL PLANT MATERIAL SHALL BE WELL-FORMED AND DEVELOPED IN GOOD CONDITION, HEALTHY AND DISEASE-FREE, AND BE TYPICAL OF THE SPECIES. PLANTS SHALL COMPLY WITH ACCEPTABLE STANDARDS AS SET
- FORTH IN THE LATEST EDITION OF THE "AMERICAN STANDARD FOR NURSERY STOCK." 9. ALL PLANT MATERIALS SHALL BE PROTECTED FROM THE DRYING ACTION OF THE SUN AND WIND AFTER BEING DUG, WHILE BEING TRANSPORTED, AND WHILE AWAITING PLANTING. ROOT BALLS OF PLANTS WHICH CANNOT BE PLANTED IMMEDIATELY SHALL BE PROTECTED FROM DRYING ACTION BY COVERING THEM WITH MOIST MULCH. PERIODICALLY, APPLY WATER TO MULCH-COVERED ROOT BALLS TO KEEP THEM MOIST. IF PLANTING SHOULD OCCUR DURING GROWING SEASON, APPLY ANTI-DESSICANT TO LEAVES BEFORE TRANSPORT TO REDUCE LIKELIHOOD OF WINDBURN. REAPPLY ANTI-DESSICANT AFTER PLANTING TO REDUCE TRANSPIRATION.
- 10. PLANTS DESIGNATED AS CONTAINER GROWN SHALL HAVE BEEN GROWN IN POTS, CANS OR BOXES FOR A MINIMUM OF SIX MONTHS AND A MAXIMUM OF TWO YEARS. THESE PLANTS SHALL BE REMOVED FROM CONTAINERS BEFORE PLANTING. PLANTS THAT APPEAR ROOT-BOUND SHALL BE REJECTED.
- 11. APPLY A 3" LAYER OF 1-3" DIAMETER DECORATIVE GRAVEL OVER NONWOVEN GEOTEXTILE FABRIC IN ALL PLANTING BEDS ADJACENT TO THE BUILDING AND A 3" LAYER OF SHREDDED BARK MULCH AROUND ANY TREES OTHERWISE PLACED WITHIN TURF AREAS. IN BOTH CASES, MULCH SHOULD NOT COME IN CONTACT WITH PLANT TRUNKS OR STEMS.
- 12. ALL TURF AREAS SHALL BE SEPARATED FROM THE BUILDING FOUNDATION WALL BY AN AGGREGATE MOW STRIP 18 INCHES IN WIDTH, 6 INCHES IN DEPTH, AND CONSISTING OF 1-3" DIAMETER DECORATIVE GRAVEL. REFER TO SHEET L101, DETAIL #6.
- 13. ALL PLANTING BEDS AND AGGREGATE MOW STRIPS MUST BE SEPARATED FROM TURF AREAS WITH STEEL LANDSCAPE EDGING. PROVIDE "BORDER KING STEEL LANDSCAPE EDGING" MANUFACTURED BY BORDER CONCEPTS, INC., OR APPROVED EQUAL. REFER TO SHEET L1.02, DETAIL #5.
- 14. CONTRACTOR SHALL USE AN APPROVED TREE GUYING SYSTEM. TREE GUYING TO BE FLAT WOVEN POLYPROPYLENE MATERIAL, 3/4-INCH-WIDE, WITH A TENSILE STRENGTH OF 900 LBS. HOSE AND WIRE WILL NOT BE ACCEPTED. SUBJECT TO COMPLIANCE WITH THESE REQUIREMENTS, PROVIDE ONE OF THE FOLLOWING PRODUCTS, OR APPROVED EQUAL:
  - a. "ARBORTIE GREEN" MANUFACTURED BY DEEP ROOT PARTNERS, LP
  - b. "LEONARD TREE TIE WEBBING GREEN" MANUFACTURED BY A.M. LEONARD, INC.
- 18. TURF SEED SHALL COMPLY WITH U.S. DEPARTMENT OF AGRICULTURE RULES AND REGULATIONS UNDER THE FEDERAL SEED ACT AND BE EQUAL IN QUALITY TO STANDARDS FOR CERTIFIED SEED. SEED SHALL BE A TURF-TYPE FESCUE BLEND CONSISTING OF 85% TURF-TYPE TALL FESCUE, 10% KENTUCKY BLUEGRASS, AND 5% ANNUAL RYEGRASS. ALL SEEDED AREAS SHALL BE MULCHED WITH STRAW OR HYDROMULCH AT TIME OF INSTALLATION UNTIL SEED HAS ESTABLISHED.
- 19. TURF SOD SHALL BE CERTIFIED TURF GRASS SOD COMPLYING WITH TURFGRASS PRODUCERS INTERNATIONAL'S "GUIDELINE SPECIFICATIONS FOR TURFGRASS SODDING." SOD SHALL BE TURF-TYPE TALL FESCUE HARVESTED FROM A SOD FARM LOCATED WITHIN 100 MILES OF THE PROJECT SITE. SOD SHALL BE WELL ROOTED, 2-YEAR OLD STOCK HARVESTED IN ROLLS AND FERTILIZED 2-3 WEEKS PRIOR TO CUTTING. ALL SOD SHALL BE MACHINE CUT AND VIGOROUSLY GROWING (NOT DORMANT). MAXIMUM TIME FROM STRIPPING TO PLANTING SHALL BE 24 HOURS. THE SOD SHALL CONTAIN A GROWTH OF NOT MORE THAN TEN (10%) PERCENT OF OTHER GRASSES AND CLOVERS, SHALL BE FREE FROM ALL PROHIBITED AND NOXIOUS WEEDS AND SHALL BE THREE-FOURTHS  $(\frac{3}{4})$ INCH TO ONE AND ON-FOURTH (1- $\frac{1}{4}$ ") INCH THICK. SOD SHALL BE CUT IN STRIPS NOT LESS THAN 18 INCHES WIDE AND THREE (3) FEET LONG.
- 20. THE CONTRACTOR SHALL PROVIDE ALL WATER, WATERING DEVICES AND LABOR NEEDED TO IRRIGATE PLANT MATERIALS UNTIL PROVISIONAL ACCEPTANCE OF THE PROJECT. THE CONTRACTOR SHALL SUPPLY ENOUGH WATER TO MAINTAIN THE PLANT'S HEALTHY CONDITION.
- 21. REMOVE ALL RUBBISH, EQUIPMENT, AND MATERIAL AND LEAVE THE AREA IN A NEAT, CLEAN CONDITION EACH DAY. MAINTAIN PAVED AREAS UTILIZED FOR HAULING EQUIPMENT AND MATERIALS BY OTHER TRADES IN A CLEAN AND UNOBSTRUCTED CONDITION AT ALL TIMES. REMOVE SOIL OR DIRT THAT ACCUMULATES DUE TO PLANTING OPERATIONS EACH DAY.
- 22. AT THE COMPLETION OF PLANTING OPERATIONS ALL PLANTS SHALL BE INSPECTED BY THE OWNER'S REPRESENTATIVE. CONTRACTOR SHALL REPLACE IMMEDIATELY ANY PLANTS NOT IN HEALTHY AND VIGOROUS CONDITION AT THAT TIME AT NO EXPENSE TO THE OWNER. ANY PLANT NOT IN HEALTHY CONDITION AFTER ONE FULL YEAR FROM THE DATE OF FINAL ACCEPTANCE SHALL BE REPLACED AS PER THE ORIGINAL SPECIFICATIONS, FREE OF CHARGE TO THE OWNER.
- 23. OWNER'S REPRESENTATIVE RESERVES THE RIGHT TO REJECT AT ANY TIME OR PLACE PRIOR TO FINAL ACCEPTANCE OF WORK, ANY AND ALL PLANTS WHICH, IN THEIR OPINION, FAIL TO MEET THESE SPECIFICATION REQUIREMENTS.
- 24. CONTRACTOR SHALL GUARANTEE TREES, SHRUBS, PERENNIALS AND TURF FOR ONE CALENDAR YEAR FOLLOWING PROVISIONAL ACCEPTANCE OF THE OVERALL PROJECT. DURING THE GUARANTEE PERIOD, PLANTS THAT DIE DUE TO NATURAL CAUSES OR THAT ARE UNHEALTHY OR UNSIGHTLY IN CONDITION, SHALL BE REPLACED BY THE CONTRACTOR. PLANTS USED FOR THE REPLACEMENT SHALL BE OF THE SAME VARIETY AND SIZE AS ORIGINALLY SPECIFIED IN THE PLANT SCHEDULE. REPLACEMENTS SHALL BE MADE WITHIN ONE WEEK OF REQUEST PENDING FAVORABLE SEASONAL PLANTING CONDITIONS. GUARANTEE WILL NOT BE ENFORCED SHOULD THE PLANT MATERIAL DIE DUE TO VANDALISM, OVER OR UNDER WATERING BY THE OWNER, IMPROPER MAINTENANCE PROCEDURES CARRIED OUT BY THE OWNER INVOLVING LAWN MOWER DAMAGE, OVER FERTILIZATION, ACTS NOT RELATED TO CONTRACTUAL RESPONSIBILITIES OF CONTRACTOR OR SIMILAR CIRCUMSTANCES BEYOND THE CONTROL OF THE CONTRACTOR.
- 25. THE DEVELOPER SHALL SUBMIT AN AFFIDAVIT, COMPLETED BY A LANDSCAPE ARCHITECT LICENSED IN THE STATE OF MISSOURI, VERIFYING THAT ALL LANDSCAPING REQUIRED OF THE APPROVED PLAN HAS BEEN INSTALLED IN ACCORDANCE WITH THE PLAN AND IS HEALTHY PRIOR TO CERTIFICATE OF OCCUPANCY.



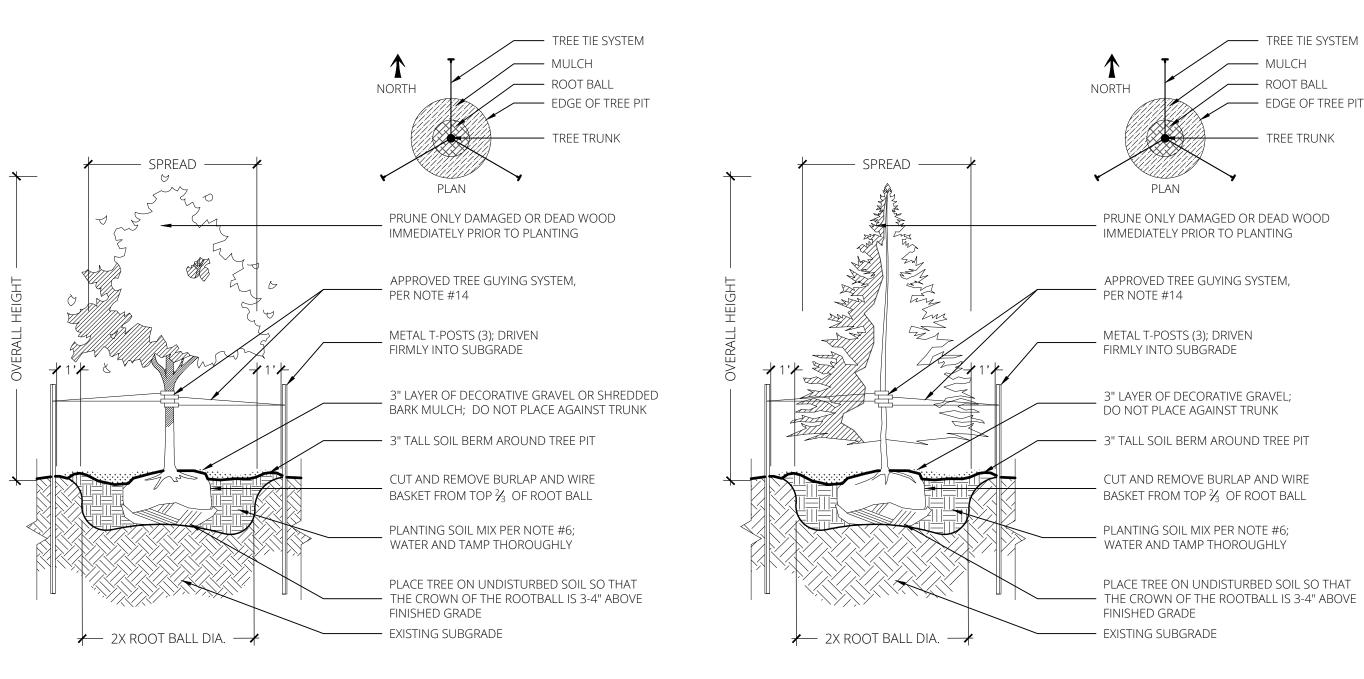

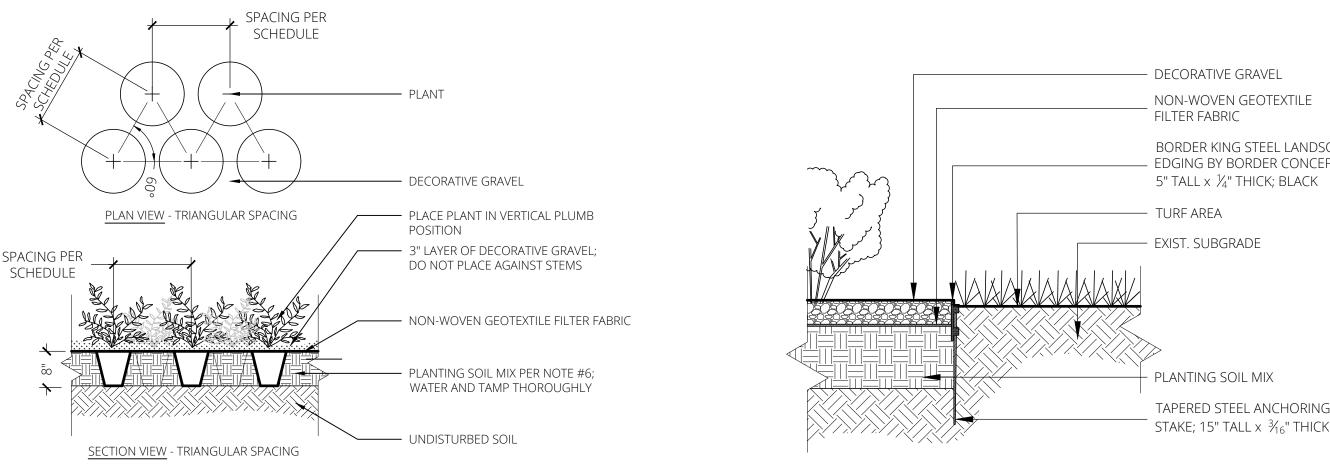

PERENNIAL PLANTING SCALE = 1/2'' = 1'-0''

# DECIDUOUS TREE PLANTING SCALE = 1/4" = 1'-0"



# 5 LANDSCAPE EDGING SCALE = 1" = 1'-0"


 $\frown$  EVERGREEN TREE PLANTING

**SCALE** = 1/4" = 1'-0"

BORDER KING STEEL LANDSCAPE EDGING BY BORDER CONCEPTS, INC.;



N

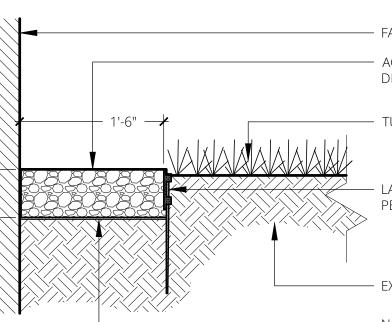

FACE OF BUILDING AGGREGATE MOW STRIP DECORATIVE GRAVEL

TURF AREA

LANDSCAPE EDGING, PER DETAIL #5

EXIST. SUBGRADE

NON WOVEN GEOTEXTILE FILTER FABRIC

MOW STRIP SCALE = 1" 1'-0'

3 SHRUB PLANTING SCALE = 1/2" = 1'-0"

24" LARGER THAN CONTAINER

- 3" LAYER OF DECORATIVE GRAVEL; DO NOT PLACE AGAINST STEMS - NON-WOVEN GEOTEXTILE FILTER FABRIC

- PLACE SHRUB IN UPRIGHT POSITION


- 3" TALL SOIL BERM AROUND SHRUB PIT


AND PLACE SHRUB IN UPRIGHT POSITION

REMOVE CONTAINER COMPLETELY PLANTING SOIL MIX PER NOTE #6; WATER AND TAMP THOROUGHLY

- UNDISTURBED SOIL

Schedule		<u> </u>				-						
Symbol	Label	Image	Quantity	Manufact	urer	Cata	log Number	Descripti	on		Number Lamps	Lumen Per Lam
⊕	A	1.440	18	Americar Lighting	Electric	ATB	M P50 XXXX R4 3K	АТВМ, Р 3000К С	erformance Packa CT	ge P50, Type 4,	1	17154
0	В		7	Lithonia L	ighting	WPX	K1 LED P2 40K Mvolt		ED wallpack 3000l ure 120-277 Volts	n 4000K color	1	2913
Sta	tistic	S										
	criptio		Syml	bol	Avg		Max		Min	Max/Mi	n í	Avg/ľ
Calc	Zone	: #1	+	-	1.3 fc		12.8 fc		0.0 fc	N/A		N/
Stat	Zone	#1	*	<	2.3 fc		4.6 fc		0.7 fc	6.6:1		3.3
Side	walk		*		2.5 fc		2.8 fc		1.7 fc	1.6:1		1.5

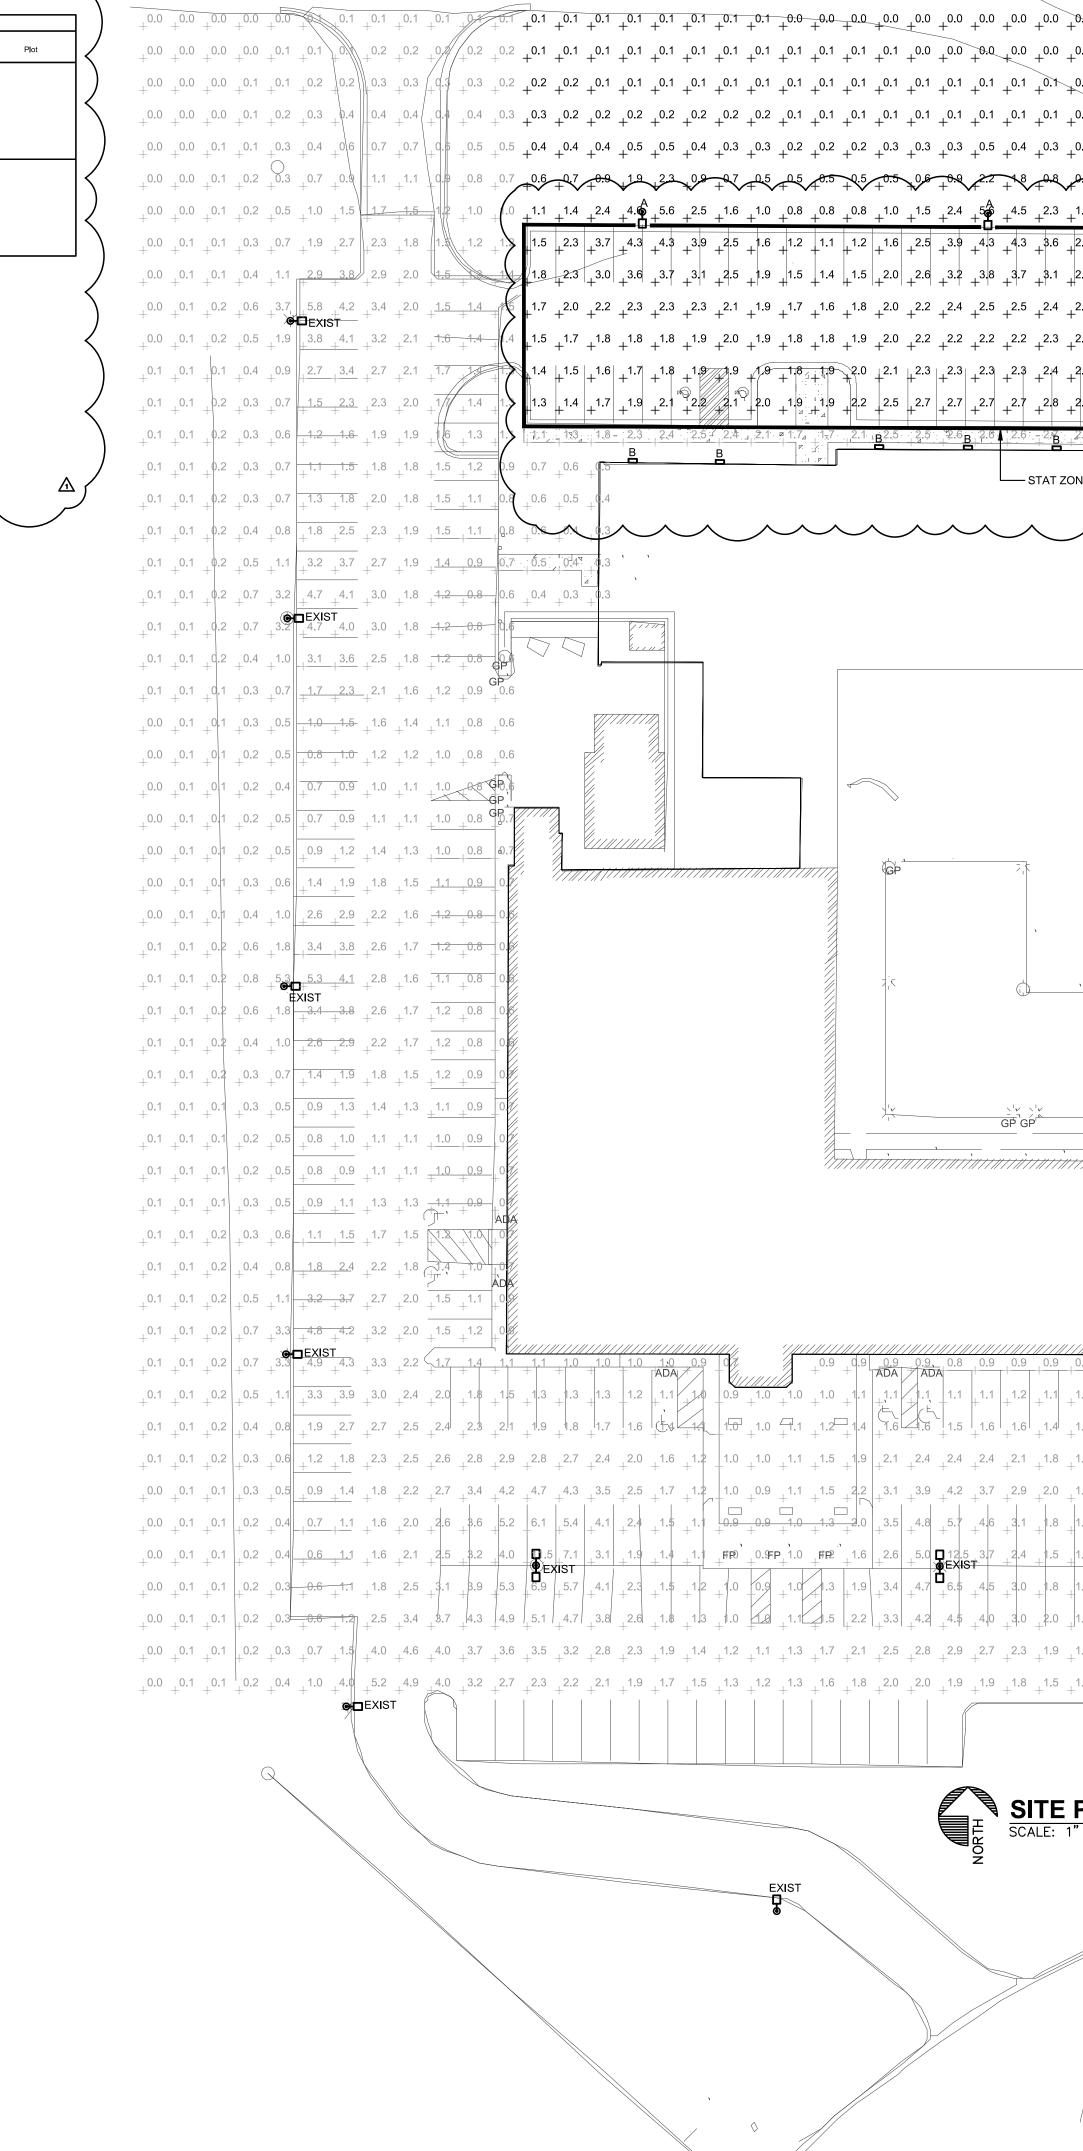

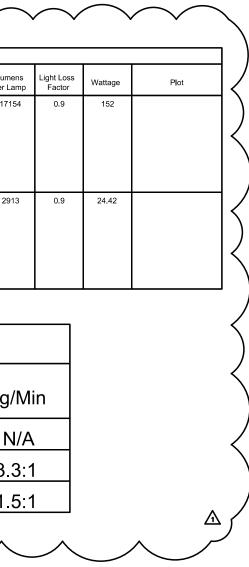

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### Meeting Sign-In Sheet

Project Name and Address:

New Guest Tower Development-Four Points by Sheraton KCI 11832 NW Plaza Cir Kansas City, MO 64153

Name	Address	Phone	Email
Kyle Kippes	14700 W 114th Terrace, Lenexa, KS 66215	913.894.5150	kippes@kveng.com
Scott Poindexter	11730 NW. Ambassador Dr. Kansas City, MO 64153	816.841.1931	spoindexter@hikciairport.com



Project Case #: CD-CPC-2023-00154

Meeting Date: 10/30/23

Meeting Location: Via Microsoft Teams

Meeting Time (include start and end time): 5:30pm-6:30pm

Additional Comments (optional):

Bell/Knot	t & Associates Architects, p.c.		MEETING NOTES
12730 State Line Road Leawood, Kansas 66209	(913) 378-1600 bellknott.com		ISSUE DATE: 10/30/2023 PROJECT NUMBER: 20-056
PROJECT NAME: PROJECT ADDRESS: DATE & TIME: REVIEWED BY:	Hulsing -KCI Hotel Expansion. 11832 NW Plaza Circle 10/30/2023 5:30 -6:30 Justin Murray, Matthew Walter		
Meeting Location:Via Teams (online) In Attendance:		Legend:	
<u>(Name)</u> Justin Muray – BKA Matthwe Walter – BKA	(Company)	(Name)	(Company)

Matthwe Walter – BKA Kyle Kippes – KVE Scott Poindexter – Holiday Inn & KC Expo Center

These notes are our account of the discussion that took place at this meeting, any errors or omissions should be reported to this office. These notes are intended as documentation of the discussion, which occurred during this meeting and are not intended as an interpretation of the contract documents. These notes are assumed to be correct unless Bell/Knott is notified in writing of any errors or discrepancies within five days of issuance of these notes.

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Neighborhood meeting for proposed hotel expansion

Review of the proposed project.

Questions and Responses:

1. What is the proposed schedule of the project?

Response: Project is proposed to begin in 1<sup>st</sup> quarter of 2024 and is expected to be completed by the end of the year.

- 2. Is the existing Structure to be renovated during the construction of the additional tower?
  - Response: the renovation of the existing building has not been determined yet.
- 3. Will both the outdoor pool remain with the addition of the indoor pool.

Response: Yes, both the existing outdoor pool and the new indoor pool are to be maintained.

4. Will Courtyard be enclosed?

Response: Yes, the yard will be enclosed. The are to be provisional to get morer and other landscape equipment to the center yard areas for maintenance.

5. Will meeting space be added to the new tower?

Response: No additional meeting space is planned.

#### END OF MEETING NOTES