

### CITY PLAN COMMISSION STAFF REPORT

City of Kansas City, Missouri
City Planning & Development Department
<a href="https://www.kcmo.gov/cpc">www.kcmo.gov/cpc</a>

June 5, 2024

### **Project Name**

Cookingham Development – Expansion

### Docket#

- 9.1 Area Plan Amendment
- 9.2 Rezoning without Plan
- 9.3 Development Plan Non-Residential

### Request

CD-CPC-2024-00030 Rezoning without Plan CD-CPC-2024-00031 Area Plan Amendment CD-CPC-2024-00032

Development Plan – Non-Residential

### **Applicant**

Aaron March Rouse Frets White Goss, PC

### Owner

Cookingham LLC & Dillingham Enterprises Inc

Location 2001 NW Cookingham Dr

Area About 59 Acres Zoning M2-3 & AG-R

Council District 1st County Platte

School District Platte County R-III

### **Surrounding Land Uses**

**North:** Undeveloped, zoned MPD **South:** Interstate 435, zoned AG-R **East:** Interstate 435, zoned AG-R **West:** Undeveloped, zoned M2-3

### **KC Spirit Playbook Alignment**

N/A

### **Land Use Plan**

The KCI Area Plan recommends open space/buffer and mixed use community for this location.

### **Major Street Plan**

NW Cookingham Drive is identified as a thoroughfare on the City's Major Street Plan.

### APPROVAL PROCESS



### **PROJECT TIMELINE**

The application for the subject request was filed on 3/15/2024. Scheduling deviations from 2024 Cycle 5.1 have occurred due to technology issues at City Hall.

### REQUIRED PUBLIC ENGAGEMENT

Public engagement as required by 88-505-12 does apply to this request. The applicant hosted a meeting on 4/16/2024. A summary of the meeting is attached to the staff report, see Attachment #3.

### **EXISTING CONDITIONS**

The 59-acre site is undeveloped, generally flat and has a regulated stream that runs on along the eastern and southern perimeters of the site.

### **SUMMARY OF REQUEST + KEY POINTS**

**CD-CPC-2024-00030** - A request to rezone about 59 acres from zoning district AG-R to district M2-3 generally located at Interstate 435 and NW Cookingham Drive.

**CD-CPC-2024-00031**- A request to approve an area plan amendment to the KCIA Area Plan from Mixed Use Community to Commercial/Industrial on about 59 acres generally located at Interstate 435 and NW Cookingham Drive.

**CD-CPC-2024-00032** - A request to approve a non-residential development plan to allow for Communications Service Establishments in districts in the proposed M2-3 zoning district on about 59 acres generally located at Interstate 435 and NW Cookingham Drive.

### **CONTROLLING + RELATED CASES**

CD-CPC-2023-00138, CD-CPC-2023-00139 and CD-CPC-2023-0140 were approved by the City Council on November 30, 2023 to allow for a speculative data center development (Ordinance No. 230979).

### PROFESSIONAL STAFF RECOMMENDATION

Docket # Recommendation

8.1 APPROVAL APPROVAL

13 APPROVAL WITH CONDITIONS

### **PLAN REVIEW & ANALYSIS**

The applicant is expanding a previously approved development plan to allow for a speculative data center (communication service establishment). The proposed expansion will consist of an additional 30 acres east of the previously approved site. The 30 acres are undeveloped, currently zoned for agricultural uses, adjacent to Interstate 435 and generally flat. The applicant will be removing over nine (9) acres of trees but is not required to provide any tree mitigation due to the existing stream buffer that runs along the eastern and southern perimeter of the site. The applicant is also seeking a deviation of 10' to allow for 70' tall structures to be constructed on the site. City staff assigned MoDOT a review due to the proximity of the site to Interstate 435. Also, the City and MoDOT have a cooperative maintenance agreement for NW Cookingham Drive and City staff is awaiting feedback from MoDOT to make sure they approve of the proposed use and possible traffic generation.

### \*indicates adjustment/deviation

Standards	Applicability	Meets	More Information
Lot and Building Standards (88-140)*	Yes	No	The applicant is seeking a deviation to allow for building heights up to 70' which exceed the allowable height by 10'.
Tree Preservation and Protection (88-424)	Yes	Yes	The applicant is exempt due to the existing stream buffer.
Parking and Loading Standards (88-420)	Yes	Yes	
Landscape and Screening Standards (88-425)	Yes	Yes, subject to conditions	
Outdoor Lighting Standards (88-430)	Yes	Yes, subject to conditions	
Sign Standards (88-445)	Yes	Yes, subject to conditions	
Pedestrian Standards (88-450)	Yes	Yes, subject to conditions	

### SPECIFIC REVIEW CRITERIA

### Zoning and Development Code Map Amendments, Rezonings (88-515-08)

In reviewing and making decisions on proposed zoning map amendments, the City Planning and Development Director, City Plan Commission, and City Council must consider at least the following factors:

### A. Conformance with adopted plans and planning policies;

The proposed development does require an area plan amendment to the KCI area plan but the use is generally permitted when north of Interstate 435 within this quadrant of the City.

### B. Zoning and use of nearby property;

The immediate area is generally zoned AG-R and undeveloped.

### C. Physical character of the area in which the subject property is located;

The area is undeveloped and adjacent to Interstate 435.

### D. Whether public facilities (infrastructure) and services will be adequate to serve development allowed by the requested zoning map amendment;

The applicant is continuing to coordinate with KC Water related to public infrastructure serving the site.

### E. Suitability of the subject property for the use to which it has been restricted under the existing zoning regulations;

The proposed site is adjacent to Interstate 435 and if properly screened from the public right-of-way the proposed zoning will be suitable for the proposed use.

### F. Length of time the subject property has remained vacant as zoned;

The proposed site is undeveloped.

### G. The extent to which approving the rezoning will detrimentally affect nearby properties; and

The proposed site is adjacent to Interstate 435 and if well screened from the public right-of-way and adjacent properties it should not detrimentally affect nearby properties.

H. The gain, if any, to the public health, safety, and welfare due to denial of the application, as compared to the hardship imposed upon the landowner, if any, as a result of denial of the application.

The proposed use would not be permitted without rezoning the property from AG-R to M2-3.

### Development Plans, Project Plan, or Site Plan (88-516-05)

In order to be approved, a development plan, project plan, or site plan must comply with all of the following criteria:

### A. The plan must comply with all standards of the Zoning and Development Code and all other applicable city ordinances and policies;

The applicant has outstanding corrections from KC Water and KCPD and no ordinance request can be submitted until the corrections are resolved. The applicant is also seeking a 10' height deviation from the lot and building standards of the Zoning and Development Code to construct 70' tall structures.

### B. The proposed use must be allowed in the district in which it is located;

The western side of the project area currently allows for communication service establishments, the applicant has acquired additional property since the original plan was approved in 2023 and is now expanding the use to the east. The eastern portion of the site is zoned AG-R (Agricultural – Residential) and will be rezoned to M2-3 (manufacturing) to allow for the proposed use.

- C. Vehicular ingress and egress to and from the site, and circulation within the site must provide for safe, efficient, and convenient movement of traffic not only within the site but on adjacent roadways;
  City staff is waiting for MoDOT to complete their review related to amount curb cuts proposed. MoDOT and the City of Kansas City have a shared maintenance agreement for NW Cookingham Drive. Staff has encouraged the developer to have one primary entrance and a second entrance that can only be used by emergency personnel.
- D. The plan must provide for safe, efficient, and convenient non-motorized travel opportunities, being pedestrian and bicycle movement, on the subject site;

The proposed use on the site, a data center (communication service establishment), does not generate much pedestrian or bicycle activities. The plan does comply with the Pedestrian Standards (88-450) of the Zoning and Development Code.

E. The plan must provide for adequate utilities based on City standards for the particular development proposed.

The applicant has outstanding corrections from KC Water that shall be resolved prior to ordinance request.

- F. The location, orientation, and architectural features, including design and material, of buildings and other structures on the site must be designed to be compatible with adjacent properties.
  - The proposed architectural features and design are high quality and are compatible with the site's immediate adjacency to Interstate 435.
- G. Landscaping, berms, fences, and/or walls must be provided to buffer the site from undesirable views, noises, lighting, or other off-site negative influences and to buffer adjacent properties from negative influences that may be created by the plan.

The applicant did provide a landscape plan that complies with Code and will provide a strong visual buffer along NW Cookingham Drive.

H. The design of streets, drives, and parking areas within the project should result in a minimum of area devoted to asphalt or other impervious surfaces consistent with the needs of the project and city code requirements.

The applicant has stated this is a speculative project which means that the proposed amount of impervious surfaces could change depending on who the end user is.

 The plan must identify trees to be removed and trees to be preserved during the development of the subject property with the goal of saving trees that are not required to be removed for the development of the property.

The applicant provided a tree preservation and removal plan. The applicant is proposing to remove over 9 acres of trees for the speculative development. No mitigation is required due to the existing stream buffer.

### **ATTACHMENTS**

- 1. Conditions Report
- 2. Applicants Submittal
- 3. Public Engagement Materials

### **PROFESSIONAL STAFF RECOMMENDATION**

City staff recommends the following:

CD-CPC-2024-00030 - Rezoning without Plan APPROVAL

CD-CPC-2024-00031 - Area Plan Amendment APPROVAL

CD-CPC-2024-00032 - Development Plan - Non-Residential APPROVAL WITH CONDITIONS

Respectfully Submitted,

Andrew Clarke, AICP

Adu Chike

Planner

## KANSAS CITY Planning & Dev

### **Plan Conditions**

Report Date: May 29, 2024

Case Number: CD-CPC-2024-00032

Project: Cookingham Development - Expansion

Condition(s) by City Planning and Development Department. Contact Andrew Clarke at (816) 513-8821 / Andrew.Clarke@kcmo.org with questions.

- 1. The developer shall submit an affidavit, completed by an ISA certified arborist, an SAF certified forester, a professional engineer, or a landscape architect licensed in the State of Missouri, verifying that all trees preserved and all trees planted to meet mitigation required of the approved plan, whichever is applicable, has been installed or preserved in accordance with the plan and is healthy prior to Certificate of Occupancy.
- 2. The developer shall be responsible for tree preservation in an easement or platted tract, mitigation planting, or payment of cash-in-lieu of preservation or mitigation planting, or any combination thereof in accordance with 88-424. Should the developer choose to pay cash-in-lieu of preservation or mitigation of all or a portion of the required area, the amount due shall be based upon the rate specified in 88-424. This requirement shall be satisfied prior to certificate of occupancy.
- 3. The developer shall screen all roof and/or ground mounted mechanical and utility equipment in compliance with 88-425-08.
- 4. The developer shall submit an affidavit, prepared by an engineer licensed in the State of Missouri, verifying that all outdoor lighting has been installed in accordance with approved plans and that lighting levels do not exceed that shown on the approved lighting plan at the property lines prior to Certificate of Occupancy.
- 5. The developer shall submit an affidavit, completed by a landscape architect licensed in the State of Missouri, verifying that all landscaping required of the approved plan has been installed in accordance with the plan and is healthy prior to Certificate of Occupancy.
- 6. The developer shall submit an affidavit, completed by a landscape architect licensed in the State of Missouri, verifying that street trees have been installed in accordance with the approved street tree planting plan and are healthy prior to Certificate of Occupancy.
- 7. The developer shall secure approval of a project plan from the City Plan Commission prior to building permit.
- 8. All signage shall conform to 88-445 and shall require a sign permit prior to installation.
- 9. The Council shall grant a deviation to 88-140-04 allowing for a maximum height of 70'.
- The applicant shall resolve all KC Water and KCPD corrections prior to ordinance request.
- 11. The developer shall submit a phasing plan to the Development Management Division prior to ordinance request.

Condition(s) by City Planning and Development Department. Contact Matthew Barnes at (816) 513-8817 / matthew.barnes@kcmo.org with questions.

- 12. That prior to any Certificate of Occupancy is issued for each phase, a Final Plat must be approved by the City and recorded with the County Recorder of Deeds.
- 13. That the applicant must submit, gain approval from the City, and record a Final Plat for each phase prior to any certificate of occupancy being issued.

Condition(s) by City Planning and Development Department. Contact Terry Thomas at (816) 513-2510 / Terry.A.Thomas@kcmo.org with questions.

14.	The developer shall grant a BMP and/or Surface Drainage Easement to the City as required by the Land Development
	Division, prior to recording the plat or issuance of any building permits.

15.	The developer shall dedicate additional right of way [and provide easements] for	as required by the adopted
	[Major Street Plan and/or Chapter 88] so as to provide a minimum of feet of right of way as	measured from the
	centerline, along those areas being platted.	

Condition(s) by City Planning and Development Department. Contact Terry Thomas at (816) 513-2510 / Terry.A.Thomas@kcmo.org with questions.

- 16. The developer shall submit plans for grading, siltation, and erosion control to Land Development Division for review and acceptance, provide a copy of the Storm Water Pollution Prevention (SWPP) plan submitted to the Missouri Dept. of Natural Resources (MDNR) and secure a Site Disturbance permit for any proposed disturbance area equal to one acre or more prior to beginning any construction activities.
- 17. The developer shall submit construction plans in compliance with adopted standards for all improvements required by the traffic study approved by the Public Works Department, and shall secure permits for those improvements as required by the Land Development Division, prior to recording the plat.
- 18. The developer shall submit verification of vertical and horizontal sight distance for the drive connection to public right-of-way to the Land Development Division and make improvements to ensure local jurisdiction and/or minimum AASHTO adequate sight distance standards are met, prior to issuance of any certificate of occupancy.
- 19. The developer shall pay impact fees as required by Chapter 39 of the City's Code of ordinances as required by the Land Development Division.
- 20. The developer shall cause the area to be platted and processed in accordance with Chapter 88, Code of Ordinances of the City of Kansas City, Missouri.
- 21. The developer shall submit a streetscape plan for approval and permitting by the Land Development Division prior to beginning construction of the streetscape improvements in the public right of way, and construct ADA compliant ramps at all required locations where new private drives are being added, or where existing sidewalks are modified or repaired.
- 22. The developer shall enter into a covenant agreement for the maintenance of any stormwater detention area tracts as required by the Land Development Division, prior to recording the plat.
- 23. The developer shall submit a Macro storm drainage study with the first Plat or Phase, from a Missouri-licensed civil engineer to the Land Development Division showing compliance with current adopted standards in effect at the time of submission, including Water Quality BMP's, to the Land Development Division for review and acceptance for the entire development area, and submit Micro storm drainage study with each subsequent Plat or Phase showing compliance with the approved Macro and adopted standards. The developer shall secure permits to construct any improvements as necessary to mitigate impacts from rate, volume, and quality of runoff from each proposed phase, prior to recording the plat or prior to issuance of a Building Permit, whichever occurs first as required by the Land Development Division.
- 24. The developer shall secure permits to extend public sanitary and storm water conveyance systems to serve all proposed lots within the development and determine adequacy of receiving systems as required by the Land Development Division, prior to recording the plat or issuance of a building permit whichever occurs first.

Condition(s) by Fire Department. Contact Michael Schroeder at (816) 513-4604 / michael.schroeder@kcmo.org with questions.

- 25. The developer shall meet the fire flow requirements as set forth in Appendix B of the project International Fire Code 2018. (IFC-2018 § 507.1)
- 26. Buildings equipped with a fire standpipe system shall have an operable fire hydrant within 100 feet of the Fire Department Connection (FDC). (IFC2018 § 507.5.1.1)
- 27. Fire hydrants shall be installed and operable prior to the arrival of any combustible building materials onto the site. (IFC-2018 § 501.4 and 3312.1; NFPA 241-2013 § 8.7.2)
  - Fire hydrant distribution shall follow IFC-2018 Table C102.1
- 28. Aerial Fire Apparatus access roads shall be provided for any building that is 30 feet in height or greater. Aerial Fire Apparatus Roads are a minimum 26 feet wide, at least 15 feet away from the building but not more than 30 feet from the structure. (IFC-2018 § D105).
  - Buildings exceeding three (3) stories or 30 feet in height shall have at least two means of fire apparatus access. (IFC-2018: § D104.1)
- 29. Security gates which span across a fire access road shall provide a means for emergency operation. Electric gates shall require a siren sensor device typically referred to as a "yelp gate" (IFC-2018 § 503.6).

Condition(s) by Fire Department. Contact Michael Schroeder at (816) 513-4604 / michael.schroeder@kcmo.org with questions.

- 30. A required fire department access roads shall be an all weather surface. (IFC-2012: § 503.2.3)
  - Fire Department access roads shall be provided prior to construction/demolition projects begin. (IFC-2018 § 501.4 and 3310.1; NFPA 241-2013 § 7.5.5)
  - Required fire department access roads shall designed to support a fire apparatus with gross axle weight of 85,000 pounds. (IFC-2018: § 503.2.3)
  - The turning radius for fire department access roads shall be 30 feet inside and 50 feet outside radius. (IFC-2018: § 503.2.4)
  - Shall provide fire lane signage on fire access drives.
- 31. New buildings shall have approved radio coverage for emergency responders within the building based on the existing coverage levels of the public safety communication systems utilized by the jurisdiction, measured at the exterior of the building. This section shall not require improvement of the existing public safety communication systems. (IFC 2018 510.1) and (NFPA1221)

Condition(s) by Water Services Department. Contact Heather Massey at (816) 513-2111 / heather.massey@kcmo.org with questions.

- 32. Water/Sewer Service lines shall serve only one lot or tract and shall not cross a separate lot or tract.
- 33. No water service tap permits will be issued until the public water main is released for taps.
- 34. The developer shall ensure that water and fire service lines should meet current Water Services Department Rules and Regulations. Prior to C of O. https://www.kcwater.us/wp-content/uploads/2022/05/2022-Rules-and-Regulations-for-Water-Service-Lines-Final.pdf
- 35. A full flow fire meter shall be required when the fire protection service line serves more than one building, or combination service lines 6 inches and larger, or that have private fire hydrants connected to them.

Condition(s) by Water Services Department. Contact Kirk Rome at (816) 513-0368 / kirk.rome@kcmo.org with questions.

36. Relocations and additions to the public water distribution system and public fire hydrants shall follow the KC Water Rules and Regulations for Water Main Extensions. Developer shall submit water main extension plans for review, approval, contracting, and construction of the proposed water distribution improvements prior to building permit issuance.

Condition(s) by Water Services Department. Contact Lucas Kaspar at (816) 513-2131 / Lucas.Kaspar@kcmo.org with questions.


- 37. The developer must grant BMP and Surface Drainage Easements to the City, prior to recording the plat or issuance of any building permits.
- 38. The developer shall submit a final stream buffer plan for approval prior to issuance of any building permits and obtain permits for the Stream Buffer prior to removal of any mature riparian species within the buffer zones due to construction activities on the site, in accordance with the Section 88-415 requirements.
- 39. The developer must secure permits to extend public sanitary and storm water conveyance systems to serve all proposed lots within the development and determine adequacy of receiving systems, prior to recording the plat or issuance of a building permit whichever occurs first.
- 40. The developer must obtain a floodplain certificate from Development Services prior to beginning any construction activities with the floodplain.
- 41. The developer must show the limits of the 100-year floodplain on the final plat and show the Minimum Low Opening Elevation (MLOE) of any structure on each lot that abuts a 100-year flood prone area (including detention basins and engineered surface drainage conveyances) on any plat and plan.
- 42. The developer shall submit a Preliminary Stream Buffer plan prior to approval of the plan in accordance with the Section 88-415 requirements.
- 43. The developer must grant on City approved forms, a STREAM BUFFER Easement to the City, as required by Chapter 88, prior to issuance of any stream buffer permits.

Condition(s) by Water Services Department. Contact Lucas Kaspar at (816) 513-2131 / Lucas.Kaspar@kcmo.org with questions.

44. The developer must enter into a covenant agreement for the maintenance of any storm water detention area tracts, prior to recording the plat.

# PRELIMINARY DEVELOPMENT PLAN & PRELIMINARY PLAT FOR COOKINGHAM DEVELOPMENT

Part of the NW & NE 1/4
Section 21-Township 52S-Range 33E
in the
City of Kansas City
Platte County, Missouri

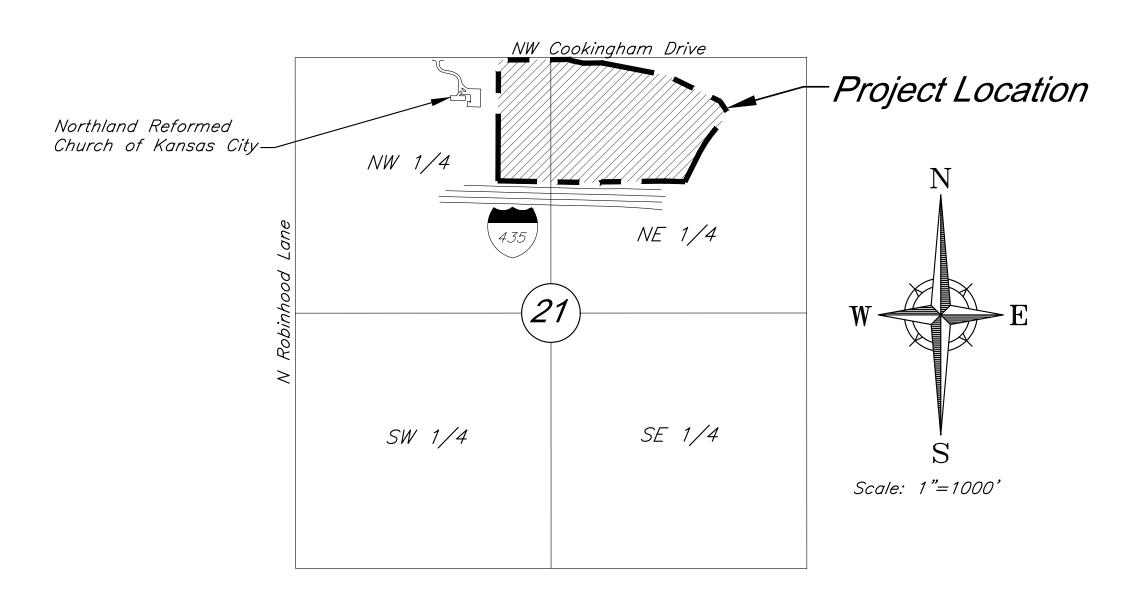

### VICINITY MAP Part of the NW & NE 1/4 Section 21-Township 52-Range 33

Sht. No.	Description
1	Title Sheet
2	General Layout
<i>3-4</i>	Site Plan
<i>5</i>	Landscape Plan
6	Street Tree Plan
7	Planting Details
<i>8-9</i>	Grading Plan
10-11	Utility Plan
<i>12</i>	Tree Removal & Tree Preservation Plan
<i>13</i>	Preliminary Plat
14	Stream Buffer Plan
E1.1	Lighting Plan
<i>E1.2</i>	Lighting Plan
A4.1 - Color	Partial Building Elevations
A4.2 - Color	Partial Building Elevations

Partial Building Elevations

**INDEX OF SHEETS** 

A4.3 - Color

PREPARED FOR:
GBA REALTY LLC
9801 RENNER BOULEVARD
LENEXA, KANSAS 66219
PHONE: 816-876-3893
CONTACT: GRAHAM JONES LEED AP
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PREPARED BY:
GEORGE BUTLER ASSOCIATES, INC.
9801 RENNER BOULEVARD
LENEXA, KANSAS 66219
PHONE: 913-492-0400
CONTACT: CLINT LOUMASTER P.E.
EMAIL: cloumaster@gbateam.com

### FLOODPLAIN:

According to the Flood Insurance Rate Maps (FIRMs) for the city of Kansas City, Missouri (29095C0061G, dated January 20th, 2017), the site is situated mainly within Zone X, areas determined to be outside the 0.2% annual chance floodplain. A channel on the site contains Zone AE, special flood hazard areas.

### **DEVIATIONS REQUESTED:**

1. A deviation is requested to allow facilities up to 70 feet in height on each of the proposed


PROJECT ENGINEER: CLINT LOUMASTER, P.E. DATE:


APPROVED BY:


MANAGER, ENGINEERING SERVICES DIVISION: DATE:




9801 Renner Boulevard Lenexa, Kansas 66219 9 1 3 . 4 9 2 . 0 4 0 0 www.gbateam.com

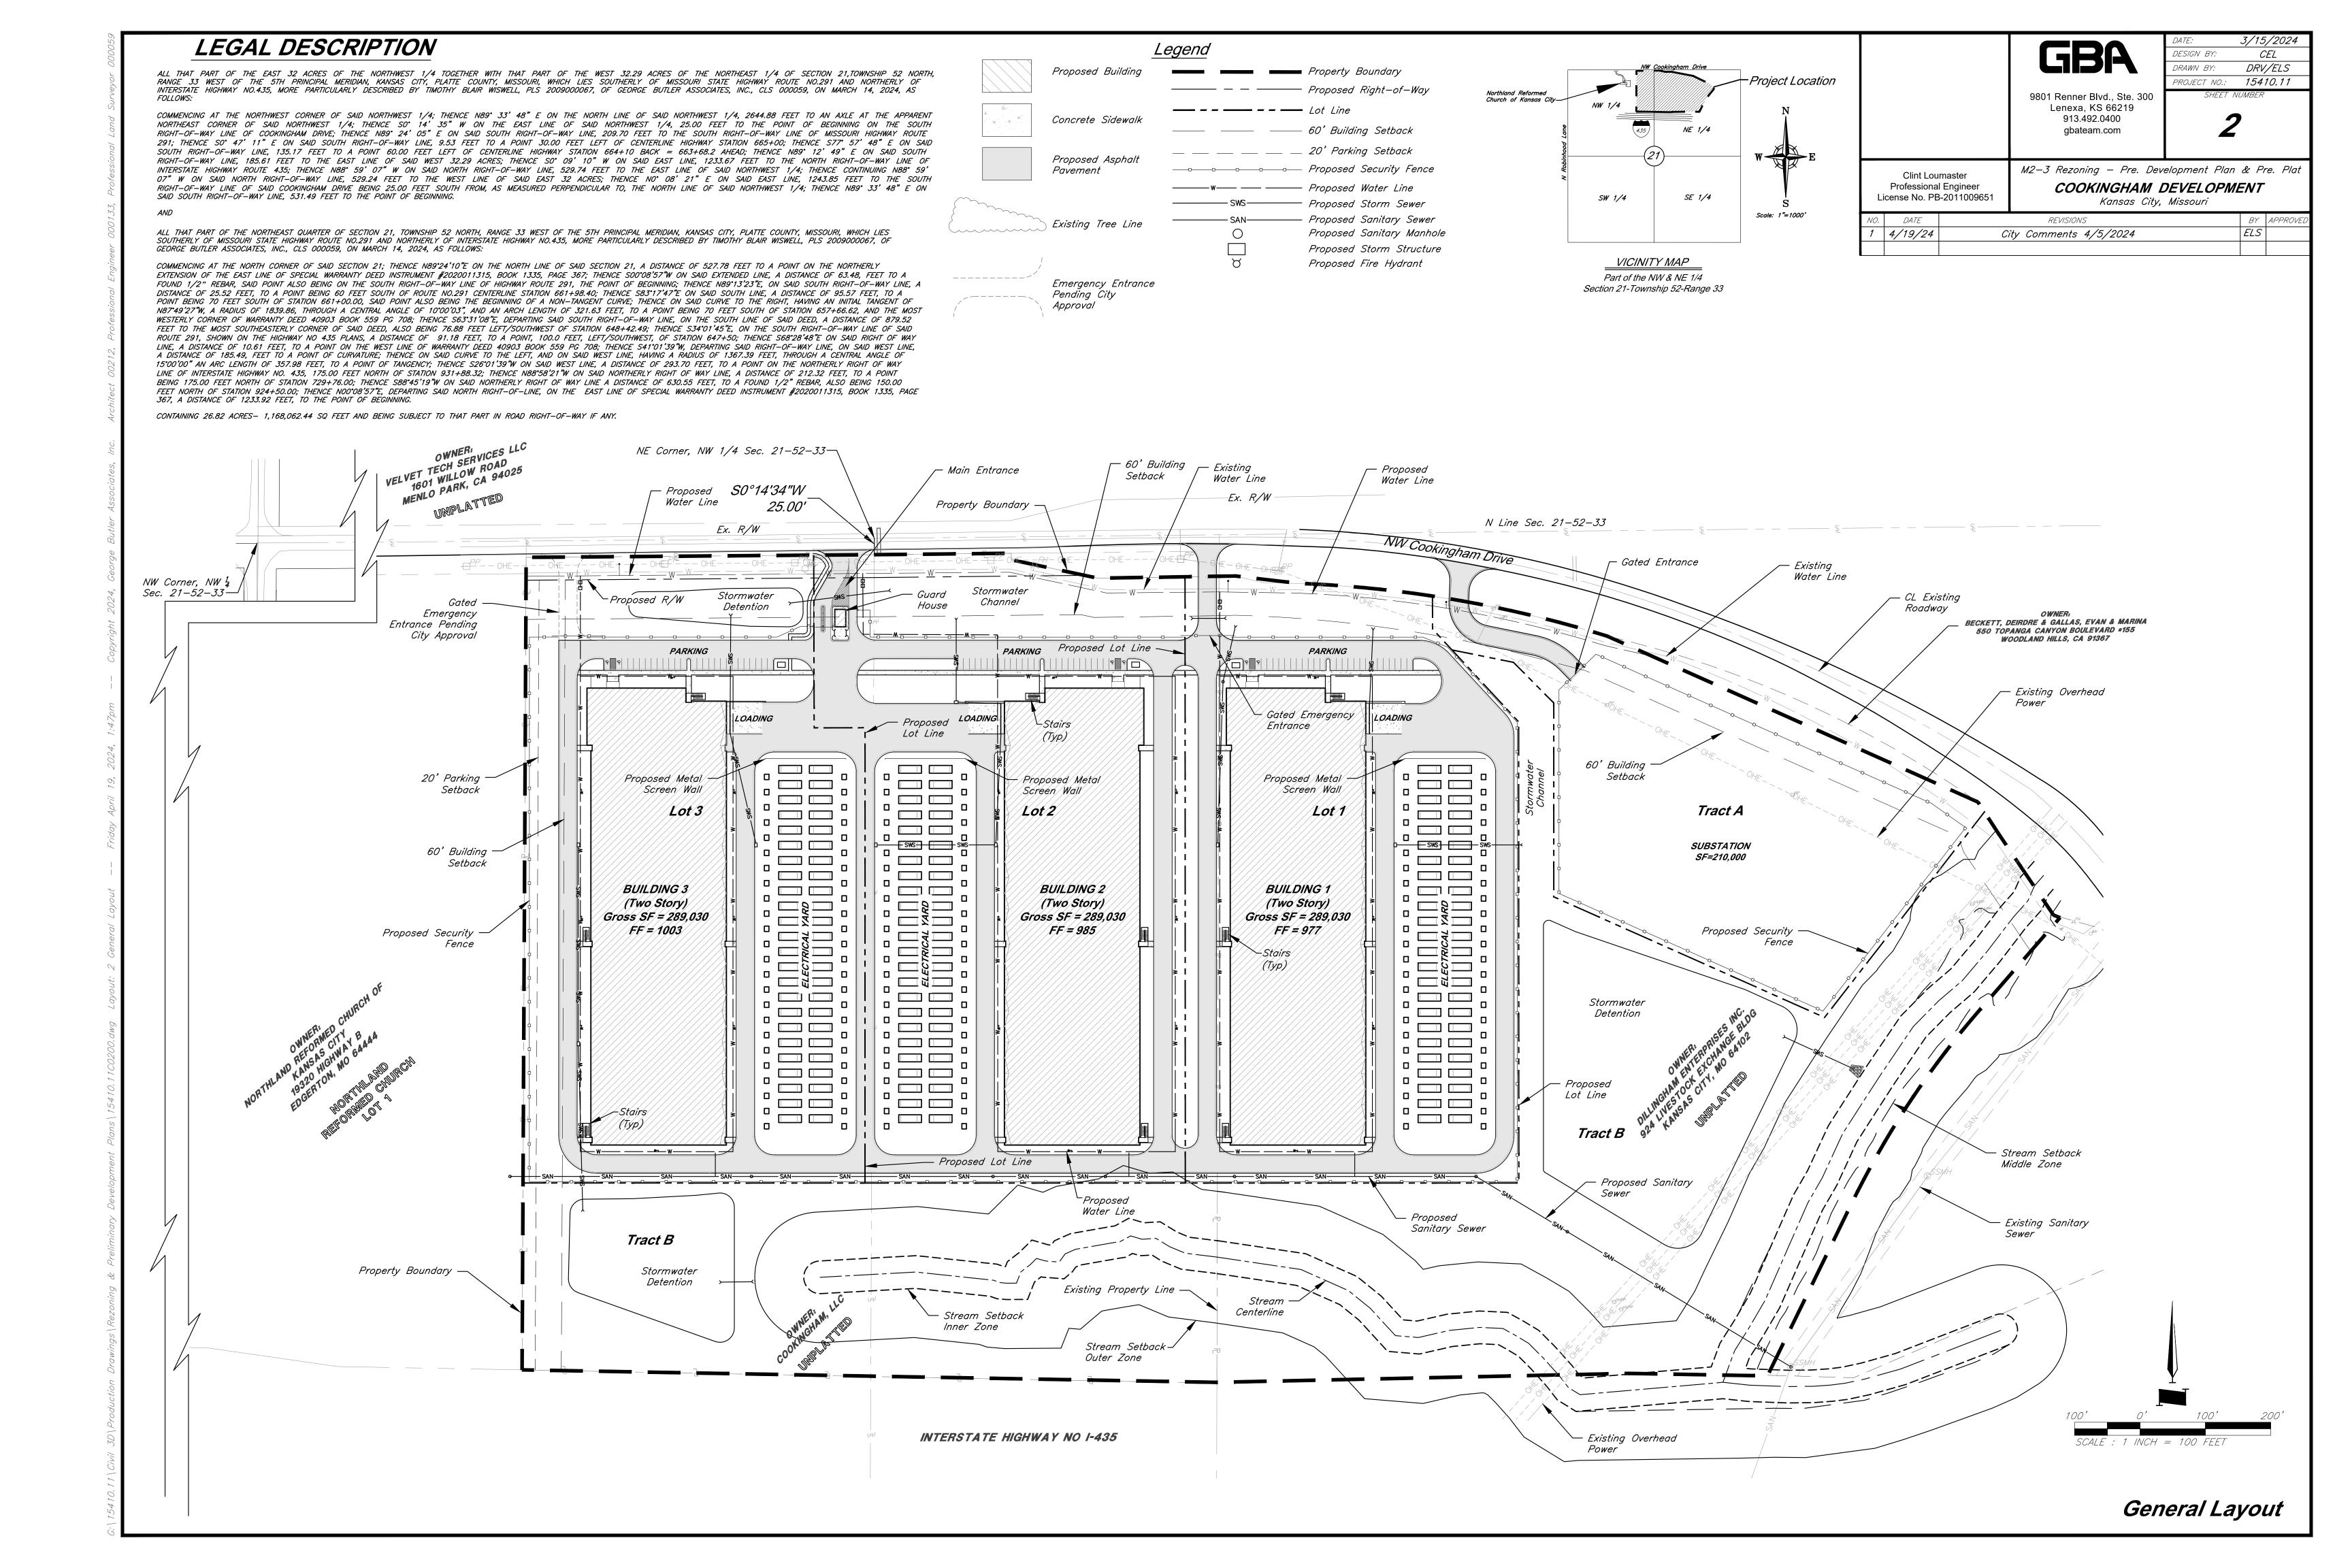

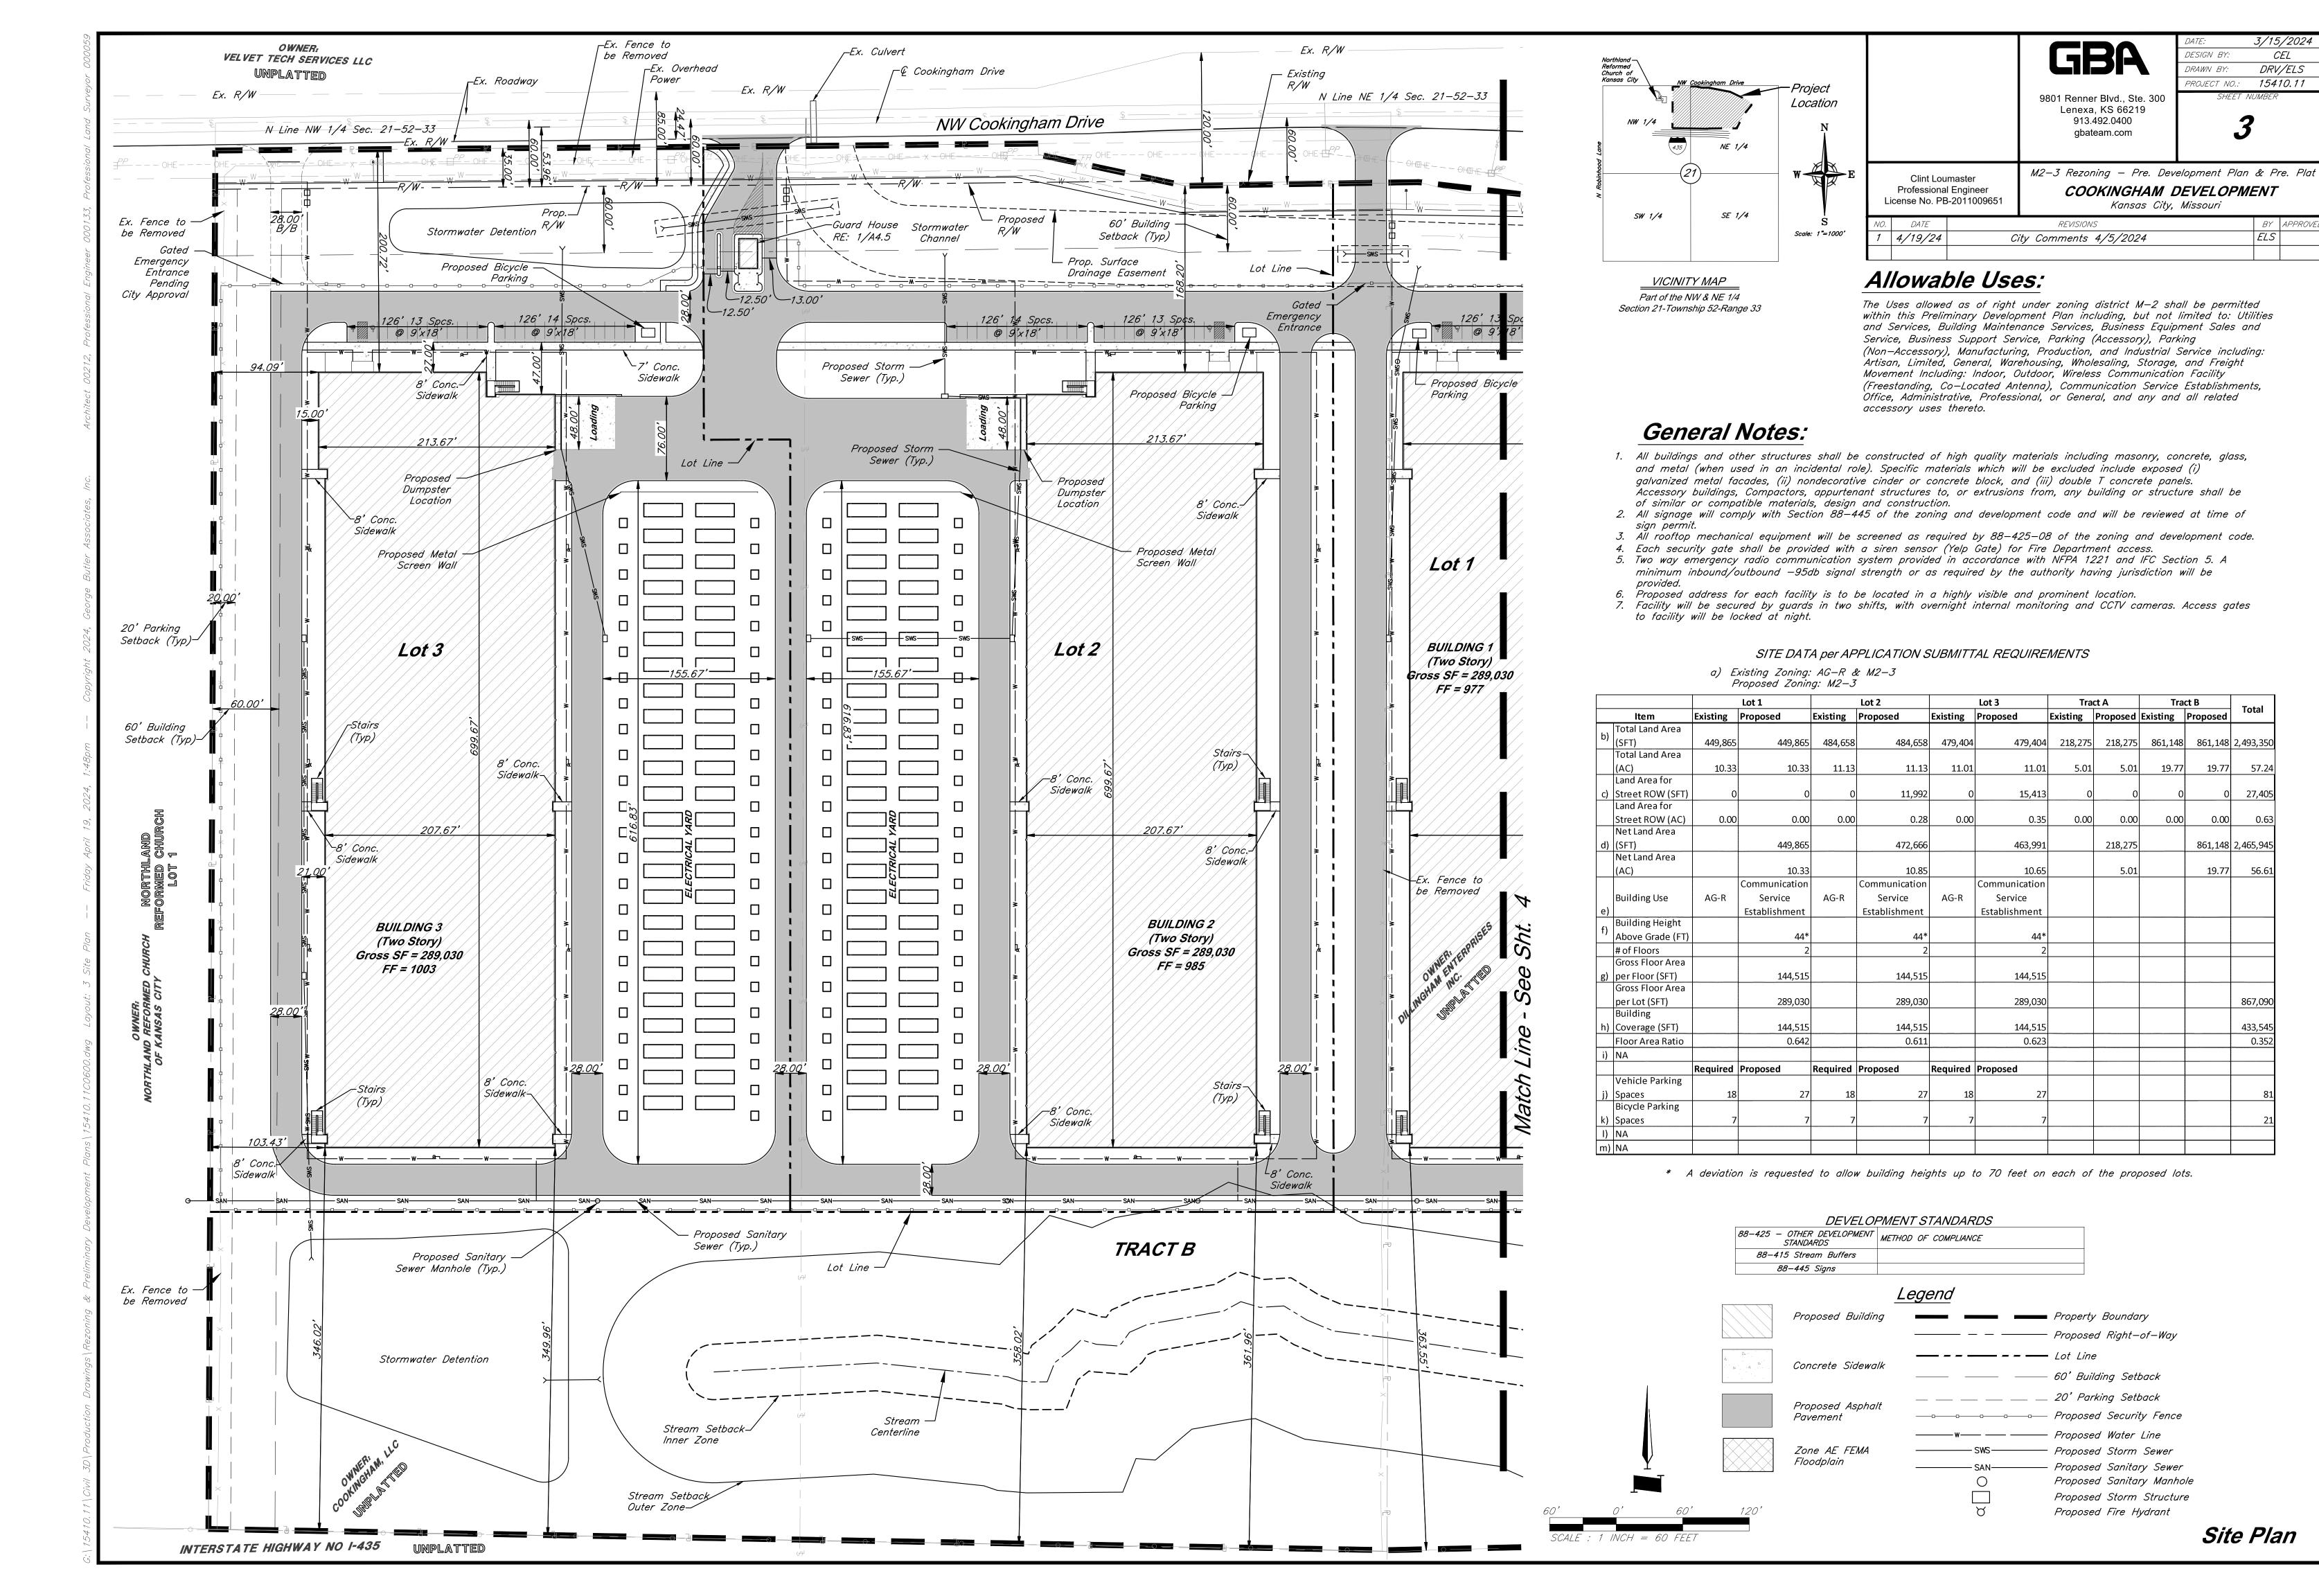

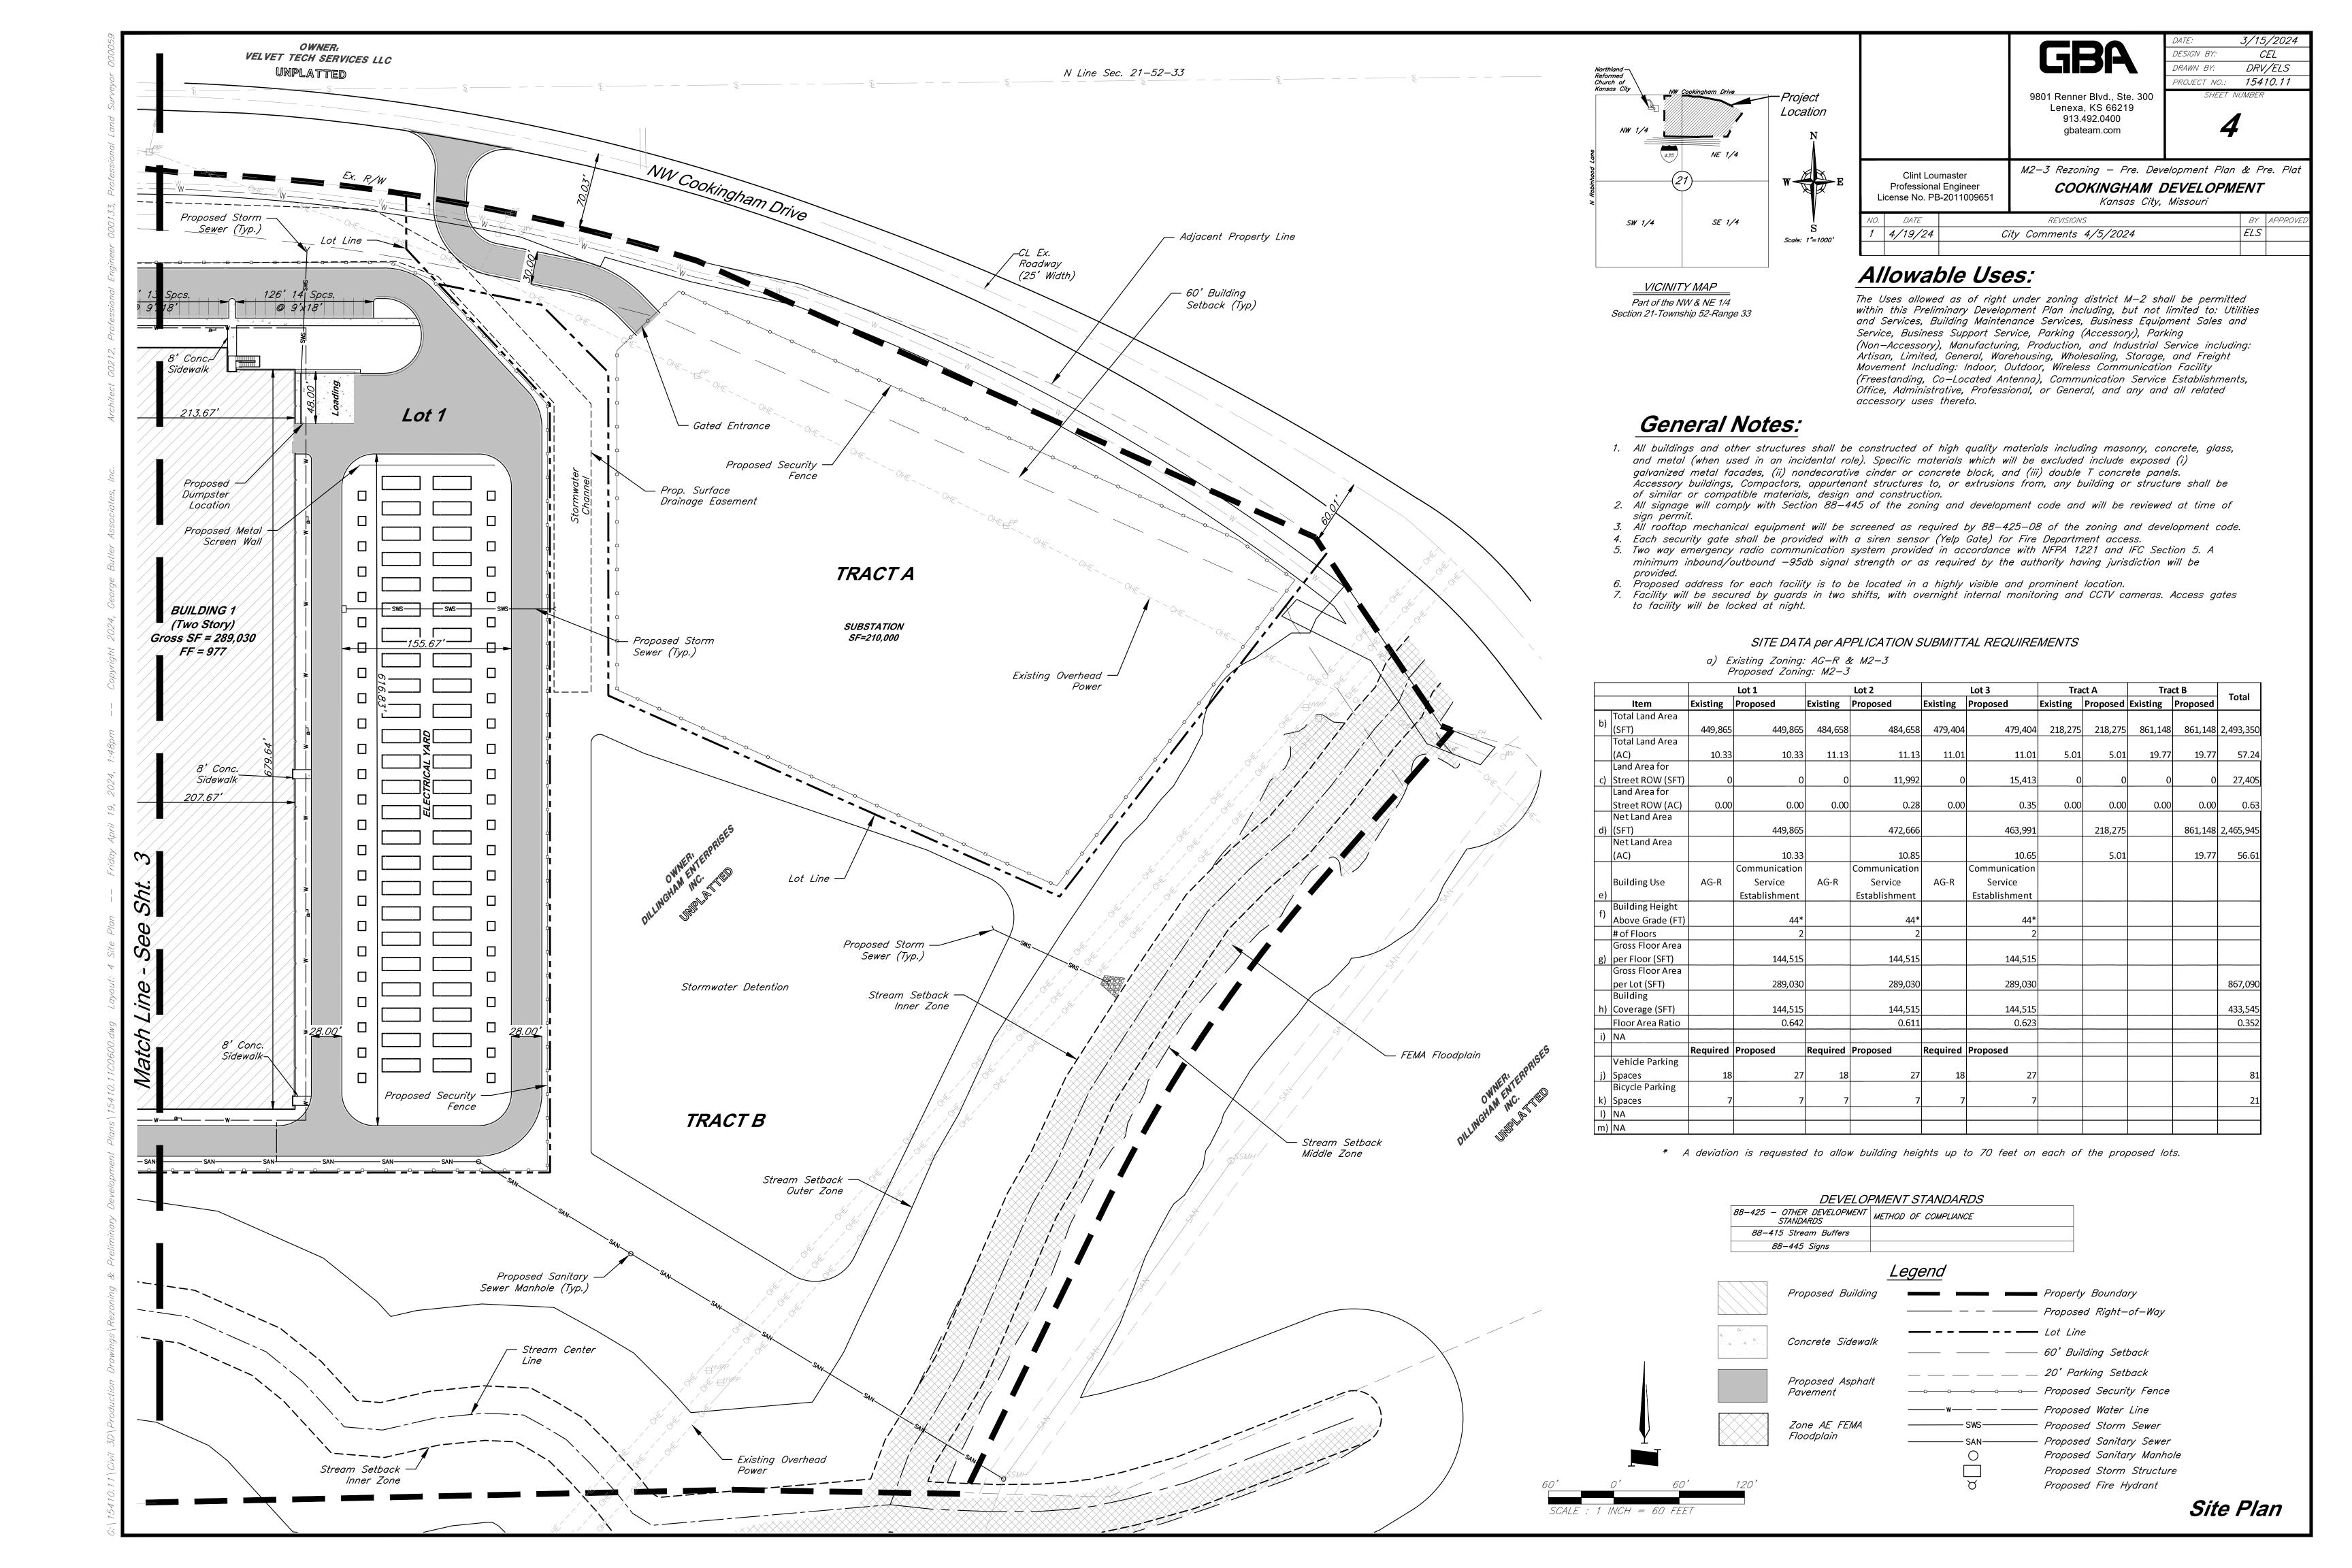

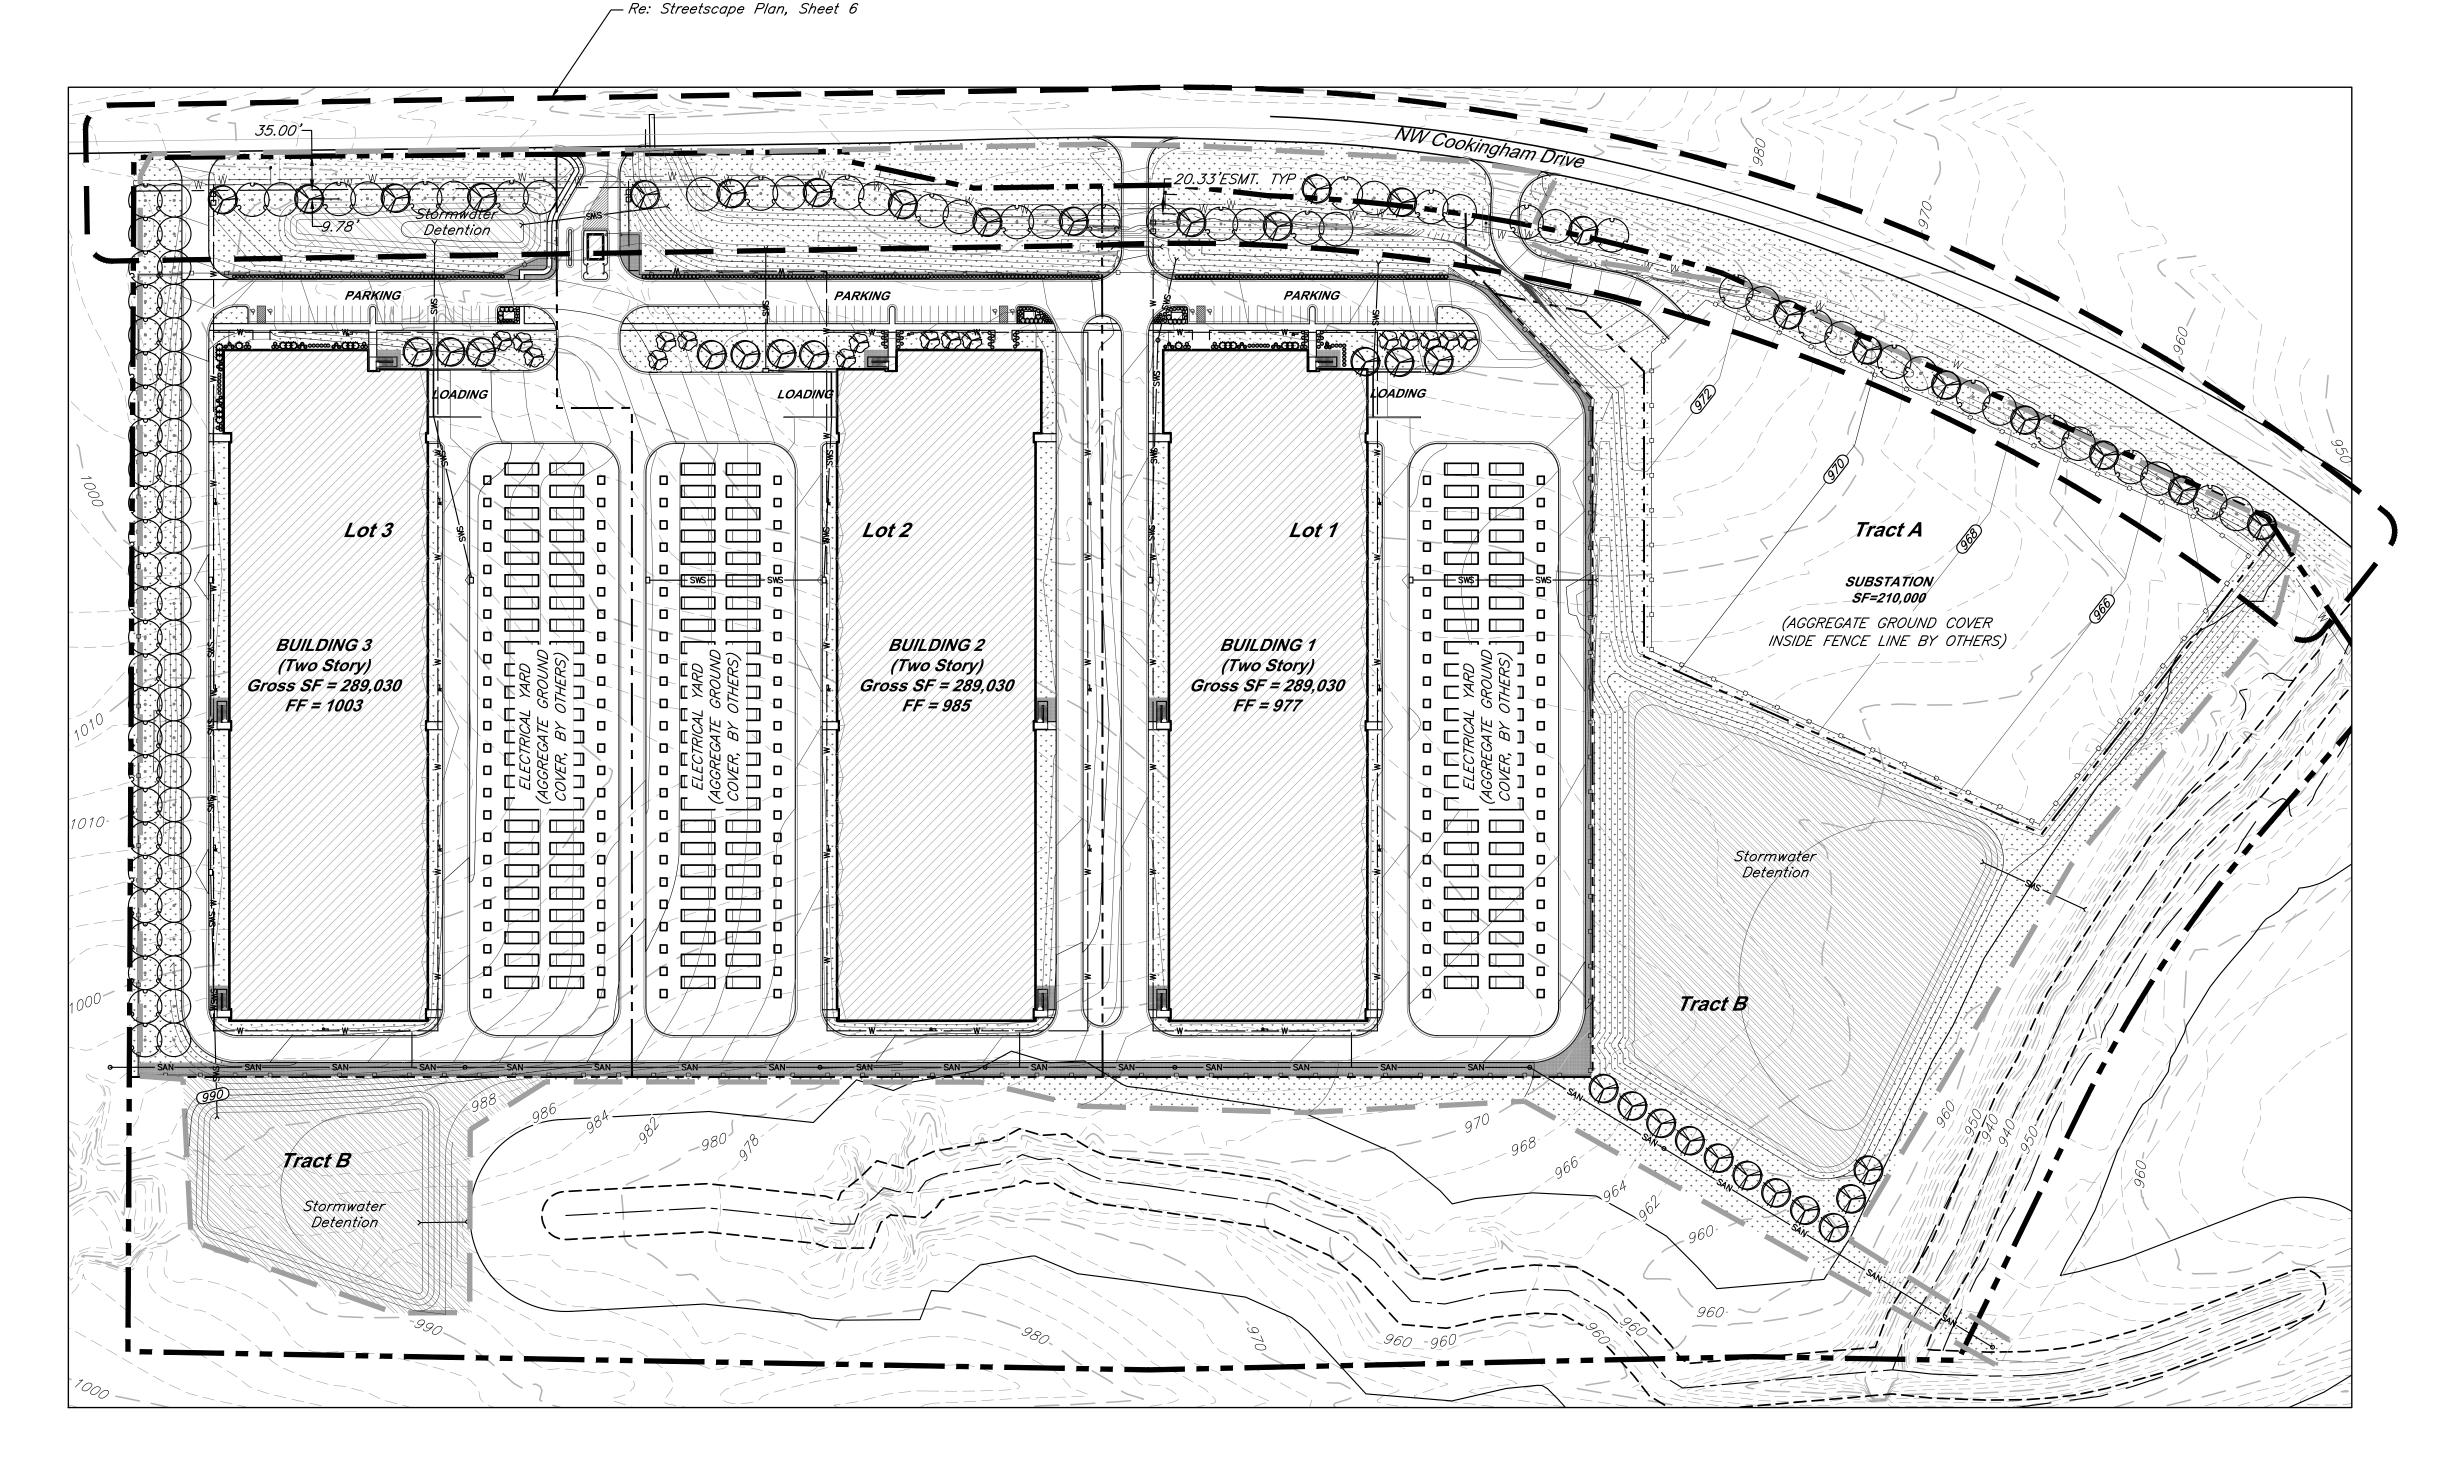

GBA
9801 Renner Blvd., Ste Lenexa, KS 6621

913.492.0400 gbateam.com

DRV/ELS DRAWN BY: PROJECT NO.: 15410.11

DESIGN BY:

CEL

Clint Loumaster Professional Engineer License No. PB-2011009651 M2-3 Rezoning - Pre. Development Plan & Pre. Plat COOKINGHAM DEVELOPMENT Kansas City, Missouri

1	NO.	DATE	REVISIONS	BY	APPROVE
	1	4/19/24	City Comments 4/5/2024	ELS	7 7 7.0 72
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### OVERALL PLANT SCHEDULE

SYMBOL	CODE	QTY	BOTANICAL / COMMON NAME
TREES			
	AS	43	Acer saccharum 'John Pair' / Fall Fiesta Maple
	СО	16	Cercis canadensis texensis 'Oklahoma' / Oklahoma Texas Redbud
	PM	48	Platanus x acerifolia 'Morton Circle' / Exclamation Plane Tree
•	QS	48	Quercus shumardii / Shumard Oak
SHRUBS			
	НК	27	Hypericum kalmianum 'Deppe' / Sunny Boulevard® St. Johnswort
	IS	130	Ilex glabra 'Shamrock' / Shamrock Holly
	JK	16	Juniperus chinensis 'Kallays Compact' / Kallay Juniper
\\\\\\\\\\\\\\\\\\\\\\\\\\\\\\\\\\\\\\	JF	20	Juniperus chinensis 'Sea Green' / Sea Green Juniper
	JA	131	Juniperus x pfitzeriana 'Armstrongii' / Armstrong Pfitzer Juniper
	PV	110	Panicum virgatum 'Shenandoah' / Shenandoah Switch Grass
$(\lambda)$	VN	32	Viburnum opulus 'Nanum' / Dwarf European Cranberrybush
GROUND CO	VERS		
	DR	45,320 sf	Decorative Landscape Rock
,	FG	544,345 sf	Festuca var.
	NM	211,375 sf	Native Mix Oval Sedge - Carex brevior Canada Wild Rye - Elymus canadensis Bottlebrush Sedge - Elymus hystx Tussock Sedge Common Rush Fox Sedge American Sweet Flag


### LANDSCAPE REQUIREMENTS (Kansas City, Missouri)

I IEIVI(S)	REQUIRED	PROVIDED		
STREET TREES (88-425-03-C)				
1 TREE PER 30' OF FRONTAGE				
COOKINGHAM DRIVE (2,561 L.F.)	2,561 L.F. / 30 = 85 TREES	67 TREES		
PARKING LOT SCREENING (88-425-05-B)				
3' HT. CONT. EVERGREEN HEDGE	3' HT. CONT. EVERGREEN HEDGE AT PARKING	PROVIDED PER PLANS		
INTERIOR PARKING LOT LANDSCAPE (88-425-06)				
TOTAL PROPOSED PARKING = 81 SPACES				
35 S.F. LANDSCAPE AREA PER 1 PARKING SPACE	LANDSCAPE AREA REQUIRED = 2,835 S.F.	5,332 S.F.		
1 TREE PER 5 PARKING SPACES	TREES REQUIRED = 16	26 TREES		
1 SHRUB PER PARKING SPACE	SHRUBS REQUIRED = 81	205 SHRUBS		
GENERAL LANDSCAPE (88-425-04)				
1 TREE PER 5,000 S.F. OF BLDG. COVERAGE				
BUILDING COVERAGE = 433,386 S.F.	433,386 S.F. / 5,000 = 86.6 TREES	87 TREES PROVIDED		
SCREENING OF MECH, UTIL, TRASH (88-425-08-A)				
DUMPSTERS, CONTAINERS, UTILITIES SCREENED FROM	_	DUMPSTERS AND TRASH WILL BE CONTAINED		
PUBLIC VIEW		WITHIN BUILDING		


### INTERIOR PARKING LOT LANDSCAPE SCHEDULE (88-425-06)

A JA 131 Juniperus x pfitzeriana 'Armstrongii' / Armstrong Pfitzer Juniper

SYMBOL	CODE	QTY	BOTANICAL / COMMON NAME	SIZE	CONTAINER
TREES					
	AS	10	Acer saccharum 'John Pair' / Fall Fiesta Maple	2.5" Cal.	B&B
	со	16	Cercis canadensis texensis 'Oklahoma' / Oklahoma Texas Redbud	2" Cal.	
SYMBOL	CODE	QTY	BOTANICAL / COMMON NAME		
SHRUBS					
	НК	27	Hypericum kalmianum 'Deppe' / Sunny Boulevard® St. Johnswort		
	JK	16	Juniperus chinensis 'Kallays Compact' / Kallay Juniper		
<del>}``</del> }	JF	20	Juniperus chinensis 'Sea Green' / Sea Green Juniper		
	PV	110	Panicum virgatum 'Shenandoah' / Shenandoah Switch Grass		
$\wedge$	VN	32	Viburnum opulus 'Nanum' / Dwarf European Cranberrybush		
PARKII	NG LO	T SCI	REENING SCHEDULE (88-425-05-B)		
SYMBOL	CODE	QTY	BOTANICAL / COMMON NAME		
SHRUBS	IS	130	Ilex glabra 'Shamrock' / Shamrock Holly		

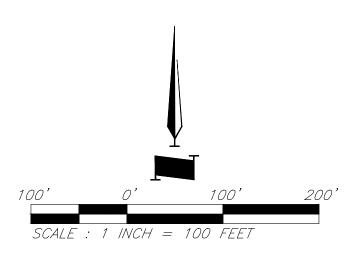

Landscape Plan

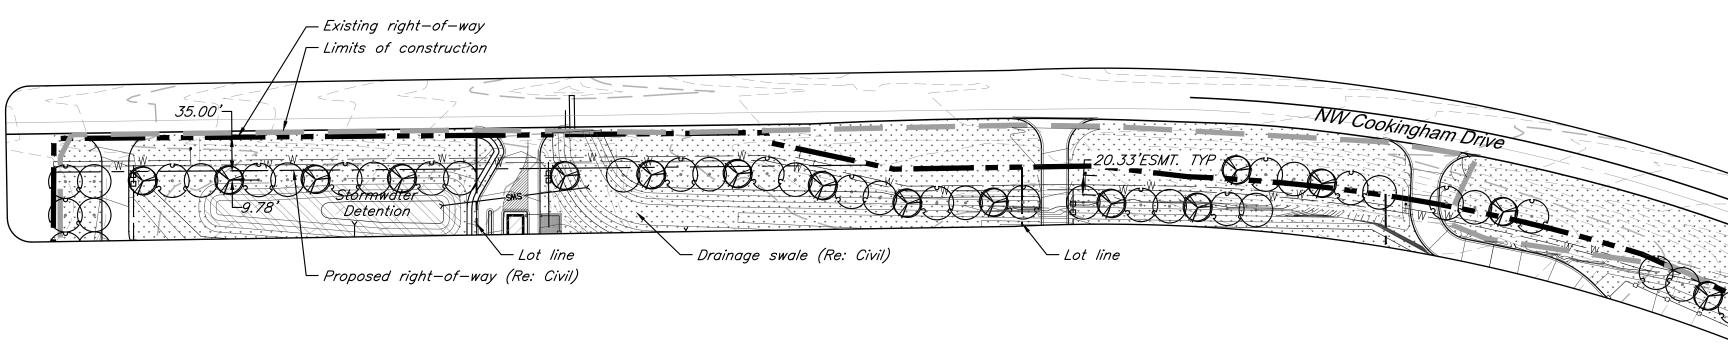

PROVIDED

67 TREES

2,561 L.F. / 30 = 85 TREES

LANDSCAPE REQUIREMENTS (KCMO)

COOKINGHAM DRIVE (2,561 L.F.)

STREET TREES (88-425-03-C)

1 TREE PER 30' OF FRONTAGE

PLANT SCHEDULE STREETSCAPE						
SYMBOL	CODE	QTY	BOTANICAL / COMMON NAME	SIZE	CONTAINE	
TREES						
	AS	22	Acer saccharum 'John Pair' / Fall Fiesta Maple	2.5" Cal.	В&В	
	PM	24	Platanus x acerifolia 'Morton Circle' / Exclamation Plane Tree	2.5" Cal.	в&в	
·	QS	24	Quercus shumardii / Shumard Oak	2.5" Cal.	B&B	

Fence (Re: Civil) —

GBA

9801 Renner Blvd., Ste. 300 Lenexa, KS 66219 913.492.0400 gbateam.com PROJECT NO.: 15410.11
SHEET NUMBER

DESIGN BY:
DRAWN BY:

3/15/2024 CEL


DRV/ELS

Clint Loumaster Professional Engineer License No. PB-2011009651 M2-3 Rezoning - Pre. Development Plan & Pre. Plat

COOKINGHAM DEVELOPMENT

Kansas City, Missouri

				<b>3</b> ·		
NO.	DATE		REVISIONS		BY	APPROVE.
1	4/19/24	City Com	ments 4/5/2024		ELS	

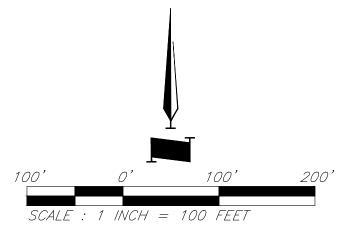

### LANDSCAPE NOTES:

- 1. FIELD VERIFY UTILITIES SHOWN ON PLANS PRIOR TO WORK COMMENCEMENT. INFORMATION SHOWN ON PLAN IS FROM AVAILABLE INFORMATION AND ALL LOCATIONS SHOWN SHOULD BE CONSIDERED APPROXIMATE. THE CONTRACTOR AGREES TO BE FULLY RESPONSIBLE FOR ANY AND ALL DAMAGE TO UTILITIES MADE FROM CONSTRUCTION ACTIVITY. IMMEDIATELY NOTIFY PROJECT LANDSCAPE ARCHITECT AND ENGINEER IF DISCREPANCIES ARISE.
- 2. COMPLETE REQUIRED LANDSCAPING FOR THE ENTIRE SITE IN CONFORMANCE TO THE PLANS AND SPECIFICATIONS, INCLUDING BUT NOT LIMITED TO: SEEDED AREAS, SODDED AREAS, SHRUB BEDS, AND SITE CLEAN-UP.
- 3. VERIFY QUANTITIES PRIOR TO COMMENCING WORK. REPORT DISCREPANCIES TO THE LANDSCAPE ARCHITECT. PLANT MATERIAL TO BE SPACED AS SHOWN, UNLESS OTHERWISE NOTED.
- 4. PLANT MATERIAL SHALL COMPLY WITH ALL SIZING AND GRADING STANDARDS OF LATEST EDITION OF AMERICAN STANDARD FOR NUSERY STOCK (A.S.N.S.) LATEST EDITION PUBLISHED BY (ANLA) ANSI 260.1. THIS IS A REPRESENTATIVE GUIDELINE SPECIFICATION ONLY AND WILL CONSTITUTE MINIMUM QUALITY REQUIREMENTS FOR THE PLANT MATERIAL.
- 5. THE OWNER RESERVES THE RIGHT TO SUBSTITUTE PLANT MATERIAL, TYPE, SIZE AND/OR QUANTITY. LARGER SIZED PLANT MATERIALS OF THE SPECIES LISTED MAY BE USED IF THE STOCK CONFORMS TO A.S.N.S. VEGETATION SUBSTITUTIONS SHALL BE APPROVED BY PROJECT LANDSCAPE ARCHITECT. SUBSTITUTIONS MADE WITHOUT WRITTEN APPROVAL WILL BE REPLACED WITH APPROVED SELECTIONS AT CONTRACTOR'S COST.
- 6. DISTURBED AREAS DUE TO CONSTRUCTION ACTIVITIES NOT IDENTIFIED ON THESE PLANS SHALL BE REPAIRED AND RESTORED TO ORIGINAL OR BETTER CONDITIONS AT CONTRACTOR'S COST. SOD WITH A TURF-TYPE TALL FESCUE BLEND SHALL BE PROVIDED FOR AREAS NOT DESIGNATED AS BEDS & PAVEMENT.
- 7. CONTRACTOR SHALL COMPLY WITH APPLICABLE CODES AND ORDINANCES REGARDING LANDSCAPING. REFER TO SPECIFICATIONS FOR PLANT MATERIAL, SOILS, AND INSTALLATION METHODS.
- 8. INSTALL PLANT MATERIAL IN ACCORDANCE WITH A.S.N.S. STANDARDS.
- 9. INSTALL FINISHED GRADES OF SOD, LANDSCAPE BEDS, AND MULCH 1" BELOW ABUTTING PAVEMENT SURFACES TO ALLOW UNINHIBITED DRAINAGE TO NON-PAVEMENT SURFACES.
- 10. REMOVE ALL TWINE, WIRE, AND BURLAP FROM TREE AND SHRUB ROOT BALLS. REMOVE ALL PLASTIC WRAP, FABRIC ROPE, ROT PROOF WRAP, AND PLANT IDENTIFICATION TAGS.
- 11. TREES SHALL NOT BE PLANTED CLOSER THAN EIGHT HORIZONTAL FEET OF UNDERGROUND UTILITIES UNLESS OTHERWISE NOTED OR PER PLANS. MODIFICATIONS TO TREE PLACEMENT SHALL BE COORDINATED WITH THE LANDSCAPE ARCHITECT AND CAN BE SUBJECT TO CITY REVIEW AND APPROVAL. CONTRACTOR IS RESPONSIBLE FOR UNAPPROVED RELOCATION(S) OR MODIFICATION(S) TO TREE LOCATIONS.
- 12. PROVIDE NATURAL TOPSOIL THAT IS FERTILE, FRIABLE, WITHOUT MIXTURE OF SUBSOIL MATERIALS, AND OBTAINED FROM A WELL DRAINED, AVAILABLE SITE. IT SHALL NOT CONTAIN SUBSTANCES WHICH MAY BE HARMFUL TO PLANT GROWTH. TOPSOIL SHALL BE SCREENED AND FREE FROM CLAY, LUMPS, STONES, ROOTS, PLANTS, OR SIMILAR SUBSTANCES 1" OR MORE IN DIAMETER, DEBRIS, OR OTHER OBJECTS WHICH MIGHT BE A HINDRANCE TO PLANTING OPERATIONS. TOPSOIL SHALL CONTAIN AT LEAST 4-6% ORGANIC MATTER BY WEIGHT AND HAVE A PH RANGE OF 5.5 TO 7.0.

- 13. PLANT MATERIAL TO BE GUARANTEED FOR ONE (1) YEAR FROM THE DATE OF SUBSTANTIAL COMPLETION AND ACCEPTANCE. PLANT MATERIALS SHALL BE A ONE-TIME-REPLACEMENT AND RECORDS KEPT BY THE LANDSCAPE CONTRACTOR FOR ALL REPLACEMENTS.
- 14. PLANT MATERIAL SHALL BE OF EXCELLENT QUALITY, FREE OF DISEASE & INFESTATION-TRUE TO TYPE, VARIETY, SIZE SPECIFIED, & FORM PER ANSI STANDARDS.
- 15. WATER-IN EACH PLANT IMMEDIATELY FOLLOWING INSTALLATION AND CONTINUE WATERING ROUTINE UNTIL SUBSTANTIAL PROJECT COMPLETION. CONTRACTOR IS REQUIRED TO COORDINATE WATERING REQUIREMENTS TO THE OWNER THEREAFTER.
- 16. ALL WORK SHALL BE COORDINATED WITH THE WORK OF OTHER TRADES.
- 17. THE OWNER'S REPRESENTATIVE RESERVES THE RIGHT TO REJECT ANY PLANT MATERIAL NOT CONFORMING TO THE SPECIFICATIONS.
- 18. THE LANDSCAPE CONTRACTOR SHALL TEST PROPOSED PLANTING AREAS FOR SOIL NUTRIENT DEFICIENCIES AND UNDESIRABLE SOIL TEXTURE AND STRUCTURE. BASED ON THE RESULTS OF THIS TESTING, THE LANDSCAPE CONTRACTOR SHALL PROVIDE AND INCORPORATE SOIL CONDITIONING MATERIALS (IE: FERTILIZER, SAND, COMPOST, ETC.) AS NECESSARY TO DEVELOP A PLANT GROWTH MEDIUM OF ADEQUATE FERTILITY, STRUCTURE, AND TEXTURE FOR THE ESTABLISHMENT OF LANDSCAPE MATERIALS. PEAT IS NOT ACCEPTABLE.
- 19. THE LANDSCAPE CONTRACTOR SHALL REMOVE FROM THE SITE ALL ROCK GREATER THAN 1-INCH AND ALL DEBRIS IN THE AREAS OF PROPOSED NEW PLANTINGS.
- 15.DAMAGED TURF AREAS ADJACENT TO PLANTING AREAS SHALL BE RESTORED AND SODDED TO MATCH EXISTING ADJACENT TOPOGRAPHY AND TURF TYPE.


### 16. PLANTING SCHEDULE:

TREE PLANTING:	MARCH 15 - JUNE 15	OR	SEPTEMBER 15 - DECEMBER 31
SHRUB PLANTING:	APRIL 15 - JUNE 15	OR	AUGUST 15 - OCTOBER 15
SOD/SEED PLANTING:	MARCH 15 - JUNE 15	OR	SEPTEMBER 15 - DECEMBER 1

17. ALL PLANTING METHODS SHALL COMPLY WITH CITY OF KANSAS CITY, MO STANDARDS.

PLANTING BED INSTALLATION NOTES:

- 1. ALL PLANTATION BEDS SHALL BE AMENDED WITH 1 CUBIC YARD OF COTTON BOLL COMPOST PER 1000 SQUARE FEET. FILL COTTON BOLL INTO SOIL TO A 6" DEPTH. A 10-10-10 FERTILIZER SHALL BE SPREAD OVER ALL PLANTING AREAS PRIOR TO PLANTING, AT A RATE OF 50 POUNDS PER 2000 SQ. FT.
- 2. AFTER PLANTING HAVE BEEN INSTALLED, ALL PLANTING BEDS SHALL BE TREATED WITH DACTHAL PRE-EMERGENT HERBICIDE PRIOR TO MULCH OR ROCK APPLICATION.
- 3. PLANT PIT BACKFILL FOR SHRUBS SHALL BE 25% COTTON BOLL COMPOST AND 25% TOP SOIL AND 50% EXISTING SOIL. TOP SOIL SHALL BE NATURAL FERTILE, FRIABLE SOIL POSSESSING CHARACTERISTICS OF REPRESENTATIVE PRODUCTIVE SOILS IN THE AREAS. SOIL SHALL NOT BE EXCESSIVELY ACID, ALKALINE OR TOXIC THAT MAY BE HARMFUL TO PLANT GROWTH. ALSO, FREE OF CLAY LUMPS, STONES, STUMPS, ROOTS OR
- SUBSTANCE 2" OR MORE IN DIAMETER. 4. PLANTING TABLETS: INSTALL MANUFACTURER GRO-POWER, INC, PRODUCT: GROWPOWER TABLETS, SIZE: 7-GRAM TABLETS, RATE: 1 TABLETS PER 1-GALLON CONTAINER AND 4 TABLETS PER 3-GALLON CONTAINER AND 7 TABLETS PER 5-GALLON CONTAINER.
- 5. PLANTED BED EDGES SHALL BE IN STRAIGHT LINES OR GENTLE FOLLOWING CURVES. SUDDEN CURVES OR SHARP ANGLE SHOULD BE AVOIDED.

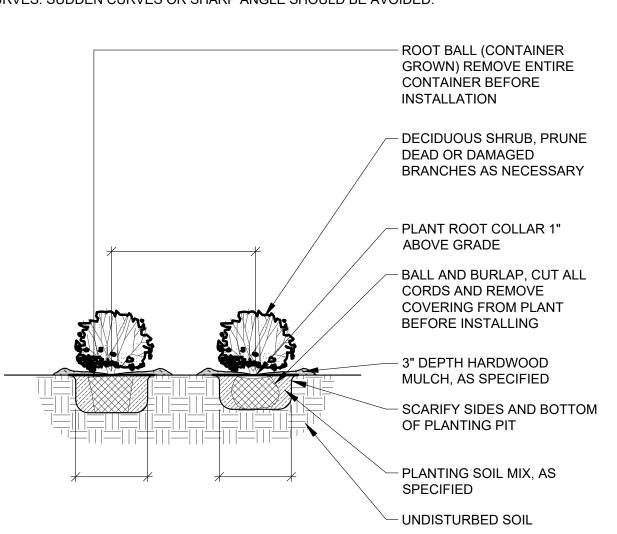

- 1) EXCAVATE A PIT WHICH IS AT LEAST TWICE THE DIAMETER OF THE ROOTBALL AND THE SAME DEPTH-NO DEEPER. HANDLE THE TREE BY THE ROOT BALL, NOT THE TRUCK. BE SURE THE ROOT BALL RESTS ON SOLID 2) BACKFILL WITH PLANTING SOIL
- 3) SATURATE THE ENTIRE BACKFILL SOIL WITH WATER. ADD MORE SOIL IF NEEDED TO COMPENSATE FOR
- 4) MULCH: COVER SMOOTHED SOIL WITH 2 INCHES OF MULCH. LEAVE GAP NEAR THE TRUCK. KEEP MULCH WEEDED. REPLACE AS NEEDED.
- 5) PRUNE ONLY BROKEN OR BADLY DEFORMED BRANCHES TO RETAIN SHAPE OF THE SPECIES. PRUNE OUT SECONDARY AND COMPETING GROWTH. DO NOT SHEAR. DO NOT CUT LEADER. BEGIN A REGULAR PRUNING PROGRAM THE SECOND YEAR AFTER PLANTING. 6) CHAFING GUARDS: REMOVE GUARDS AS SOON AS THE TREE CAN STAND ALONE ABOUT 3 MONTHS OR
- LONGER IF NEEDED. 7) DO NOT ALLOW AIR POCKETS TO FORM WHEN BACKFILLING.
- 8) DO NOT DISTURB ROOT BALL WHEN PLANTING OR STAKING. CRACKED OR OTHERWISE DAMAGED ROOT BALLS SHALL BE REJECTED. 9) WATER THOROUGHLY FOLLOWING PLANTING. 10) REMOVE EXCESS DEBRIS FORM AROUND ROOT COLLAR/FLARE IS LEVEL OR SLIGHTLY ABOVE (1" MAX)
- ADJACENT UPHILL GRADE.
- 11) SCARIFY EDGES OF EXCAVATION WHERE SMOOTHED DURING EXCAVATION. 12) ALL PLANTING METHODS SHALL COMPLY WITH CITY OF BRANSON STANDARDS.

DECIDUOUS TREE, PRUNE DEAD OR DAMAGED BRANCHES AS NECESSARY ARBOR TIE OR EQUIVALENT, AS SPECIFIED - STEEL FENCE POST OR SIMILAR STAKING WIRE ENSURE SLACK -ROOT BASE 1" ABOVE GRADE, MINIMUM FOR TREE MOVEMENT 3" DEPTH HARDWOOD MULCH, AS SPECIFIED FLEXIBLE FLAT STRAP TREE WRAP -REMOVE TOP <sup>1</sup>/<sub>3</sub> OF BURLAP, TWINE, ROPE AND BASKET FROM ROOTBALL SCARIFY SIDES AND BOTTOM OF PLANTING PIT - PLANTING SOIL MIX AS SPECIFIED

ROCK - 6" DEPTH AMENDED SOIL 6"x12 GAUGE COL-MET STEEL EDGING OR EQUAL; COLOR BLACK

LANDSCAPE

SHRUB AND PERENNIAL PLANTING

1/2" = 1'-0"

329333.01-04

1/2" = 1'-0"

**DECIDUOUS TREE PLANTING** 

9801 Renner Blvd., Ste. 300 Lenexa, KS 66219 913.492.0400 gbateam.com

PROJECT NO.: 15410.11 SHEET NUMBER

DESIGN BY:

DRAWN BY:

3/15/2024

CEL

*DRV/ELS* 

Clint Loumaster Professional Engineer License No. PB-2011009657


M2-3 Rezoning - Pre. Development Plan & Pre. Plat COOKINGHAM DEVELOPMENT Kansas City, Missouri


DATE REVISIONS BY APPROVED | ELS | 4/19/24 City Comments 4/5/2024


Planting Details


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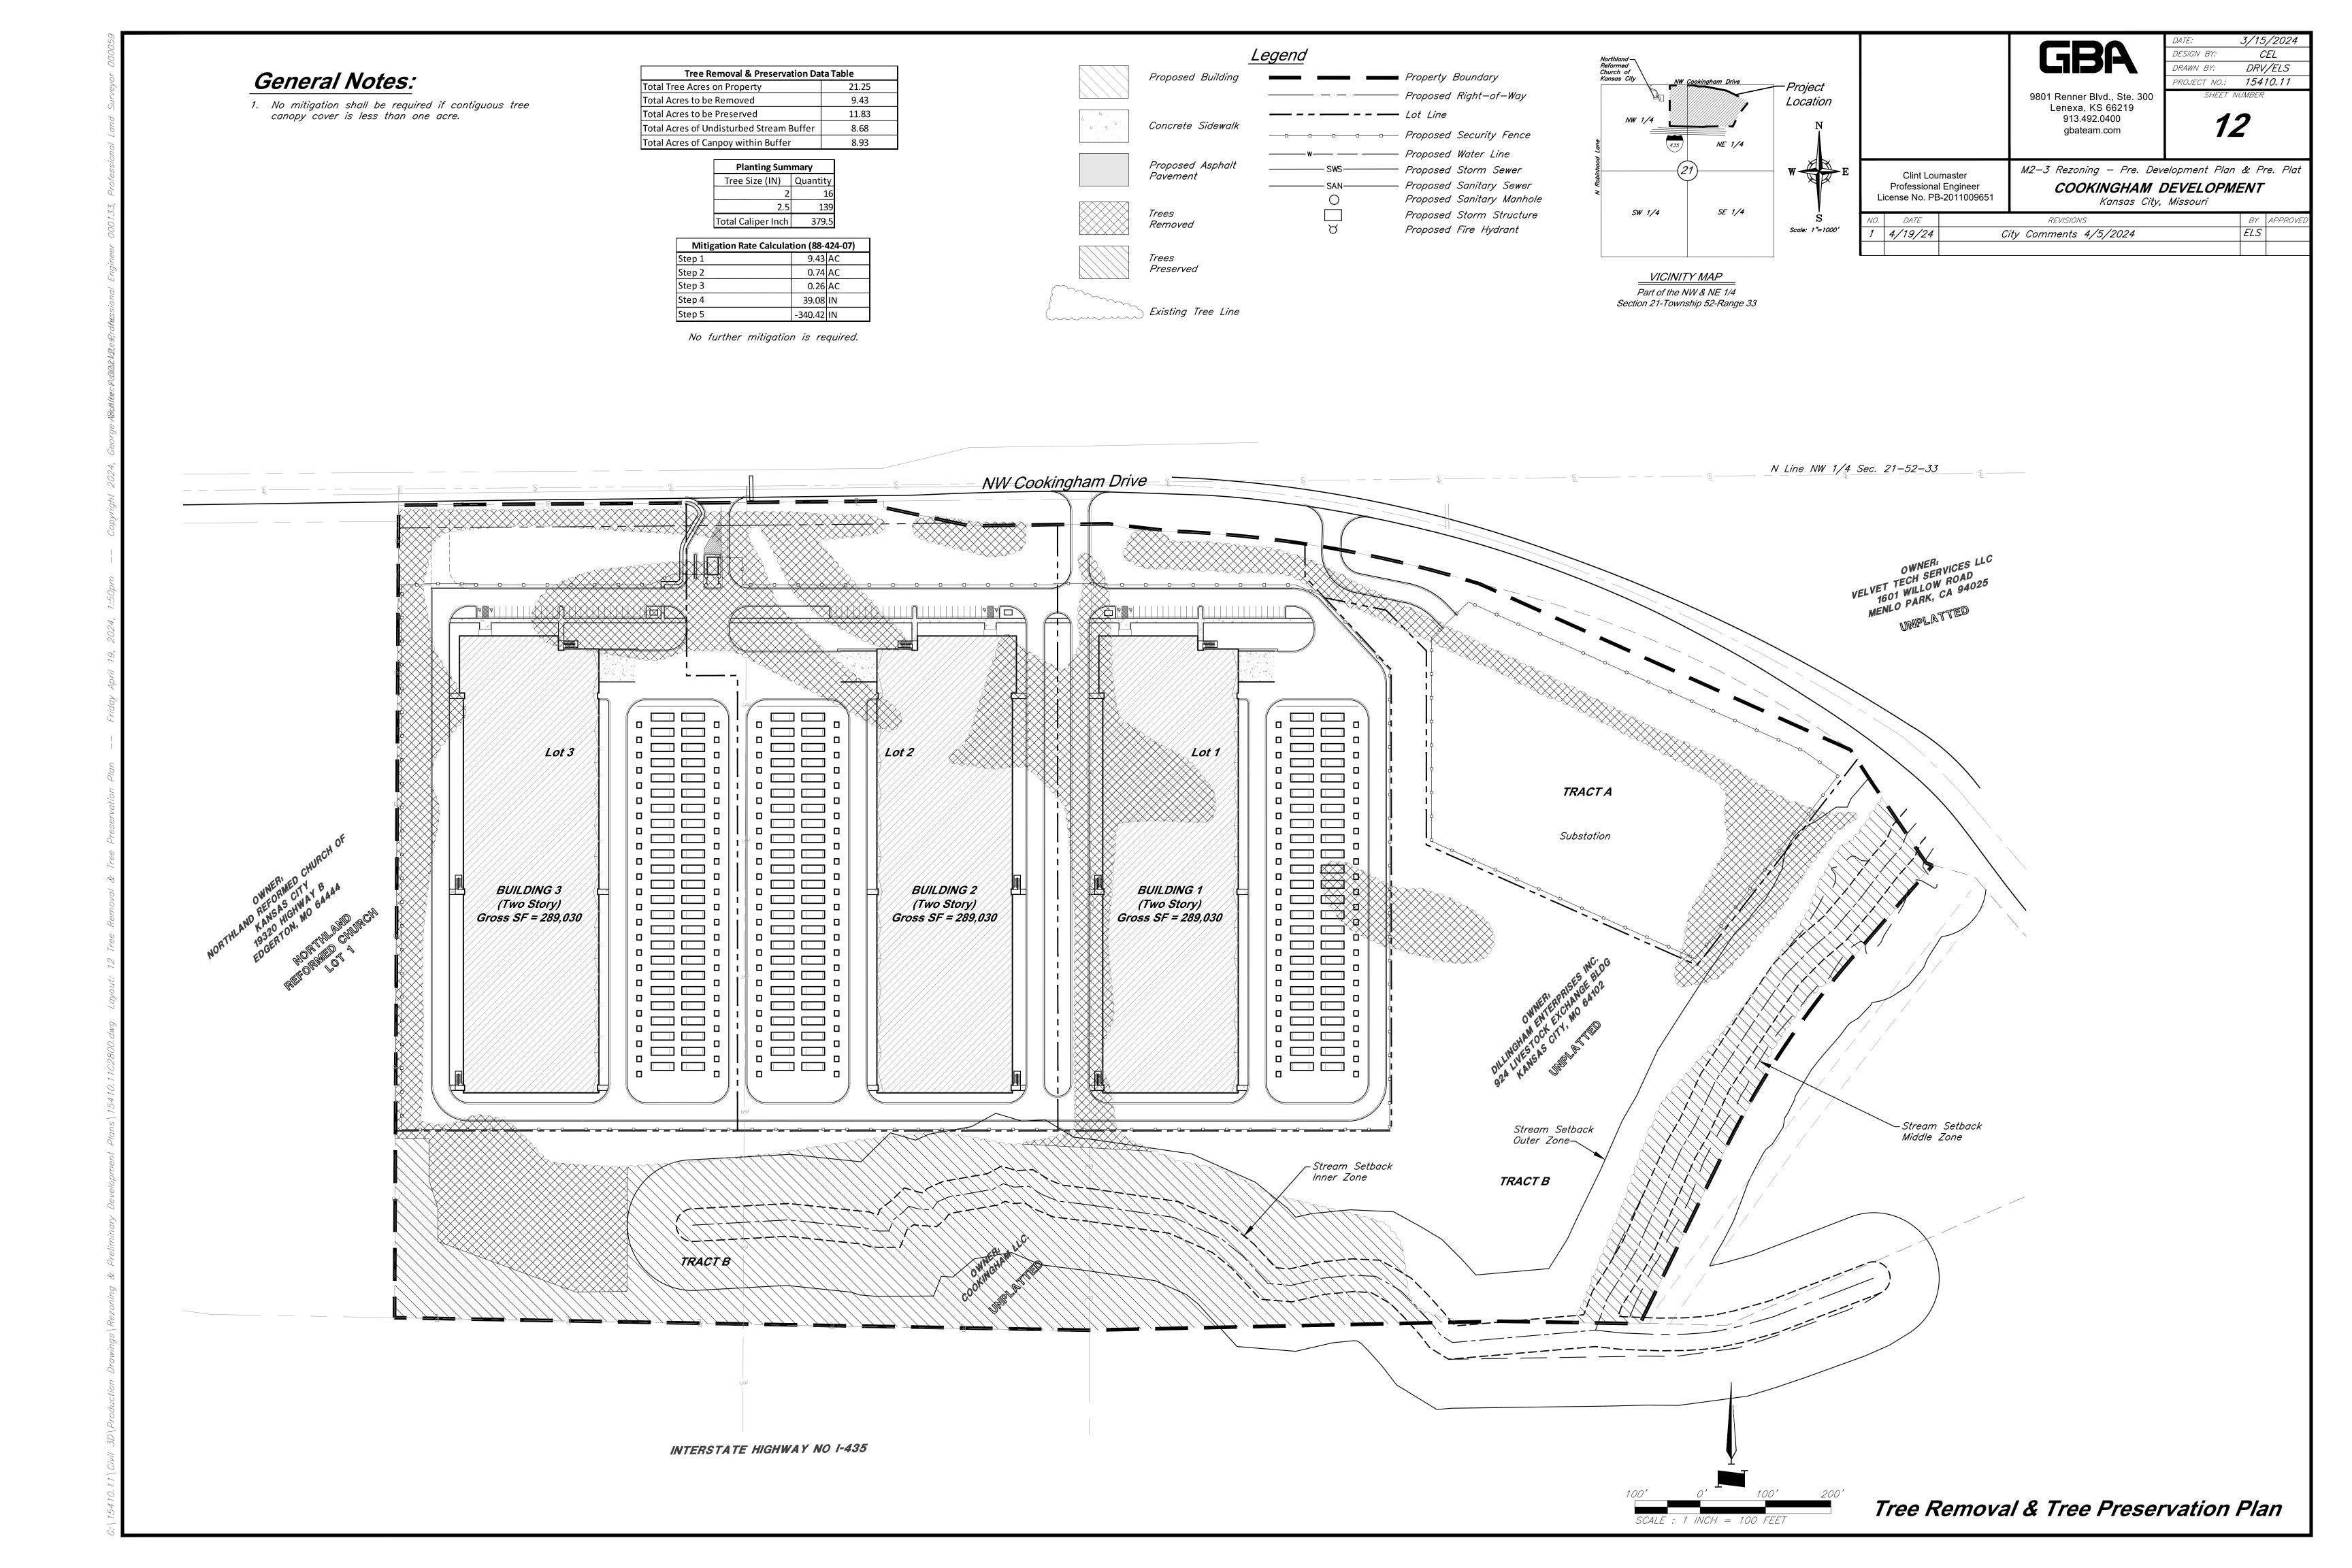
UNDISTURBED SOIL




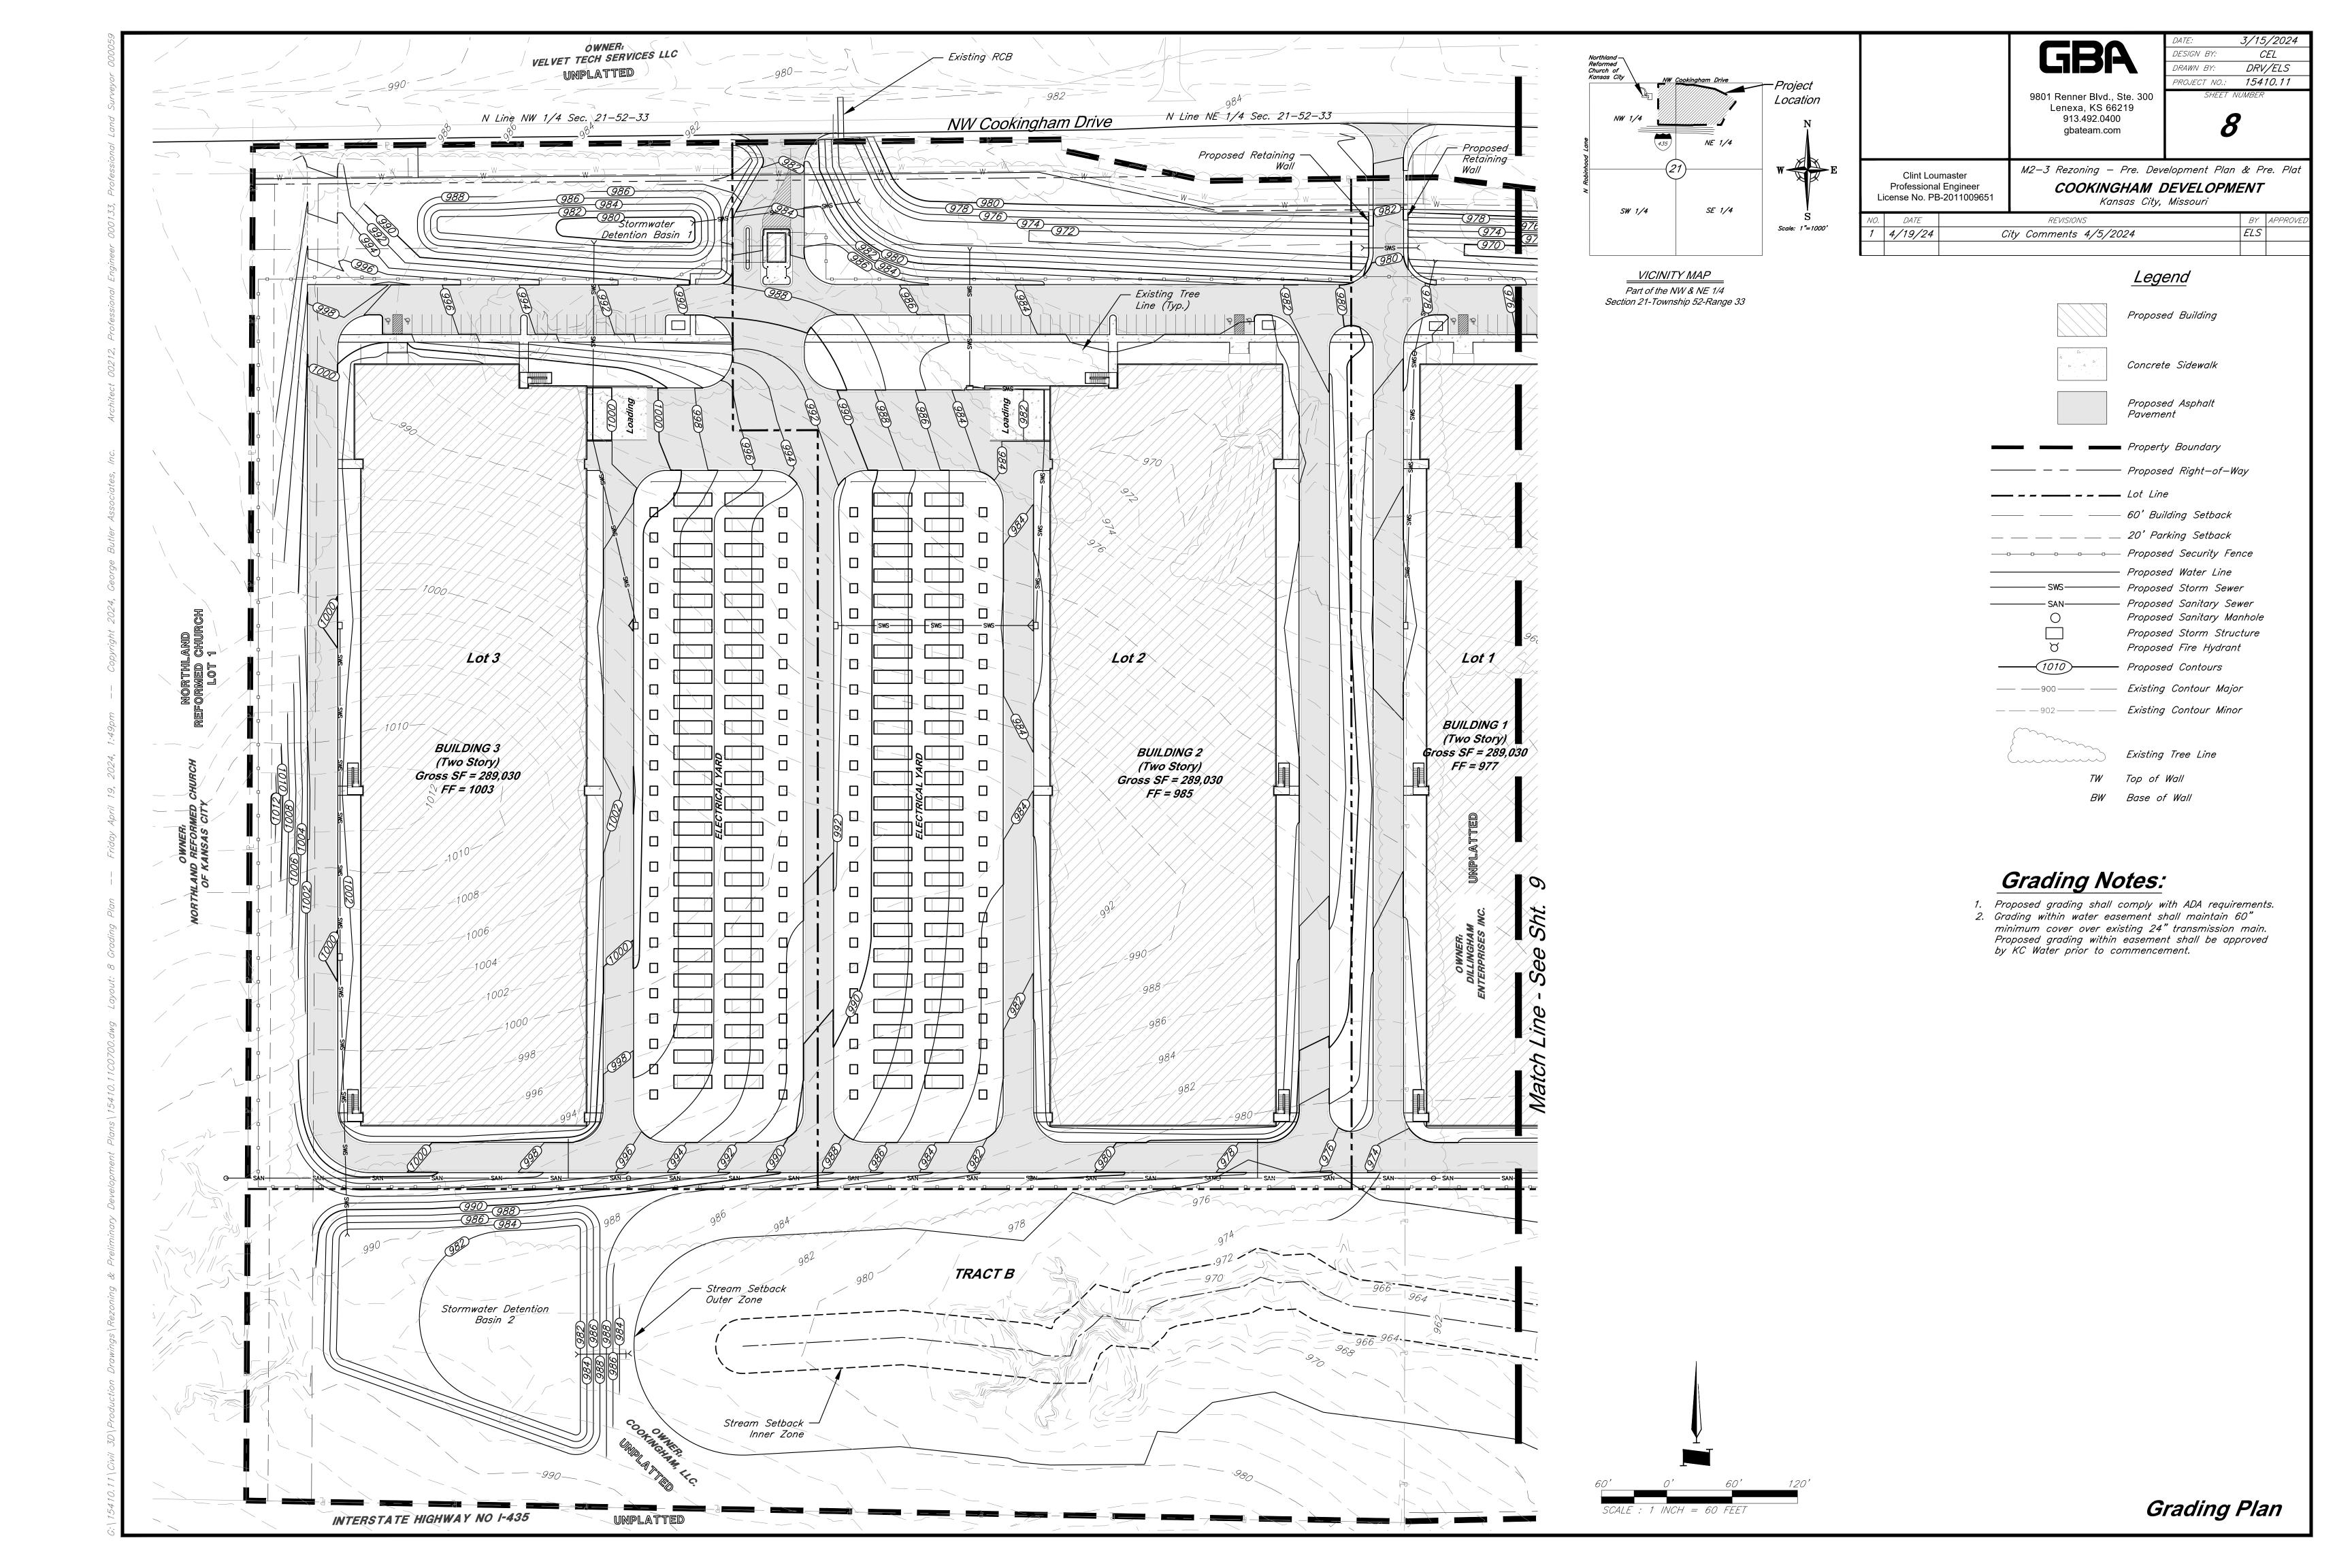


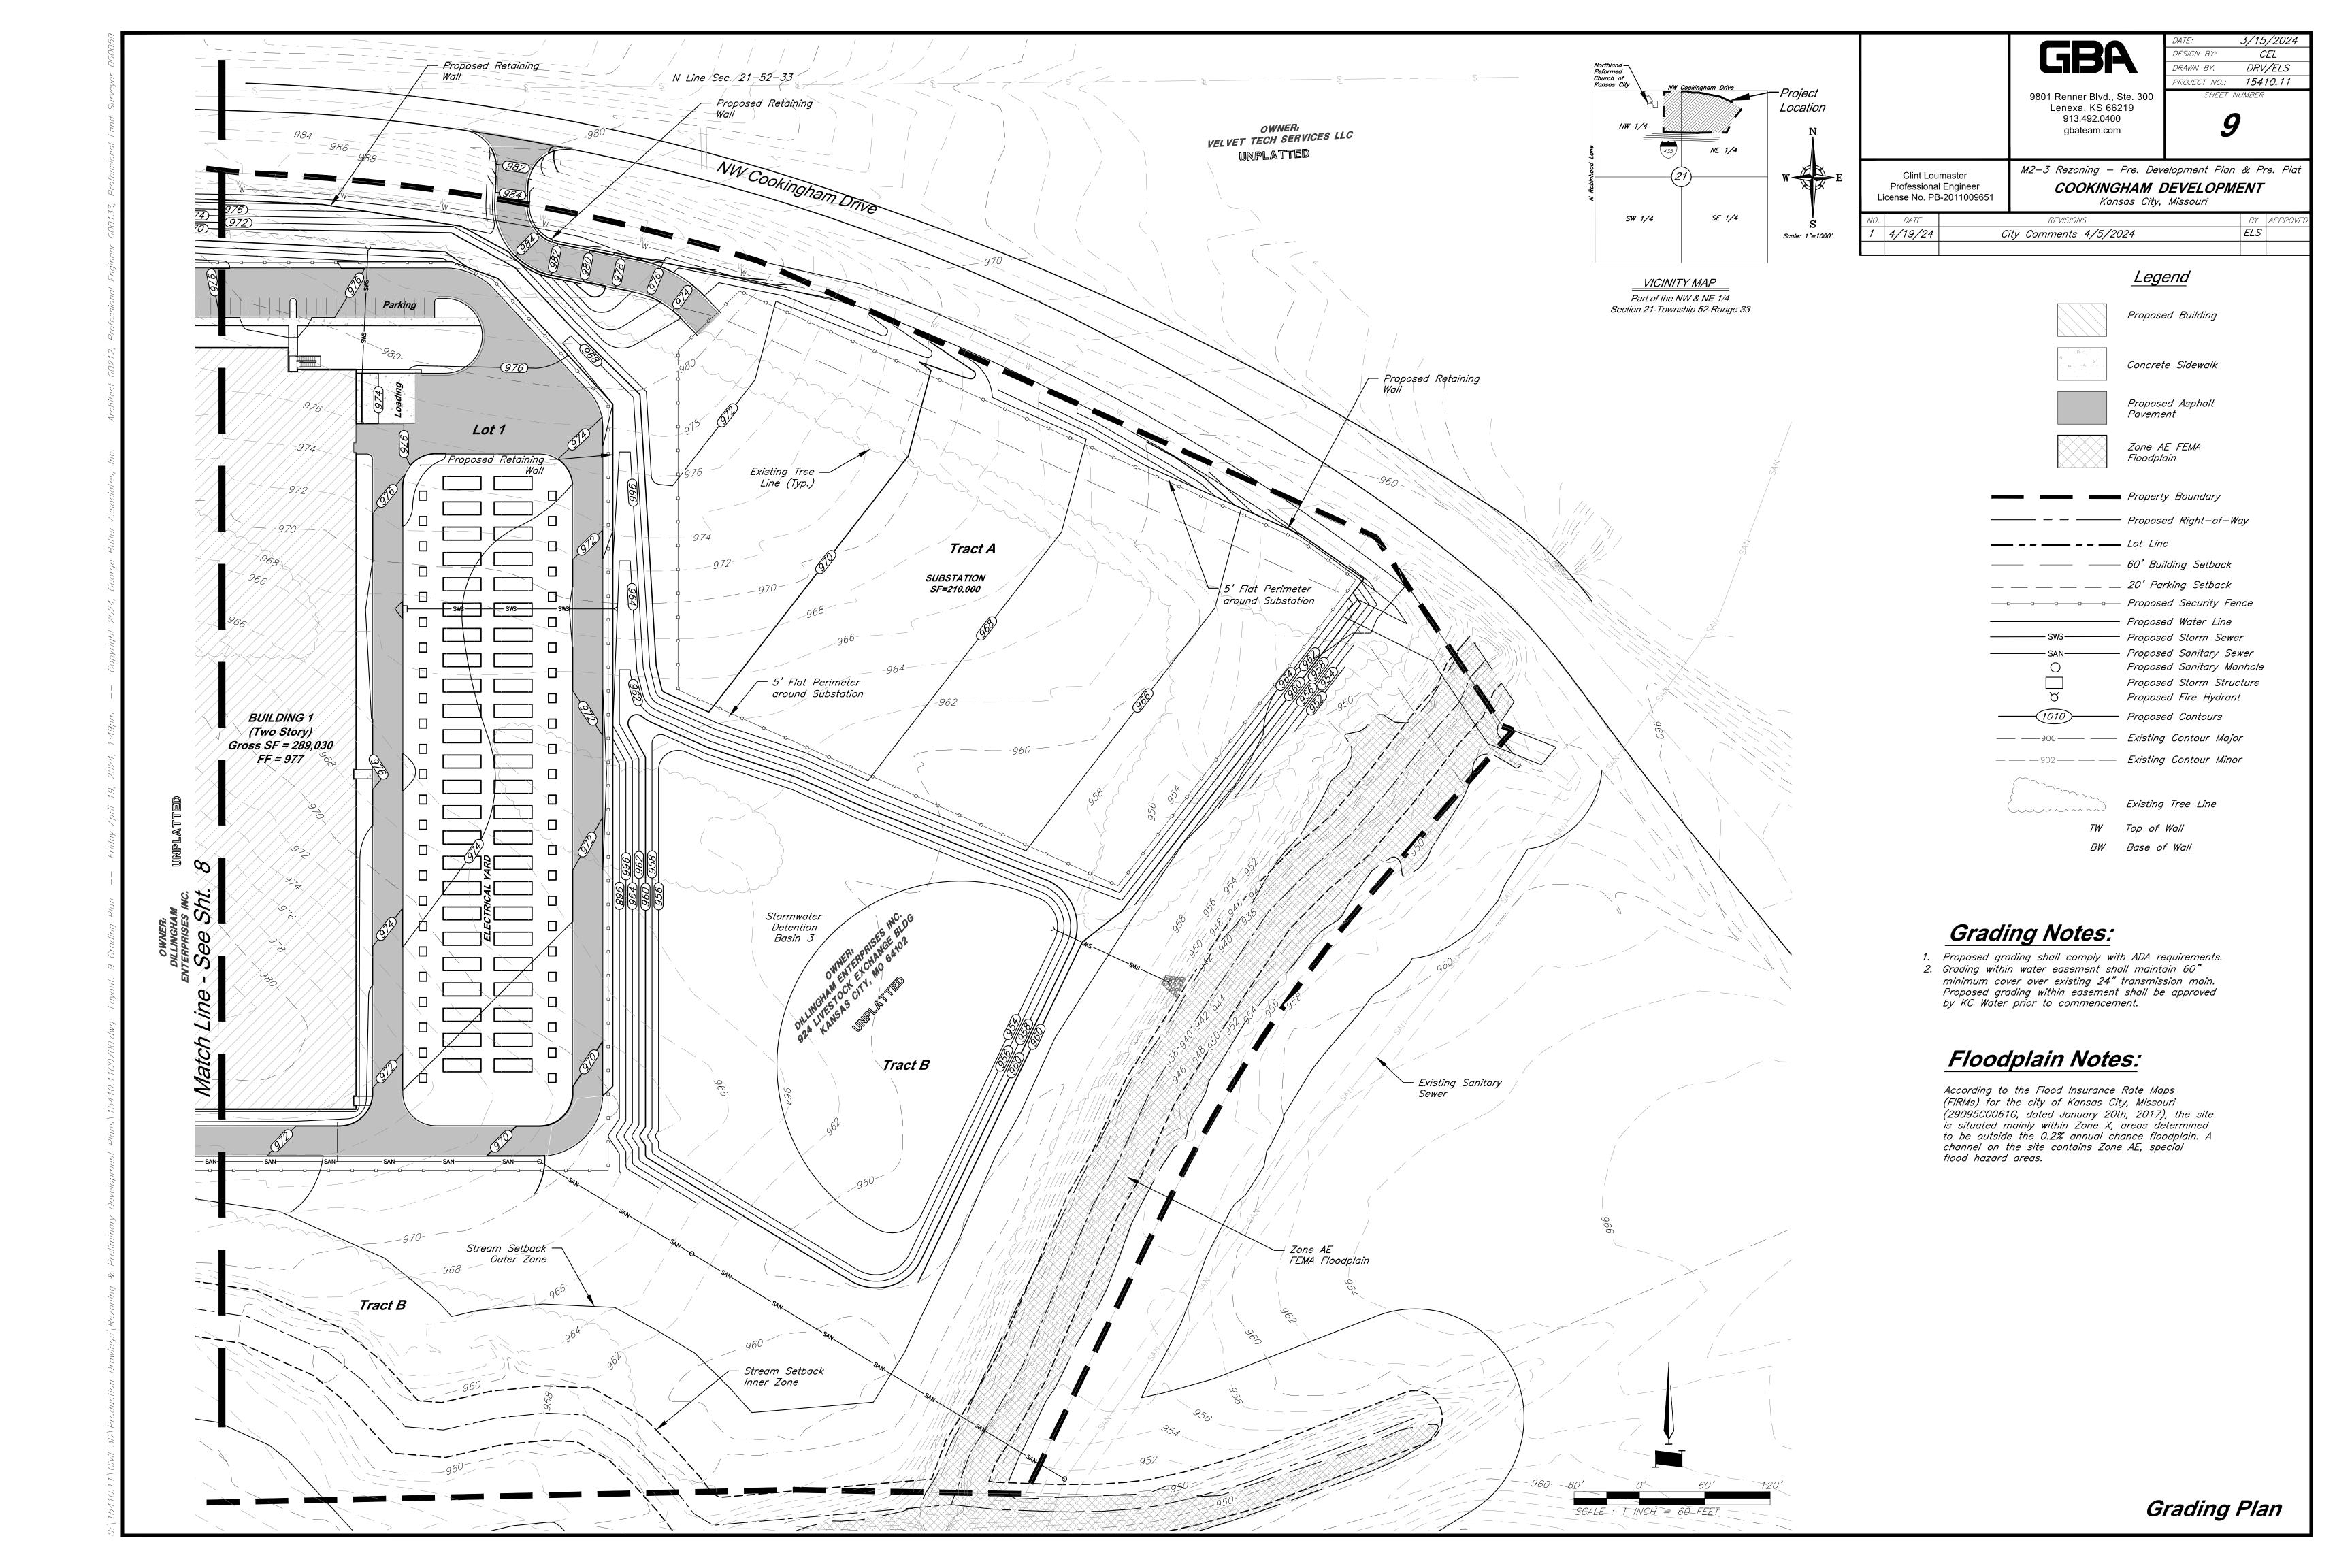

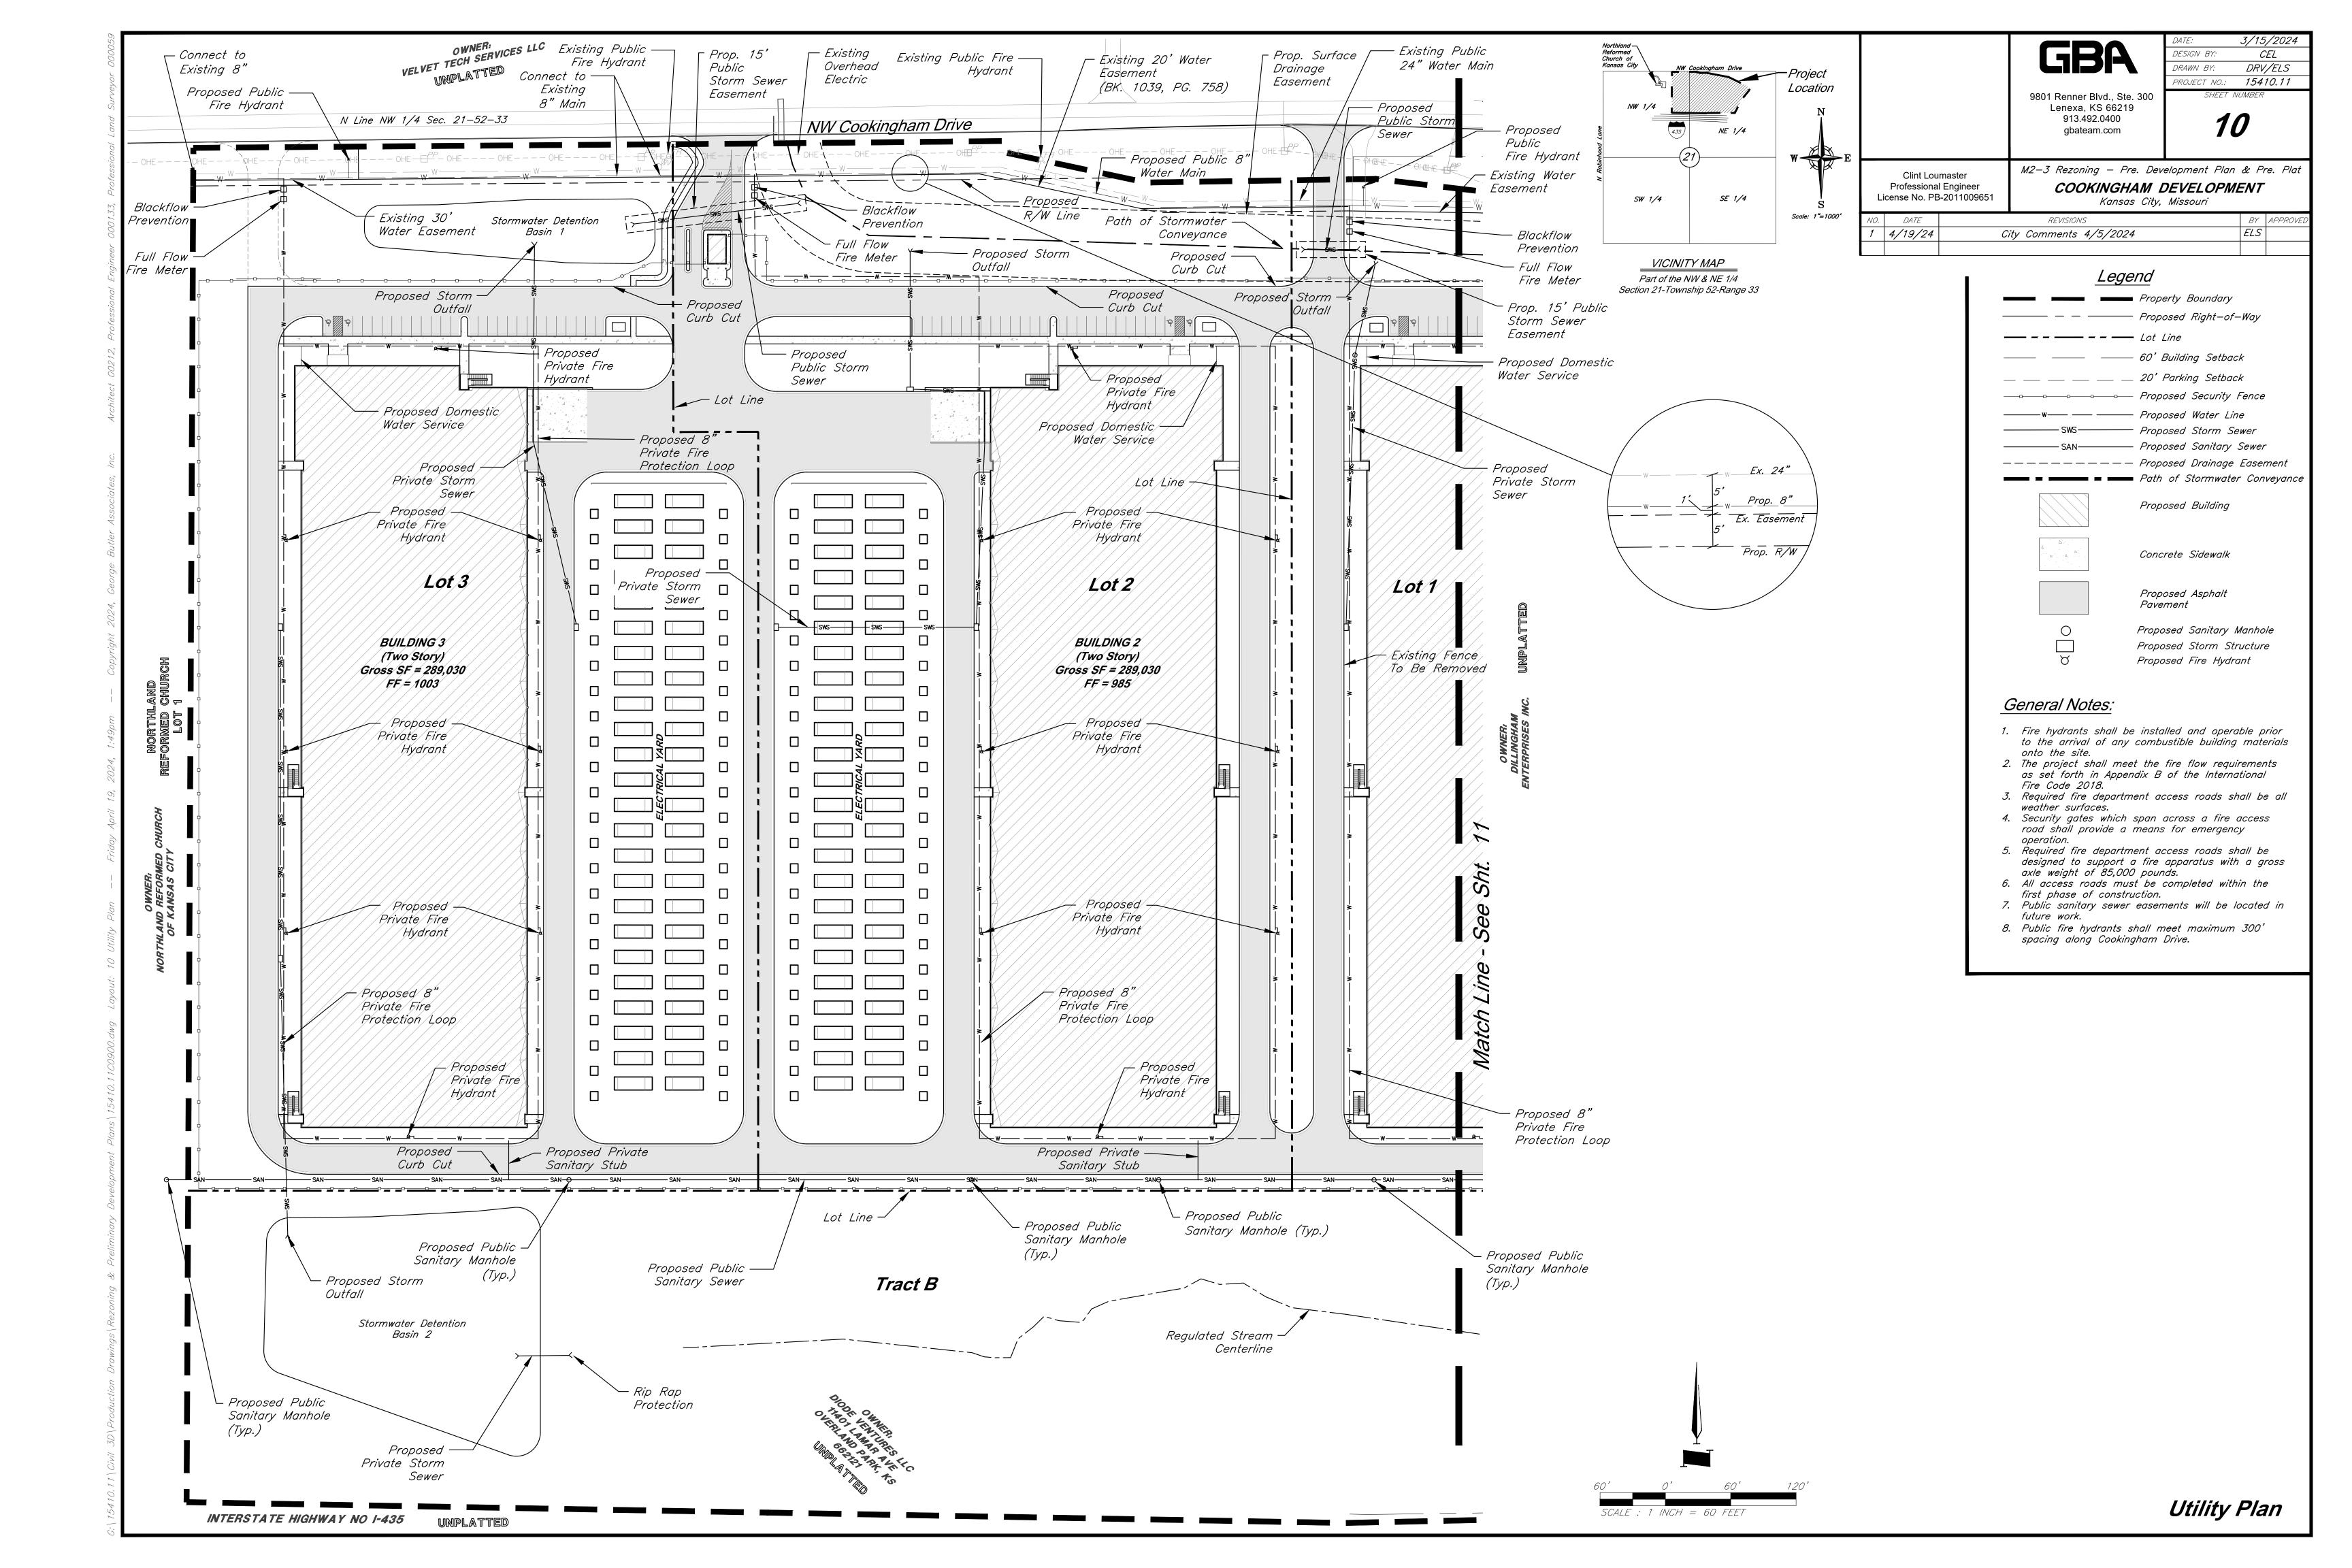

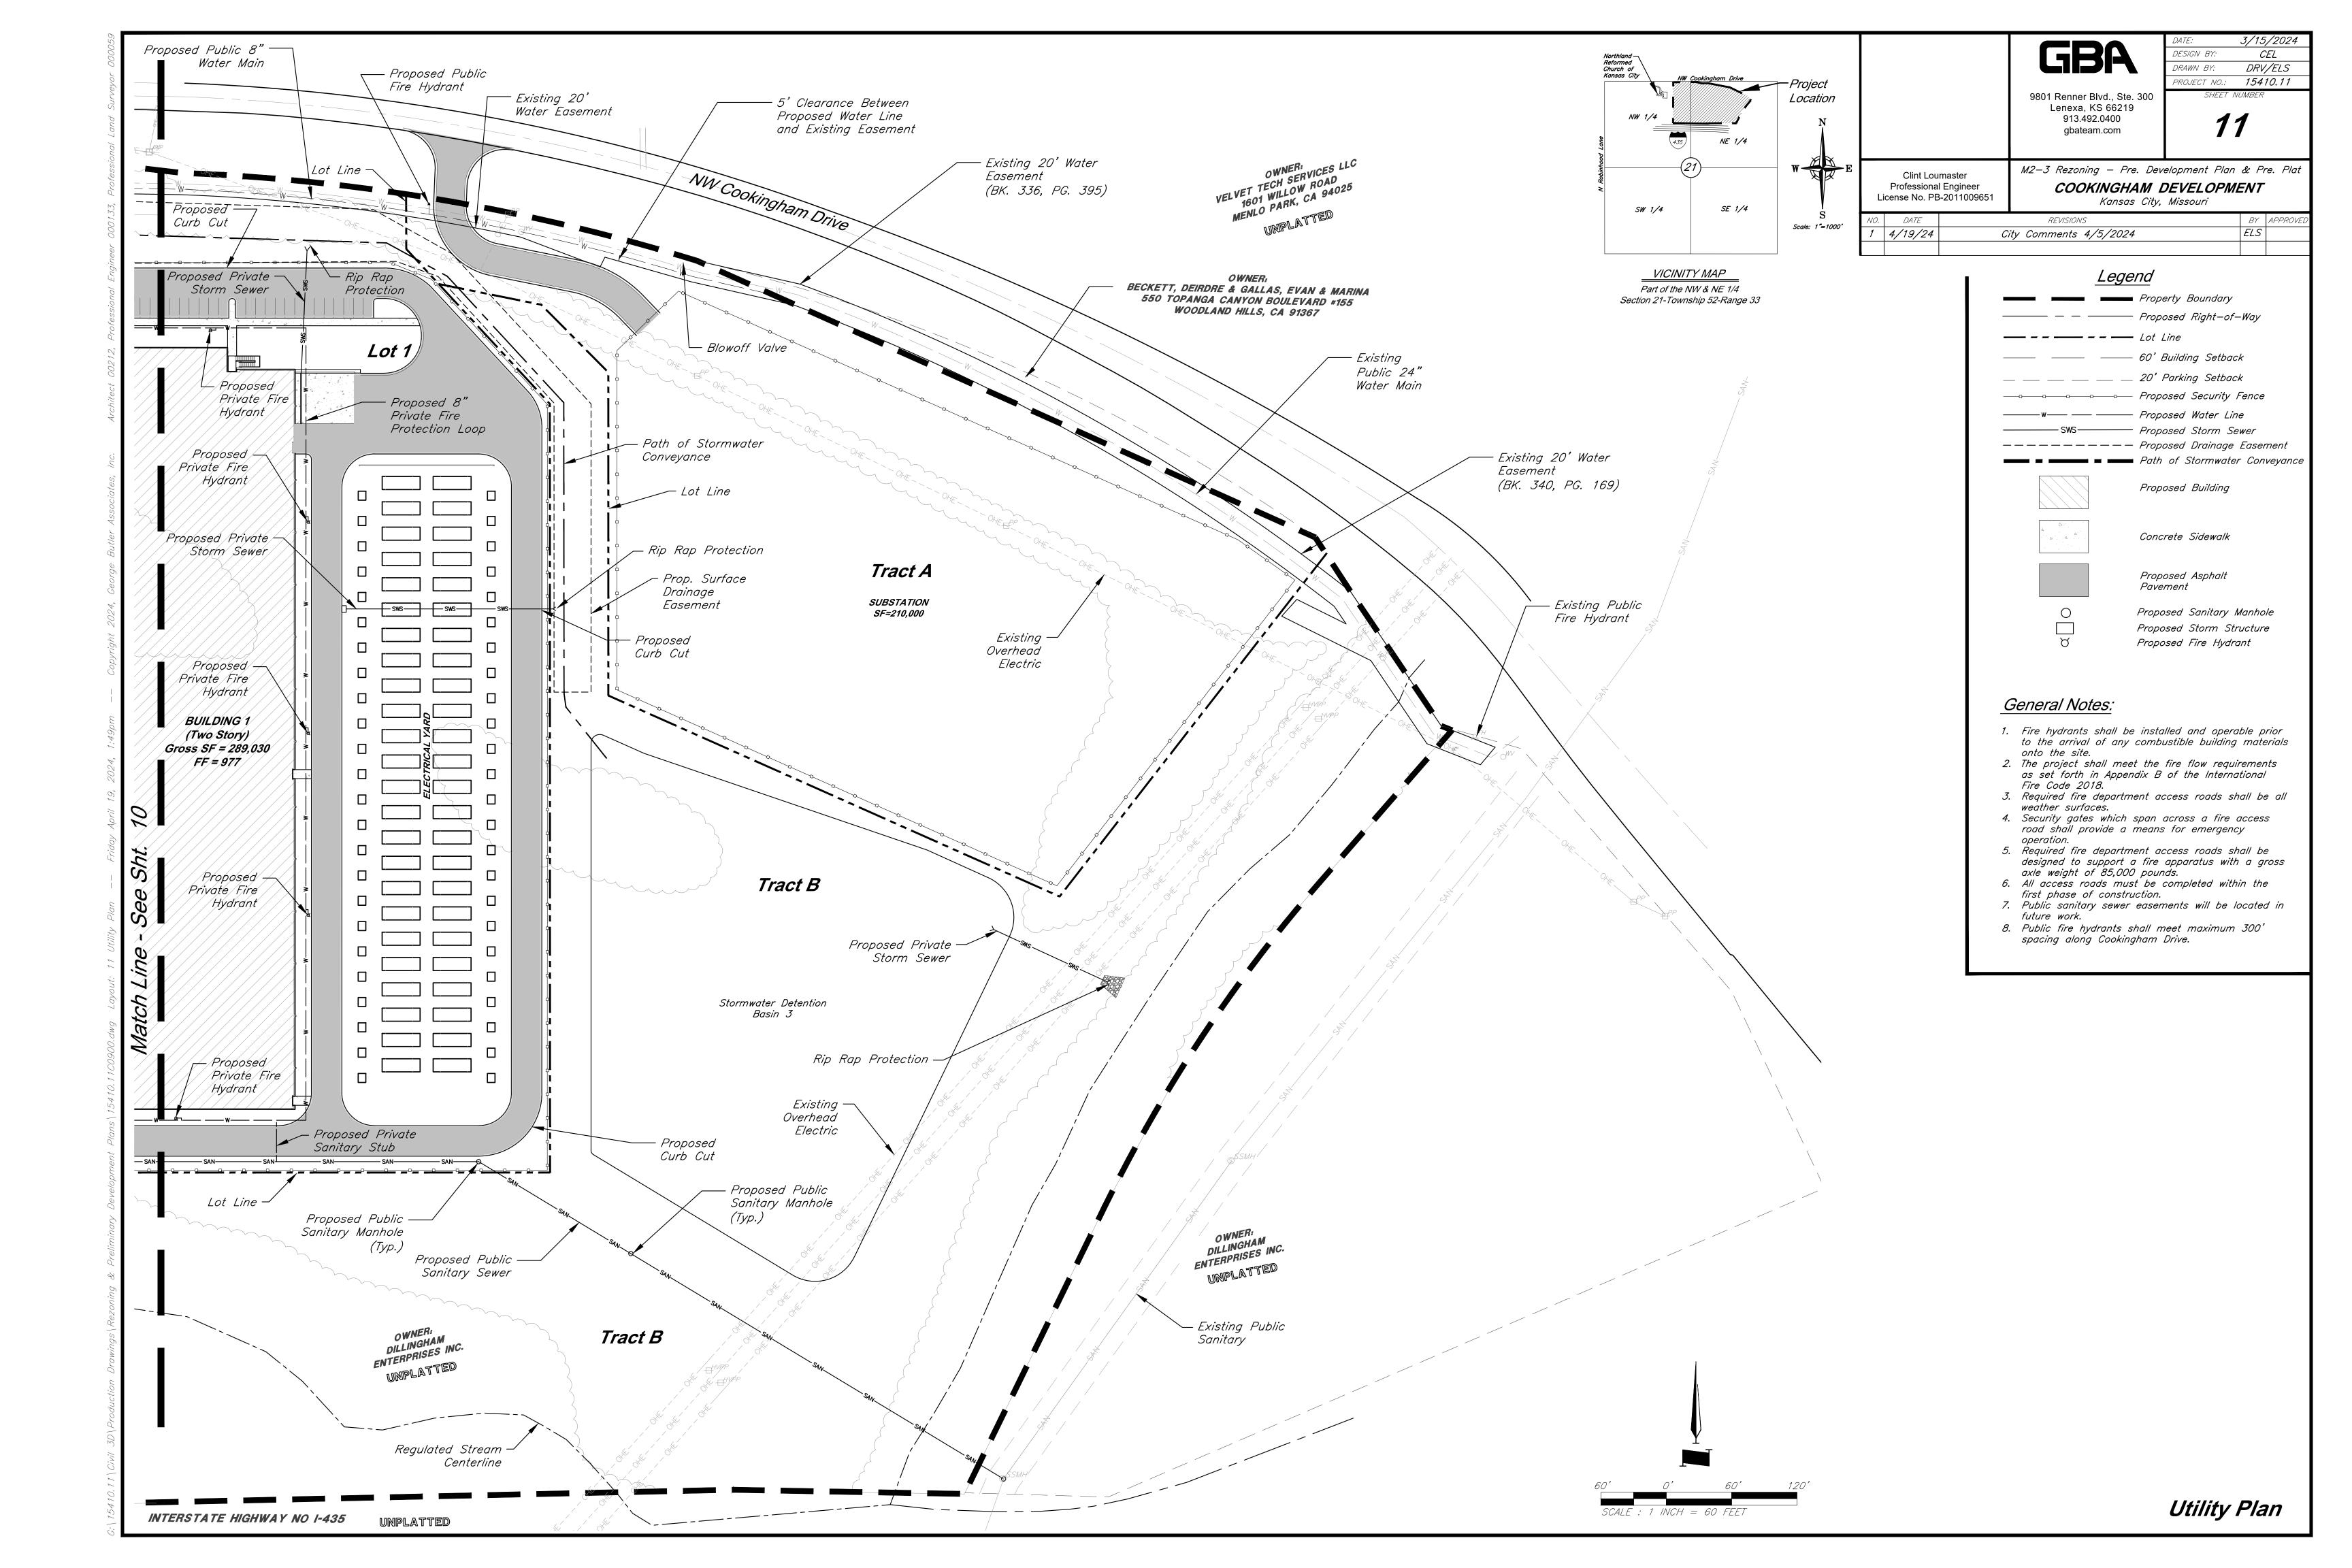

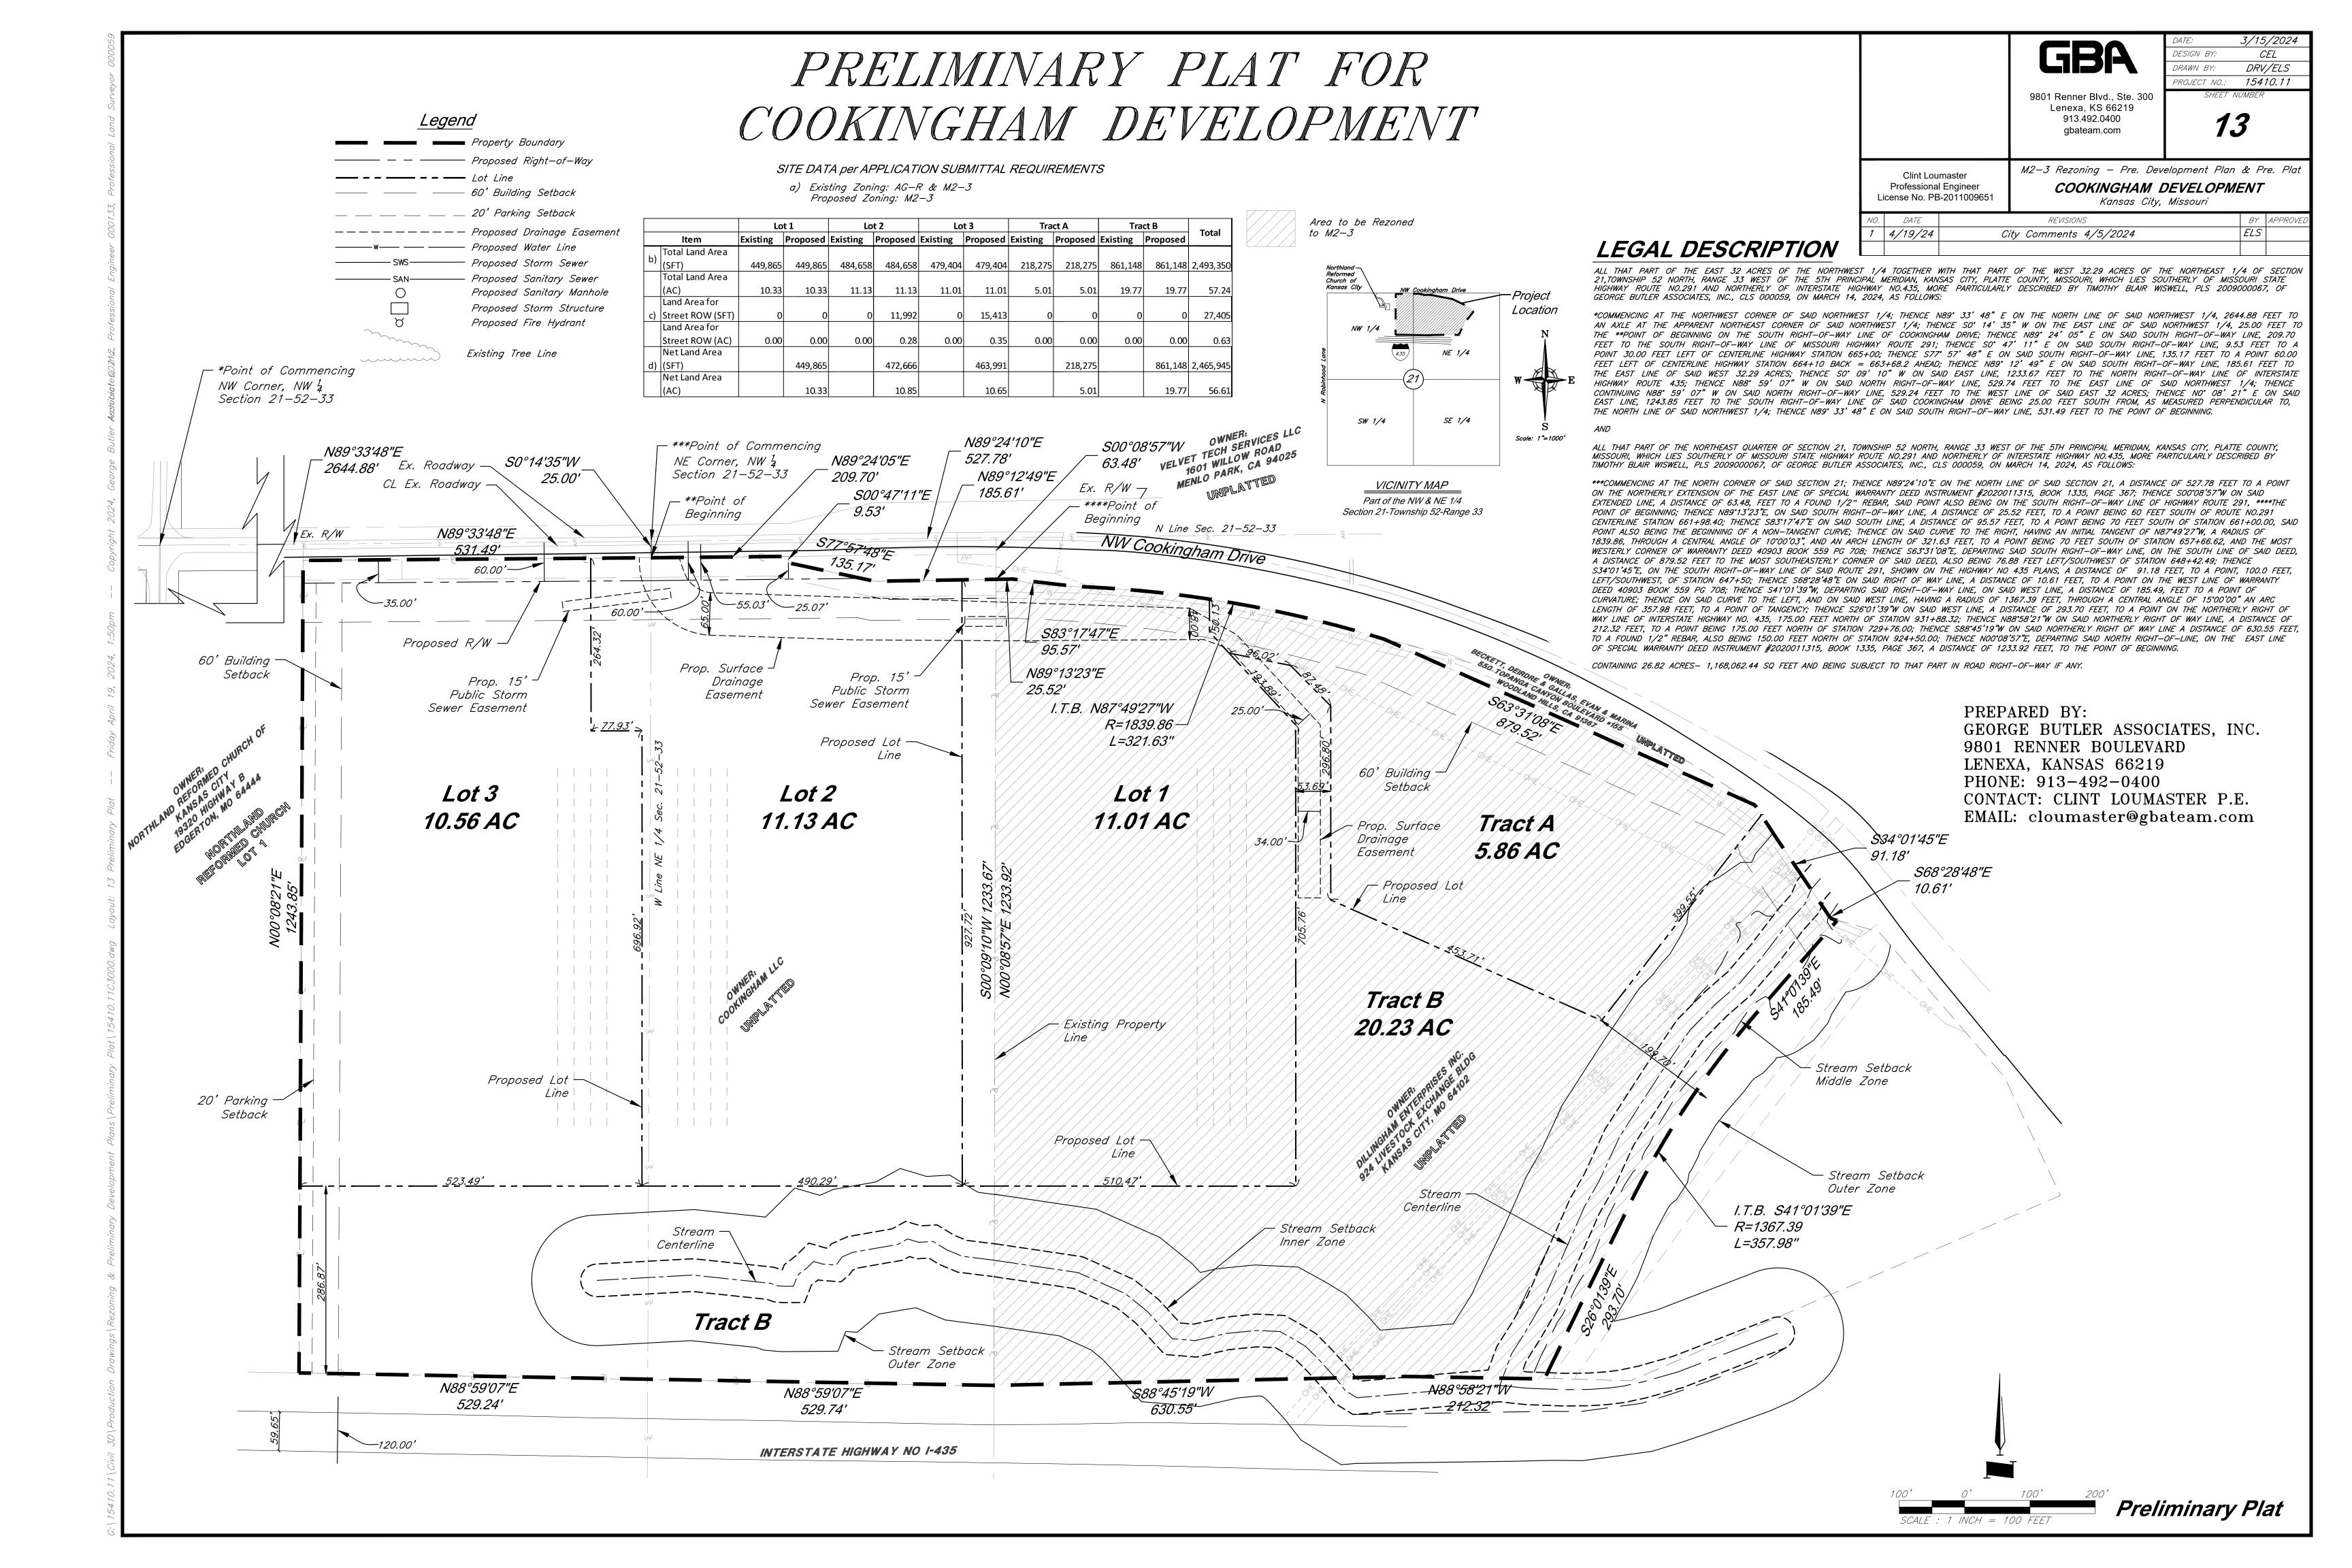

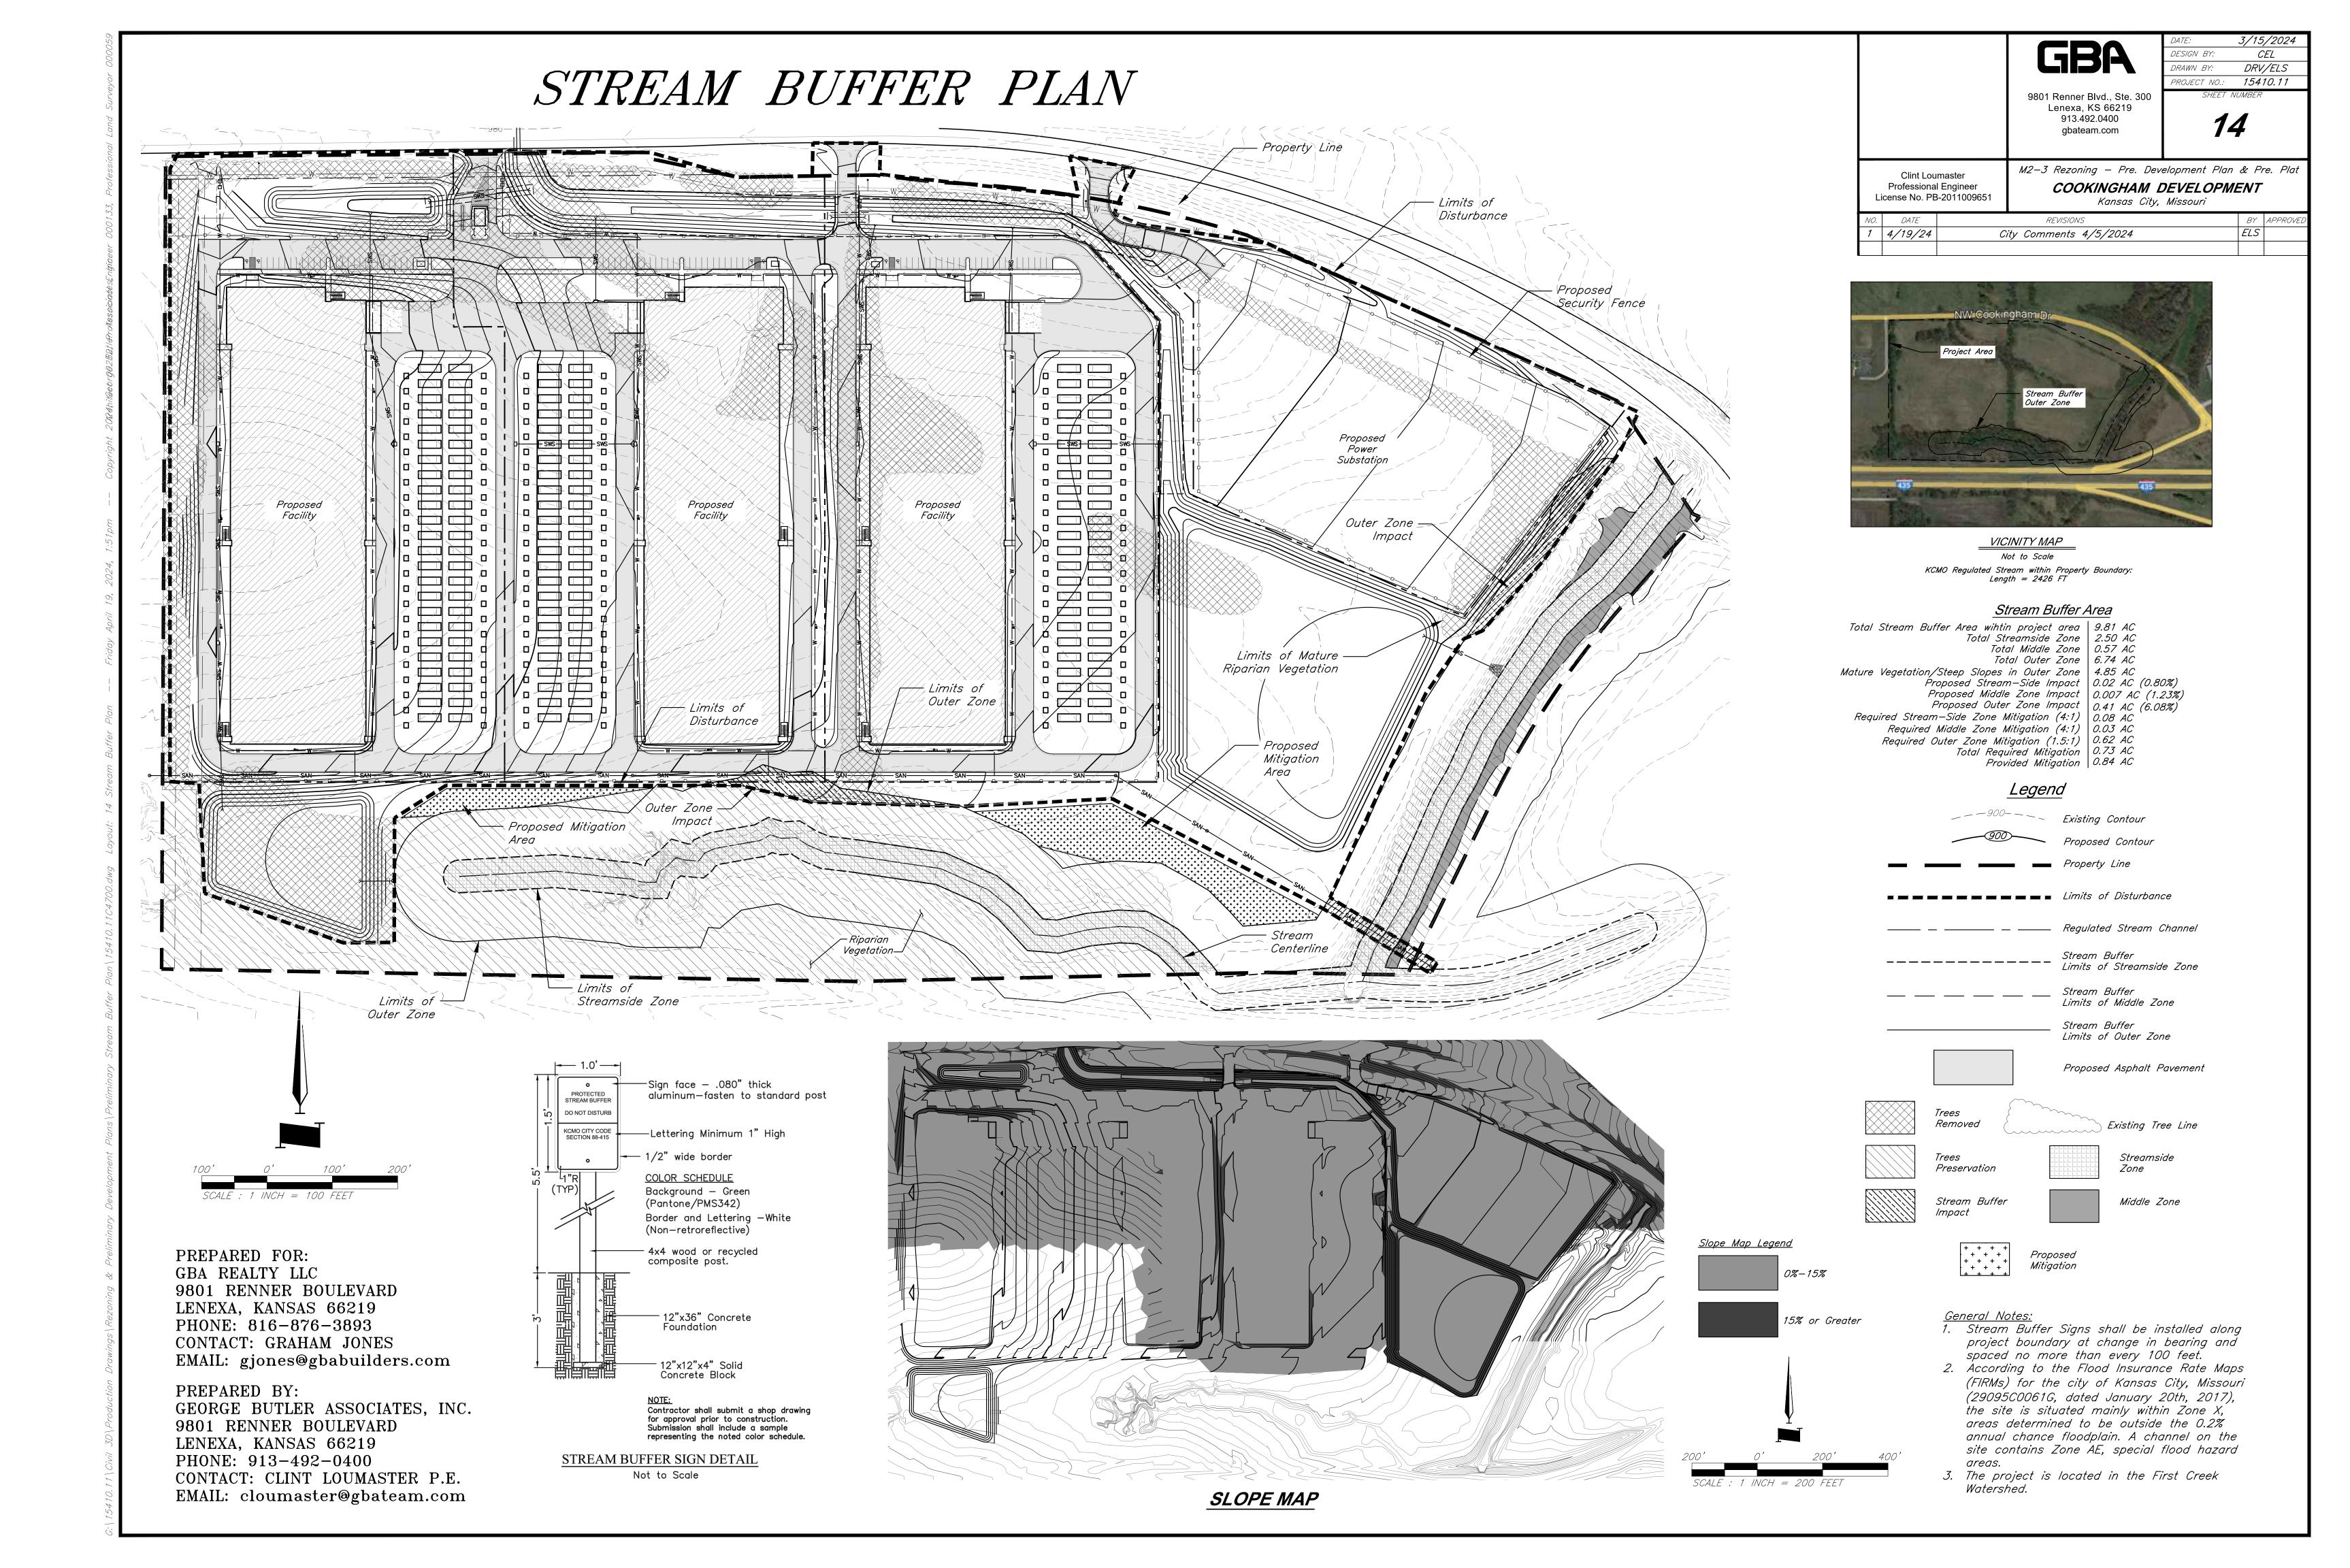

	Light Fixture Schedule									
D	DESCRIPTION	MOUNTING	LAMP TYPE	VOLTAGE	WATTS	MANUFACTURER	CATALOG NUMBER			
SL1	SINGLE-TYPE 3-20'-0" POLE MOUNTED	POLE	LED	MVOLT	98	LITHONIA	ESX1 LED P2			
SL2	SINGLE-TYPE 3-30'-0" POLE MOUNTED	POLE	LED	MVOLT	99	LITHONIA	ESX1 LED P2			
WP1	WALL PACK-WEDGE	WALL	LED	MVOLT	18	LITHONIA	WDGE2 P3 LED 40K 80CRI T3M MVOLT			
BL1	ROUND BOLLARD 40"	GRADE	LED	MVOLT	16	LITHONIA	KBR8 LED 12C 350 40K ASY MVOLT			
CP1	CANOPY	SURFACE	LED	MVOIT	17	LITHONIA	VCPG V4 P1 40K 80CRLT5W MVOLT			

9801 Renner Blvd. Lenexa, Kansas 66219

SYMBOL LIST

SYMBOL

DESCRIPTION

SINGLE POLE MOUNTED LUMINAIRE

DOUBLE POLE MOUNTED LUMINAIRE

DOUBLE POLE MOUNTED LUMINAIRE

WALL MOUNTED LUNIAIRE (MOUNTING HEIGHT AS INDICATED)

TWO OAKS DESIGN & CONSULTING

4826 ACADEMY DRIVE MADISON, WI 53716

# COOKINGHAM DEVELOPMENT KANSAS CITY, MISSOU

CHECKED BY JP
ISSUE DATE 03/12/24
REVISIONS

NO. DATE DESCRIPTION

SHEET TITLE:

ELECTRICAL


POINT BY POINT

PHOTOMETRIC SITE PLAN

WEST

ESL1.1

SHEET NO

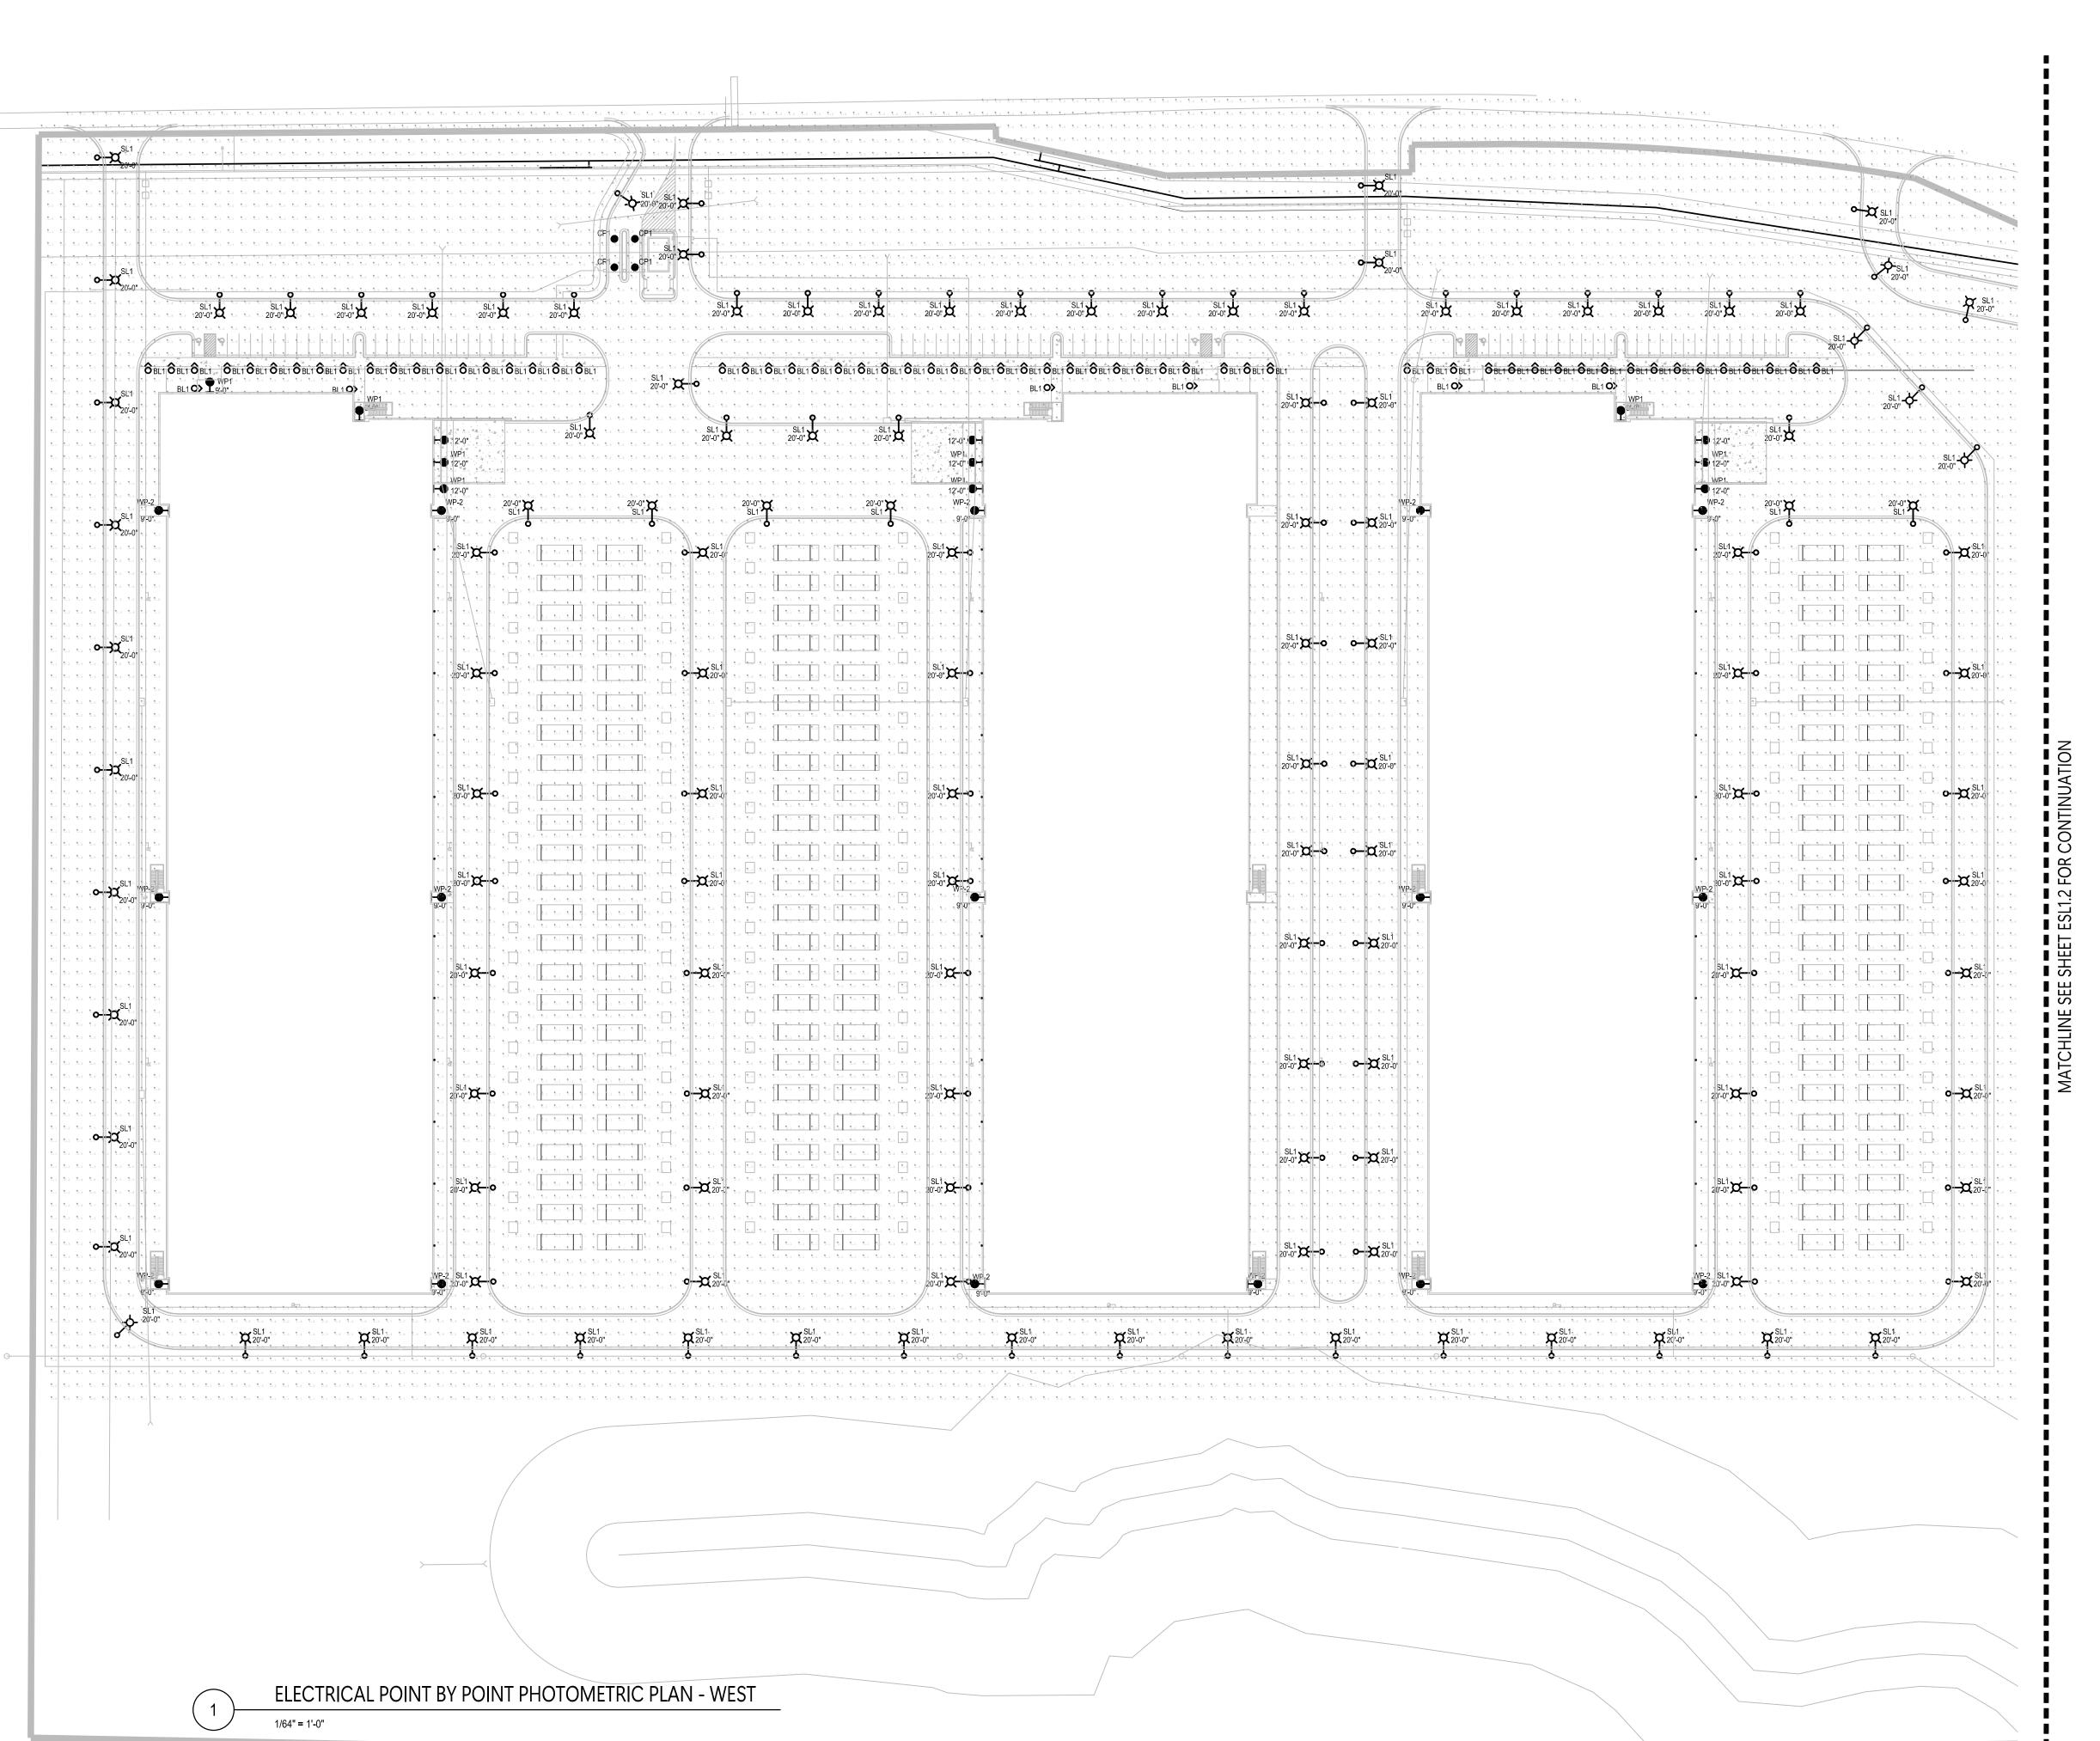

**GBA Realty** 

9801 Renner Blvd. Lenexa, Kansas 66219

TWO DESIGN & CONSULTING

4826 ACADEMY DRIVE MADISON, WI 53716

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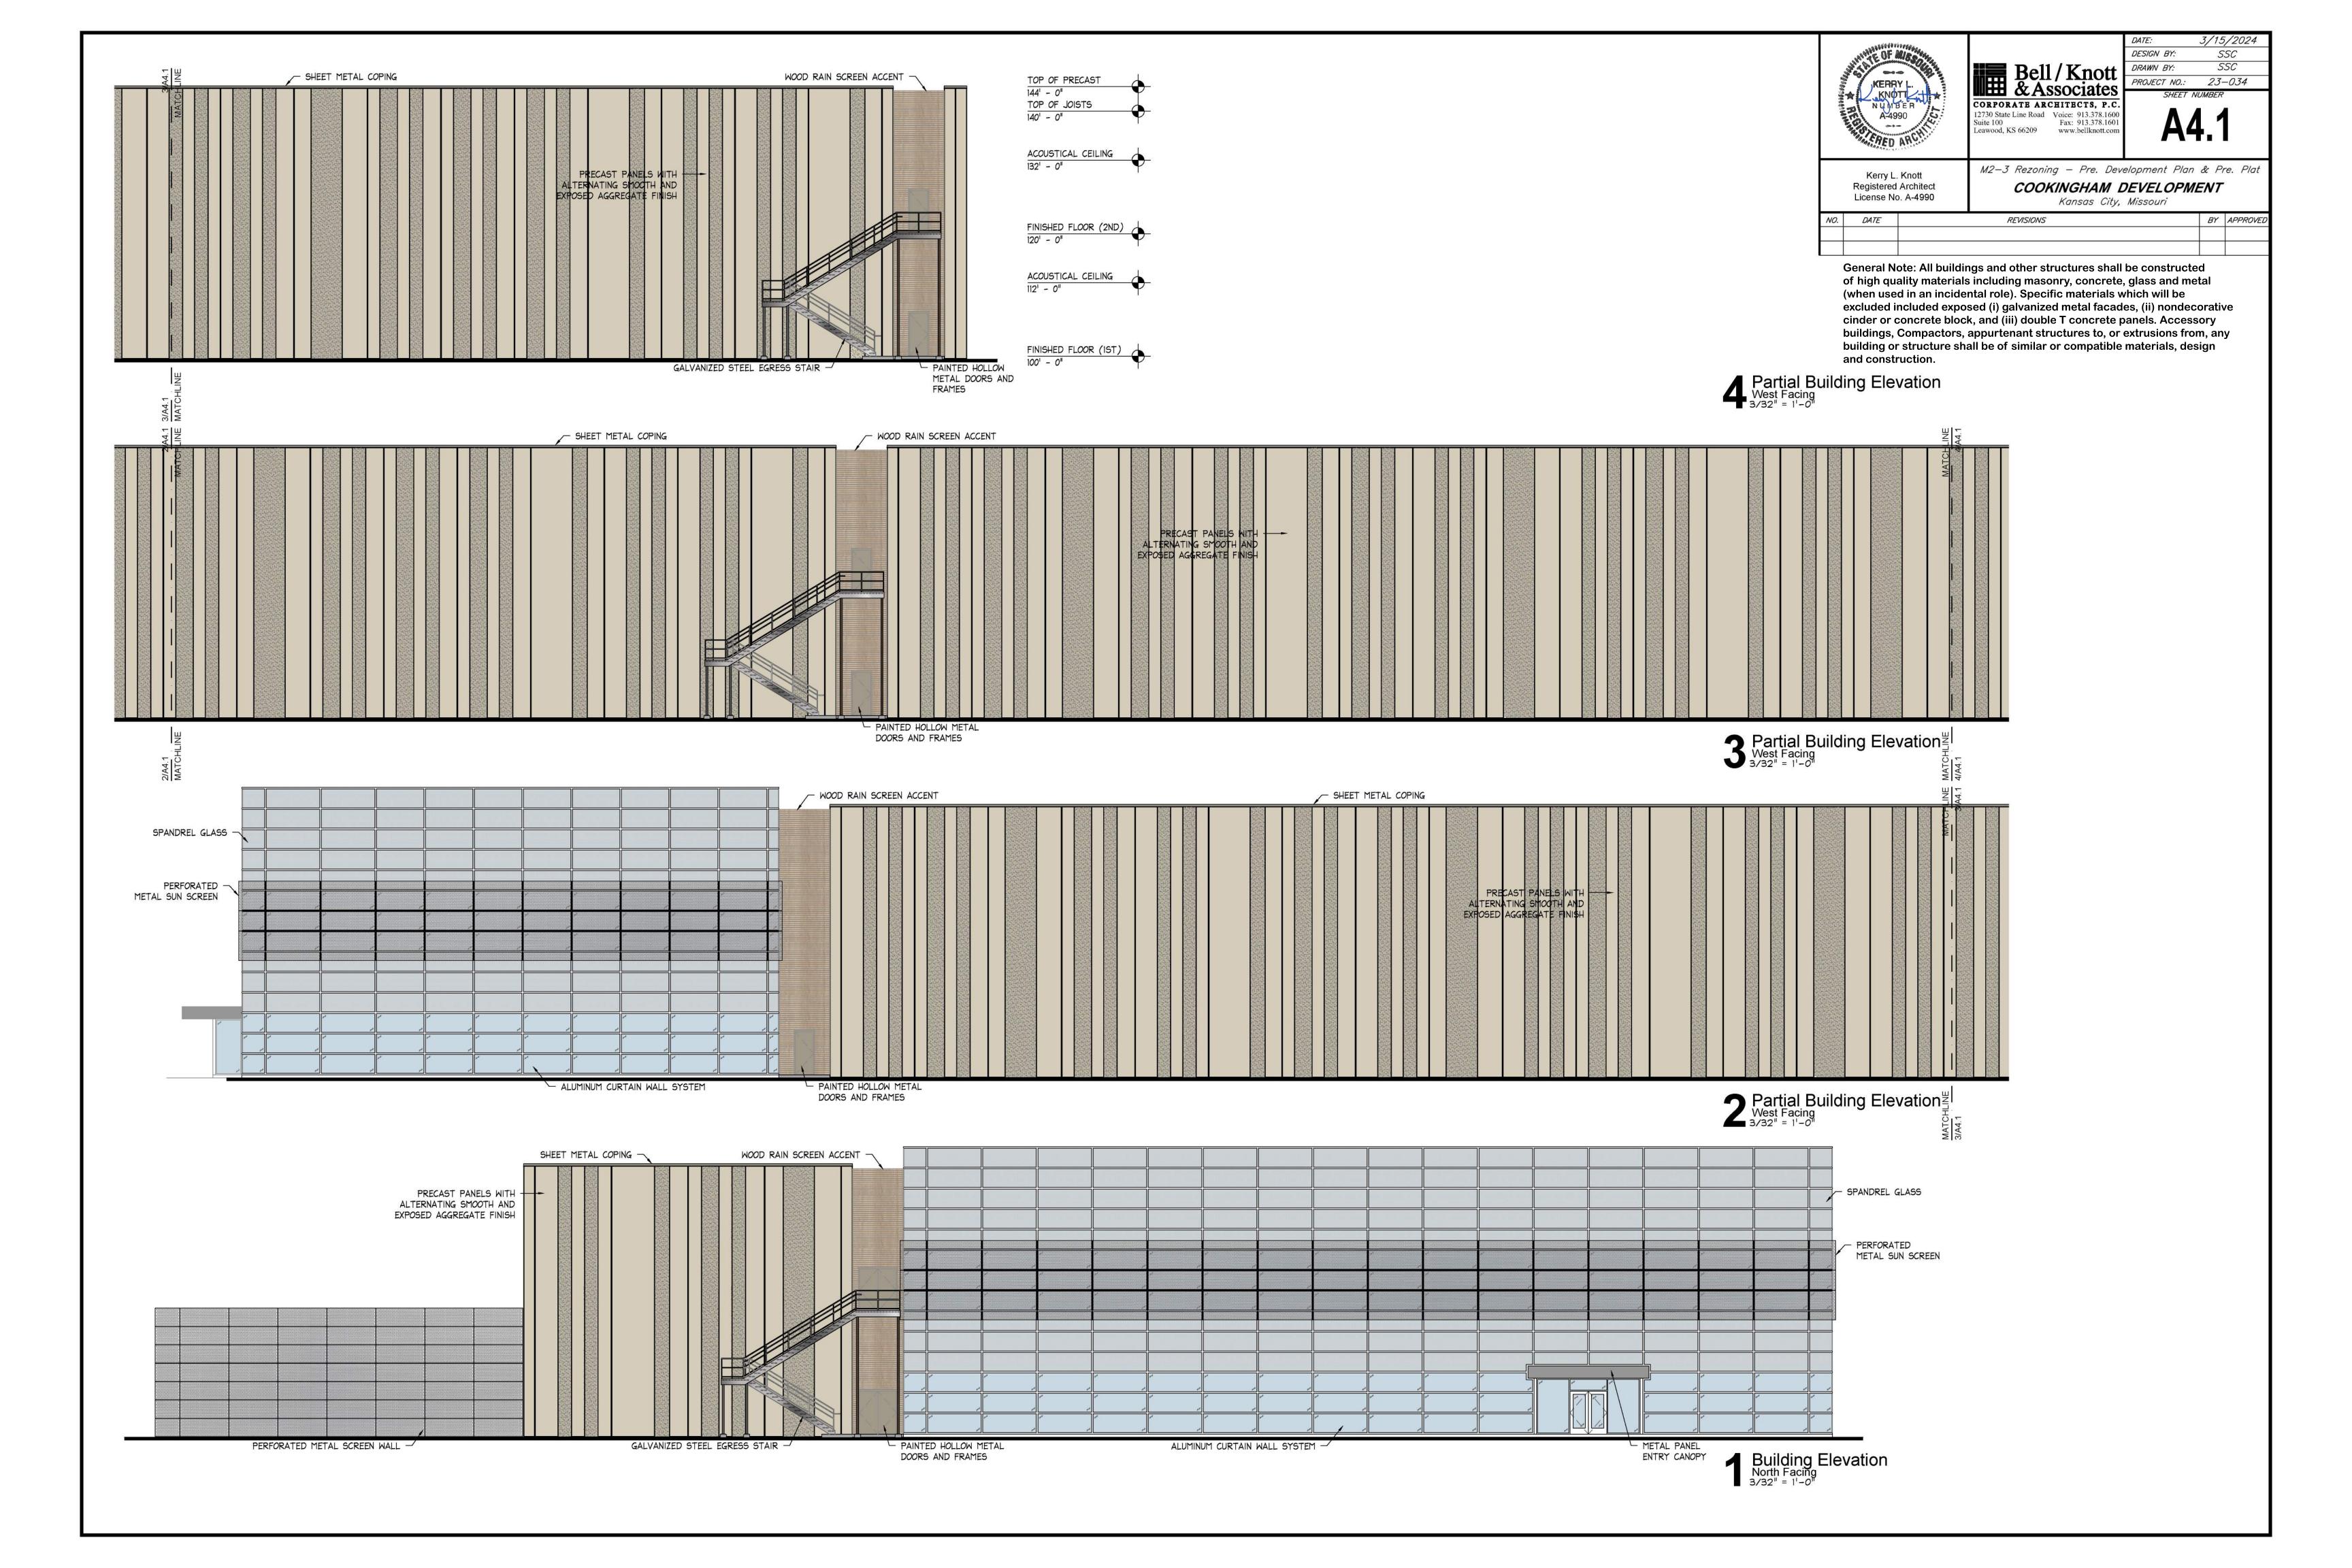
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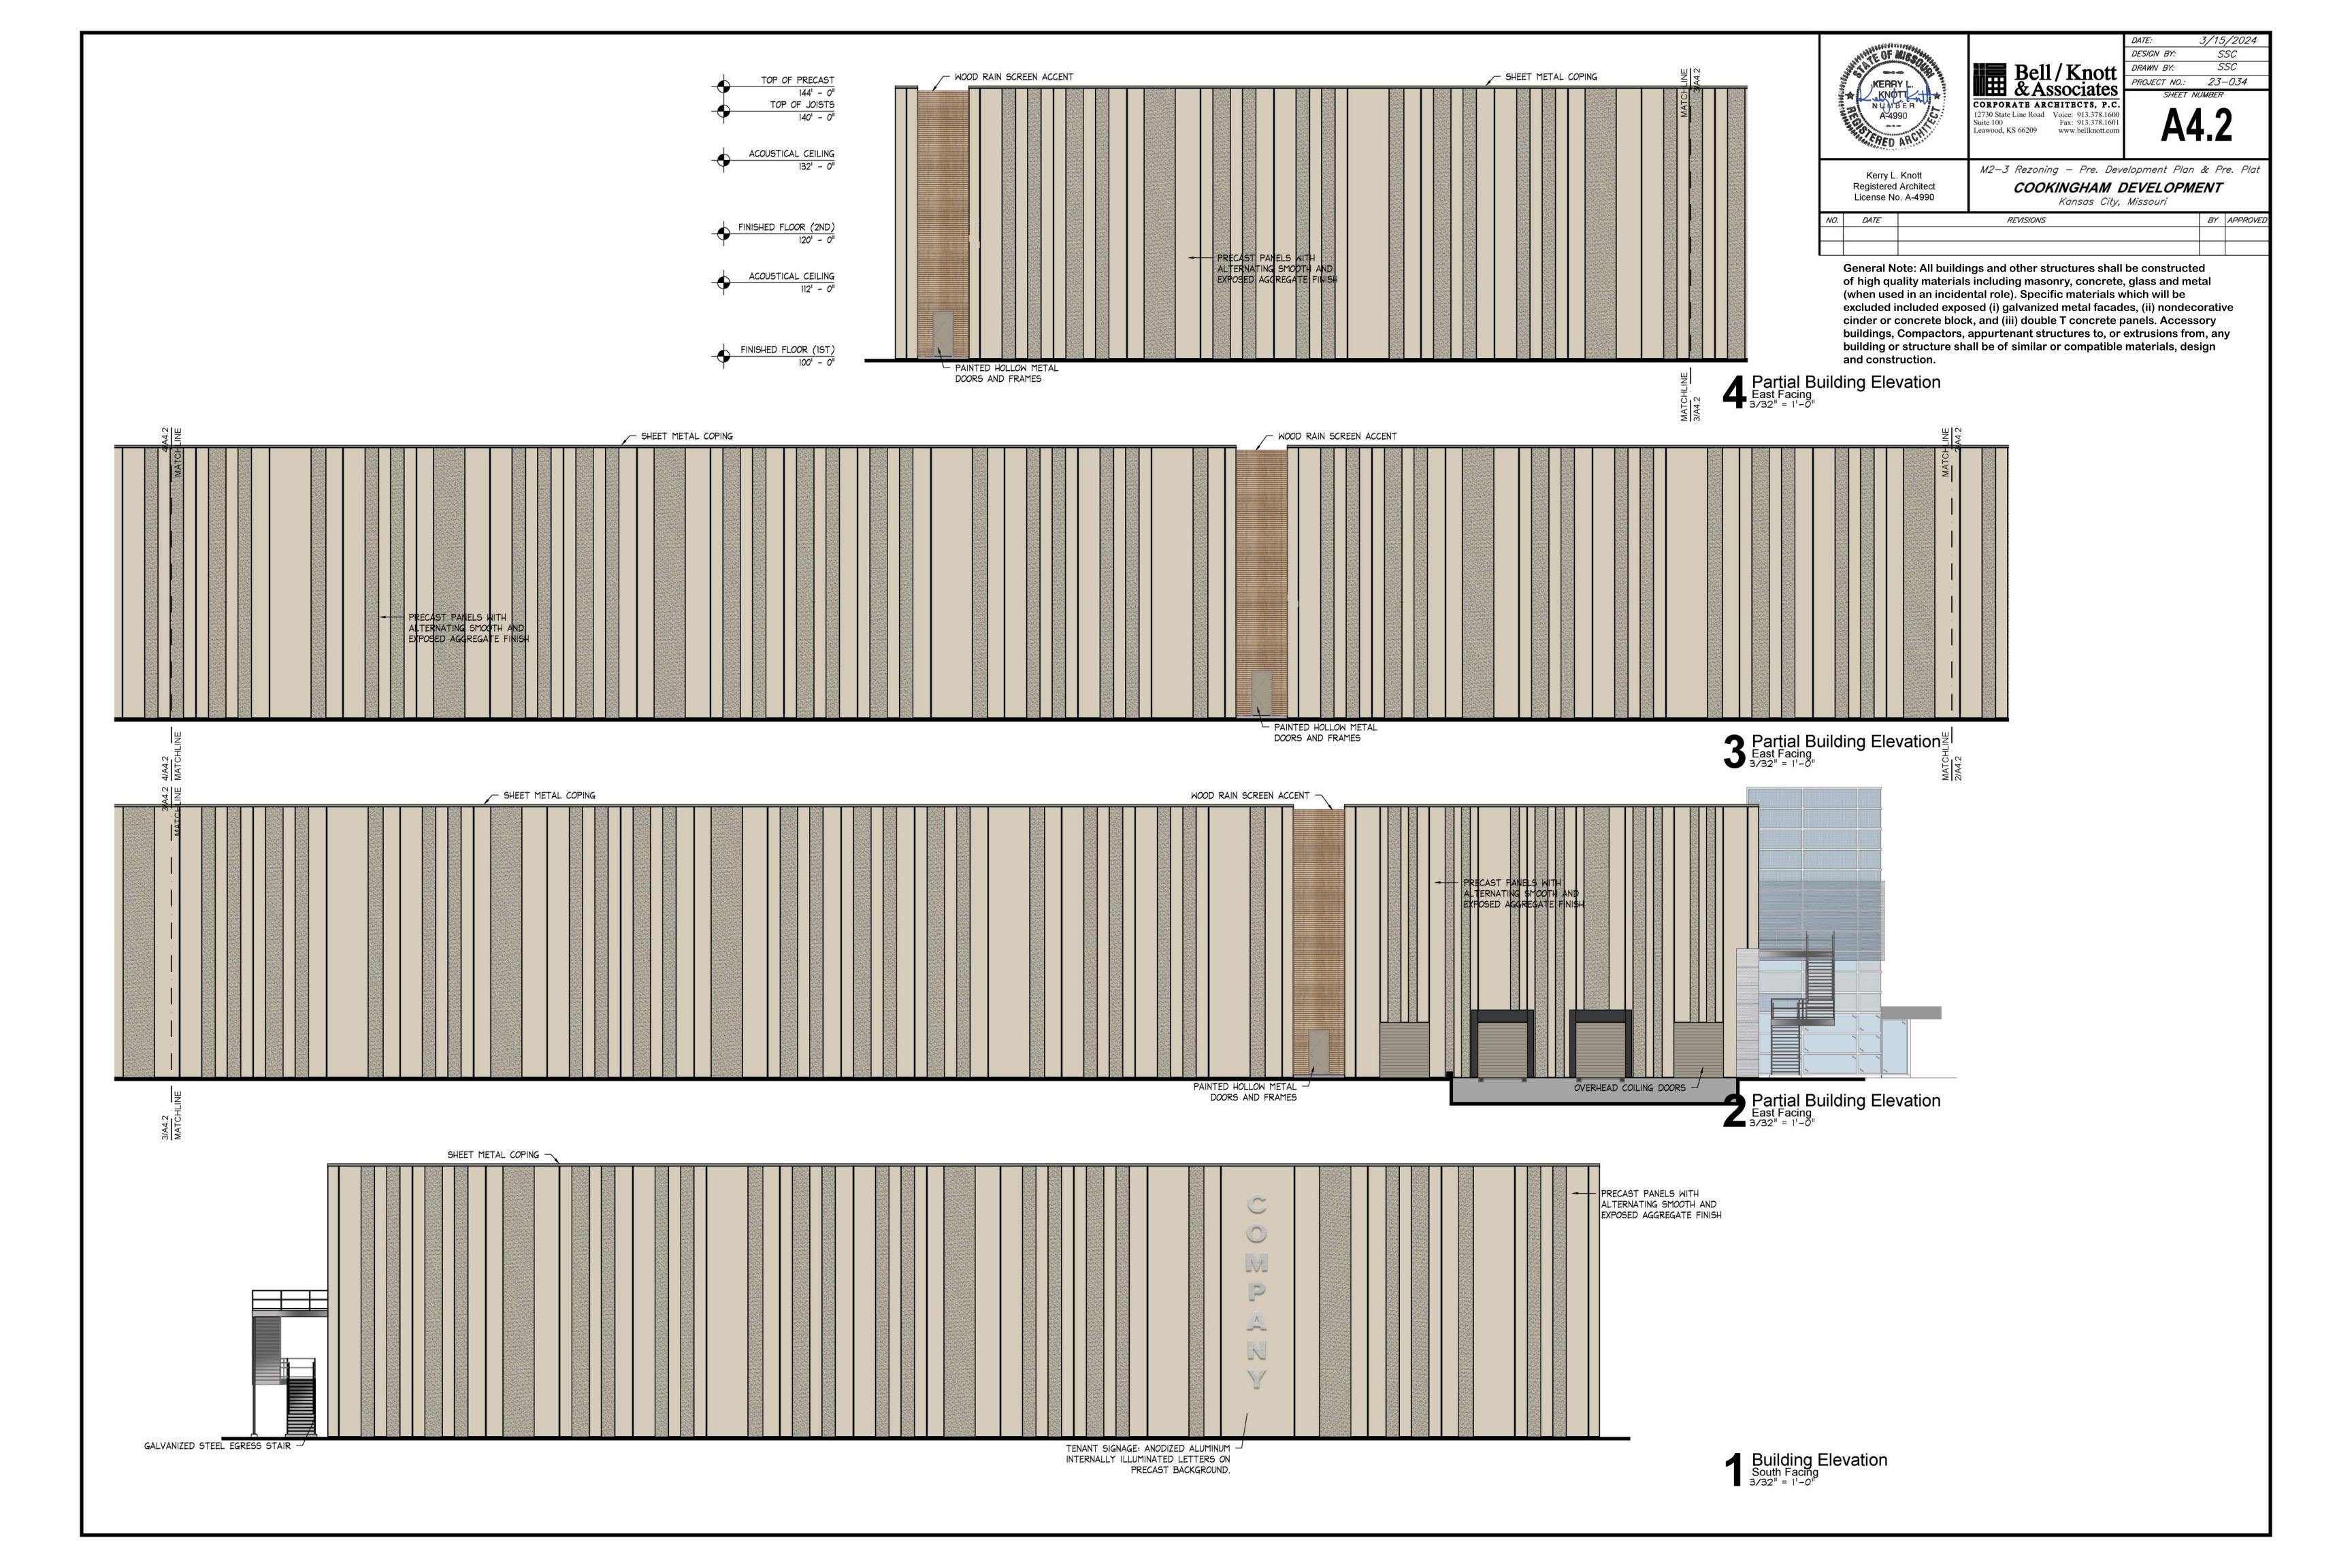
PHOTOMETRIC SITE PLAN

ESL1.2

SHEET NO

ELECTRICAL POINT BY POINT PHOTOMETRIC PLAN - EAST











### Public Meeting Summary Form

Project Case #
Meeting Date:
Meeting Location:
Meeting Time (include start and end time):
Additional Comments (optional):

### Meeting Sign-In Sheet

Project Name and Ad	ddress		

Address	Phone	Email