
PRELIMINARY DEVELOPMENT PLAN & PRELIMINARY PLAT FOR COOKINGHAM DEVELOPMENT

Part of the NW & NE 1/4
Section 21-Township 52S-Range 33E
in the
City of Kansas City
Platte County, Missouri

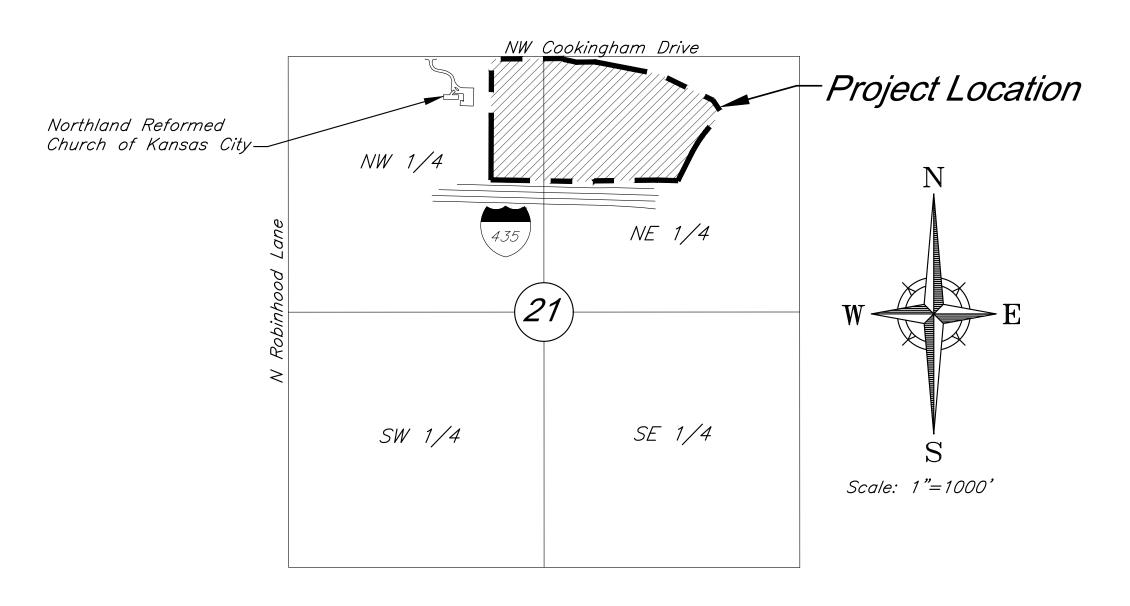

VICINITY MAP Part of the NW & NE 1/4 Section 21-Township 52-Range 33

INDEX OF SHEETS

Sht. No.	<u>Description</u>
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3	Phasing Plan
<i>4-5</i>	Site Plan
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7	Street Tree Plan
8	Planting Details
9-10	Grading Plan
<i>11-12</i>	Utility Plan
<i>13</i>	Tree Removal & Tree Preservation Plan
<i>14</i>	Preliminary Plat
<i>15</i>	Section Exhibit
<i>16</i>	Stream Buffer Plan
E1.1	Lighting Plan
E1.2	Lighting Plan
A4.1 - Color	Partial Building Elevations
A4.2 - Color	Partial Building Elevations
A4.3 - Color	Partial Building Elevations

PREPARED FOR:
GBA REALTY LLC
9801 RENNER BOULEVARD
LENEXA, KANSAS 66219
PHONE: 816-876-3893
CONTACT: GRAHAM JONES LEED AP
EMAIL: gjones@gbabuilders.com

PREPARED BY:
GEORGE BUTLER ASSOCIATES, INC.
9801 RENNER BOULEVARD
LENEXA, KANSAS 66219
PHONE: 913-492-0400
CONTACT: BRIAN BOYD
EMAIL: bboyd@gbateam.com

FLOODPLAIN:

According to the Flood Insurance Rate Maps (FIRMs) for the city of Kansas City, Missouri (29095C0061G, dated January 20th, 2017), the site is situated mainly within Zone X, areas determined to be outside the 0.2% annual chance floodplain. A channel on the site contains Zone AE, special flood hazard areas.

DEVIATIONS REQUESTED:

1. A deviation is requested to allow facilities up to 70 feet in height on each of the proposed

PROJECT ENGINEER: JAY HEALY, P.E.

DATE:


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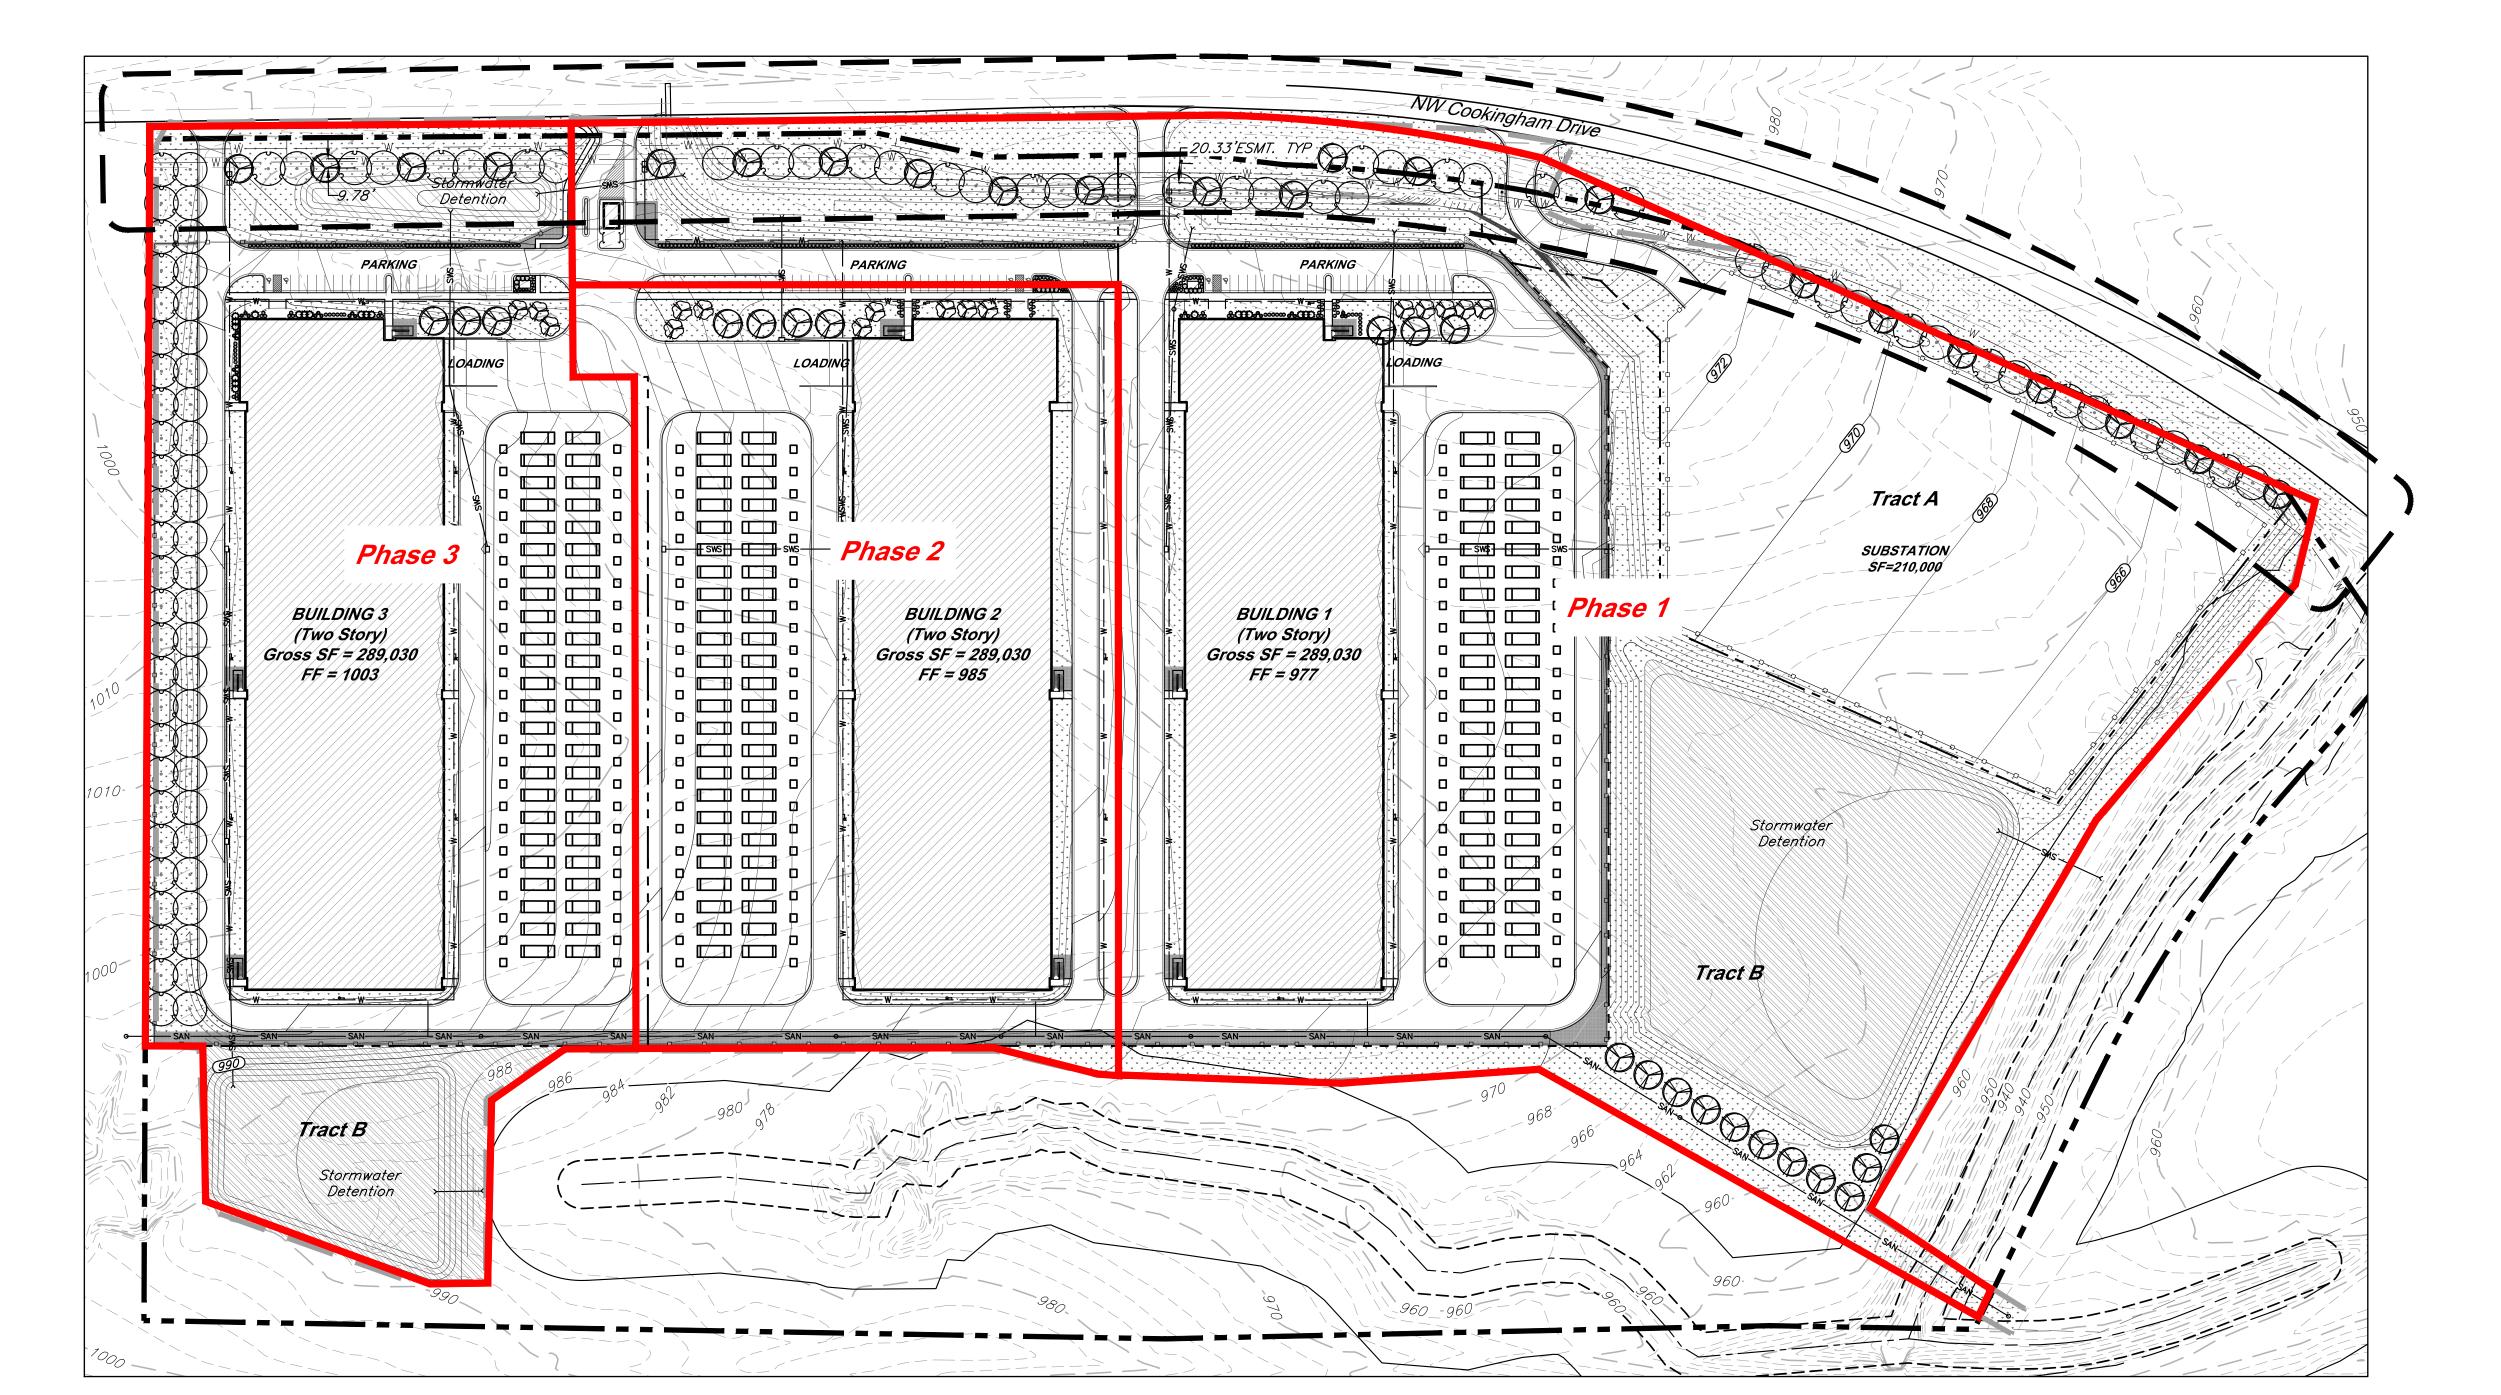
MANAGER, ENGINEERING SERVICES DIVISION:


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9801 Renner Boulevard Lenexa, Kansas 66219 9 1 3 . 4 9 2 . 0 4 0 0 www.gbateam.com





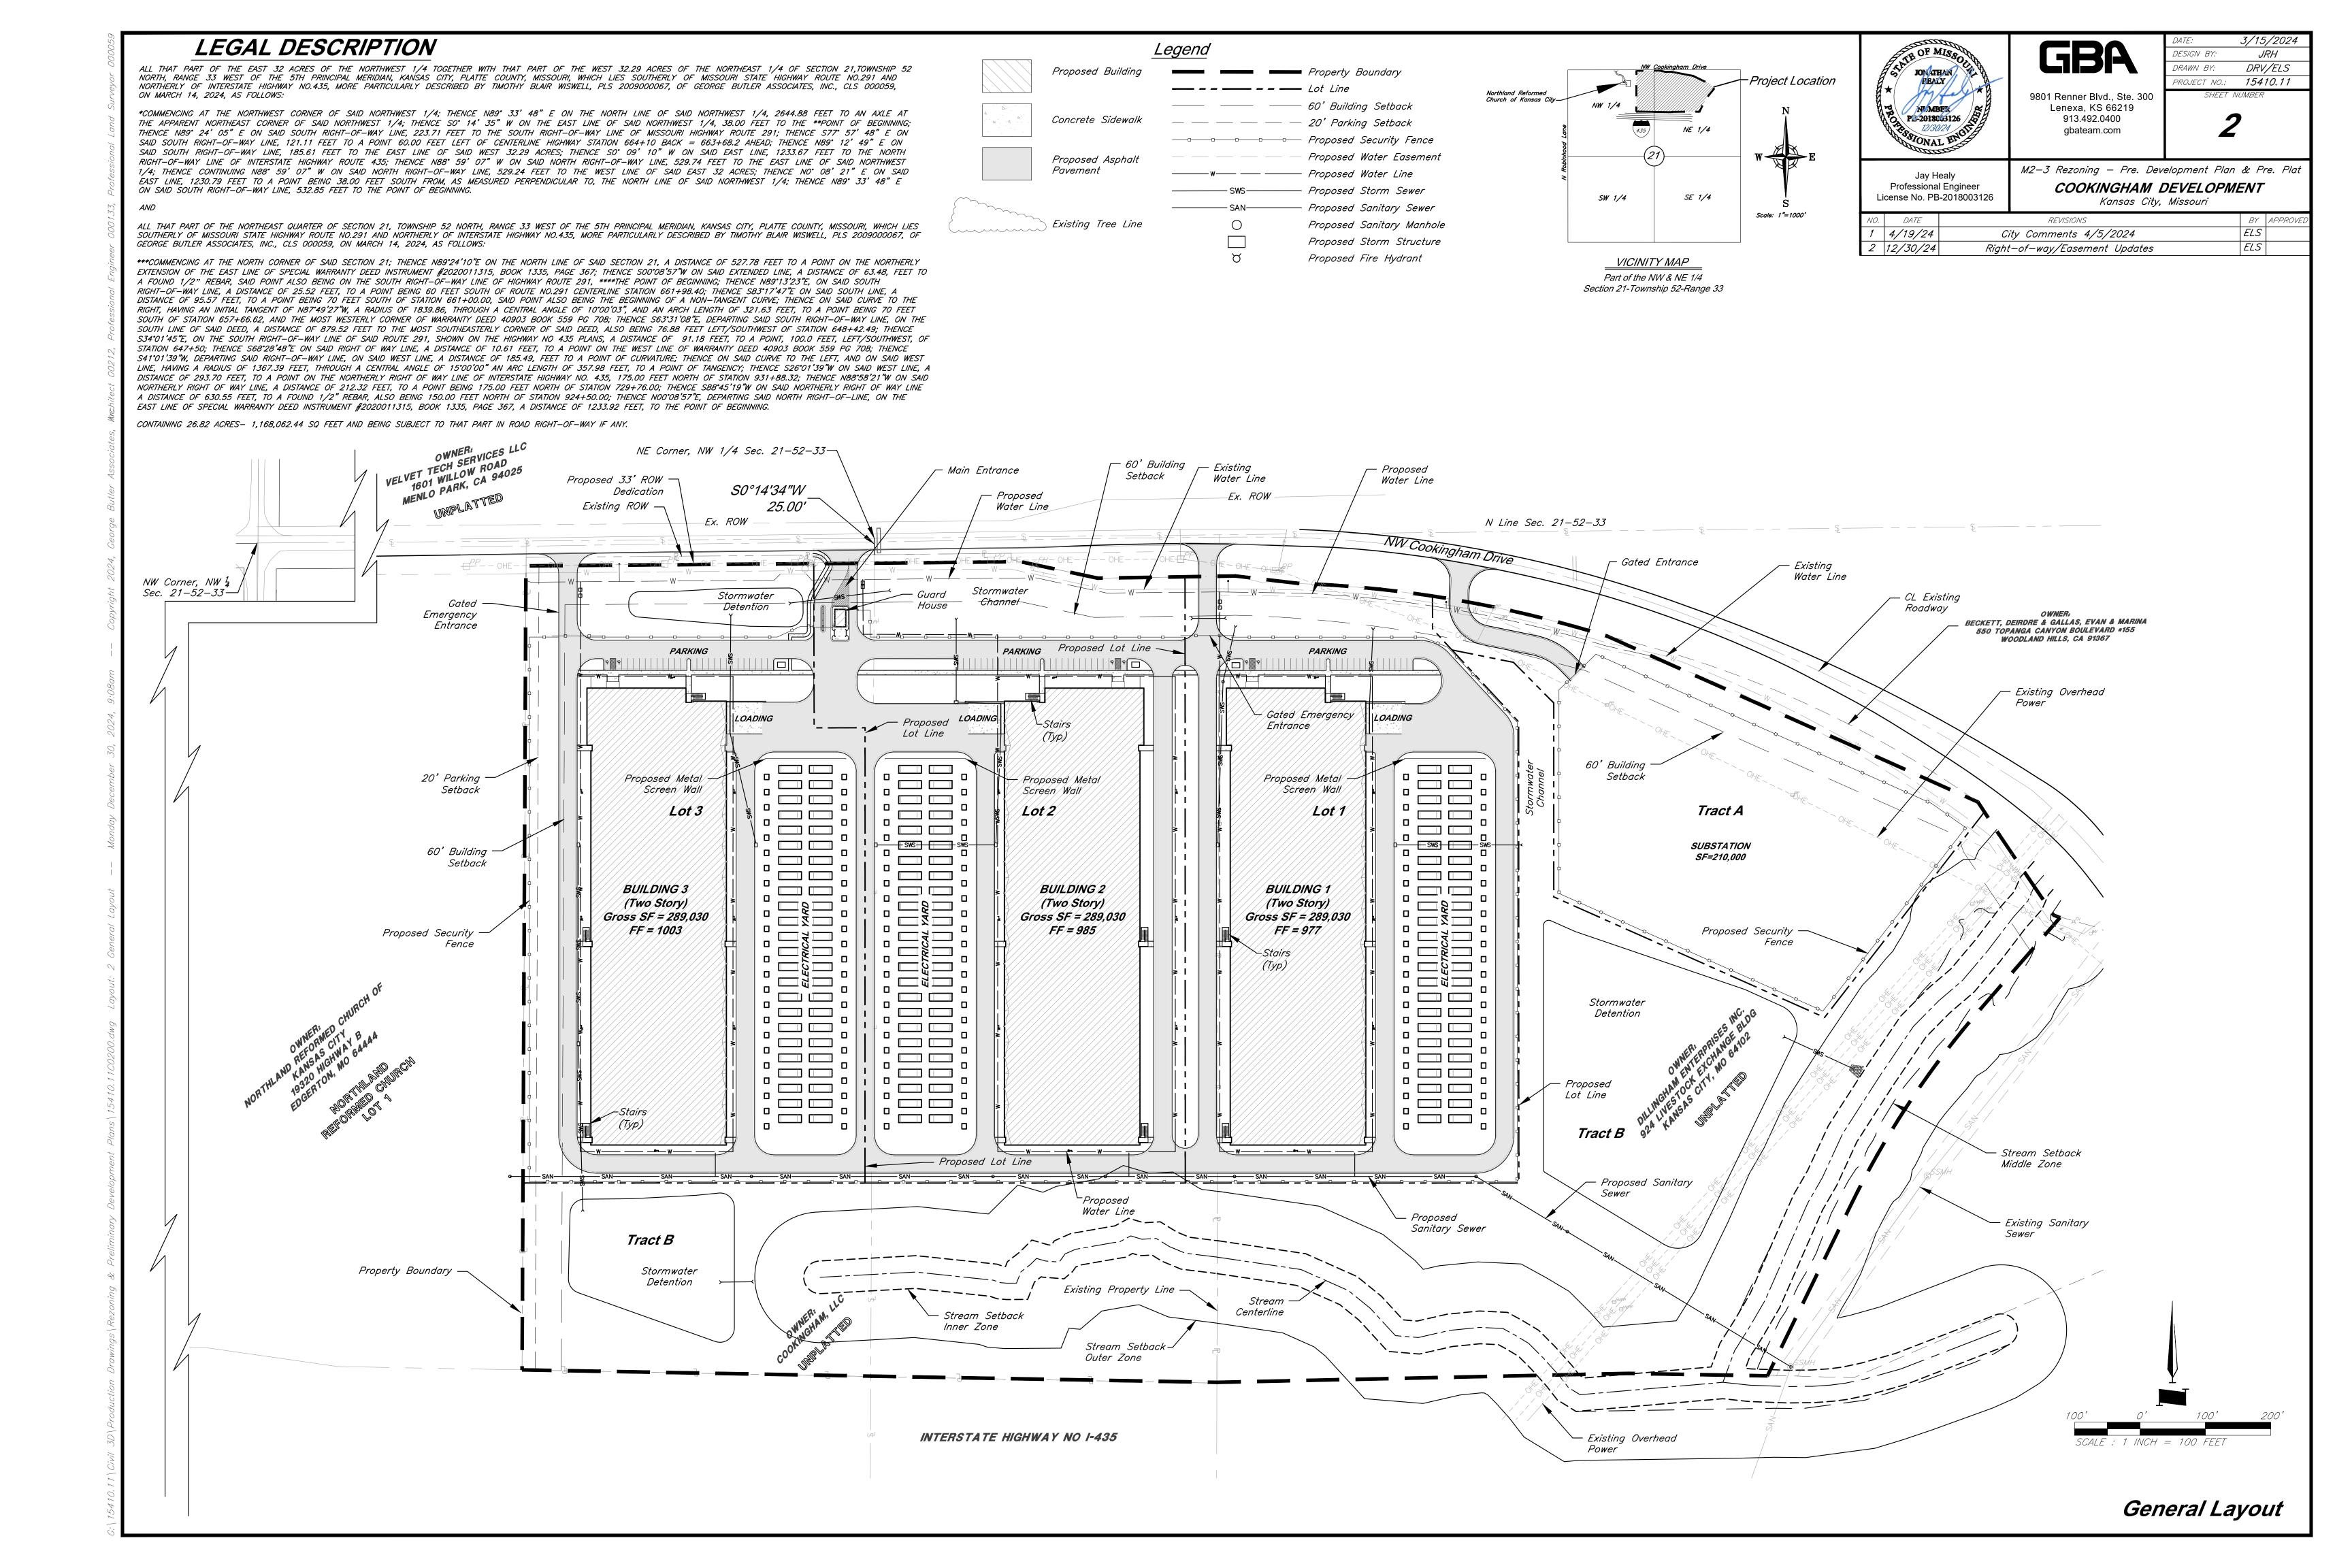

GBA 9801 Renner Blvd., Ste. 300 Lenexa, KS 66219

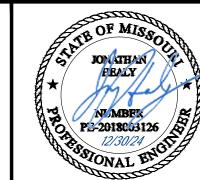913.492.0400 gbateam.com

DRV/ELS DRAWN BY: PROJECT NO.: 15410.11


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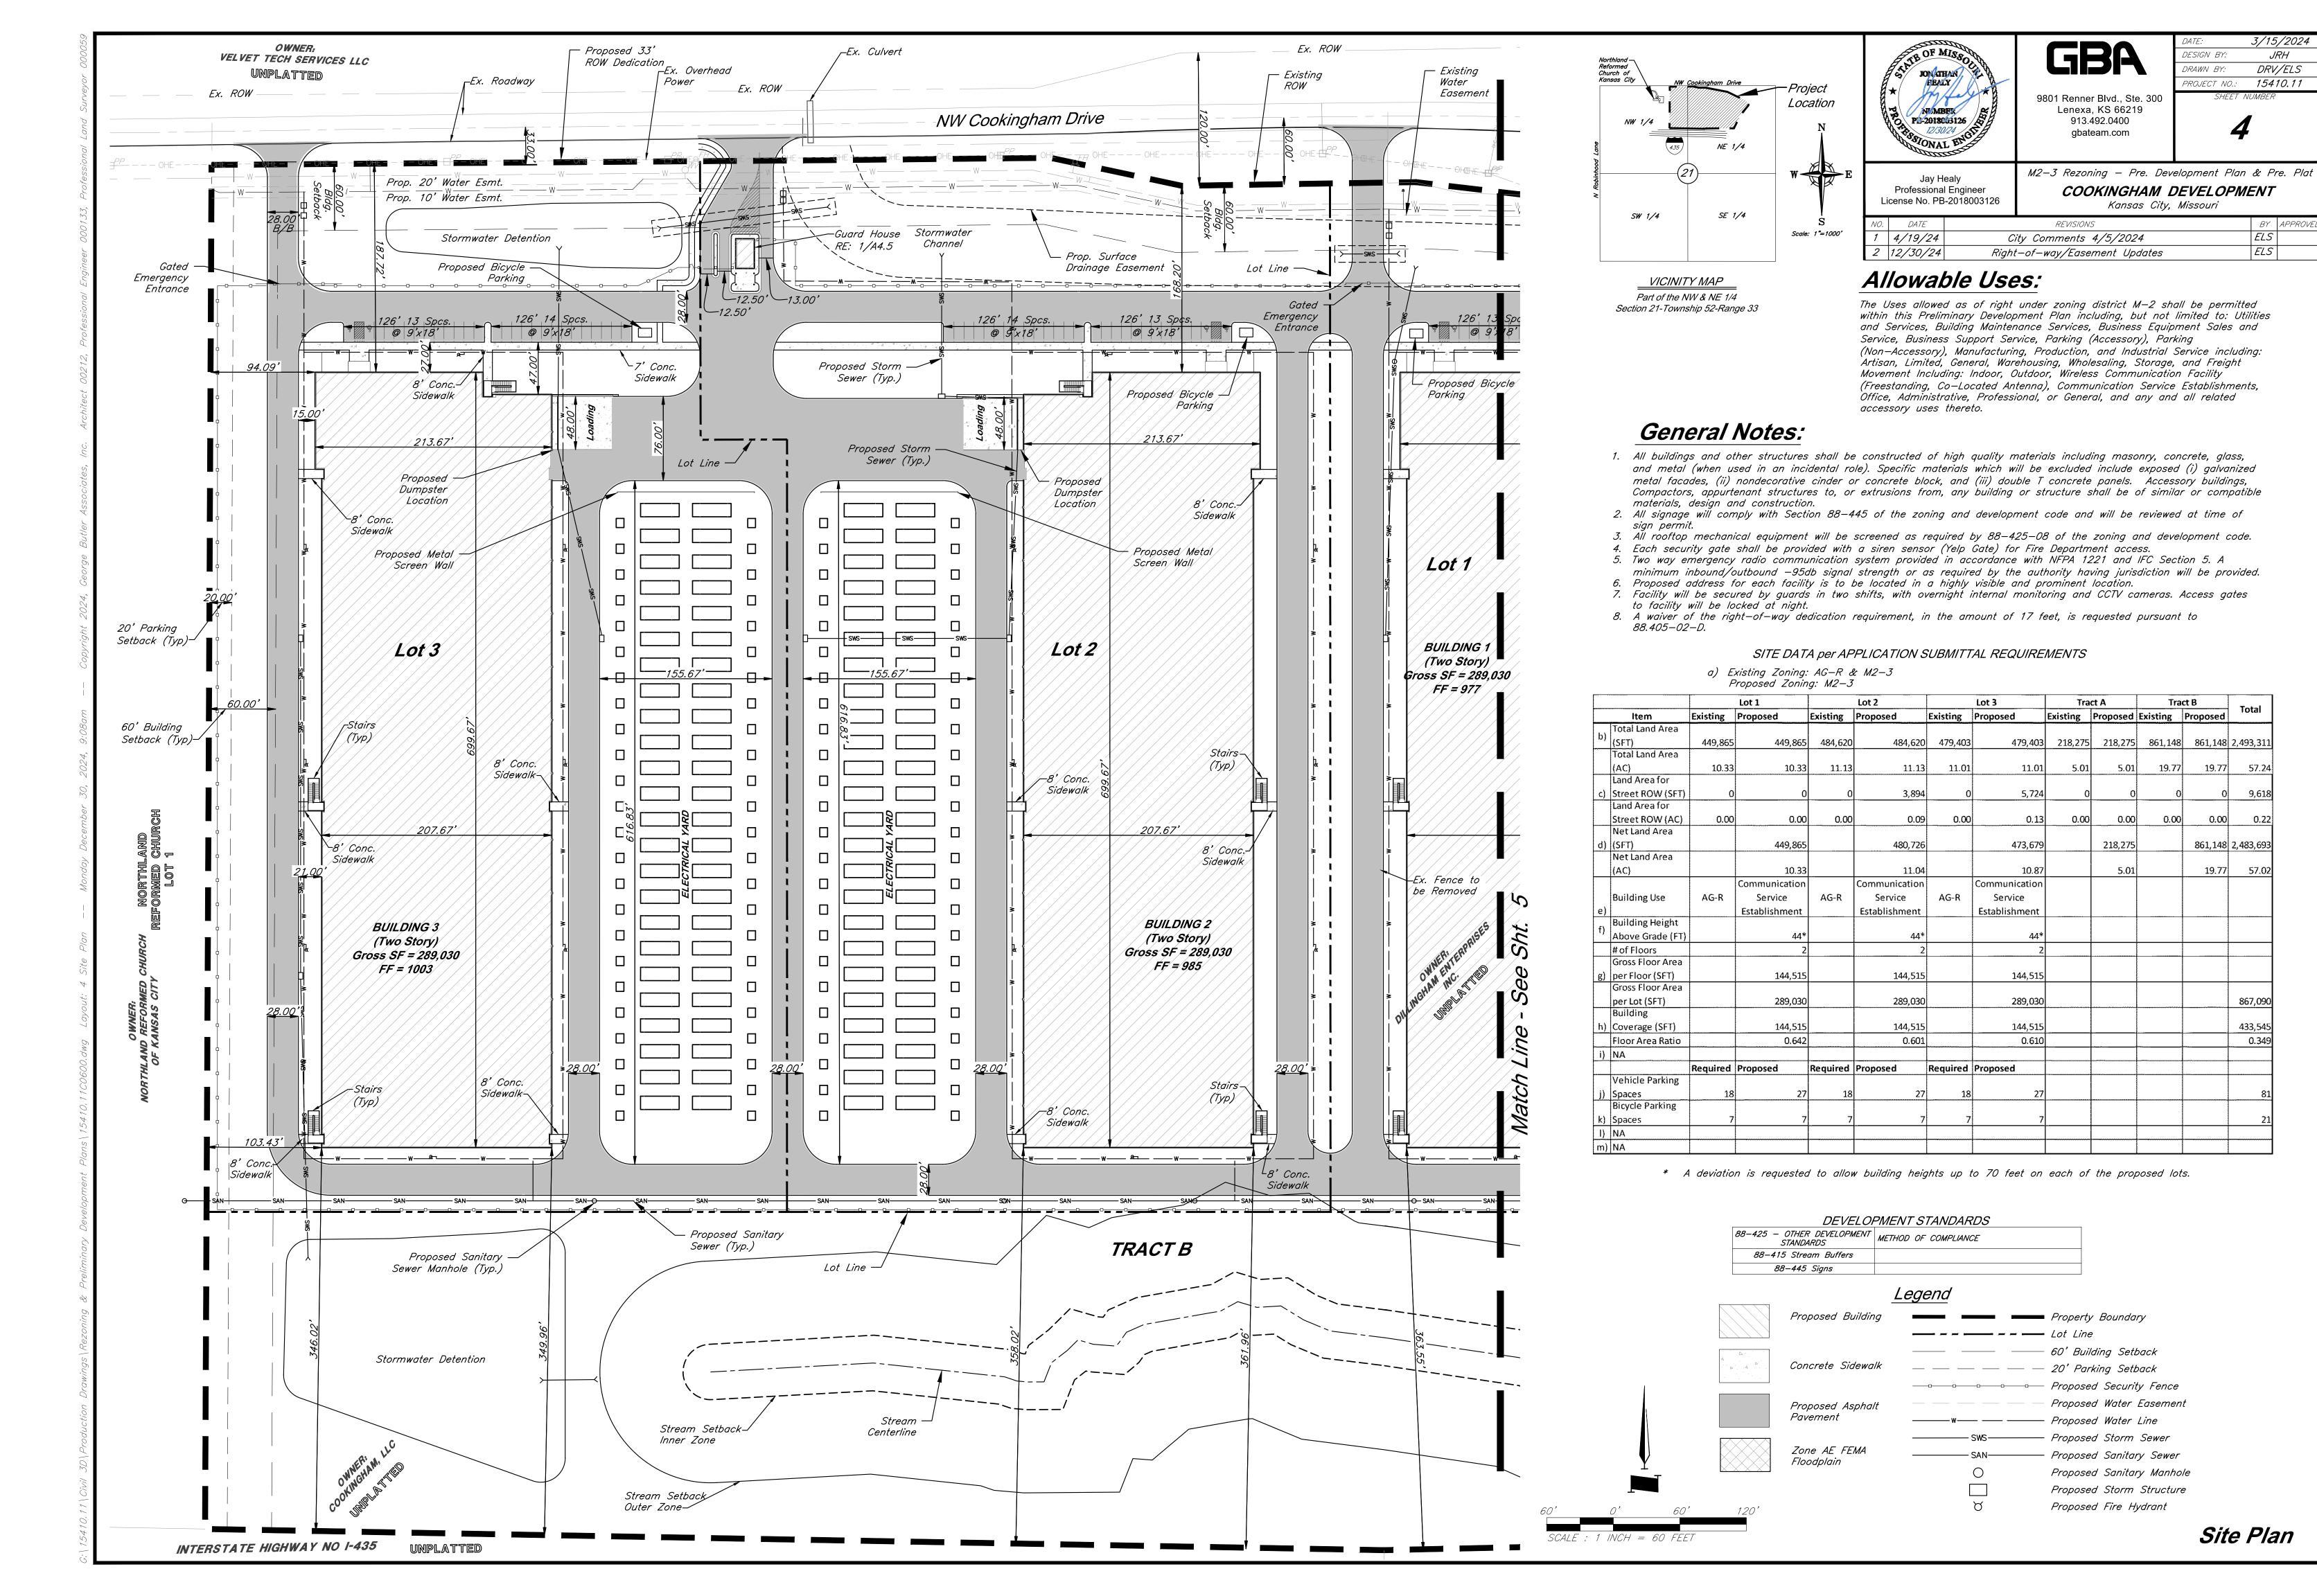
JRH

Jay Healy Professional Engineer License No. PB-2018003126 M2-3 Rezoning - Pre. Development Plan & Pre. Plat COOKINGHAM DEVELOPMENT Kansas City, Missouri

DESIGN BY:

REVISIONS BY APPROVED DATE 1 4/19/24 ELS City Comments 4/5/2024 ELS 2 12/30/24 Right-of-way/Easement Updates



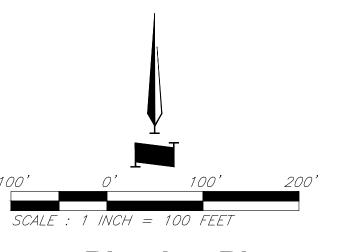

JRH

DRV/ELS


BY APPROV


ELS

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9801 Renner Blvd., Ste. 300

9801 Renner Blvd., Ste. 3 Lenexa, KS 66219 913.492.0400 gbateam.com DESIGN BY: JRH

DRAWN BY: DRV/ELS

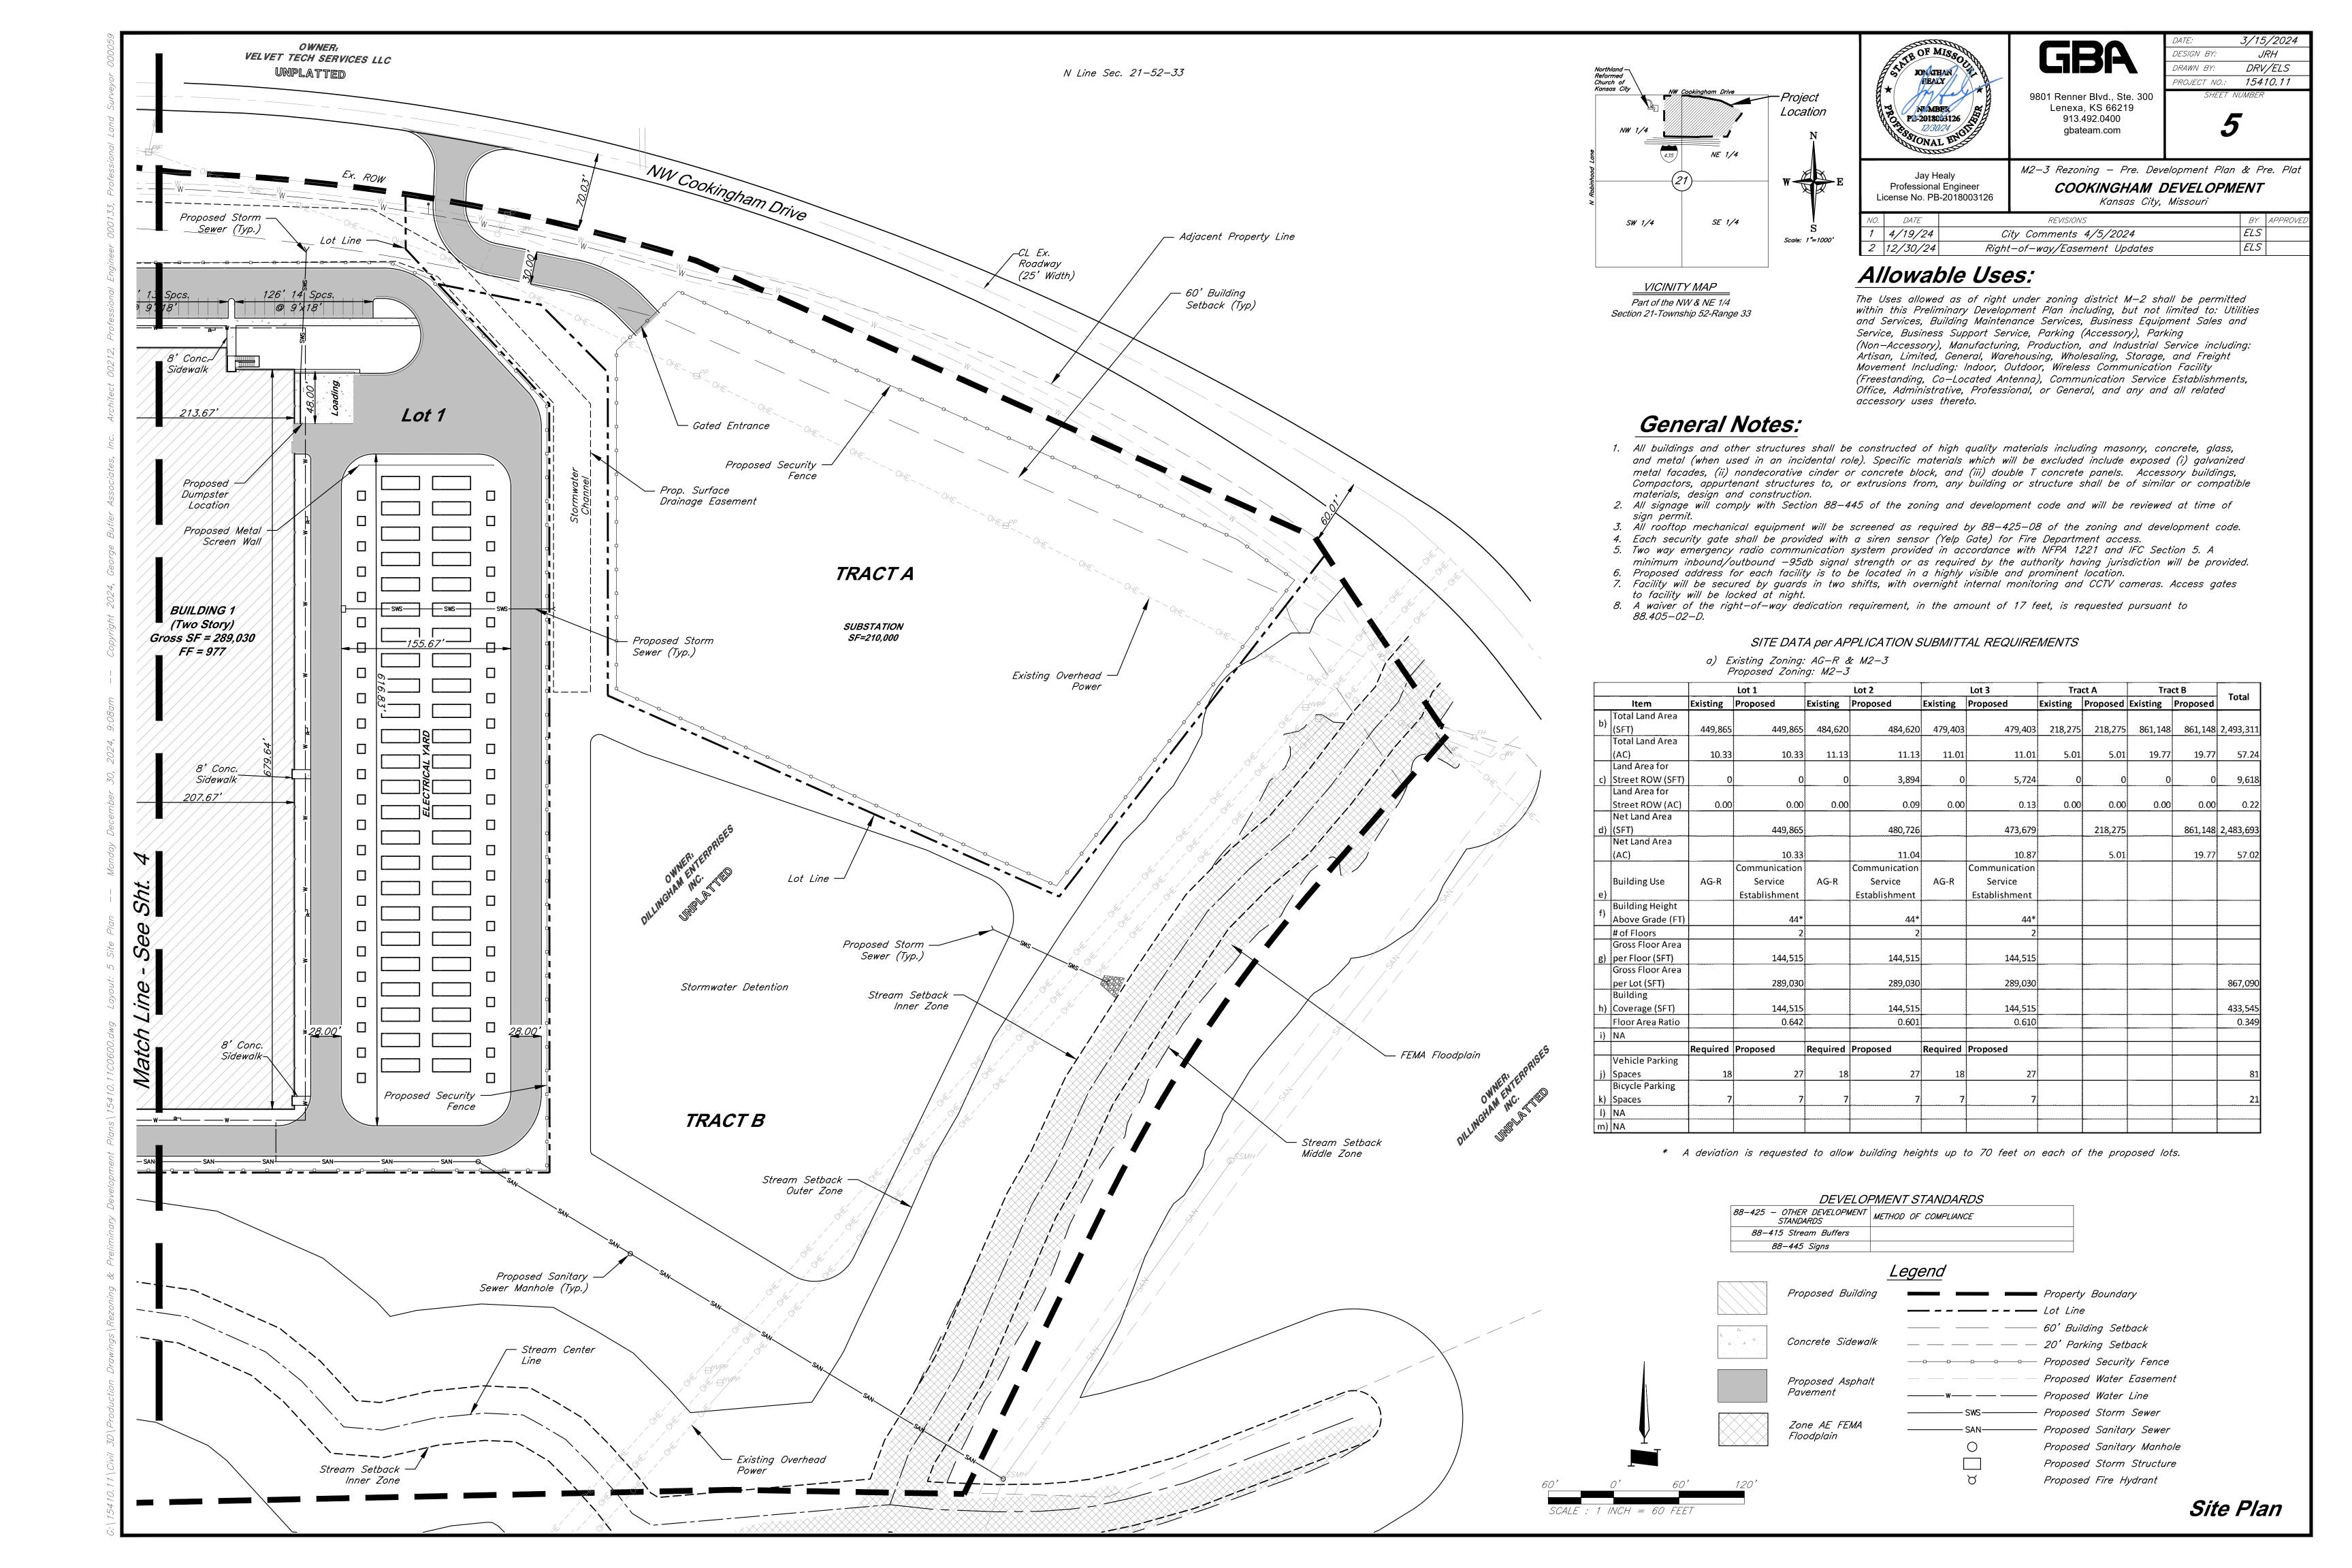PROJECT NO.: 15410.11

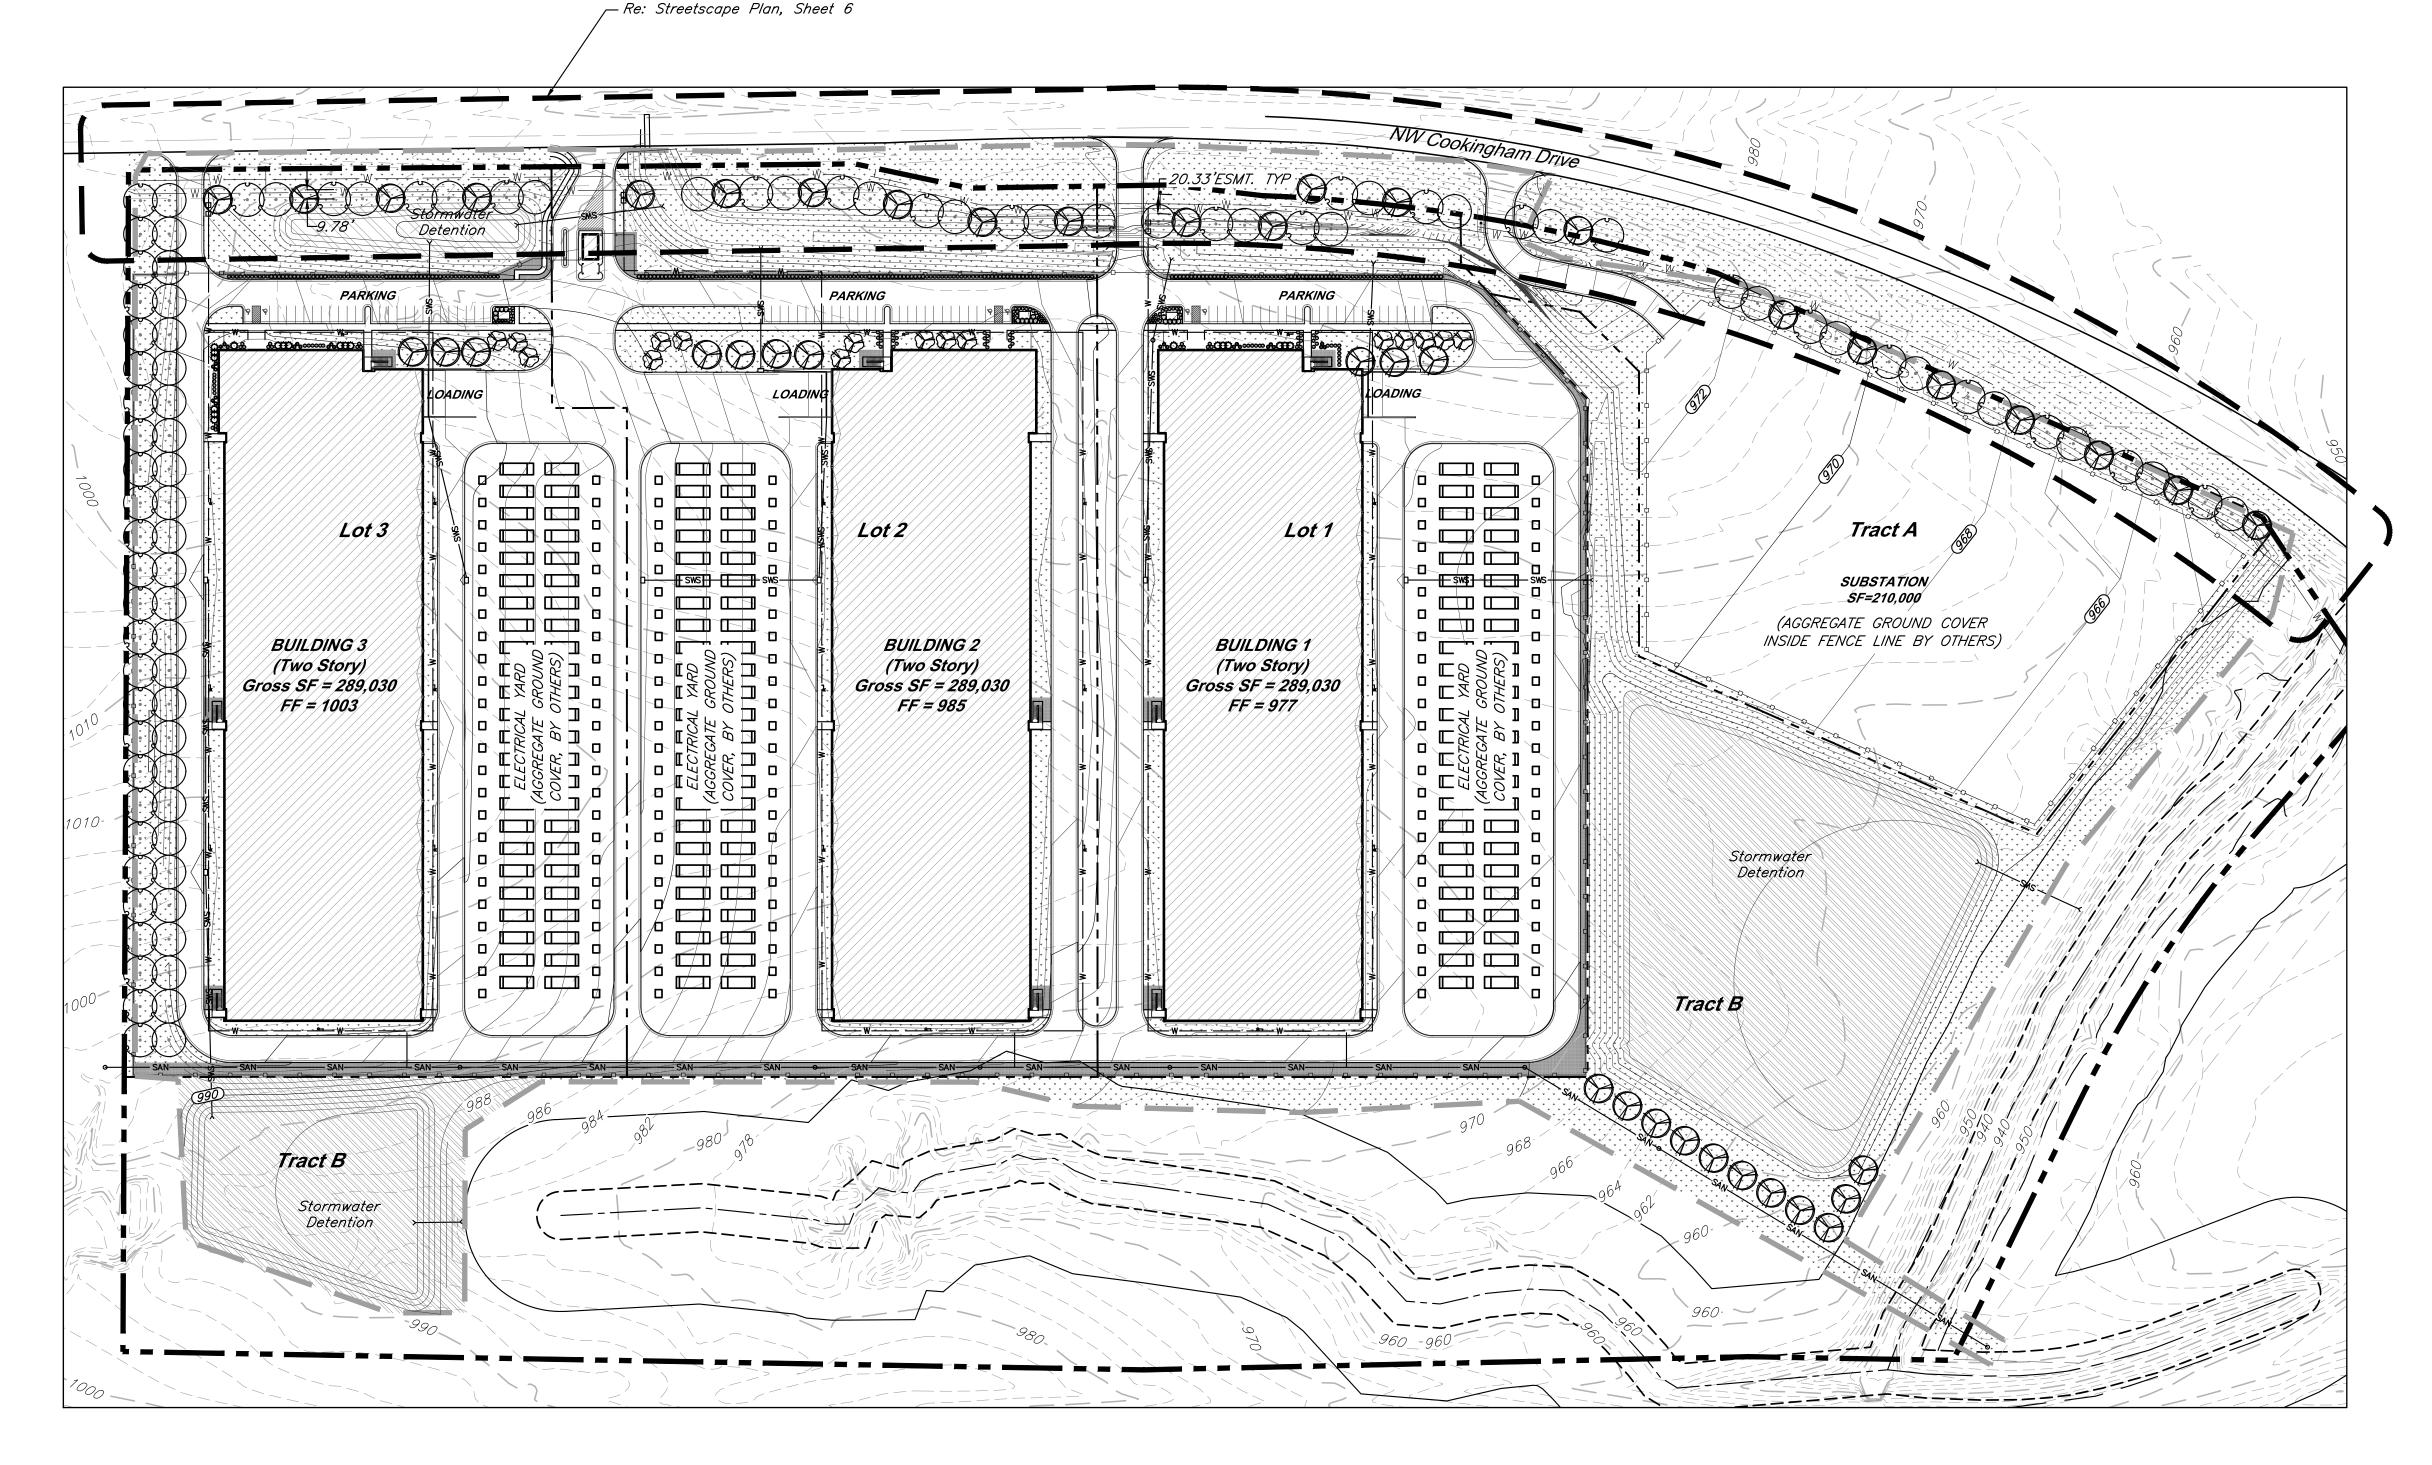SHEET NUMBER

Jay Healy Professional Engineer License No. PB-2018003126 M2-3 Rezoning - Pre. Development Plan & Pre. Plat

COOKINGHAM DEVELOPMENT

Kansas City, Missouri

NO.	DATE	DATE REVISIONS				
1	4/19/24	City Comments 4/5/2024	ELS			
2	12/30/24	Right-of-way/Easement Updates	ELS			

OVERALL PLANT SCHEDULE


SYMBOL	CODE	QTY	BOTANICAL / COMMON NAME
TREES			
	AS	43	Acer saccharum 'John Pair' / Fall Fiesta Maple
	СО	16	Cercis canadensis texensis 'Oklahoma' / Oklahoma Texas Redbud
	PM	48	Platanus x acerifolia 'Morton Circle' / Exclamation Plane Tree
	QS	48	Quercus shumardii / Shumard Oak
SHRUBS			
	НК	27	Hypericum kalmianum 'Deppe' / Sunny Boulevard® St. Johnswort
	IS	130	Ilex glabra 'Shamrock' / Shamrock Holly
	JK	16	Juniperus chinensis 'Kallays Compact' / Kallay Juniper
\.\.\.\.\.\.\.\.\.\.\.\.\.\.\.\.\.\.\.	JF	20	Juniperus chinensis 'Sea Green' / Sea Green Juniper
	JA	131	Juniperus x pfitzeriana 'Armstrongii' / Armstrong Pfitzer Juniper
	PV	110	Panicum virgatum 'Shenandoah' / Shenandoah Switch Grass
$\overline{\lambda}$	VN	32	Viburnum opulus 'Nanum' / Dwarf European Cranberrybush
GROUND CO	VERS		
	DR	45,320 sf	Decorative Landscape Rock
\ \ \ \ \ \ \ \ \ \ \ \ \ \ \ \ \ \ \	FG	544,345 sf	Festuca var.
	NM	211,375 sf	Native Mix Oval Sedge - Carex brevior Canada Wild Rye - Elymus canadensis Bottlebrush Sedge - Elymus hystx Tussock Sedge Common Rush Fox Sedge American Sweet Flag

LANDSCAPE REQUIREMENTS (Kansas City, Missouri)


ITEM(S)	REQUIRED	PROVIDED
CTREET TREET (AS AND AS		
STREET TREES (88-425-03-C) 1 TREE PER 30' OF FRONTAGE		
	2.564 (F. / 20) 05. TDF56	C T T DEEC
COOKINGHAM DRIVE (2,561 L.F.)	2,561 L.F. / 30 = 85 TREES	67 TREES
PARKING LOT SCREENING (88-425-05-B)		
3' HT. CONT. EVERGREEN HEDGE	3' HT. CONT. EVERGREEN HEDGE AT PARKING	PRÖVIDED PER PLANS
INTERIOR DARWING LOT LANDSCARE (Section of		
INTERIOR PARKING LOT LANDSCAPE (88-425-06) TOTAL PROPOSED PARKING = 81 SPACES		
TOTAL PROPOSED PARKING = 81 SPACES		
35 S.F. LANDSCAPE AREA PER 1 PARKING SPACE	LANDSCAPE AREA REQUIRED = 2,835 S.F.	5,332 S.F.
1 TREE PER 5 PARKING SPACES	TREES REQUIRED = 16	26 TREES
1 SHRUB PER PARKING SPACE	SHRUBS REQUIRED = 81	205 SHRUBS
GENERAL LANDSCAPE (88-425-04)		
1 TREE PER 5,000 S.F. OF BLDG. COVERAGE		
BUILDING COVERAGE = 433,386 S.F.	433,386 S.F. / 5,000 = 86.6 TREES	87 TREES PROVIDED
	.22,200 3 / 2,000 00.0 (11220	
SCREENING OF MECH, UTIL, TRASH (88-425-08-A)		
DUMPSTERS, CONTAINERS, UTILITIES SCREENED FROM		DUMPSTERS AND TRASH WILL BE CONTAINED
PUBLIC VIEW		WITHIN BUILDING

INTERIOR PARKING LOT LANDSCAPE SCHEDULE (88-425-06)

SYMBOL	CODE	QTY	BOTANICAL / COMMON NAME	SIZE	CONTAINE
TREES					
	AS	10	Acer saccharum 'John Pair' / Fall Fiesta Maple	2.5" Cal.	B&B
	60	4.5	Considerate de maio torre de l'Oldeboure I / Oldeboure Torre De divid		
4	СО	16	Cercis canadensis texensis 'Oklahoma' / Oklahoma Texas Redbud	2" Cal.	
SYMBOL	CODE	QTY	BOTANICAL / COMMON NAME		
SHRUBS					
	НК	27	Hypericum kalmianum 'Deppe' / Sunny Boulevard® St. Johnswort		
	JK	16	Juniperus chinensis 'Kallays Compact' / Kallay Juniper		
₹. }	JF	20	Juniperus chinensis 'Sea Green' / Sea Green Juniper		
	PV	110	Panicum virgatum 'Shenandoah' / Shenandoah Switch Grass		
(λ)	VN	32	Viburnum opulus 'Nanum' / Dwarf European Cranberrybush		
PARKII	NG LO	T SC	REENING SCHEDULE (88-425-05-B)		
SYMBOL	CODE	QTY	BOTANICAL / COMMON NAME		
SHRUBS					
	IS	130	Ilex glabra 'Shamrock' / Shamrock Holly		
\sim					

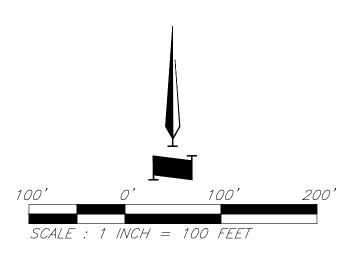

Landscape Plan

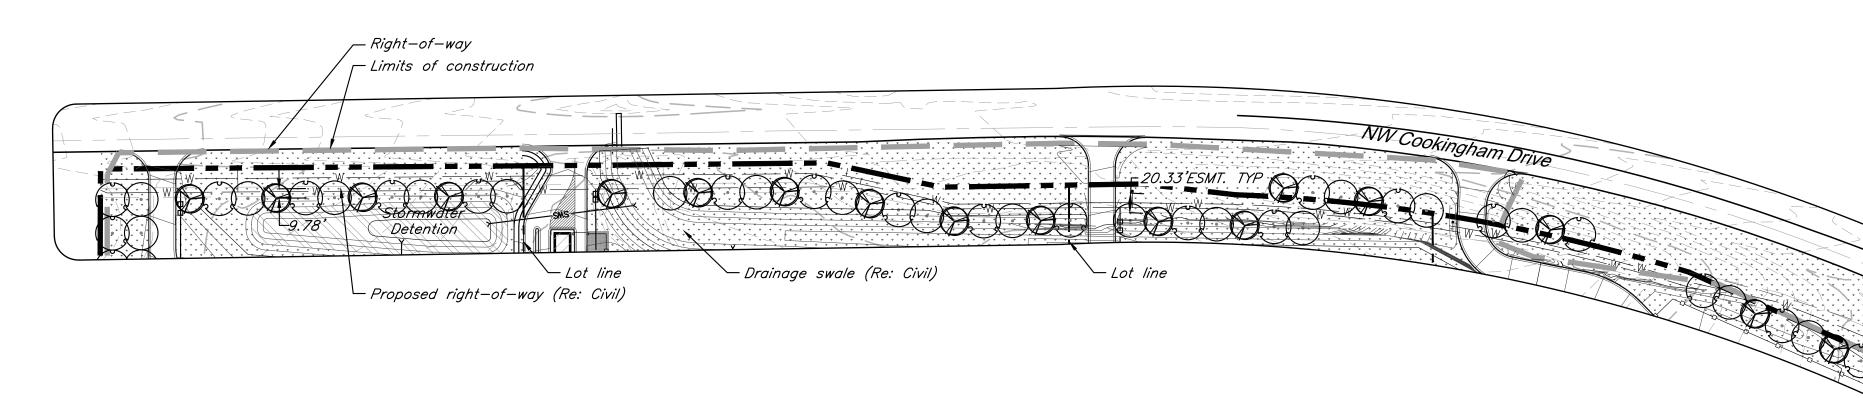

LANDSCAPE REQUIREMENTS (KCMO)

ITEM(S)	REQUIRED	PROVIDED
STREET TREES (88-425-03-C)		
1 TREE PER 30' OF FRONTAGE		
COOKINGHAM DRIVE (2,561 L.F.)	2,561 L.F. / 30 = 85 TREES	67 TREES

PLANT SCHEDULE STREETSCAPE

YMBOL	CODE	QTY	BOTANICAL / COMMON NAME	SIZE	CONTAINER
REES	AS	22	Acer saccharum 'John Pair' / Fall Fiesta Maple	2.5" Cal.	B&B
	PM	24	Platanus x acerifolia 'Morton Circle' / Exclamation Plane Tree	2.5" Cal.	В&В
$\overline{}$	QS	24	Quercus shumardii / Shumard Oak	2.5" Cal.	B&B

Fence (Re: Civil) —



9801 Renner Blvd., Ste. 300 Lenexa, KS 66219 913.492.0400 gbateam.com PROJECT NO.: 15410.11
SHEET NUMBER

DESIGN BY: DRAWN BY:

3/15/2024 JRH


DRV/ELS

Jay Healy Professional Engineer License No. PB-2018003126 M2-3 Rezoning - Pre. Development Plan & Pre. Plat

COOKINGHAM DEVELOPMENT

Kansas City, Missouri

NO.	DATE	REVISIONS	BY	APPRO
1	4/19/24	City Comments 4/5/2024	ELS	
2	12/30/24	Right-of-way/Easement Updates	ELS	

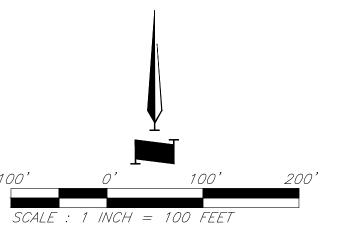

LANDSCAPE NOTES:

- 1. FIELD VERIFY UTILITIES SHOWN ON PLANS PRIOR TO WORK COMMENCEMENT. INFORMATION SHOWN ON PLAN IS FROM AVAILABLE INFORMATION AND ALL LOCATIONS SHOWN SHOULD BE CONSIDERED APPROXIMATE. THE CONTRACTOR AGREES TO BE FULLY RESPONSIBLE FOR ANY AND ALL DAMAGE TO UTILITIES MADE FROM CONSTRUCTION ACTIVITY. IMMEDIATELY NOTIFY PROJECT LANDSCAPE ARCHITECT AND ENGINEER IF DISCREPANCIES ARISE.
- 2. COMPLETE REQUIRED LANDSCAPING FOR THE ENTIRE SITE IN CONFORMANCE TO THE PLANS AND SPECIFICATIONS, INCLUDING BUT NOT LIMITED TO: SEEDED AREAS, SODDED AREAS, SHRUB BEDS, AND SITE CLEAN-UP.
- 3. VERIFY QUANTITIES PRIOR TO COMMENCING WORK. REPORT DISCREPANCIES TO THE LANDSCAPE ARCHITECT. PLANT MATERIAL TO BE SPACED AS SHOWN, UNLESS OTHERWISE NOTED.
- 4. PLANT MATERIAL SHALL COMPLY WITH ALL SIZING AND GRADING STANDARDS OF LATEST EDITION OF AMERICAN STANDARD FOR NUSERY STOCK (A.S.N.S.) LATEST EDITION PUBLISHED BY (ANLA) ANSI 260.1. THIS IS A REPRESENTATIVE GUIDELINE SPECIFICATION ONLY AND WILL CONSTITUTE MINIMUM QUALITY REQUIREMENTS FOR THE PLANT MATERIAL.
- 5. THE OWNER RESERVES THE RIGHT TO SUBSTITUTE PLANT MATERIAL, TYPE, SIZE AND/OR QUANTITY. LARGER SIZED PLANT MATERIALS OF THE SPECIES LISTED MAY BE USED IF THE STOCK CONFORMS TO A.S.N.S. VEGETATION SUBSTITUTIONS SHALL BE APPROVED BY PROJECT LANDSCAPE ARCHITECT. SUBSTITUTIONS MADE WITHOUT WRITTEN APPROVAL WILL BE REPLACED WITH APPROVED SELECTIONS AT CONTRACTOR'S COST.
- 6. DISTURBED AREAS DUE TO CONSTRUCTION ACTIVITIES NOT IDENTIFIED ON THESE PLANS SHALL BE REPAIRED AND RESTORED TO ORIGINAL OR BETTER CONDITIONS AT CONTRACTOR'S COST. SOD WITH A TURF-TYPE TALL FESCUE BLEND SHALL BE PROVIDED FOR AREAS NOT DESIGNATED AS BEDS & PAVEMENT.
- 7. CONTRACTOR SHALL COMPLY WITH APPLICABLE CODES AND ORDINANCES REGARDING LANDSCAPING. REFER TO SPECIFICATIONS FOR PLANT MATERIAL, SOILS, AND INSTALLATION METHODS.
- 8. INSTALL PLANT MATERIAL IN ACCORDANCE WITH A.S.N.S. STANDARDS.
- 9. INSTALL FINISHED GRADES OF SOD, LANDSCAPE BEDS, AND MULCH 1" BELOW ABUTTING PAVEMENT SURFACES TO ALLOW UNINHIBITED DRAINAGE TO NON-PAVEMENT SURFACES.
- 10. REMOVE ALL TWINE, WIRE, AND BURLAP FROM TREE AND SHRUB ROOT BALLS. REMOVE ALL PLASTIC WRAP, FABRIC ROPE, ROT PROOF WRAP, AND PLANT IDENTIFICATION TAGS.
- 11. TREES SHALL NOT BE PLANTED CLOSER THAN EIGHT HORIZONTAL FEET OF UNDERGROUND UTILITIES UNLESS OTHERWISE NOTED OR PER PLANS. MODIFICATIONS TO TREE PLACEMENT SHALL BE COORDINATED WITH THE LANDSCAPE ARCHITECT AND CAN BE SUBJECT TO CITY REVIEW AND APPROVAL. CONTRACTOR IS RESPONSIBLE FOR UNAPPROVED RELOCATION(S) OR MODIFICATION(S) TO TREE LOCATIONS.
- 12. PROVIDE NATURAL TOPSOIL THAT IS FERTILE, FRIABLE, WITHOUT MIXTURE OF SUBSOIL MATERIALS, AND OBTAINED FROM A WELL DRAINED, AVAILABLE SITE. IT SHALL NOT CONTAIN SUBSTANCES WHICH MAY BE HARMFUL TO PLANT GROWTH. TOPSOIL SHALL BE SCREENED AND FREE FROM CLAY, LUMPS, STONES, ROOTS, PLANTS, OR SIMILAR SUBSTANCES 1" OR MORE IN DIAMETER, DEBRIS, OR OTHER OBJECTS WHICH MIGHT BE A HINDRANCE TO PLANTING OPERATIONS. TOPSOIL SHALL CONTAIN AT LEAST 4-6% ORGANIC MATTER BY WEIGHT AND HAVE A PH RANGE OF 5.5 TO 7.0.

- 13. PLANT MATERIAL TO BE GUARANTEED FOR ONE (1) YEAR FROM THE DATE OF SUBSTANTIAL COMPLETION AND ACCEPTANCE. PLANT MATERIALS SHALL BE A ONE-TIME-REPLACEMENT AND RECORDS KEPT BY THE LANDSCAPE CONTRACTOR FOR ALL REPLACEMENTS.
- 14. PLANT MATERIAL SHALL BE OF EXCELLENT QUALITY, FREE OF DISEASE & INFESTATION-TRUE TO TYPE, VARIETY, SIZE SPECIFIED, & FORM PER ANSI STANDARDS.
- 15. WATER-IN EACH PLANT IMMEDIATELY FOLLOWING INSTALLATION AND CONTINUE WATERING ROUTINE UNTIL SUBSTANTIAL PROJECT COMPLETION. CONTRACTOR IS REQUIRED TO COORDINATE WATERING REQUIREMENTS TO THE OWNER THEREAFTER.
- 16. ALL WORK SHALL BE COORDINATED WITH THE WORK OF OTHER TRADES.
- 17. THE OWNER'S REPRESENTATIVE RESERVES THE RIGHT TO REJECT ANY PLANT MATERIAL NOT CONFORMING TO THE SPECIFICATIONS.
- 18. THE LANDSCAPE CONTRACTOR SHALL TEST PROPOSED PLANTING AREAS FOR SOIL NUTRIENT DEFICIENCIES AND UNDESIRABLE SOIL TEXTURE AND STRUCTURE. BASED ON THE RESULTS OF THIS TESTING, THE LANDSCAPE CONTRACTOR SHALL PROVIDE AND INCORPORATE SOIL CONDITIONING MATERIALS (IE: FERTILIZER, SAND, COMPOST, ETC.) AS NECESSARY TO DEVELOP A PLANT GROWTH MEDIUM OF ADEQUATE FERTILITY, STRUCTURE, AND TEXTURE FOR THE ESTABLISHMENT OF LANDSCAPE MATERIALS. PEAT IS NOT ACCEPTABLE.
- 19. THE LANDSCAPE CONTRACTOR SHALL REMOVE FROM THE SITE ALL ROCK GREATER THAN 1-INCH AND ALL DEBRIS IN THE AREAS OF PROPOSED NEW PLANTINGS.
- 15.DAMAGED TURF AREAS ADJACENT TO PLANTING AREAS SHALL BE RESTORED AND SODDED TO MATCH EXISTING ADJACENT TOPOGRAPHY AND TURF TYPE.


16. PLANTING SCHEDULE:

TREE PLANTING:	MARCH 15 - JUNE 15	OR	SEPTEMBER 15 - DECEMBER 31
SHRUB PLANTING:	APRIL 15 - JUNE 15	OR	AUGUST 15 - OCTOBER 15
SOD/SEED PLANTING:	MARCH 15 - JUNE 15	OR	SEPTEMBER 15 - DECEMBER 1

17. ALL PLANTING METHODS SHALL COMPLY WITH CITY OF KANSAS CITY, MO STANDARDS.

PLANTING BED INSTALLATION NOTES:


- 1. ALL PLANTATION BEDS SHALL BE AMENDED WITH 1 CUBIC YARD OF COTTON BOLL COMPOST PER 1000 SQUARE FEET. FILL COTTON BOLL INTO SOIL TO A 6" DEPTH. A 10-10-10 FERTILIZER SHALL BE SPREAD OVER ALL PLANTING AREAS PRIOR TO PLANTING, AT A RATE OF 50 POUNDS PER 2000 SQ. FT.
- 2. AFTER PLANTING HAVE BEEN INSTALLED, ALL PLANTING BEDS SHALL BE TREATED WITH DACTHAL PRE-EMERGENT HERBICIDE PRIOR TO MULCH OR ROCK APPLICATION.
- 3. PLANT PIT BACKFILL FOR SHRUBS SHALL BE 25% COTTON BOLL COMPOST AND 25% TOP SOIL AND 50% EXISTING SOIL. TOP SOIL SHALL BE NATURAL FERTILE, FRIABLE SOIL POSSESSING CHARACTERISTICS OF REPRESENTATIVE PRODUCTIVE SOILS IN THE AREAS. SOIL SHALL NOT BE EXCESSIVELY ACID, ALKALINE OR TOXIC THAT MAY BE HARMFUL TO PLANT GROWTH. ALSO, FREE OF CLAY LUMPS, STONES, STUMPS, ROOTS OR
- SUBSTANCE 2" OR MORE IN DIAMETER. 4. PLANTING TABLETS: INSTALL MANUFACTURER GRO-POWER, INC, PRODUCT: GROWPOWER TABLETS, SIZE: 7-GRAM TABLETS, RATE: 1 TABLETS PER 1-GALLON CONTAINER AND 4 TABLETS PER 3-GALLON CONTAINER AND 7 TABLETS PER 5-GALLON CONTAINER.
- 5. PLANTED BED EDGES SHALL BE IN STRAIGHT LINES OR GENTLE FOLLOWING CURVES. SUDDEN CURVES OR SHARP ANGLE SHOULD BE AVOIDED.

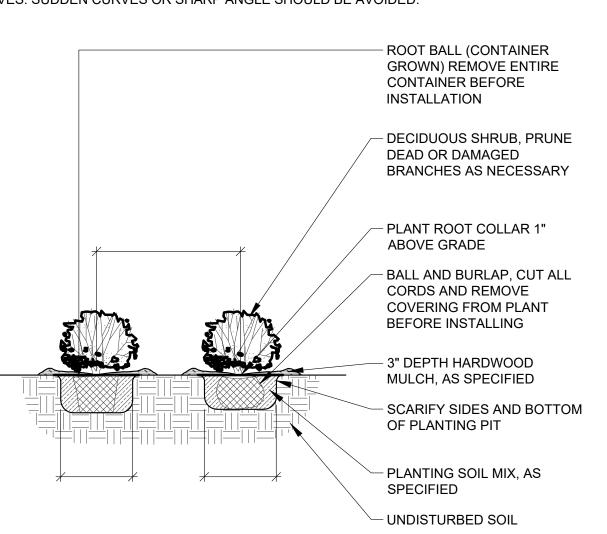

- 1) EXCAVATE A PIT WHICH IS AT LEAST TWICE THE DIAMETER OF THE ROOTBALL AND THE SAME DEPTH-NO DEEPER. HANDLE THE TREE BY THE ROOT BALL, NOT THE TRUCK. BE SURE THE ROOT BALL RESTS ON SOLID 2) BACKFILL WITH PLANTING SOIL
- 3) SATURATE THE ENTIRE BACKFILL SOIL WITH WATER. ADD MORE SOIL IF NEEDED TO COMPENSATE FOR
- 4) MULCH: COVER SMOOTHED SOIL WITH 2 INCHES OF MULCH. LEAVE GAP NEAR THE TRUCK. KEEP MULCH WEEDED. REPLACE AS NEEDED.
- 5) PRUNE ONLY BROKEN OR BADLY DEFORMED BRANCHES TO RETAIN SHAPE OF THE SPECIES. PRUNE OUT SECONDARY AND COMPETING GROWTH. DO NOT SHEAR. DO NOT CUT LEADER. BEGIN A REGULAR PRUNING PROGRAM THE SECOND YEAR AFTER PLANTING. 6) CHAFING GUARDS: REMOVE GUARDS AS SOON AS THE TREE CAN STAND ALONE ABOUT 3 MONTHS OR
- LONGER IF NEEDED. 7) DO NOT ALLOW AIR POCKETS TO FORM WHEN BACKFILLING.

8) DO NOT DISTURB ROOT BALL WHEN PLANTING OR STAKING. CRACKED OR OTHERWISE DAMAGED ROOT

- BALLS SHALL BE REJECTED 9) WATER THOROUGHLY FOLLOWING PLANTING. 10) REMOVE EXCESS DEBRIS FORM AROUND ROOT COLLAR/FLARE IS LEVEL OR SLIGHTLY ABOVE (1" MAX)
- ADJACENT UPHILL GRADE. 11) SCARIFY EDGES OF EXCAVATION WHERE SMOOTHED DURING EXCAVATION.
- 12) ALL PLANTING METHODS SHALL COMPLY WITH CITY OF BRANSON STANDARDS.

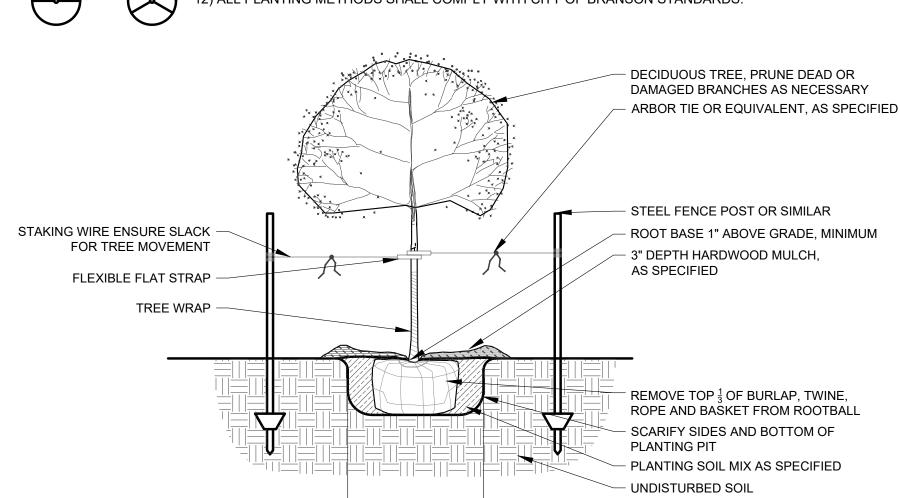

ROCK - 6" DEPTH AMENDED SOIL 6"x12 GAUGE COL-MET STEEL EDGING OR EQUAL; COLOR BLACK

LANDSCAPE

9801 Renner Blvd., Ste. 300

DESIGN BY: DRAWN BY: *DRV/ELS* PROJECT NO.: 15410.11 SHEET NUMBER

3/15/2024

Lenexa, KS 66219 913.492.0400 gbateam.com


Jay Healy Professional Engineer License No. PB-2018003126 M2-3 Rezoning - Pre. Development Plan & Pre. Plat COOKINGHAM DEVELOPMENT Kansas City, Missouri


DATE REVISIONS BY APPROVE | ELS | 1 4/19/24 City Comments 4/5/2024 2 |12/30/24| Right-of-way/Easement Updates


SHRUB AND PERENNIAL PLANTING


DECIDUOUS TREE PLANTING 1/2" = 1'-0"


Planting Details

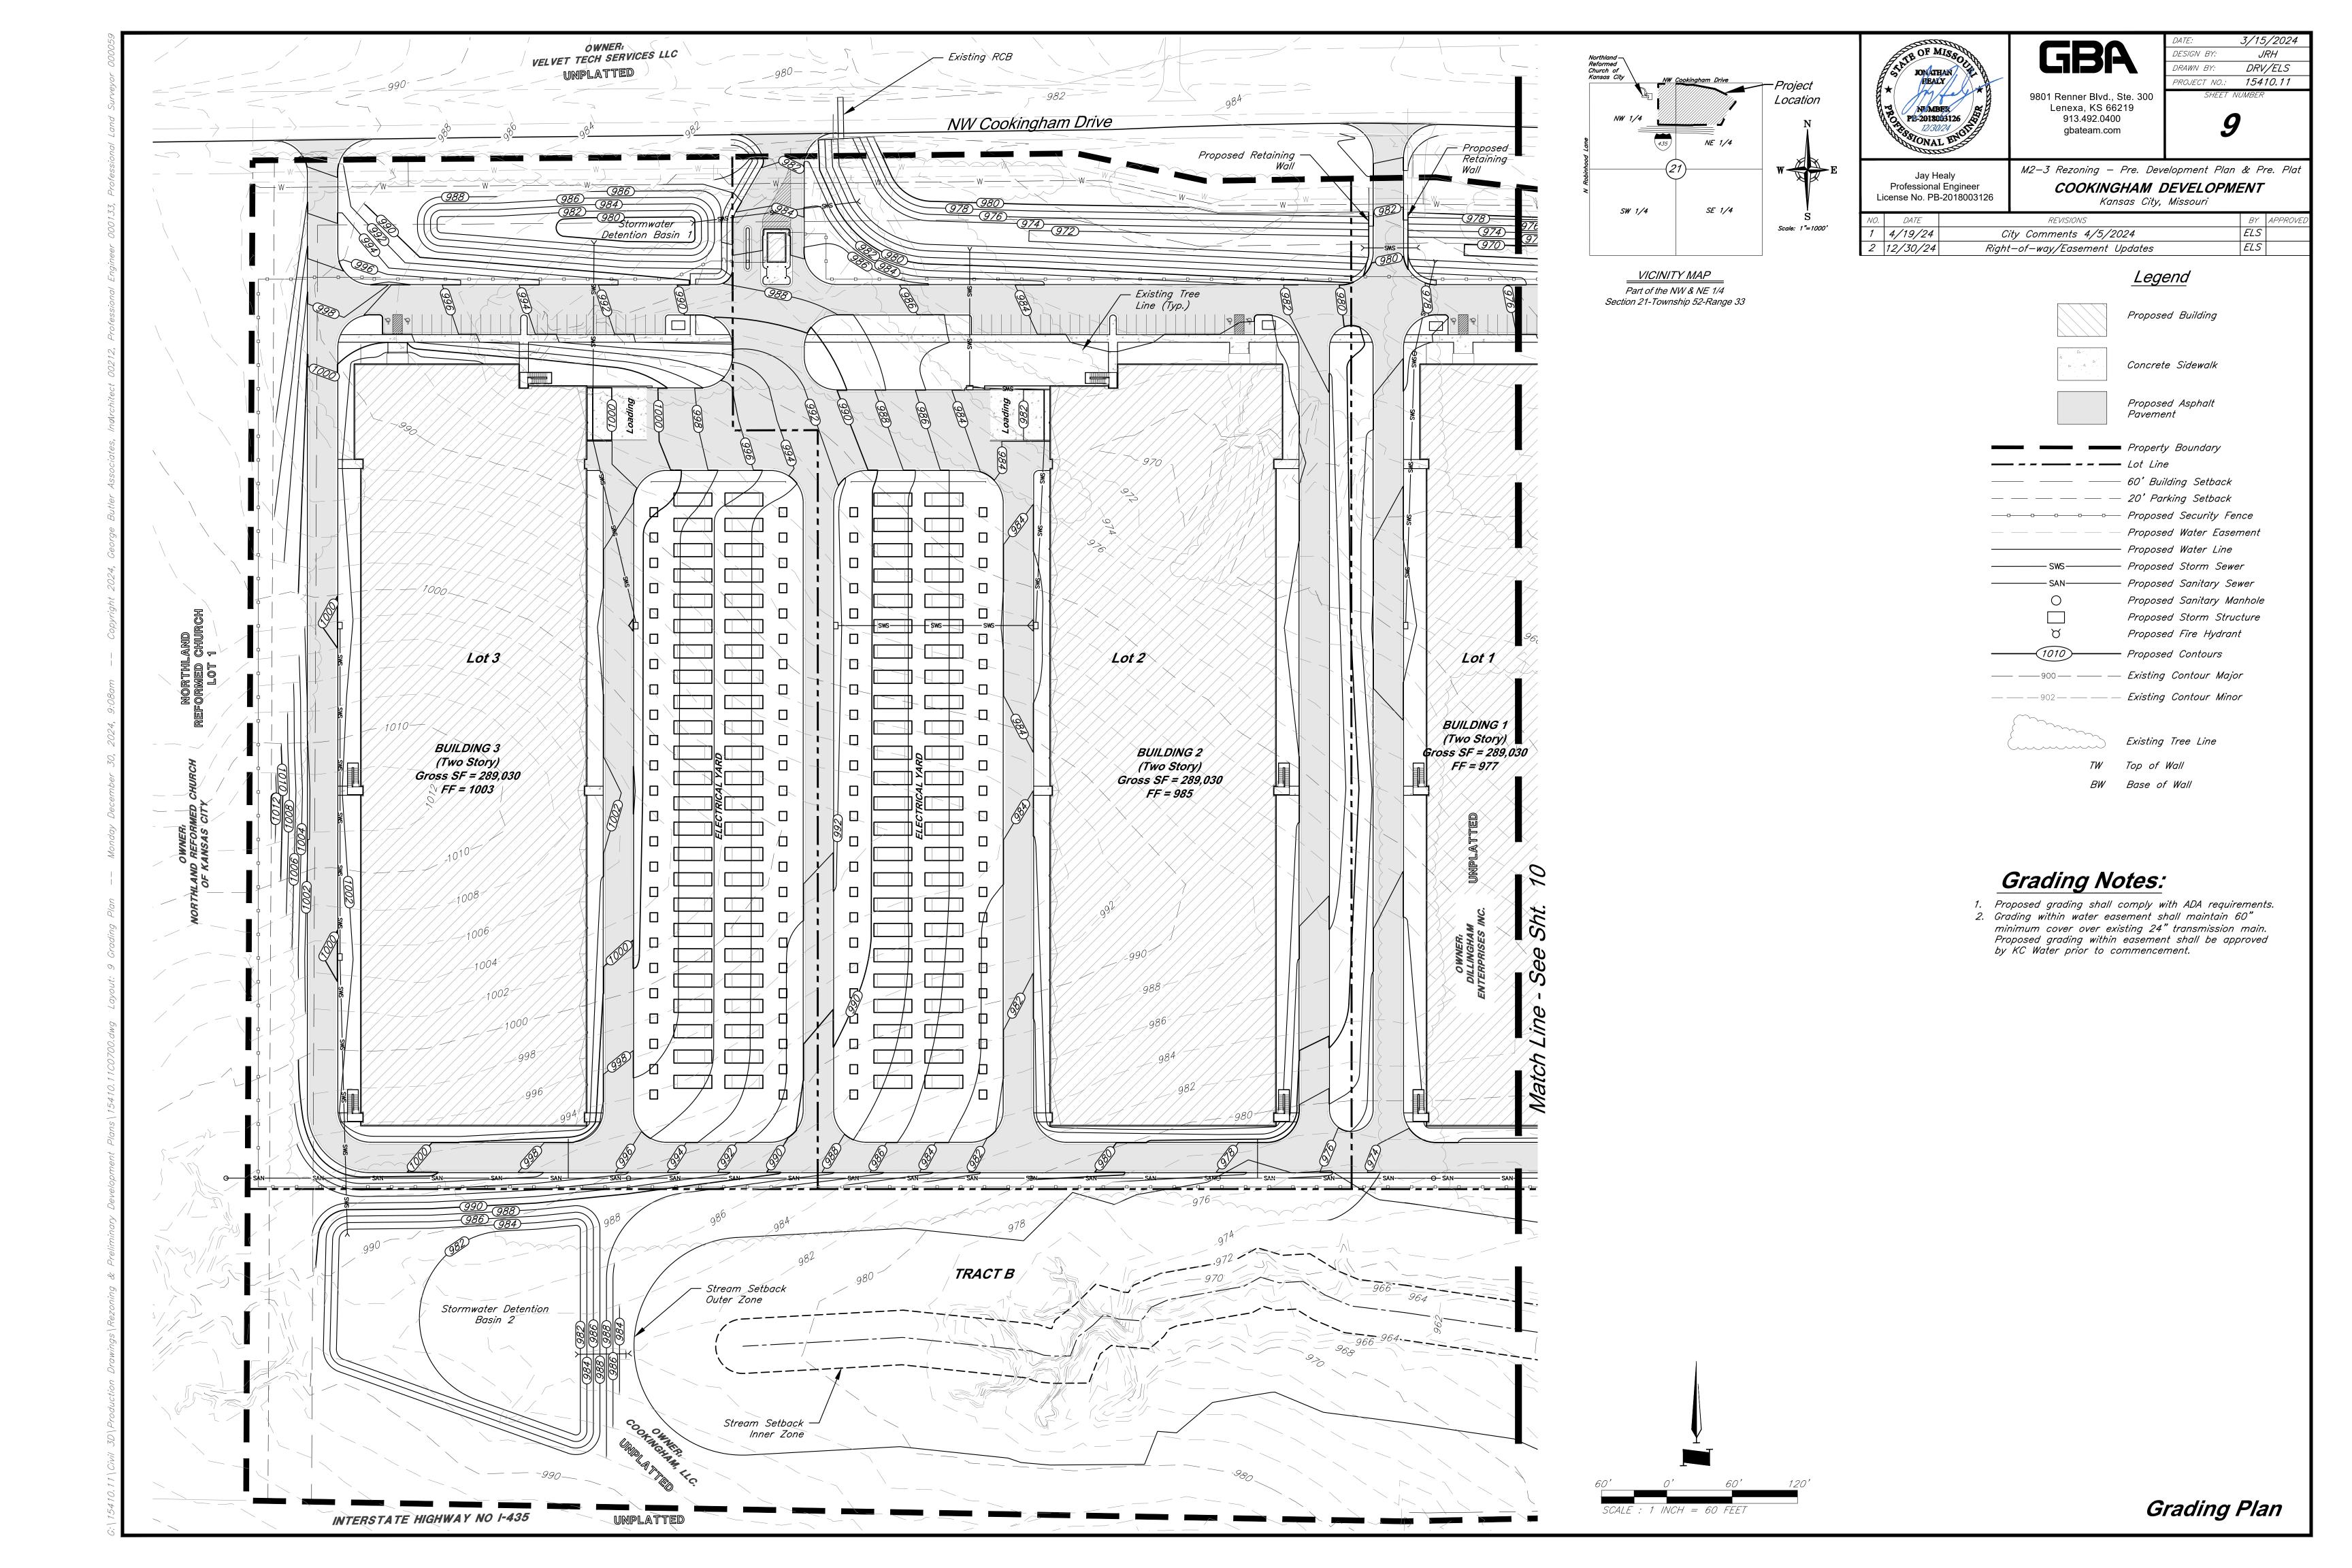


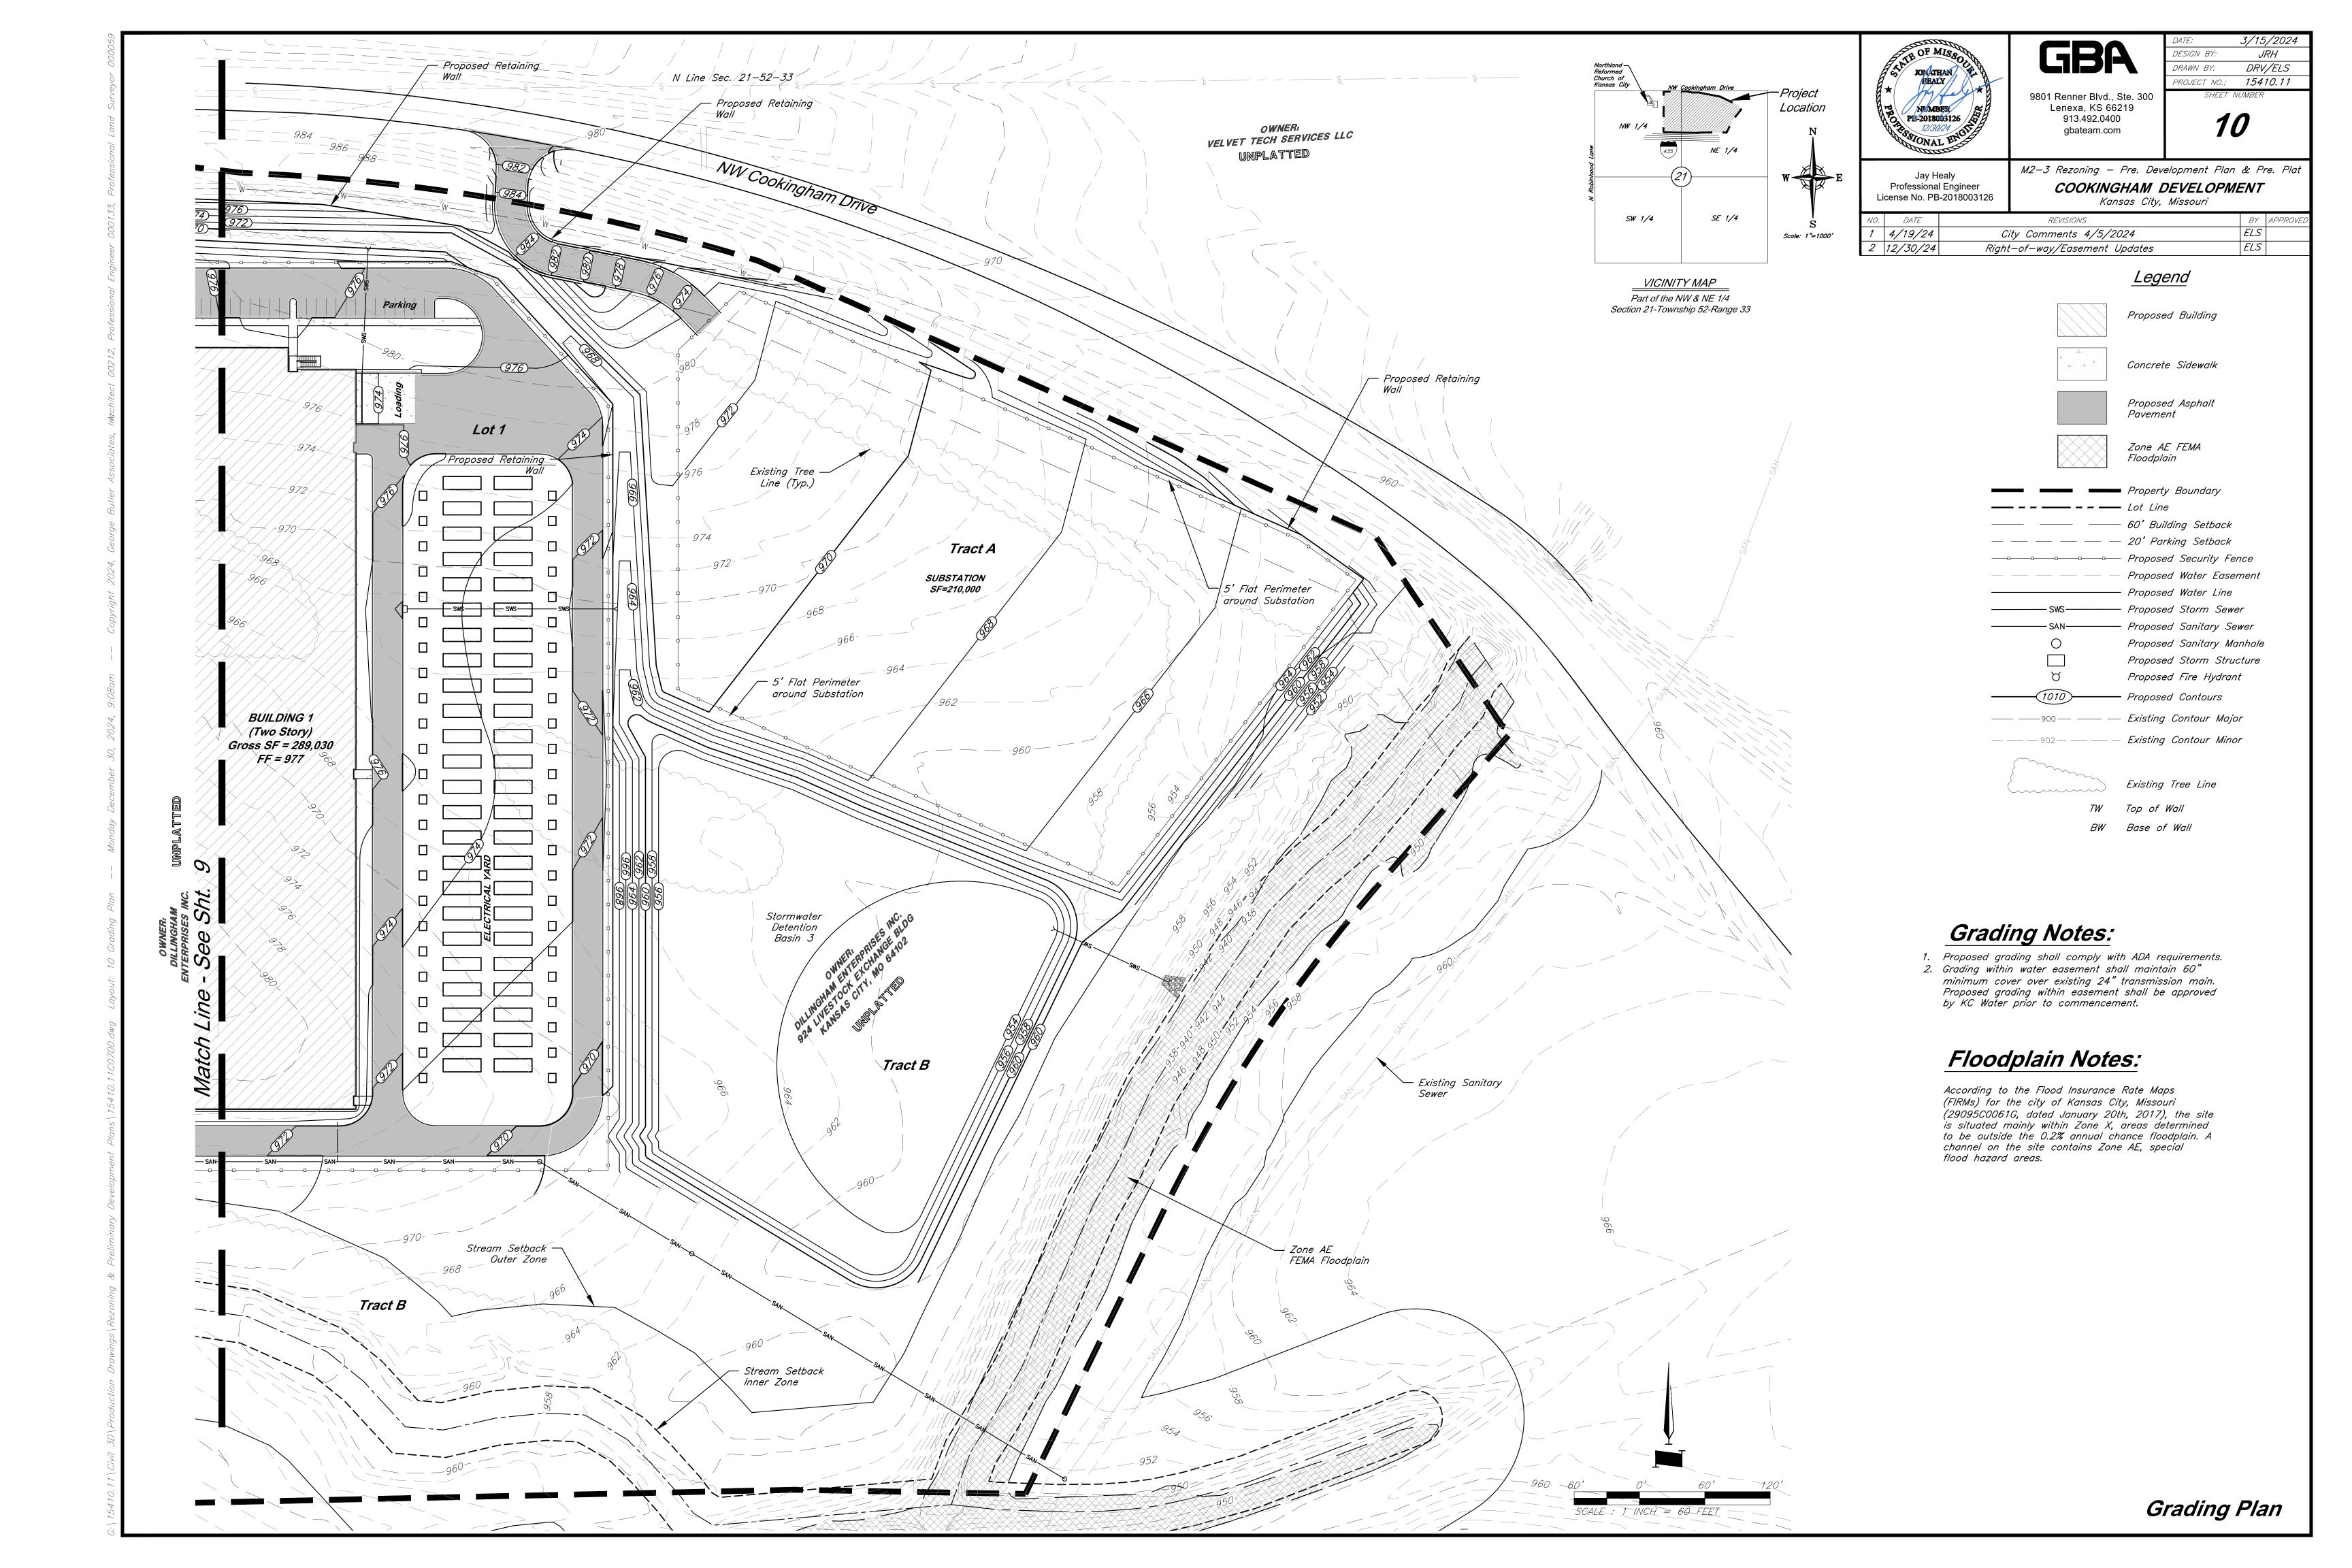


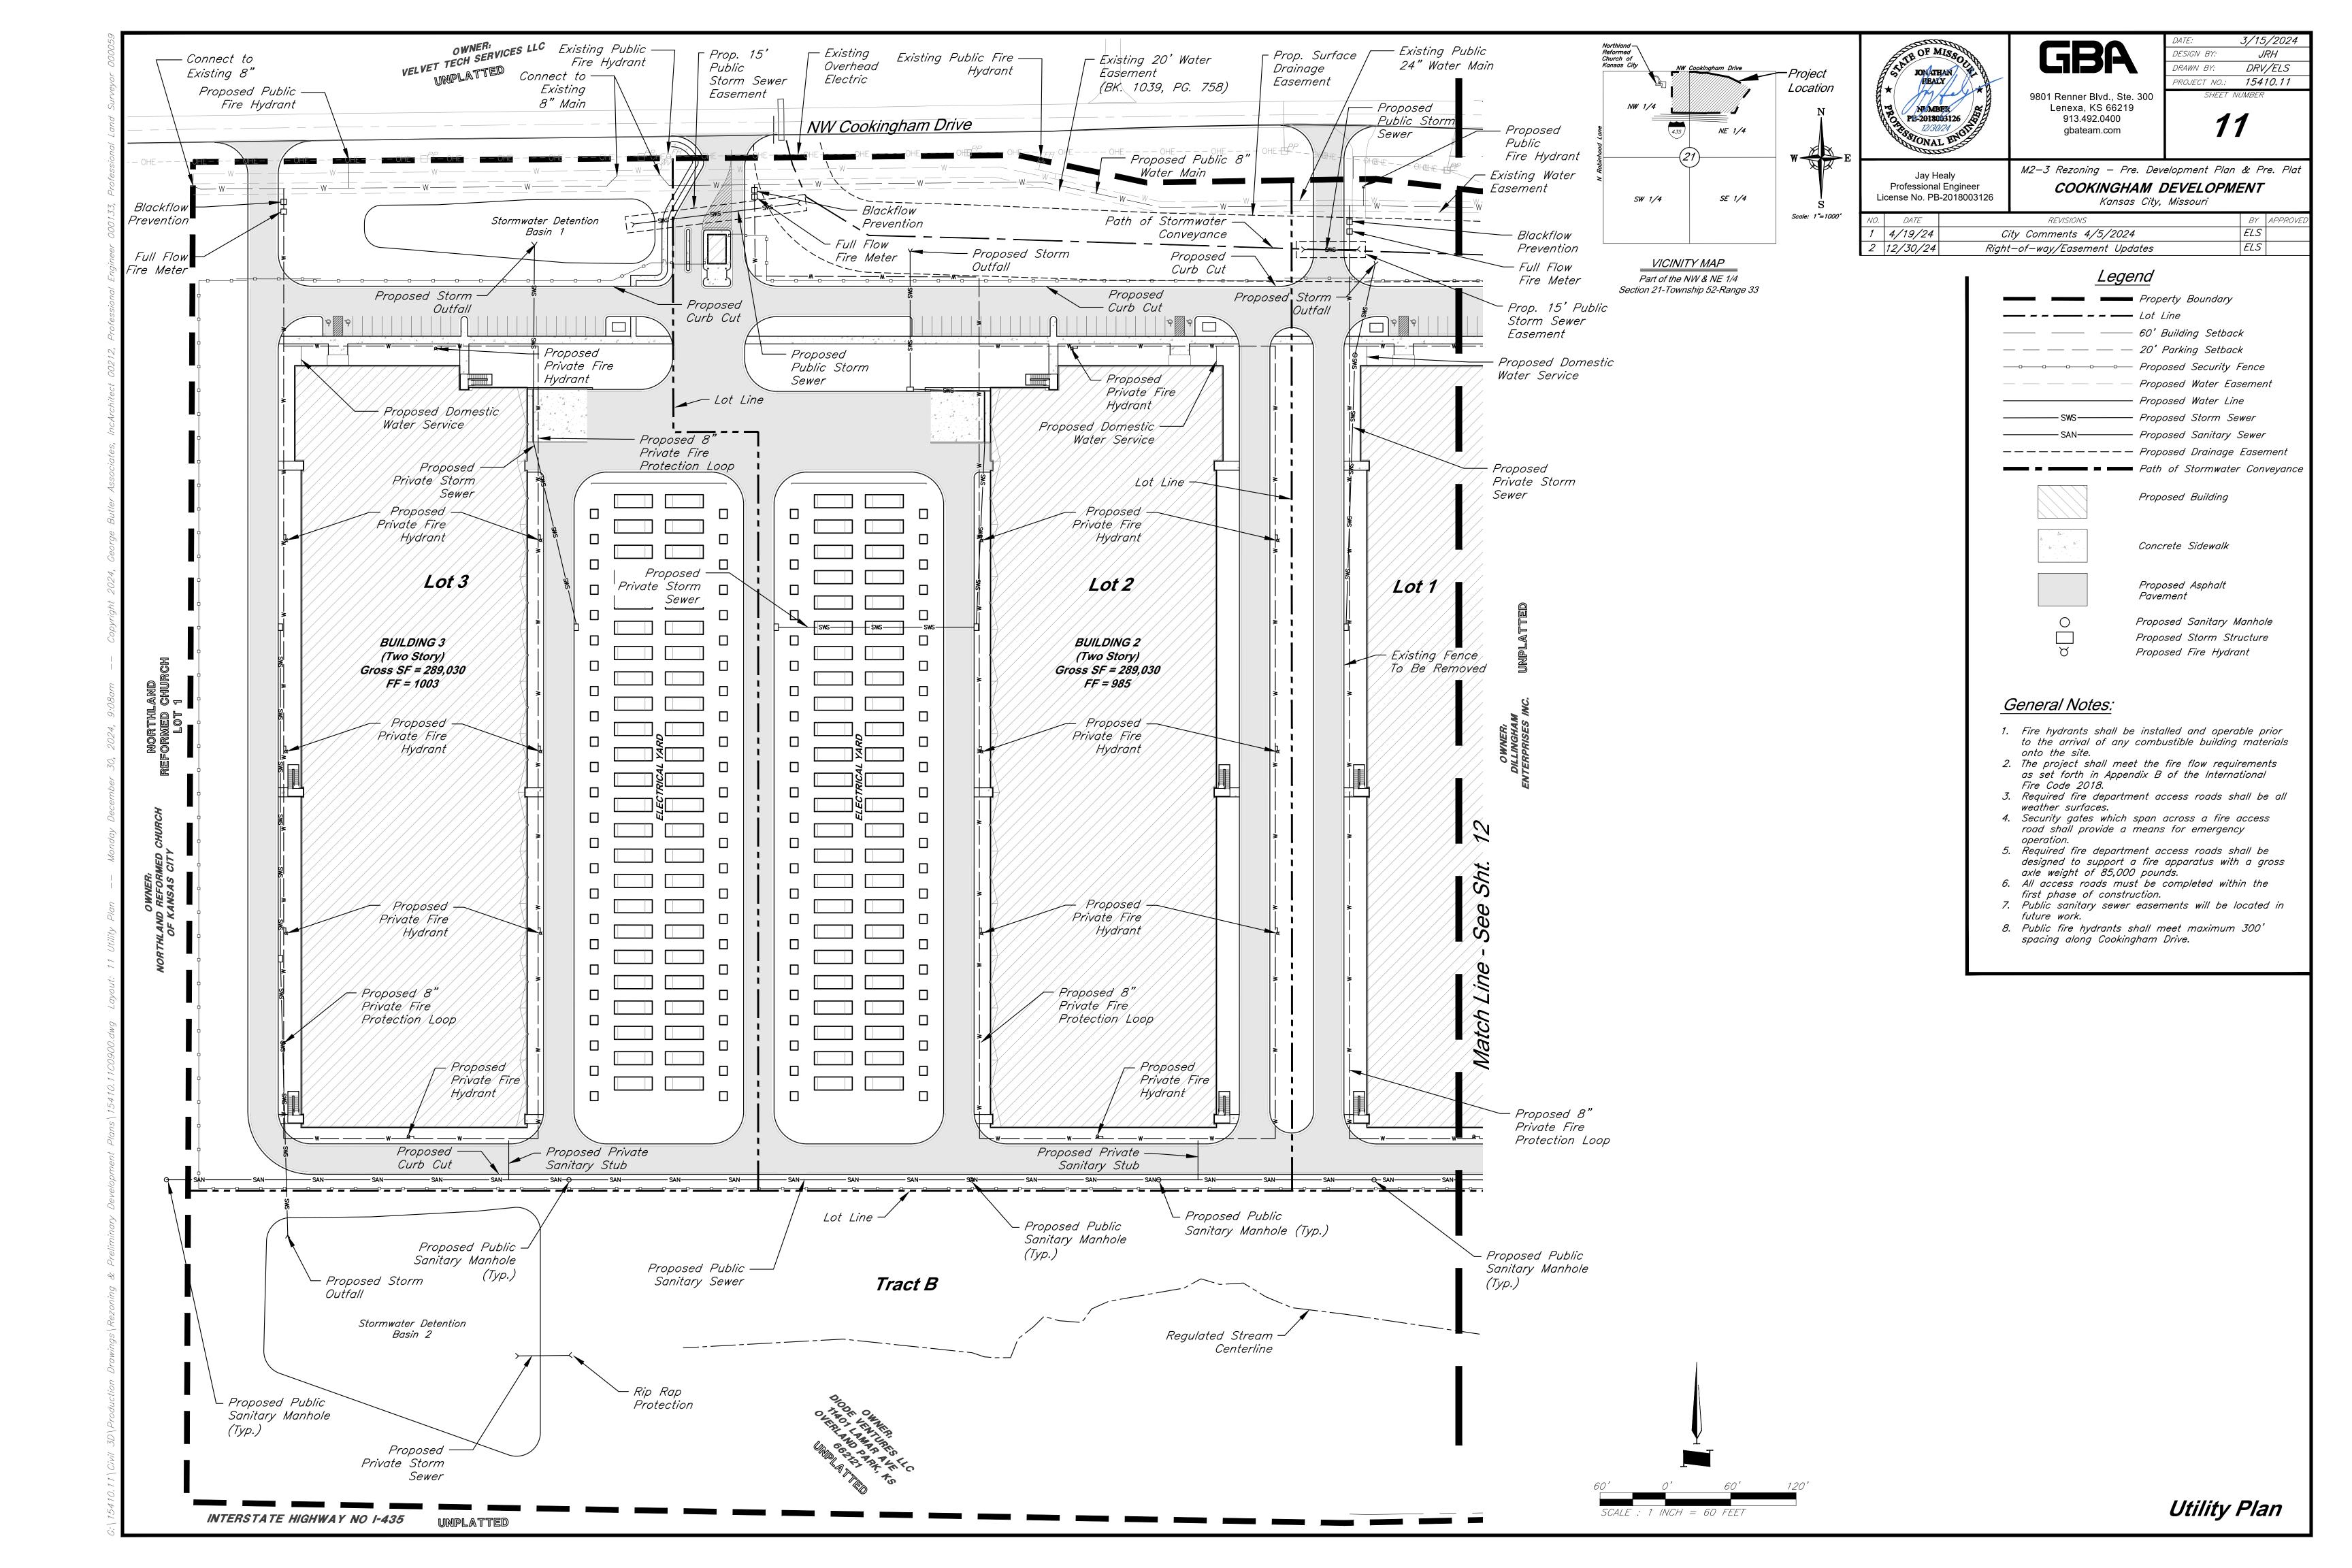


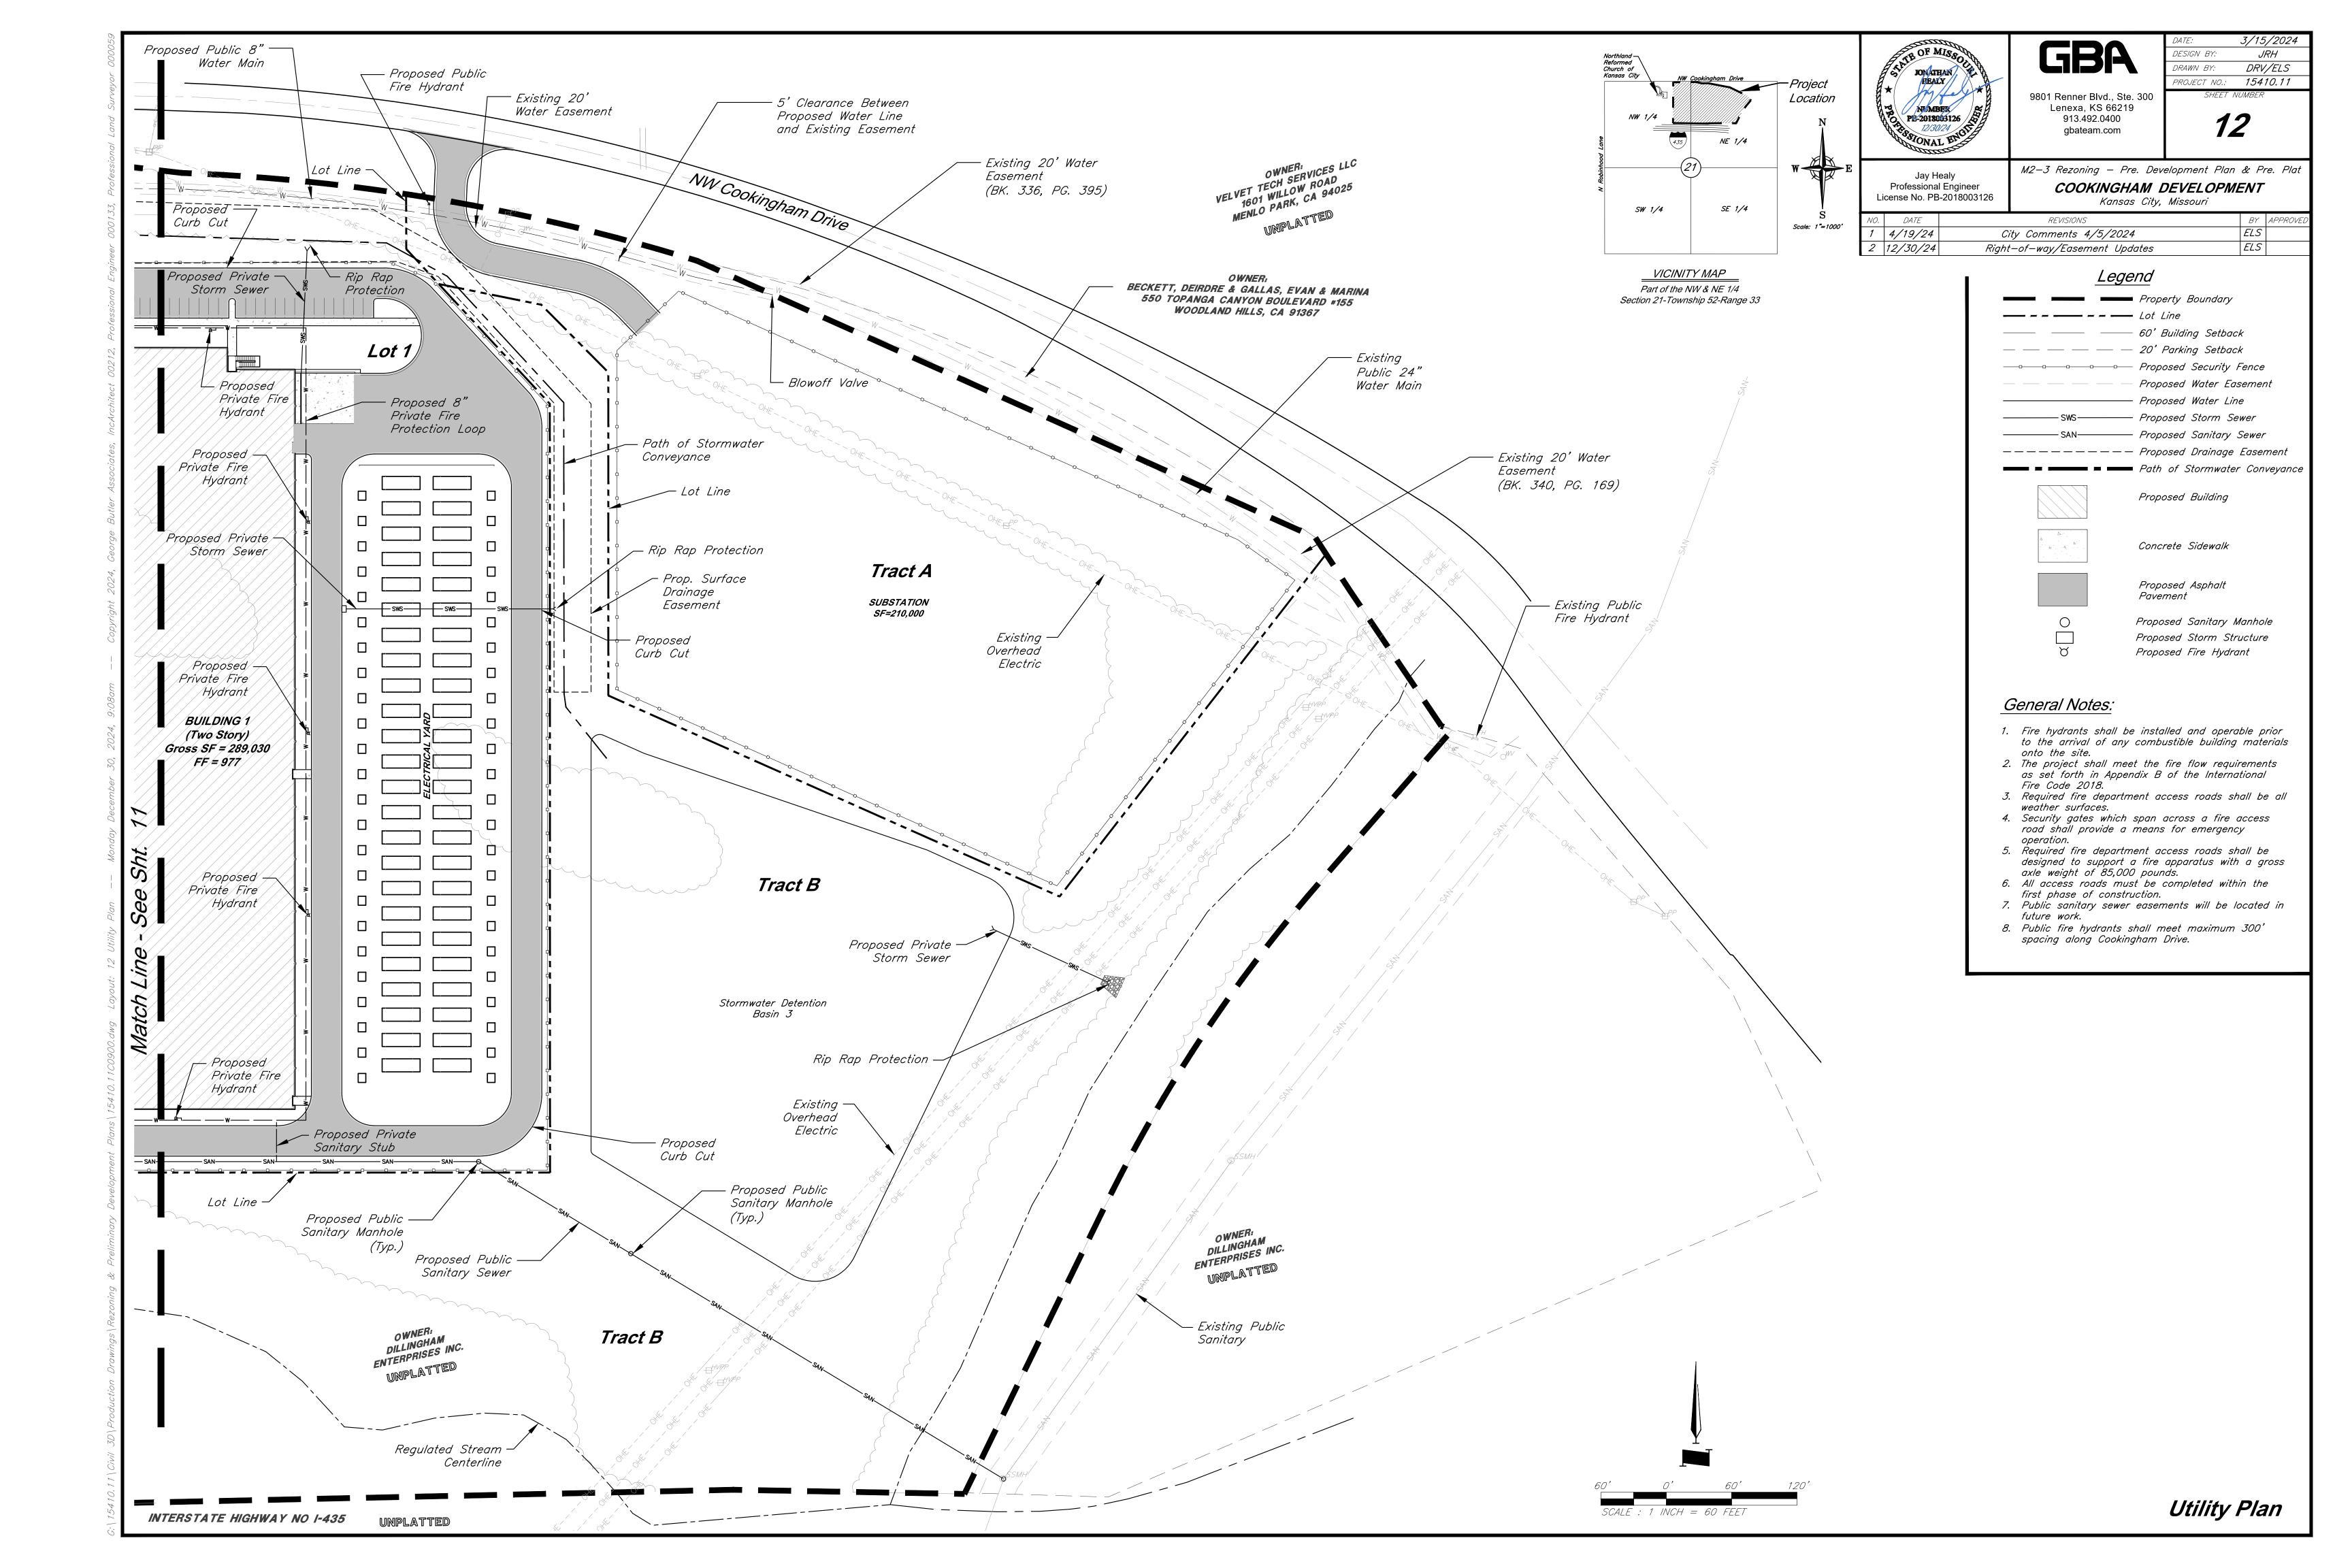


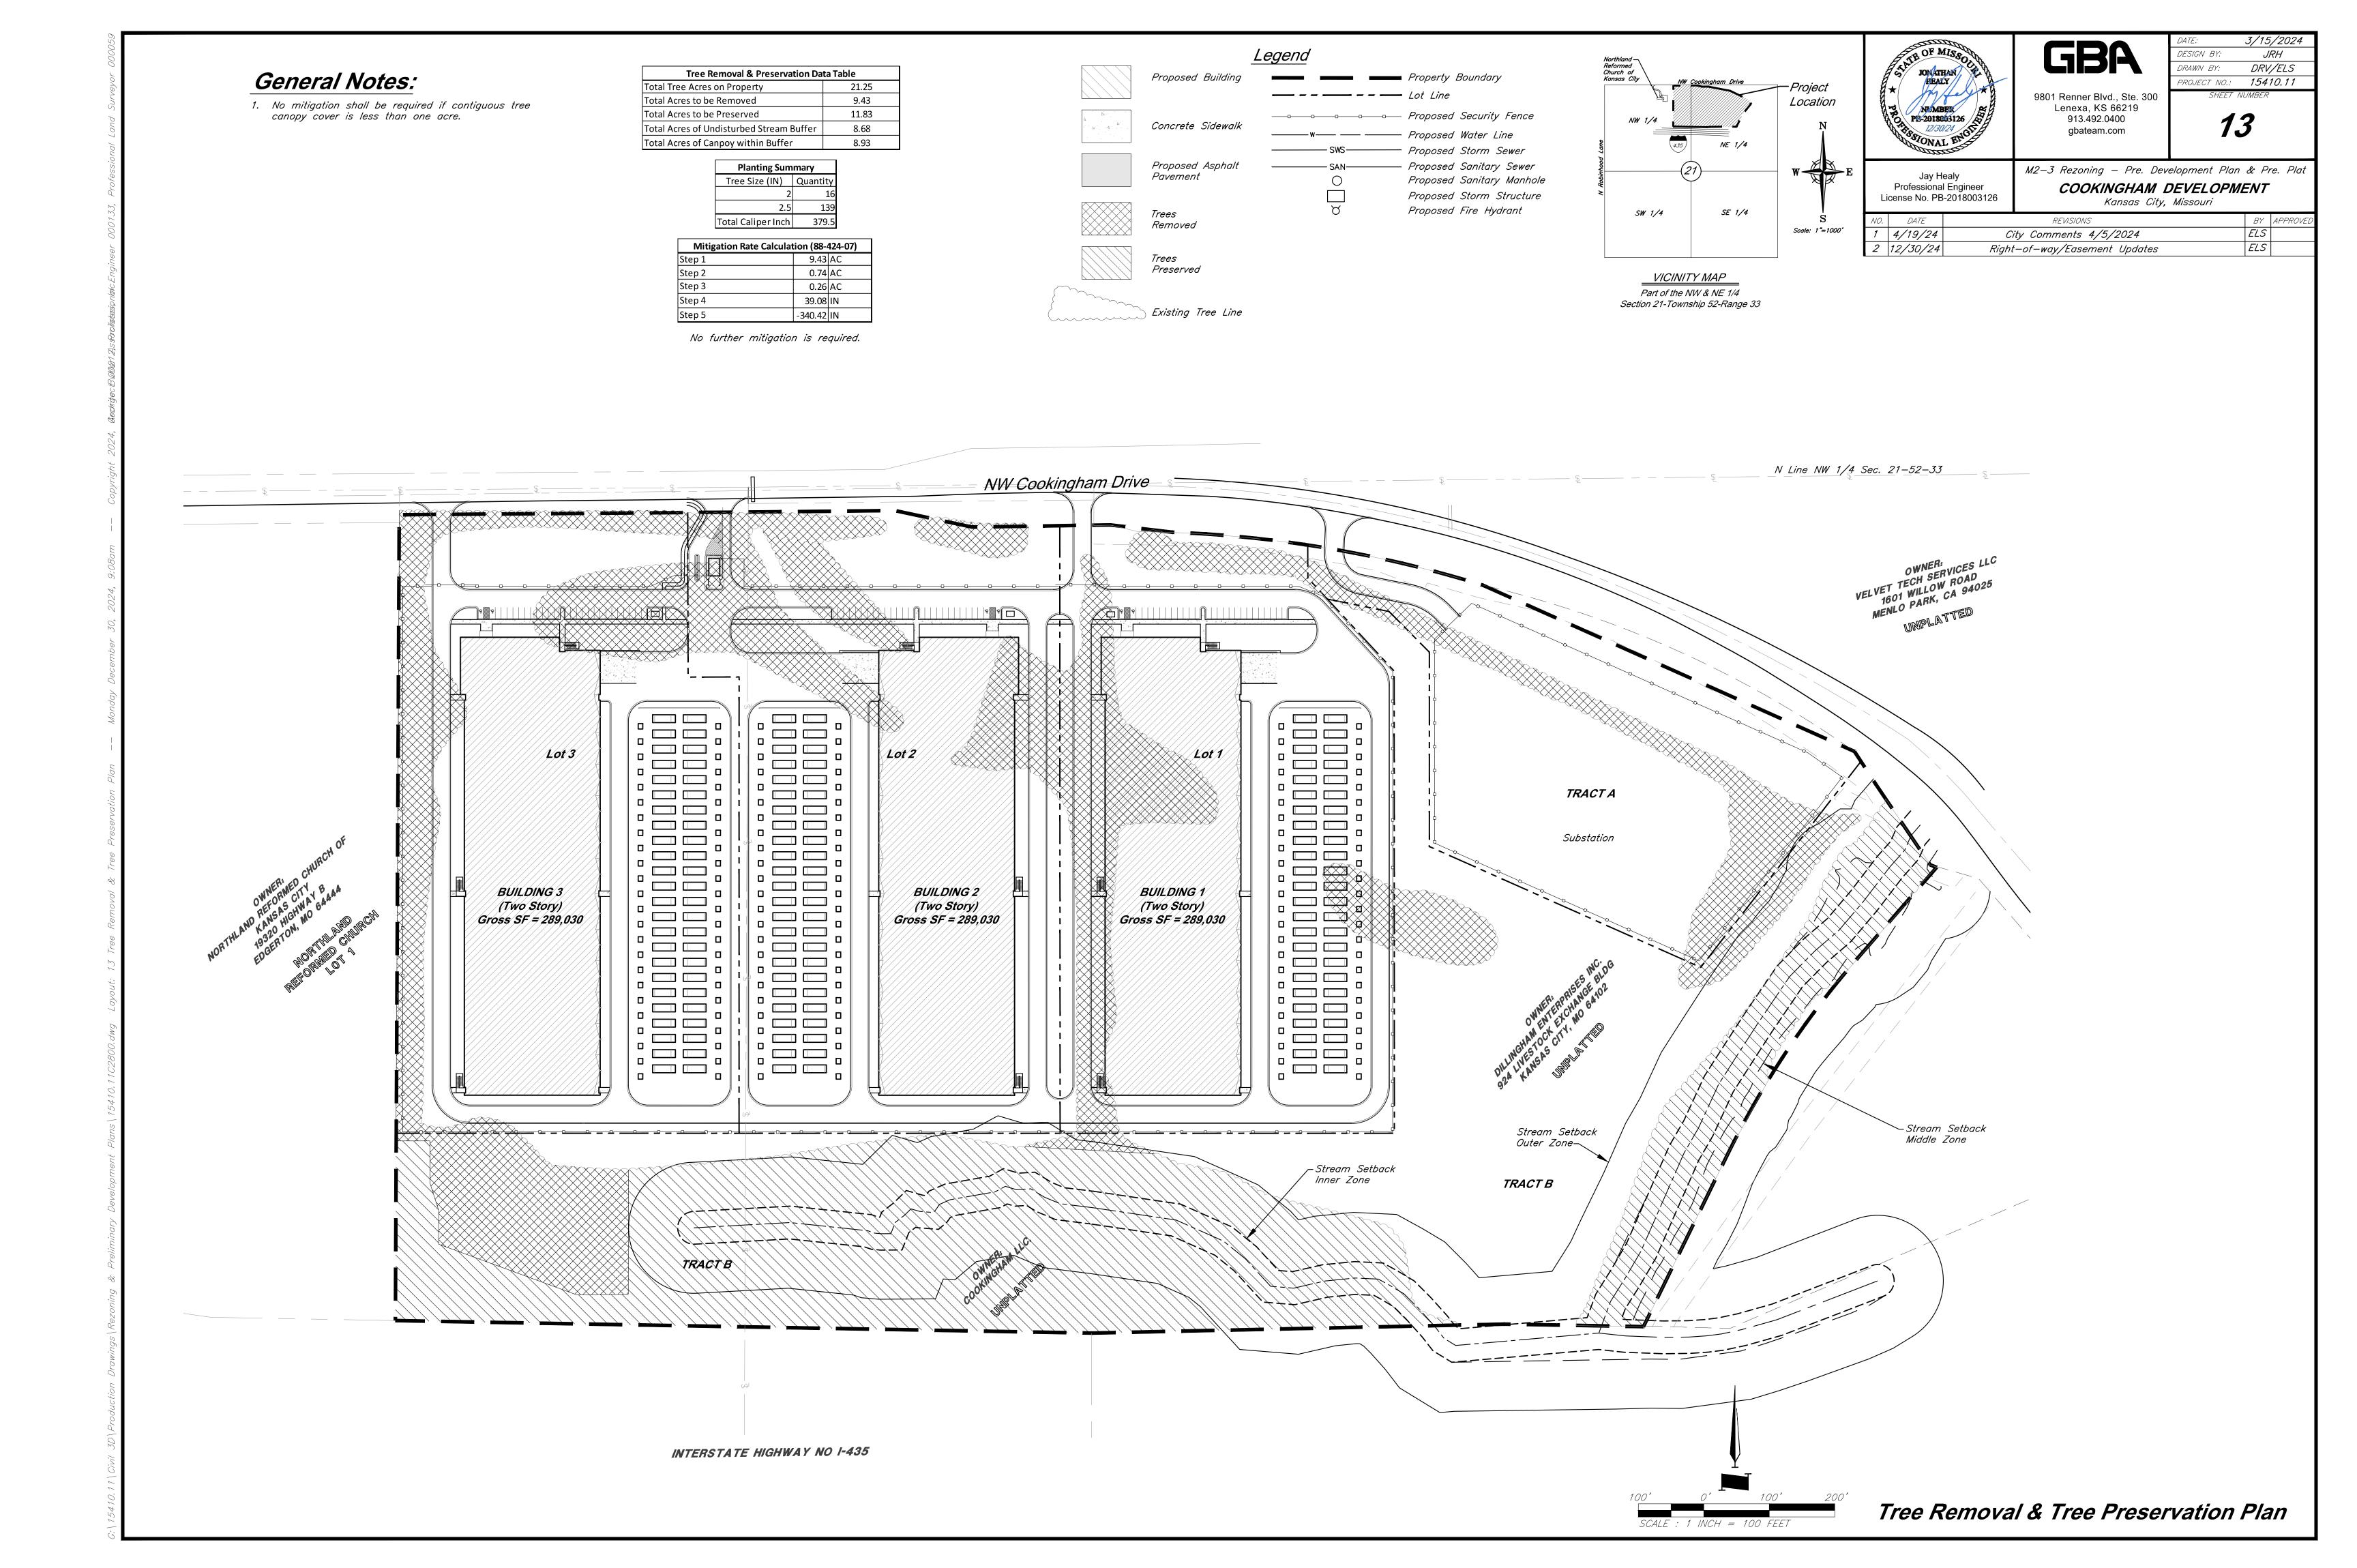

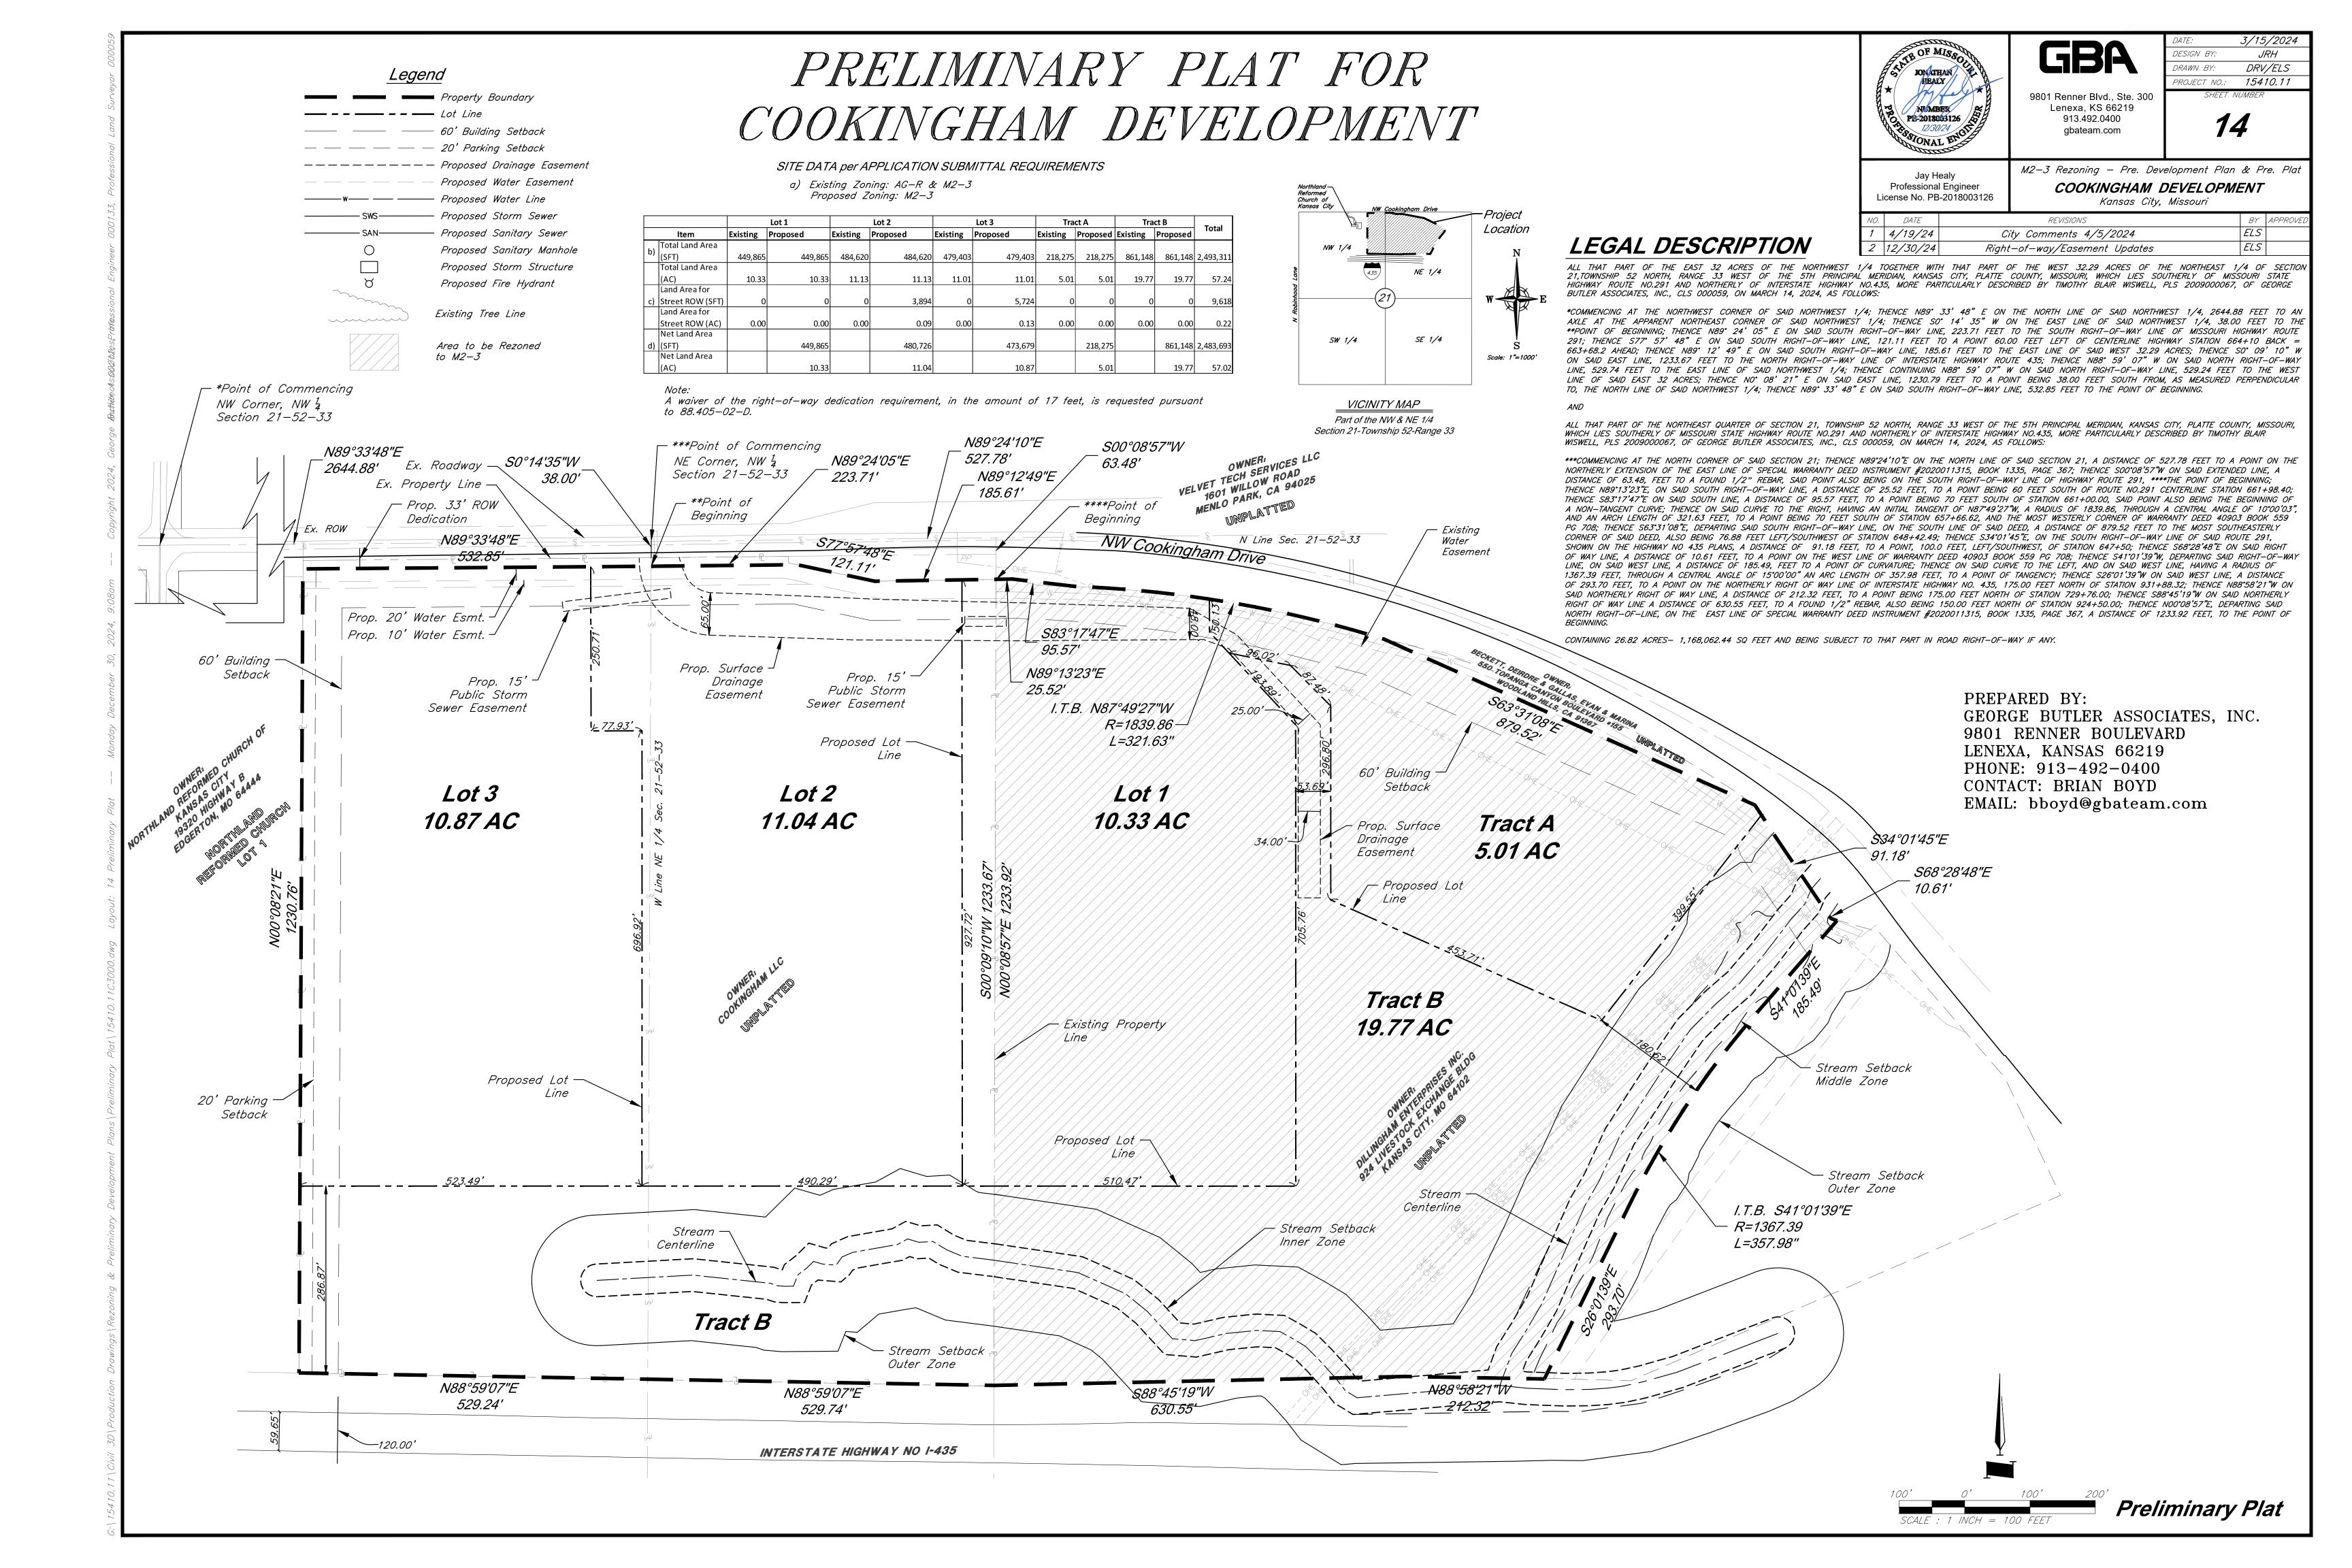

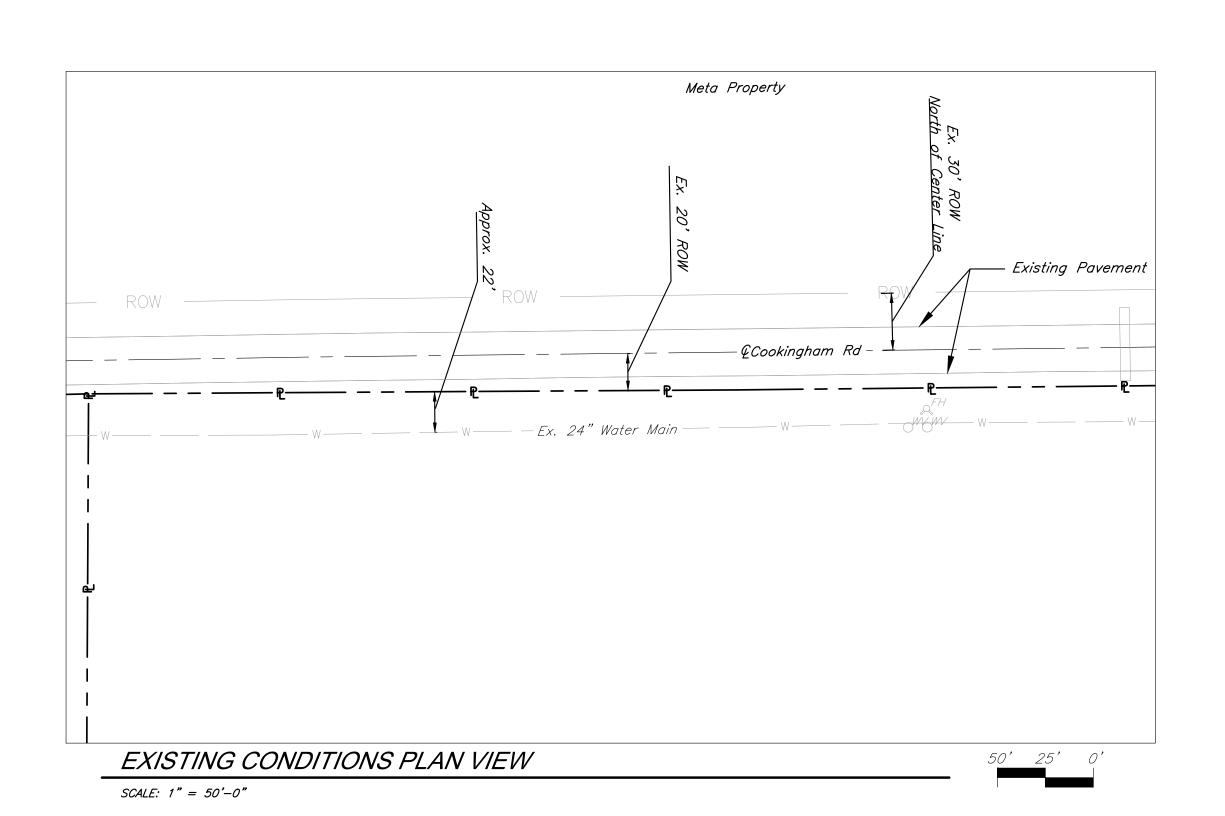

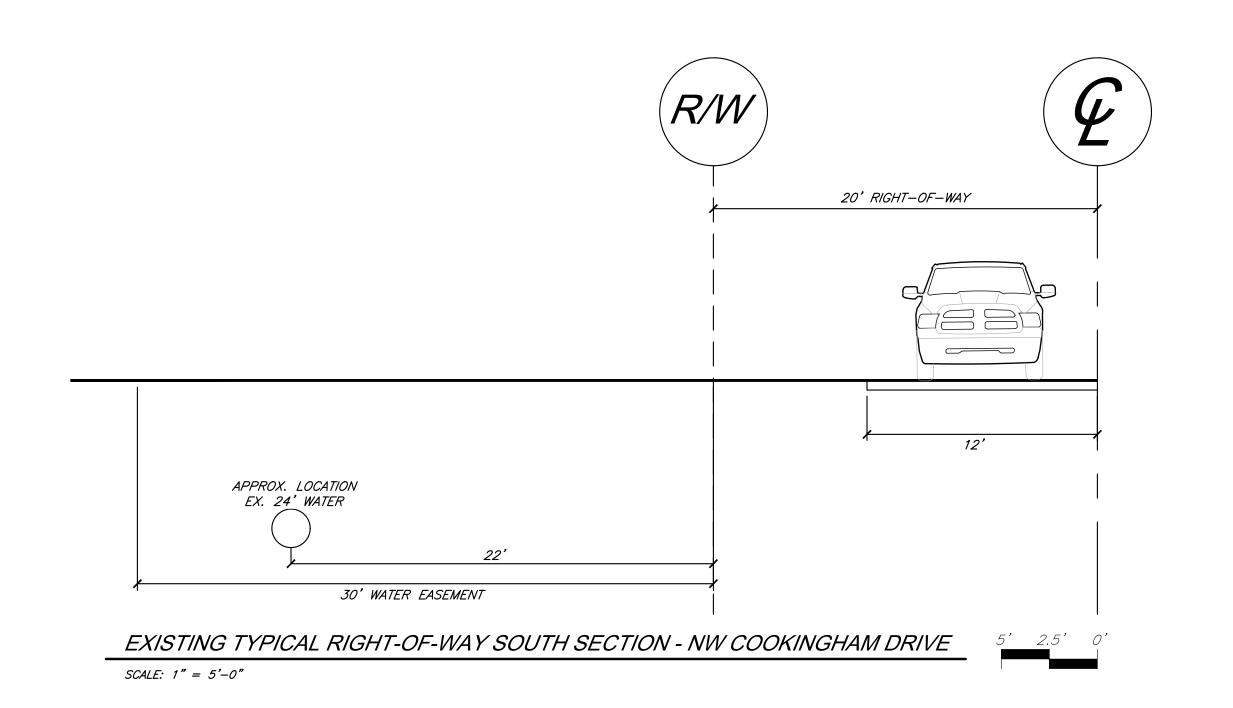

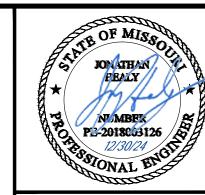

9801 Renner Blvd., Ste. 300

9801 Renner Blvd., Ste. 30 Lenexa, KS 66219 913.492.0400 gbateam.com DRAWN BY: DRV/ELS
PROJECT NO.: 15410.11
SHEET NUMBER


Jay Healy Professional Engineer License No. PB-2018003126 M2-3 Rezoning - Pre. Development Plan & Pre. Plat


COOKINGHAM DEVELOPMENT


Kansas City, Missouri

DESIGN BY:

NO.	DATE	REVISIONS	BY	APPR0
1	4/19/24	City Comments 4/5/2024	ELS	
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	Light Fixture Schedule									
ID	DESCRIPTION	MOUNTING	LAMP TYPE	VOLTAGE	WATTS	MANUFACTURER	CATALOG NUMBER			
SL3	SINGLE-TYPE 3-20'-0" POLE MOUNTED	POLE	LED	MVOLT	98	LITHONIA	ESX1 LED P2			
SL2	SINGLE-TYPE 3-30'-0" POLE MOUNTED	POLE	LED	MVOLT	99	LITHONIA	ESX1 LED P2			
WP1	WALL PACK-WEDGE	WALL	LED	MVOLT	18	LITHONIA	WDGE2 P3 LED 40K 80CRFT3M MVOLT			
BLI	ROUND BOLLARD 40"	GRADE	LED	MVOLT	16	LITHONIA	KBR8 LED 12C 350 40K ASY MVOLT			
CP1	CANOPY	SURFACE	LED	MVOLT	17	LITHONIA	VCPG V4 P1 40K 80CRFTSW MVOLT			

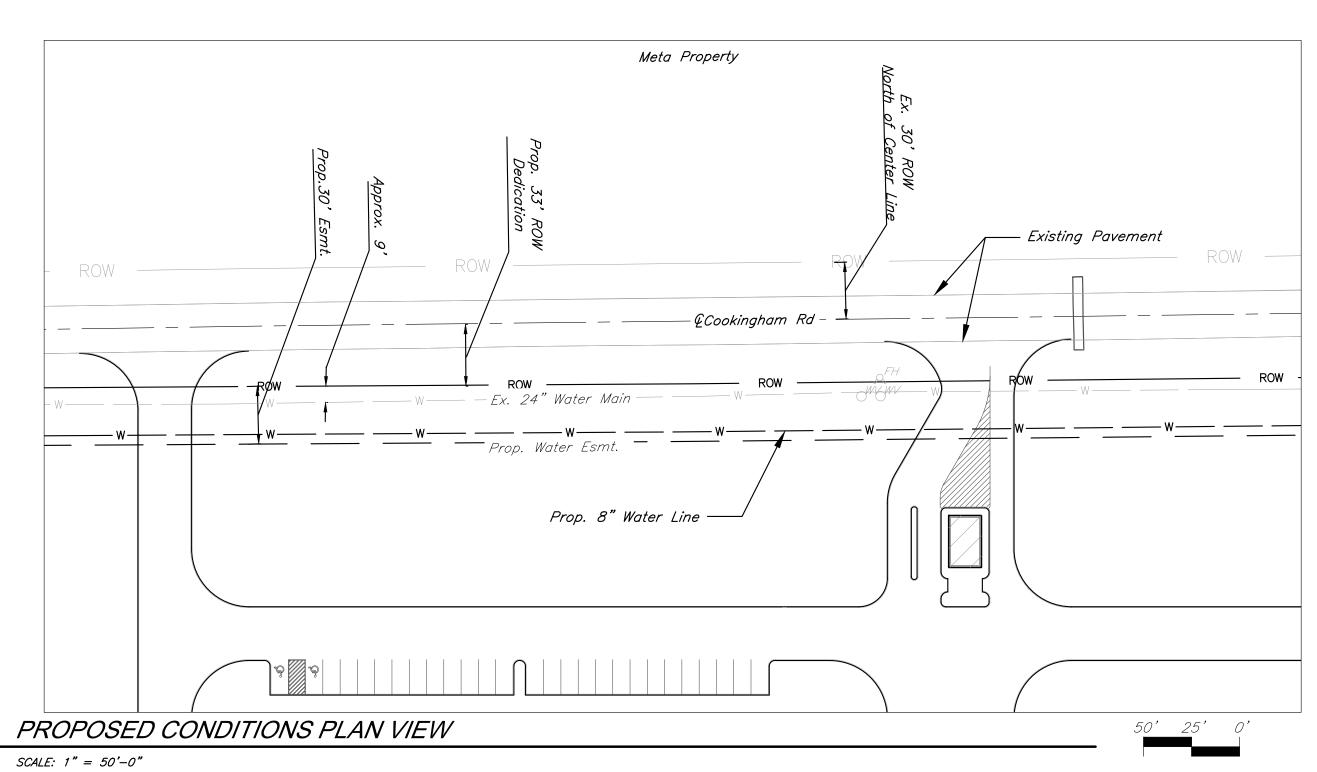WALL MOUNTED LUNIAIRE (MOUNTING HEIGHT AS INDICATED)

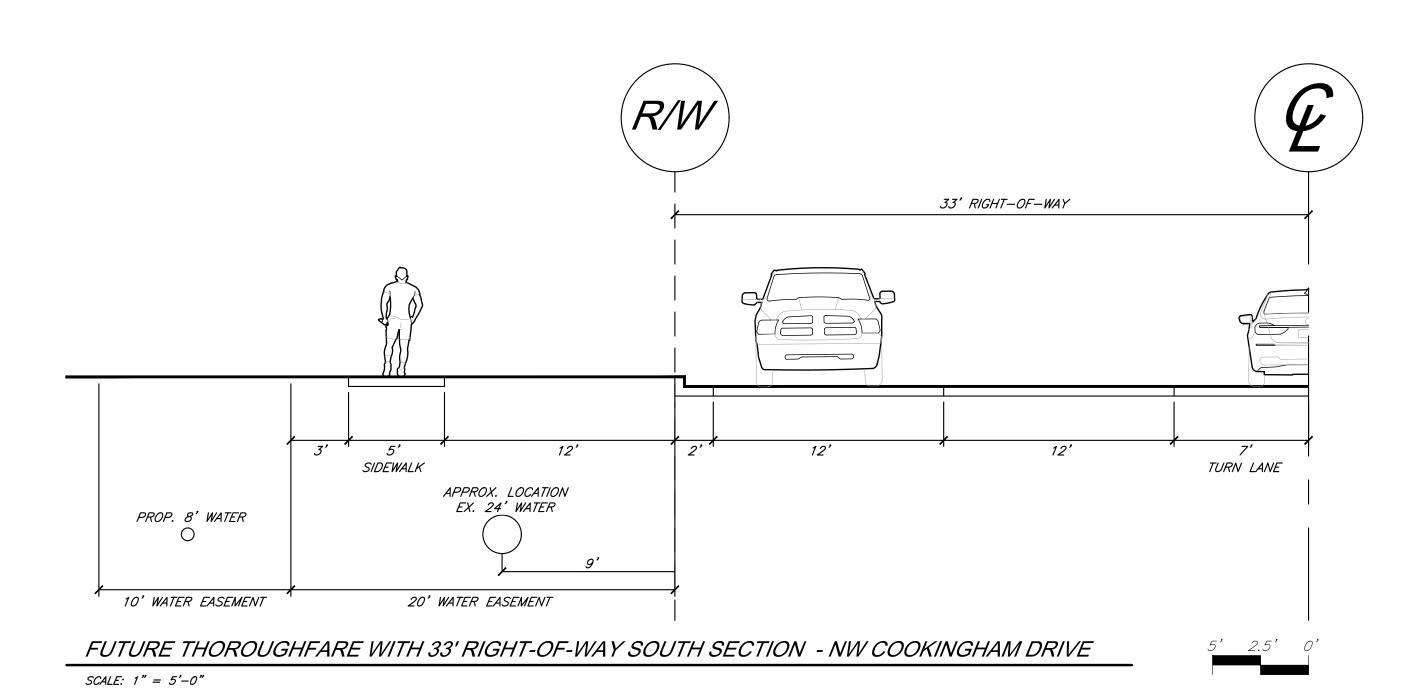GBA Realty
9801 Renner Blvd.

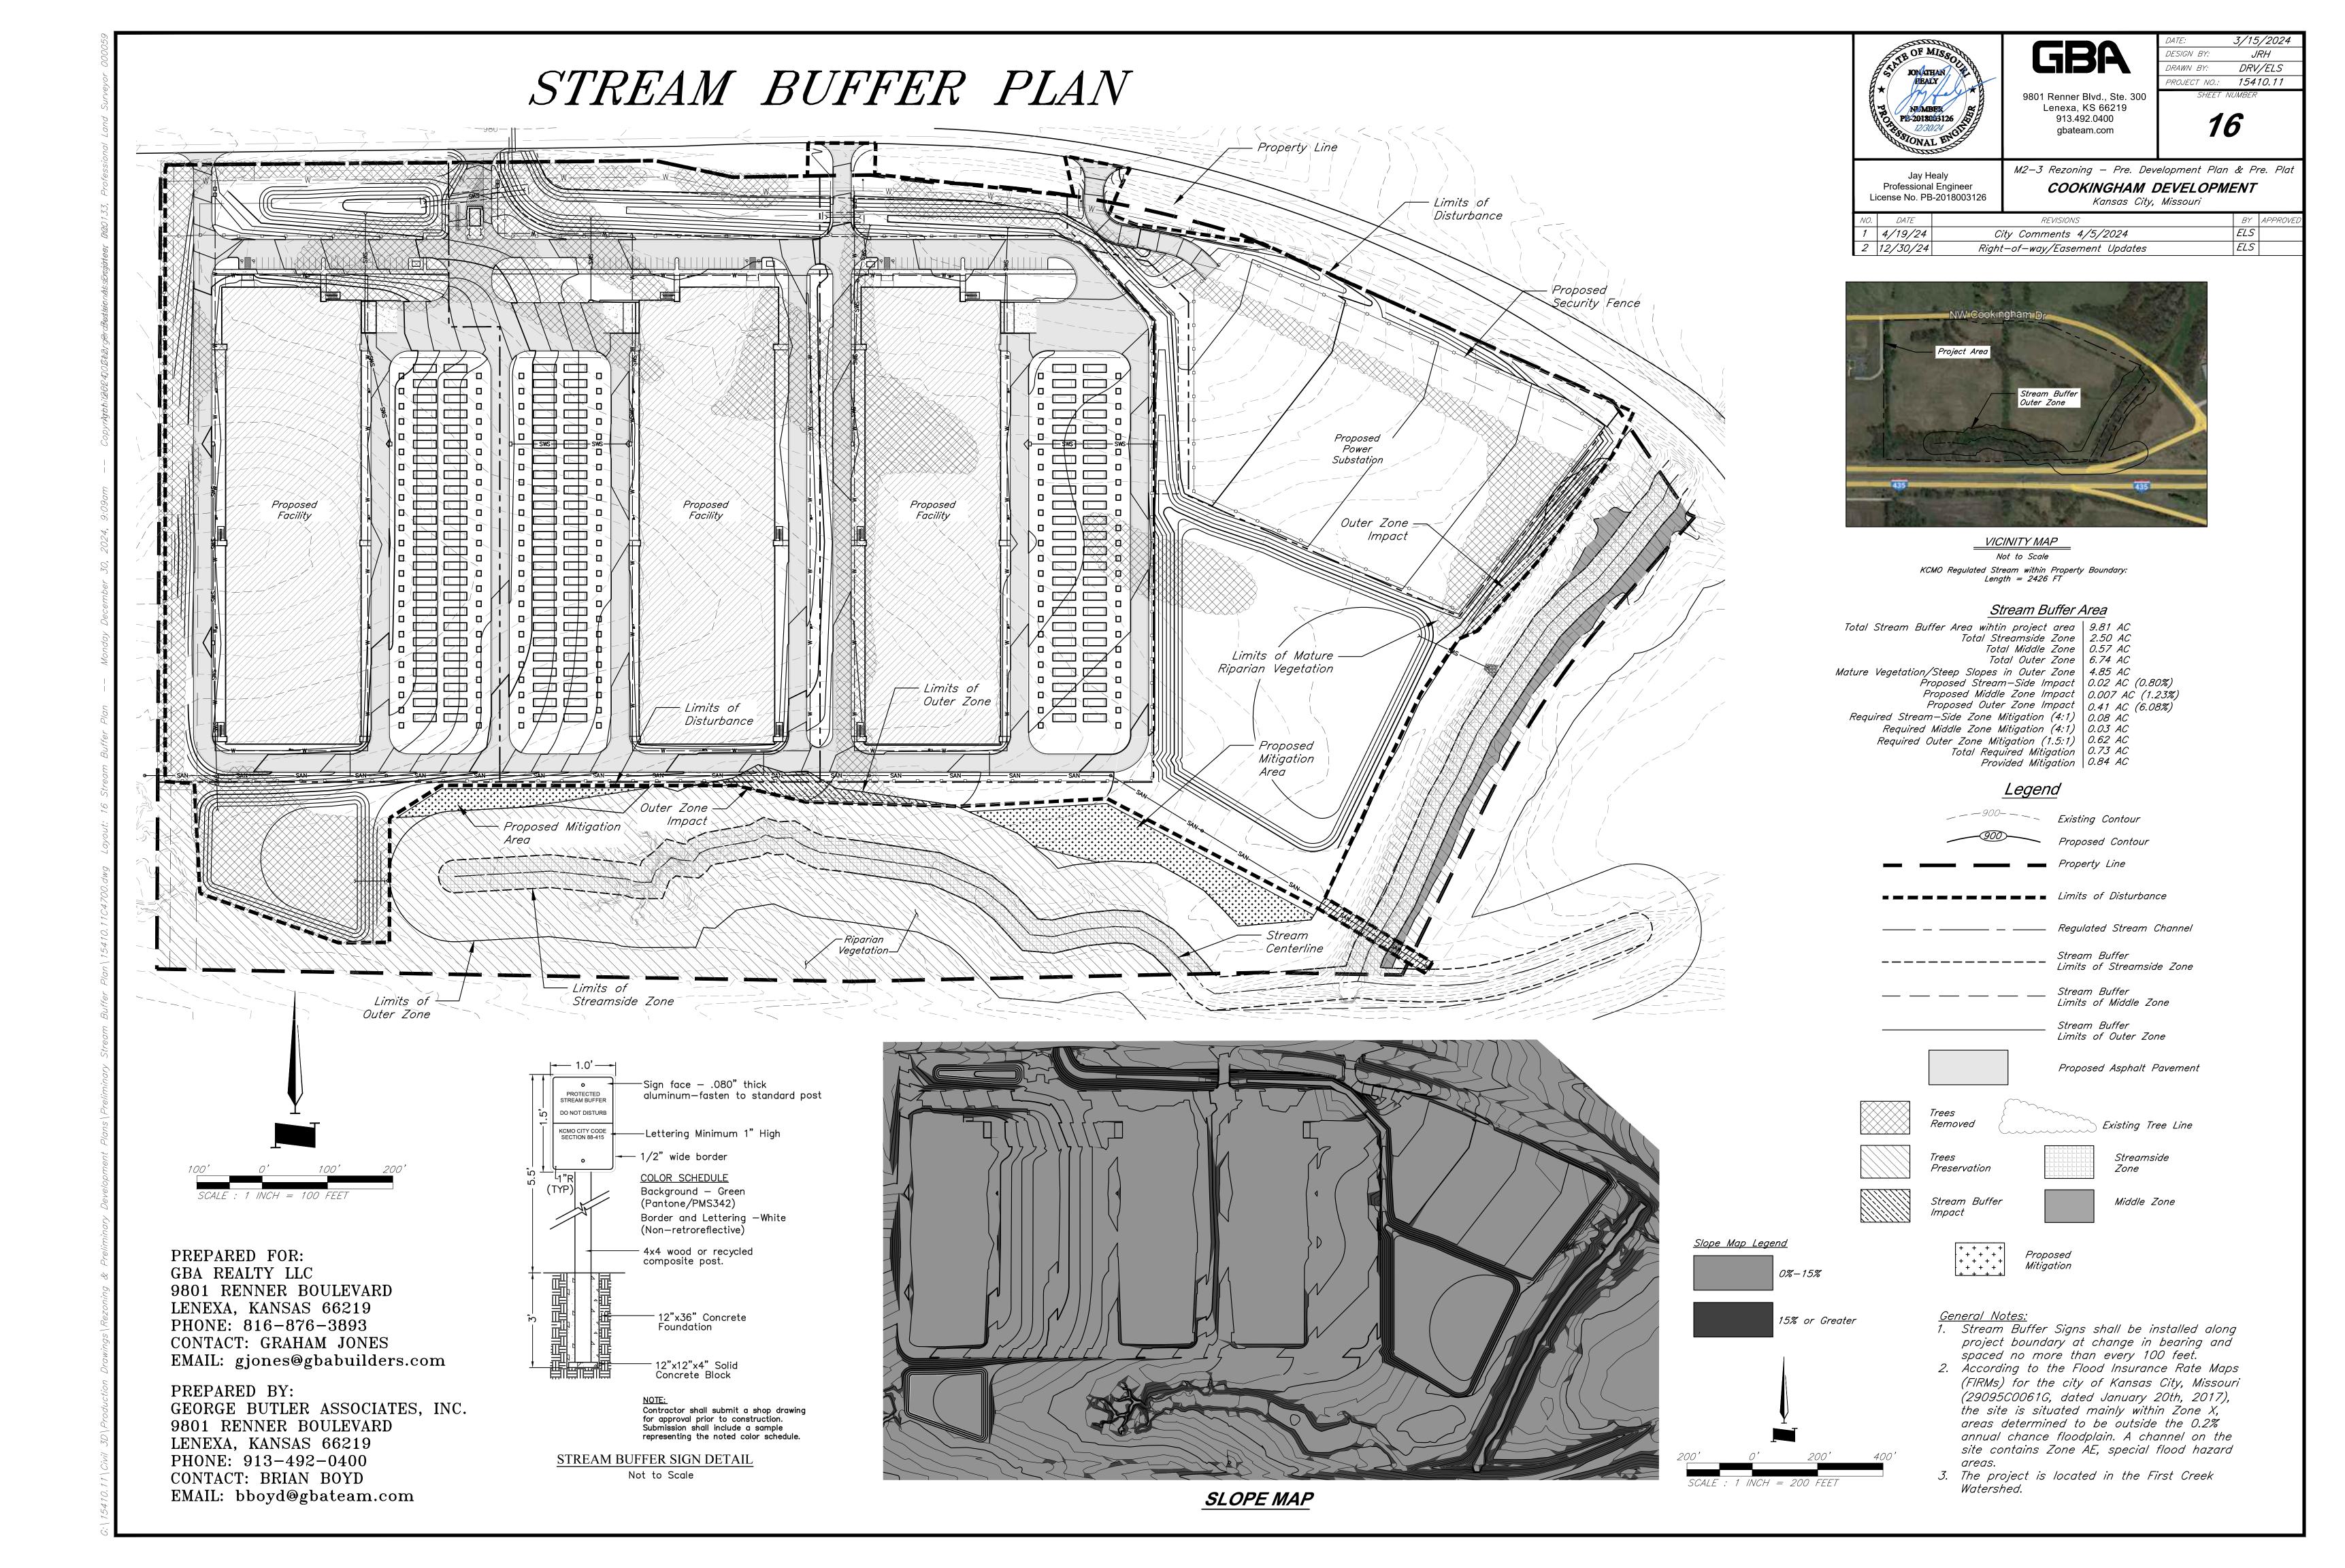
Lenexa, Kansas 66219

4826 ACADEMY DRIVE MADISON, WI 53716

CHECKED BY 03/12/24 ISSUE DATE REVISIONS NO. DATE DESCRIPTION

SHEET TITLE: ELECTRICAL POINT BY POINT PHOTOMETRIC SITE PLAN WEST

ESL1.1

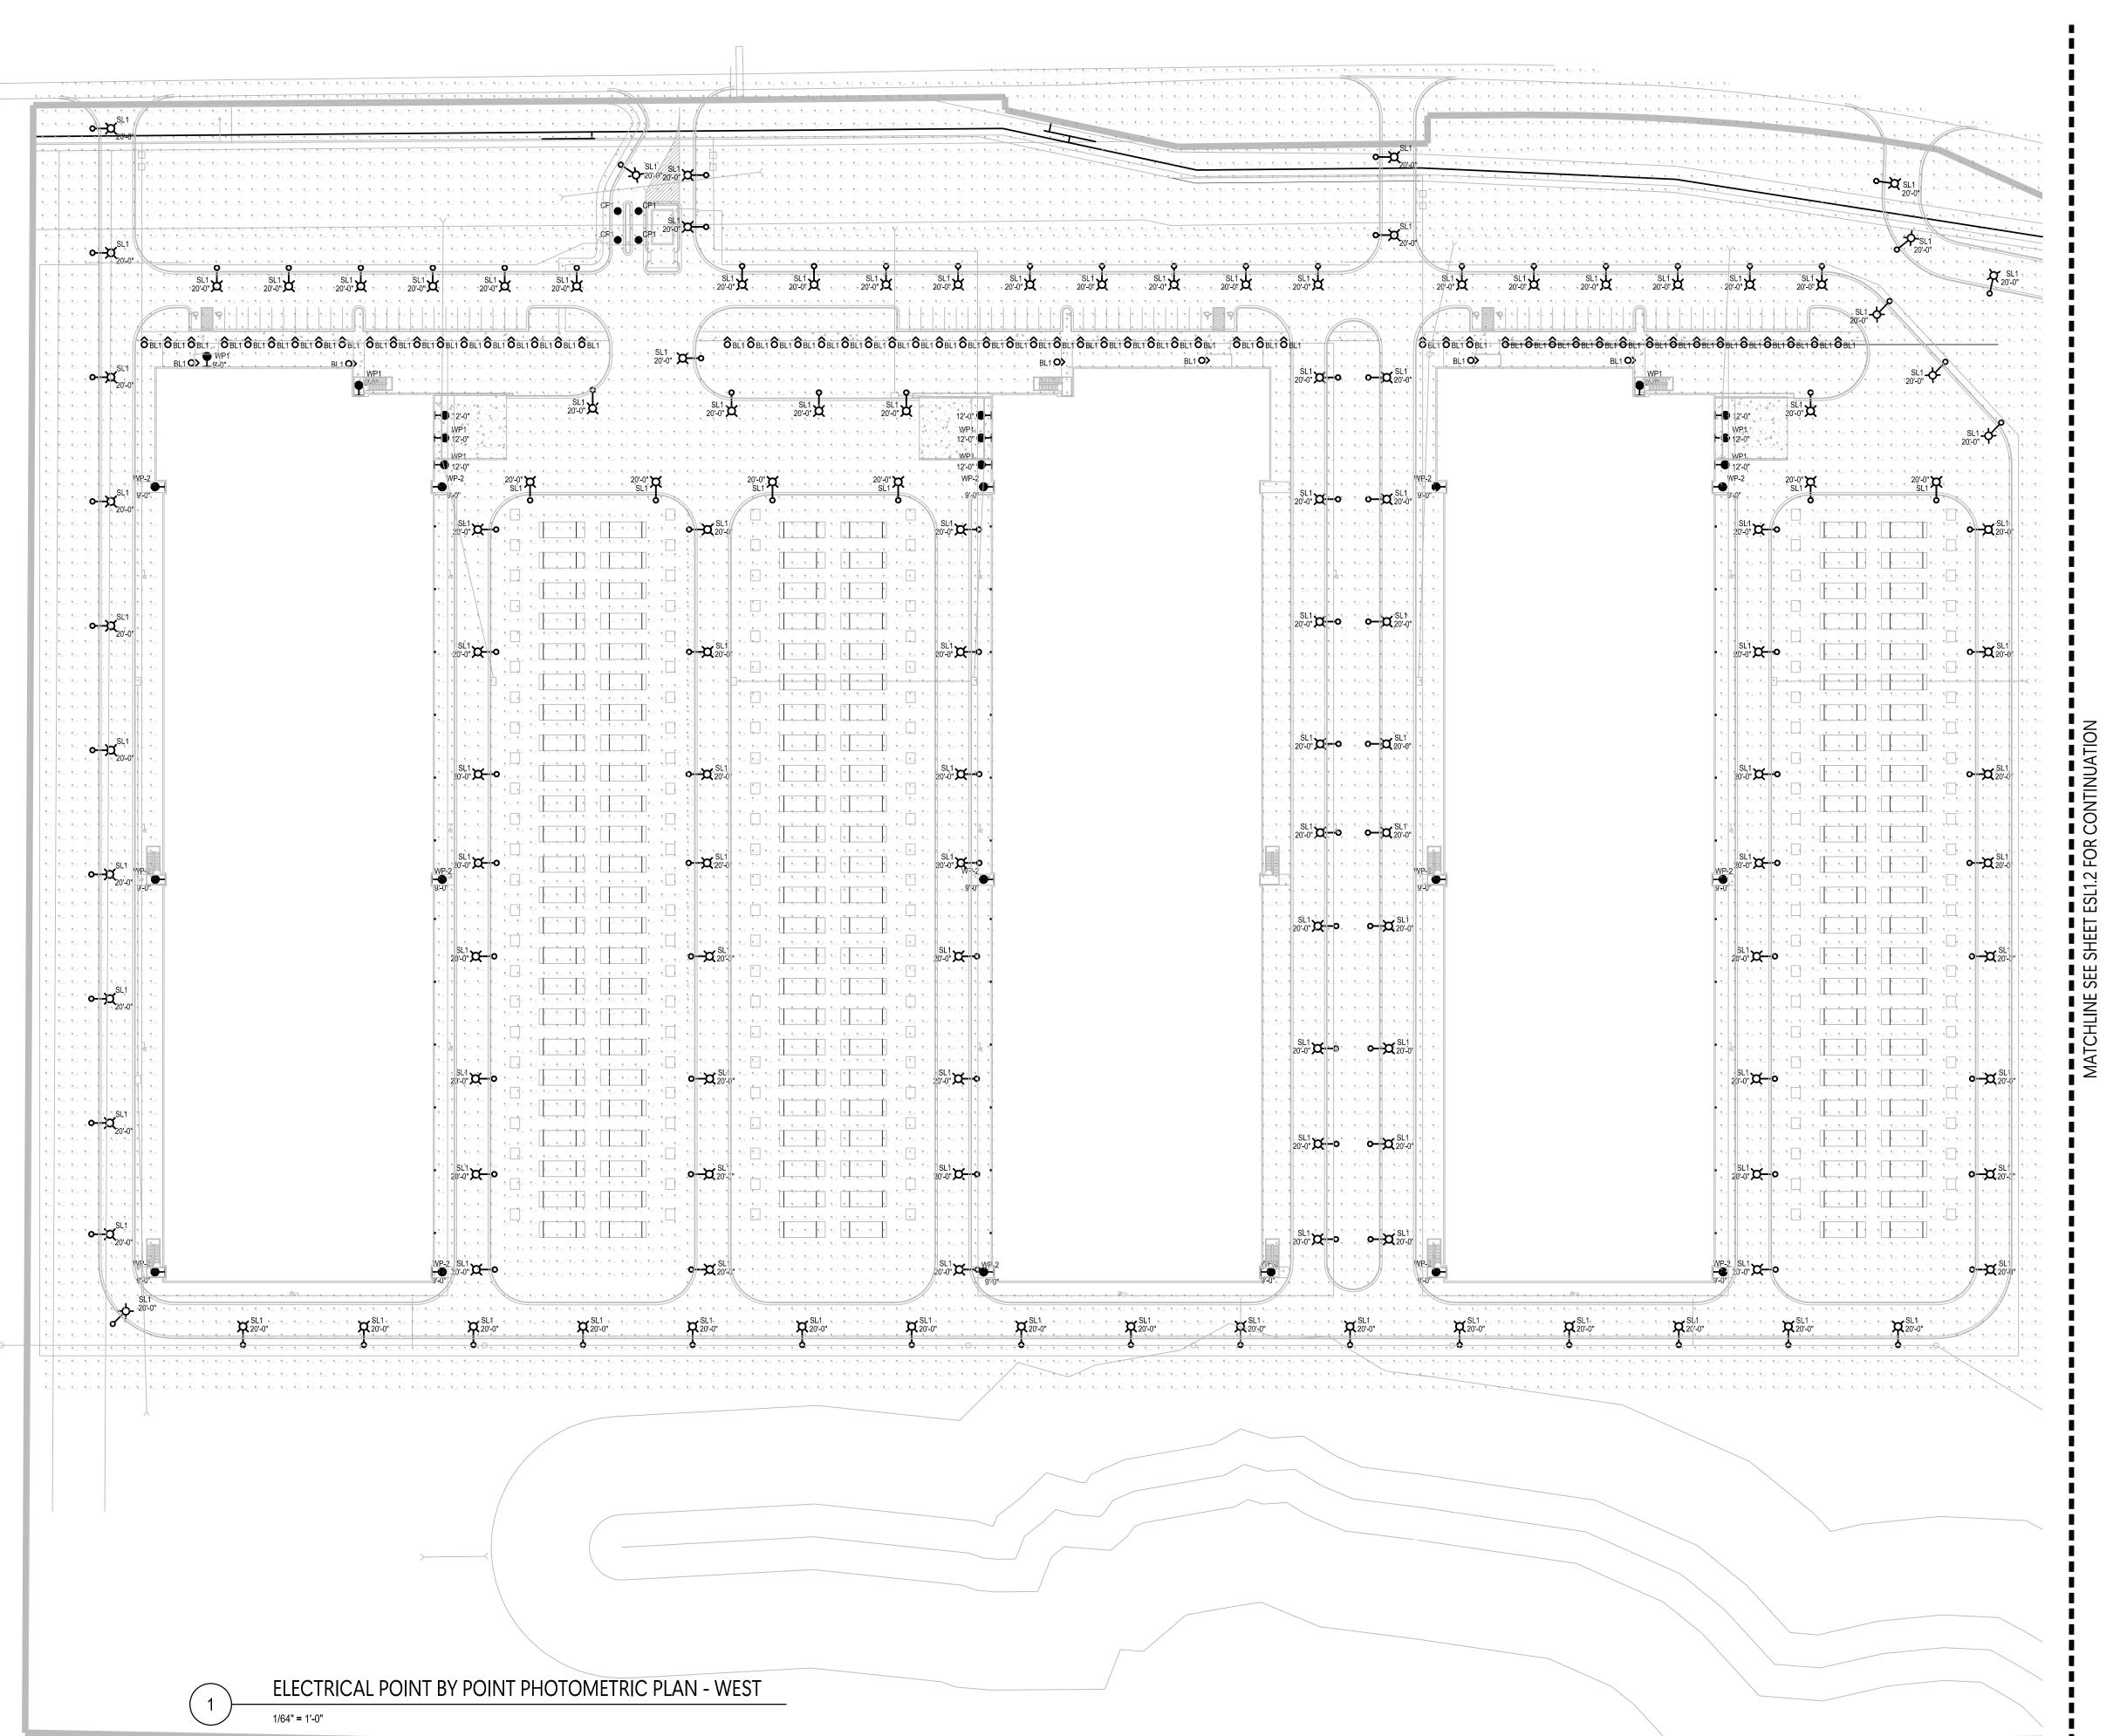

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SHEET TITLE: ELECTRICAL POINT BY POINT PHOTOMETRIC SITE PLAN

ESL1.2

ELECTRICAL POINT BY POINT PHOTOMETRIC PLAN - EAST

